

PROJECT LOCATION

6701 EVANSTAD DR N
MAPLE GROVE, MN 55369

GENERAL NOTES

1. REFER TO P&ID LEAD SHEETS FOR SYMBOLS AND ABBREVIATIONS.
2. ALL AUTOMATED VALVES ARE TO BE FAIL-CLOSE UNLESS OTHERWISE INDICATED.
3. CONNECTION POINTS TO EQUIPMENT ARE SHOWN FOR REFERENCE ONLY.
4. PIPING AND DUCT TAKEOFFS ARE SHOWN SCHEMATICALLY. FOR ACTUAL TAKEOFF ORDER, SEE PLANS.

SHEET NOTES

KEYPLAN



CLIENT

UPSHER-SMITH

Partners in Health Since 1919

CONSULTING ENGINEER

HORWITZ
7400 49th AVENUE NORTH
NEW HOPE, MN 55428
(763) 533-1900
www.horwitzinc.com

PROJECT TITLE

PROJECT KEYSTONE - PHASE 1

REV	BY	DATE	AS RECORDED	DESCRIPTION
5		03/17/23	AS RECORDED	

LICENSEE

I HEREBY CERTIFY THAT THIS PLAN, SPECIFICATION OR REPORT WAS PREPARED BY ME OR UNDER MY DIRECT SUPERVISION AND THAT I AM A DULY LICENSED ENGINEER UNDER THE LAWS OF THE STATE OF MINNESOTA.

TODD MATELSKI

Date 03/17/23

LIC NO 50819

CONFIDENTIAL - THIS DRAWING IS THE PROPERTY OF UPSHER-SMITH. THE INFORMATION CONTAINED HEREIN MAY NOT BE USED OR COPIED IN ANY MANNER WITHOUT THE WRITTEN PERMISSION OF THE OWNER.


PROJ. NO.	2022.1720	DESIGNED BY:	BB
SCALE:	1/2" = 1'-0"	CHECKED BY:	RS
SHEET SIZE:	30x42	APPROVED BY:	TM

DRAWING TITLE

STEAM BOILER FEEDWATER SURGE
TANK P&ID

DRAWING NUMBER

PID-9601

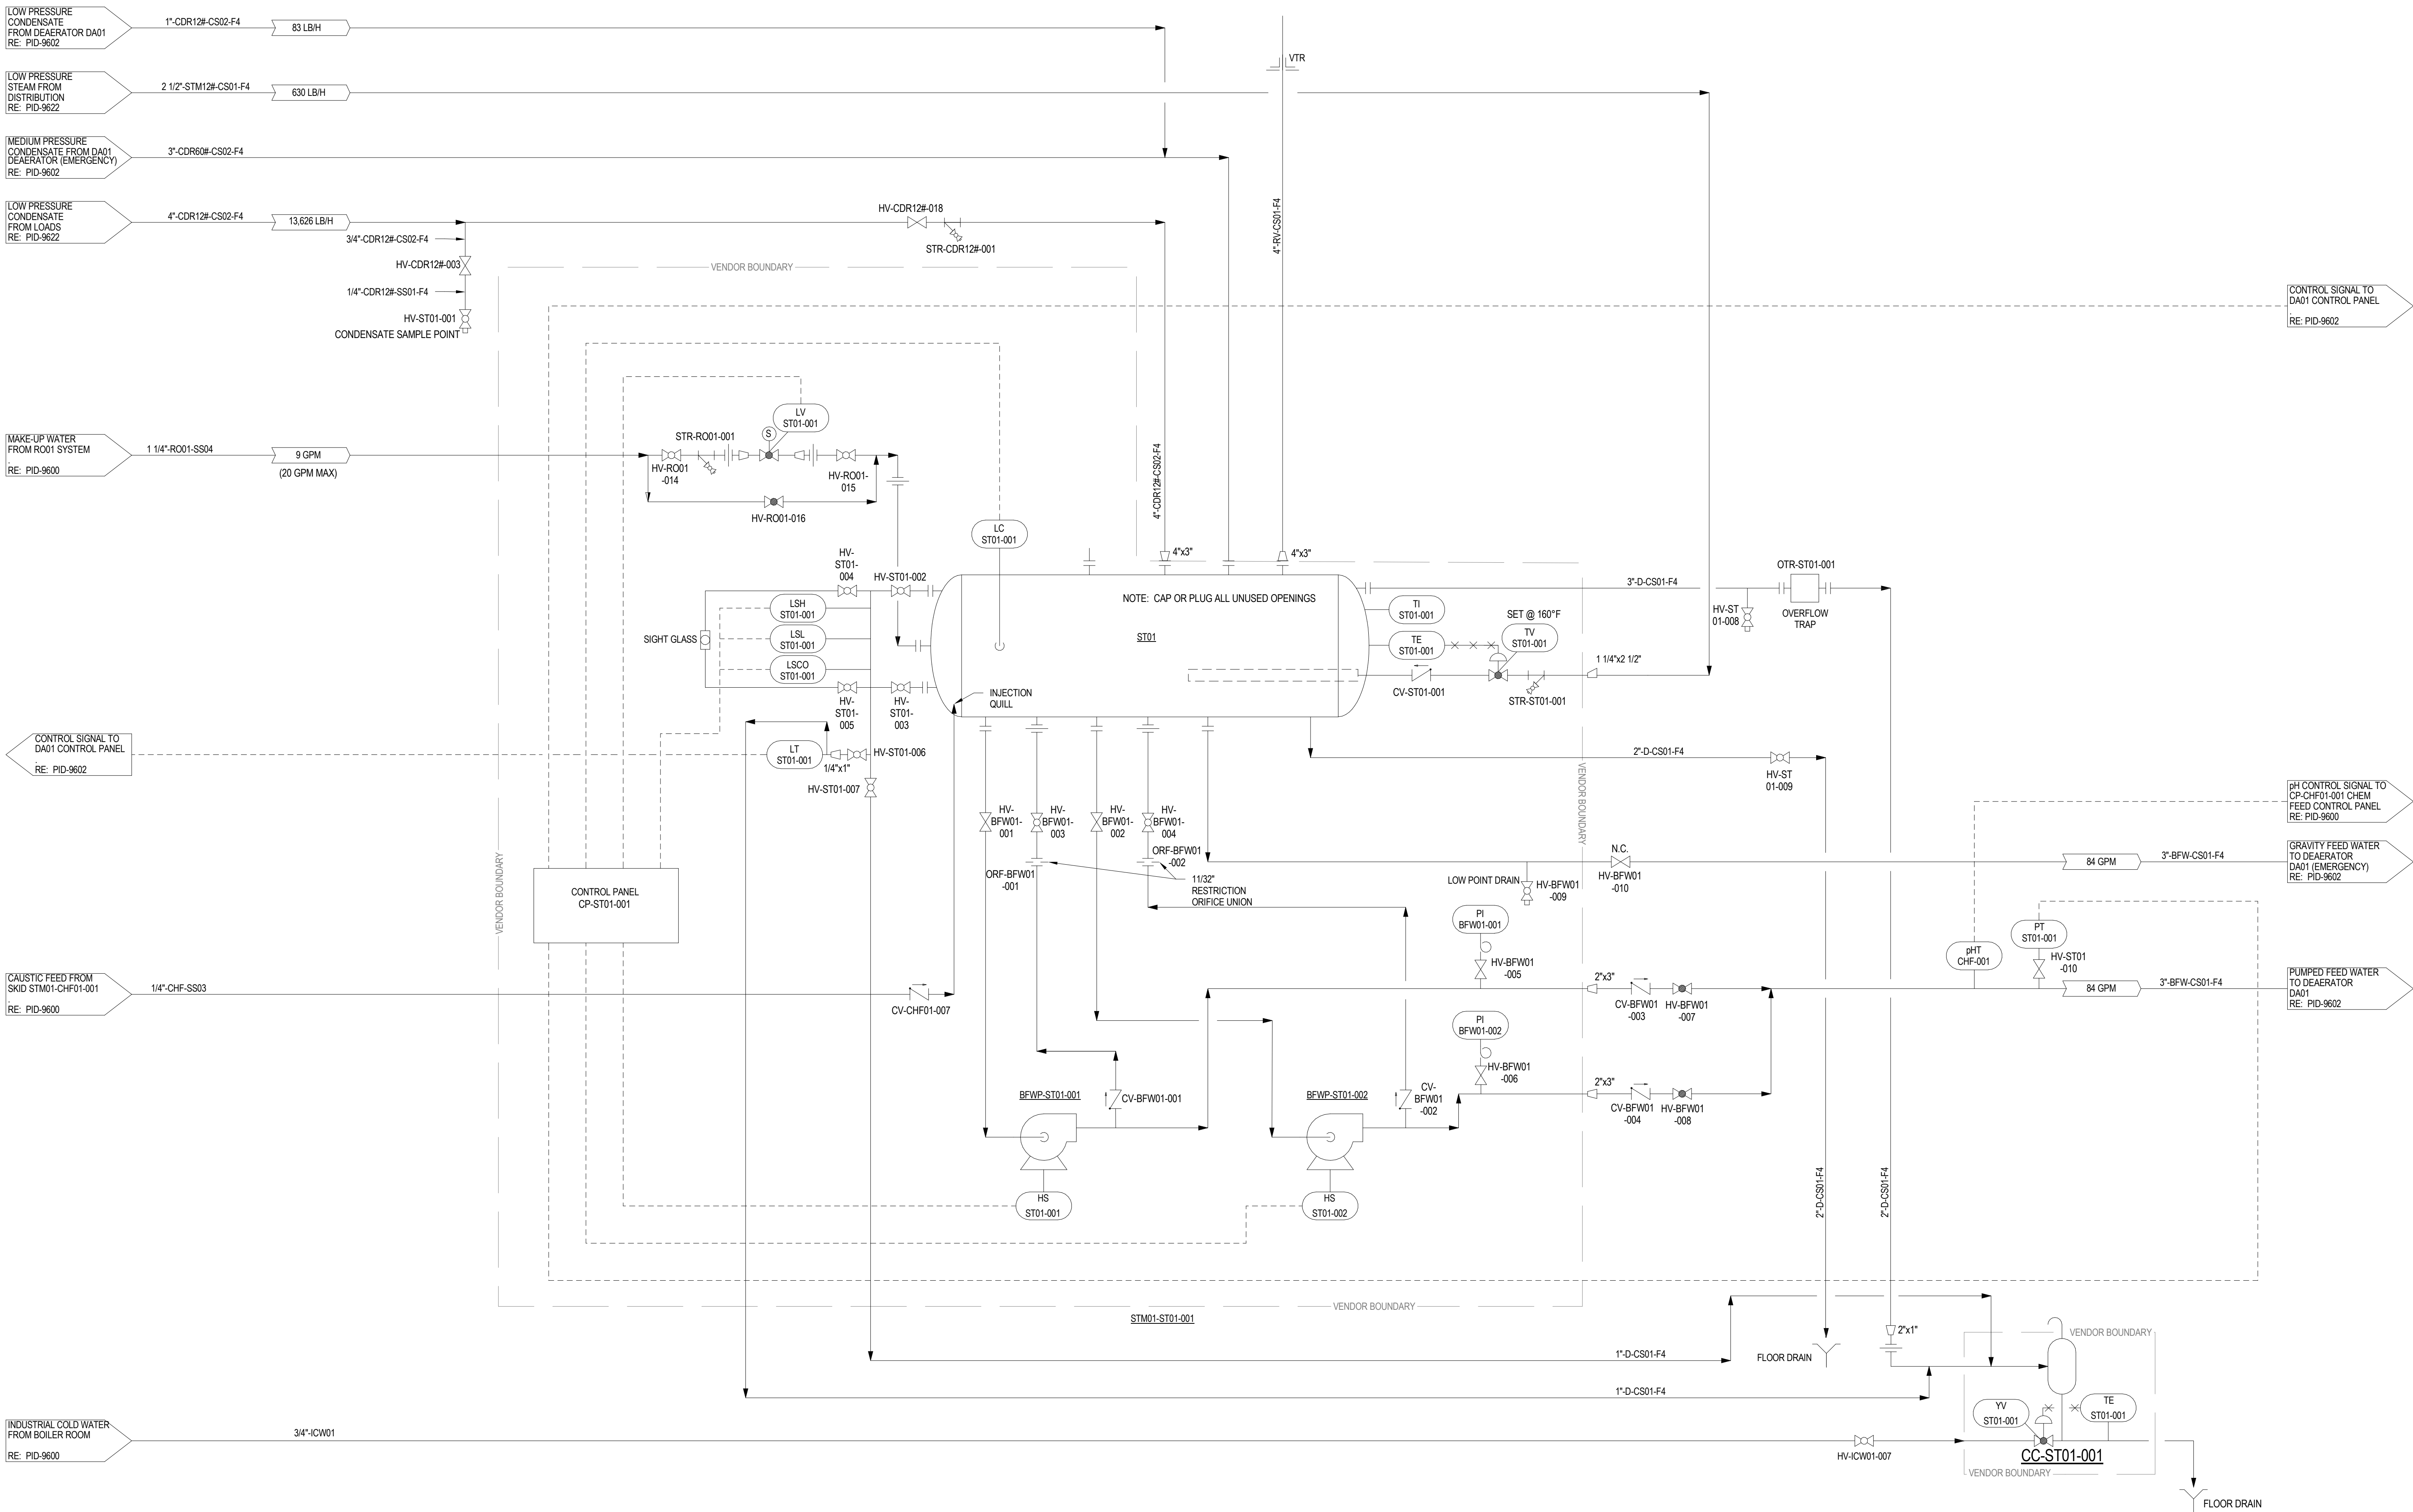

ENTIRE SHEET REISSUED FOR COORDINATION