
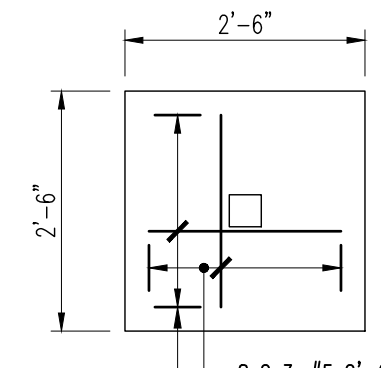


TOWNHOMES BUILDING FOUNDATION PLAN (PART 1)

REF: 2.01, S3.01 & S3.02 (DT: 2019/05/30)

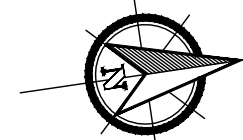


P
T-F01

DETAIL


SCALE: 3/4"=1'-0"
REF: S2.00 (DT: 2019/05/30)

08 LOCATIONS

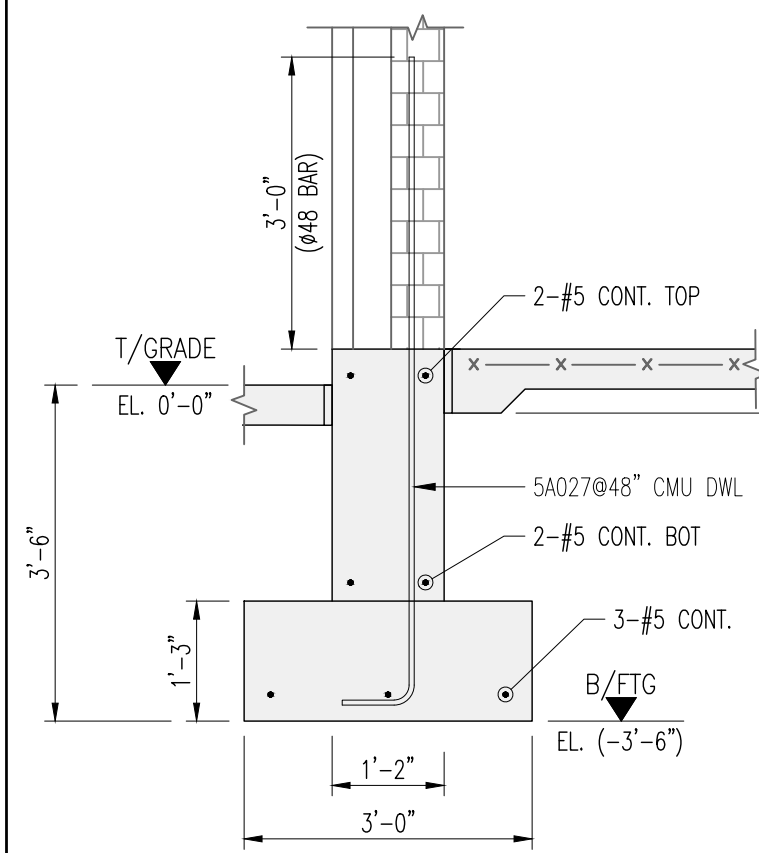


1
T-F01-T-F02

SCALE: 3/4"=1'-0"
REF: 9/S3.01 (DT: 2019/05/30)

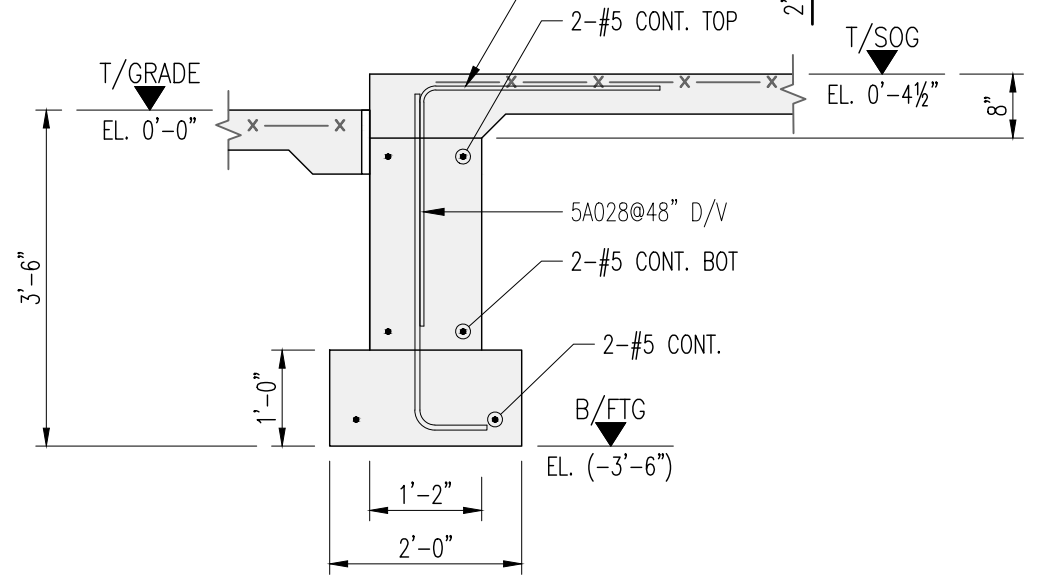

2
T-F01-T-F02


SCALE: 3/4"=1'-0"
REF: 9/S3.01 (DT: 2019/05/30)

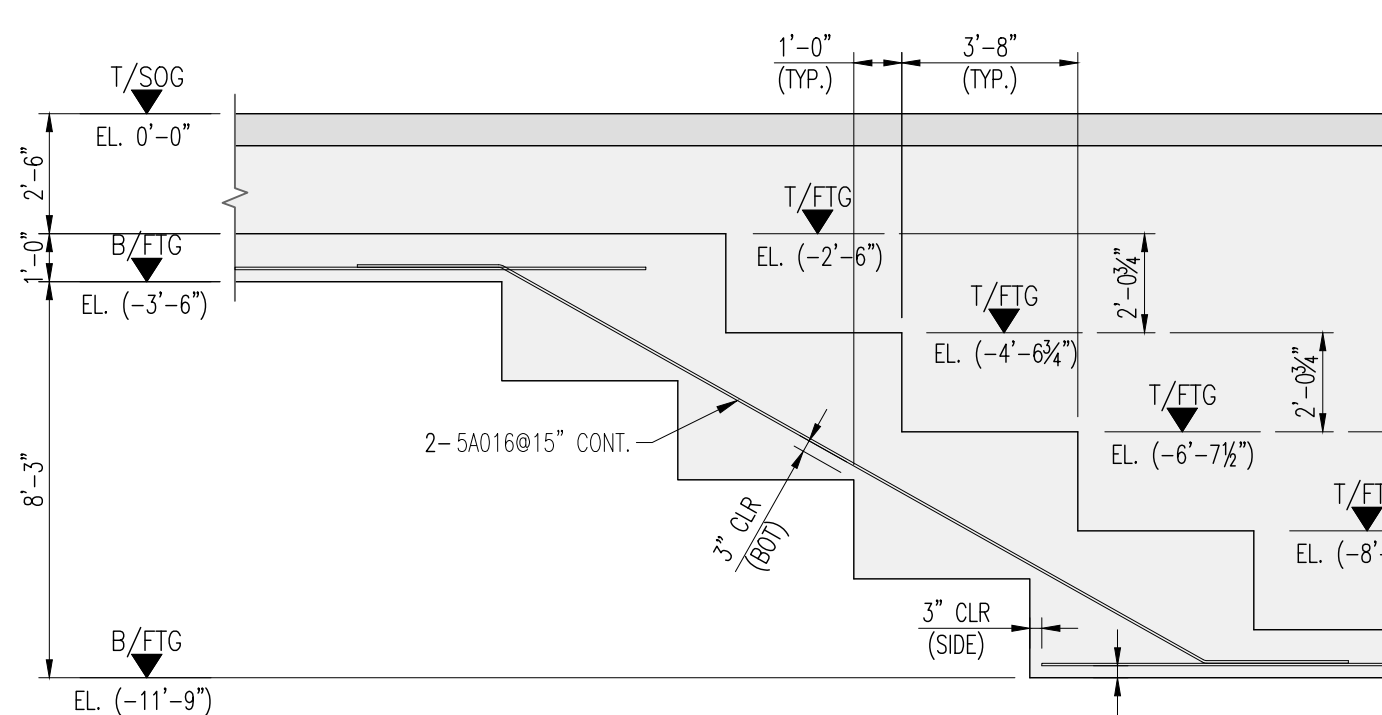

C
T-F01

FOUNDATION STEP ELEVATION


SCALE: 3/4"=1'-0"
REF: 5/S3.01 (DT: 2019/05/30)

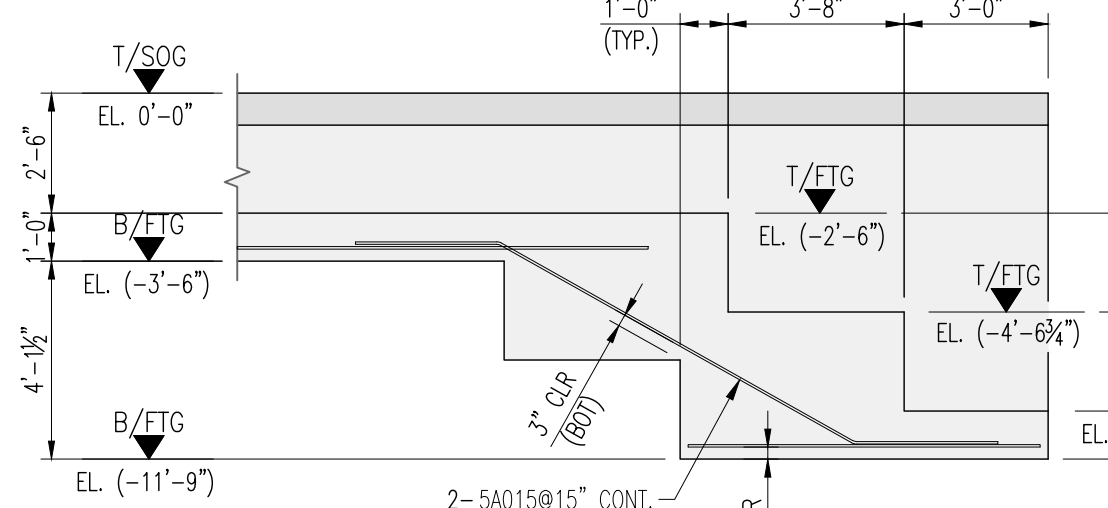

D
T-F01


FOUNDATION STEP ELEVATION

SCALE: 3/4"=1'-0"
REF: 5/S3.01 (DT: 2019/05/30)

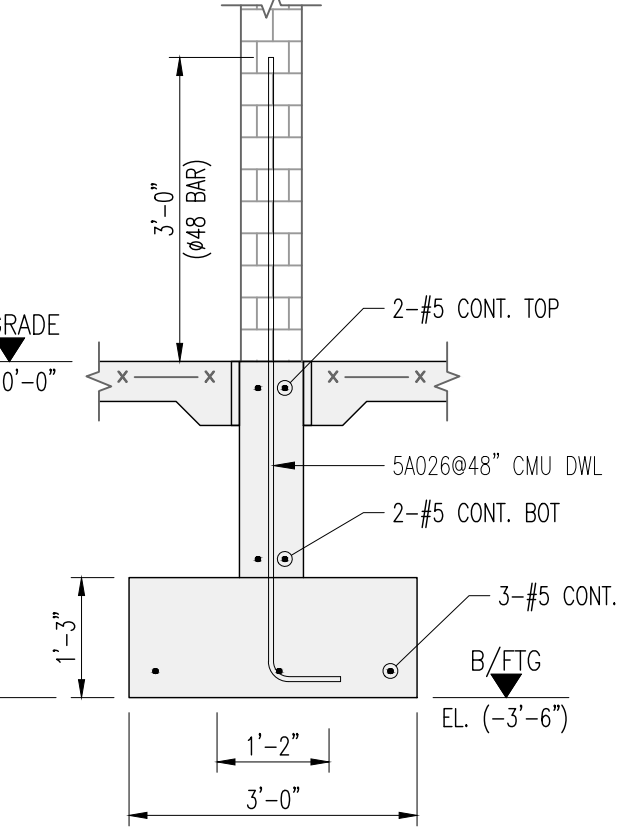

4
T-F01-T-F02


SCALE: 3/4"=1'-0"
REF: 8/S3.01 (DT: 2019/05/30)

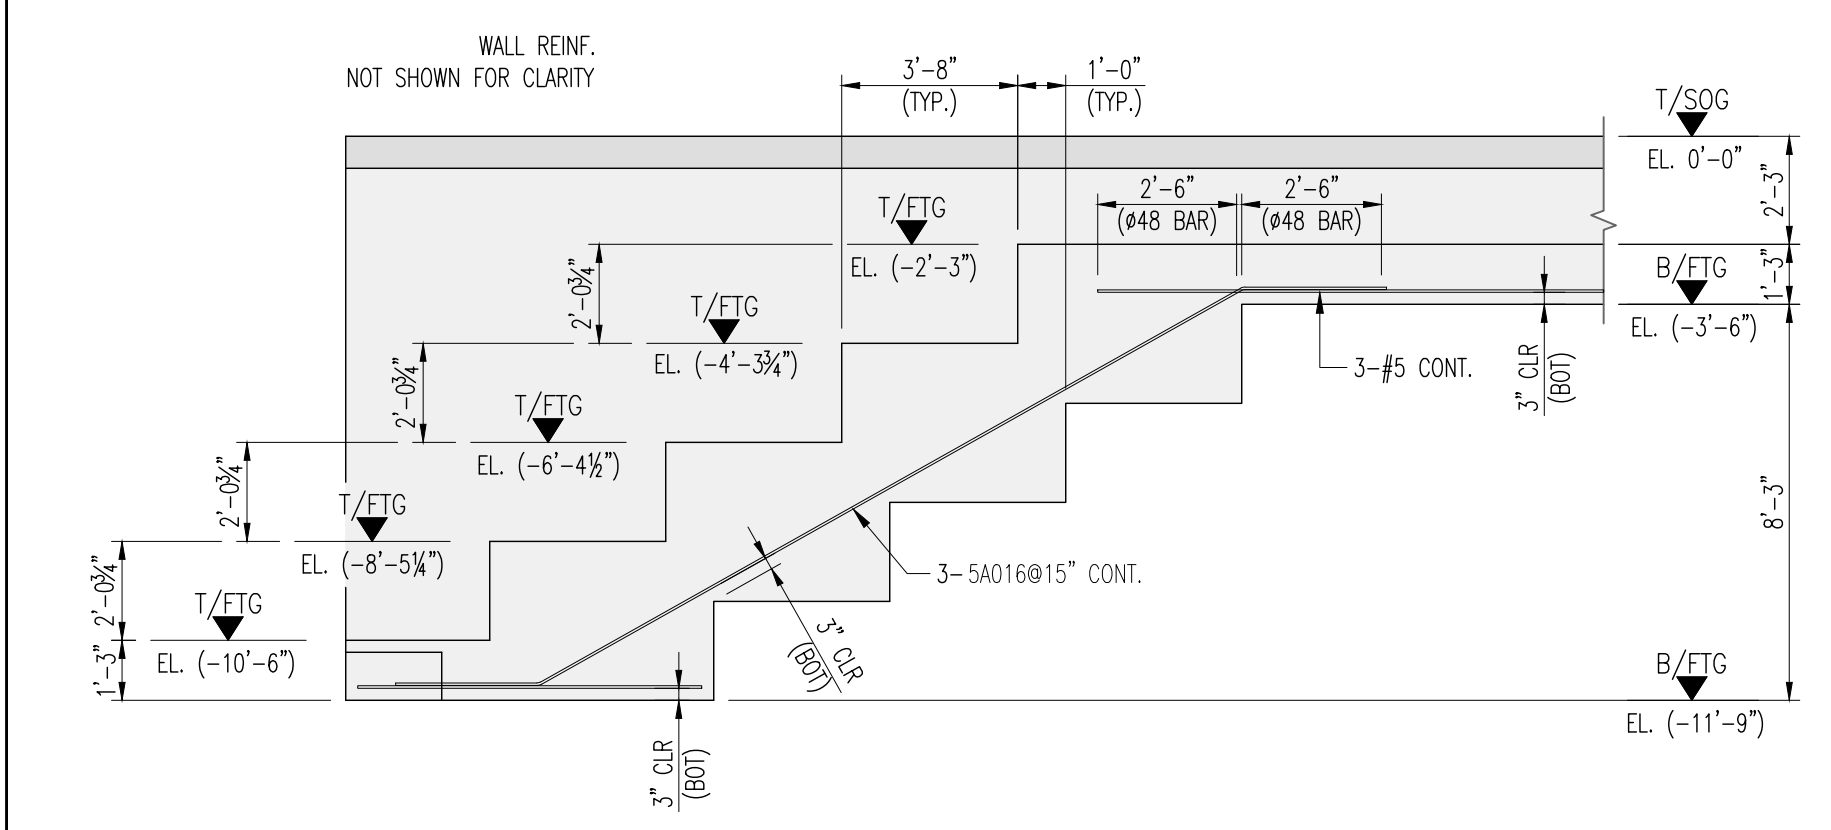

A
T-F01

FOUNDATION STEP ELEVATION


SCALE: 3/4"=1'-0"
REF: 5/S3.01 (DT: 2019/05/30)

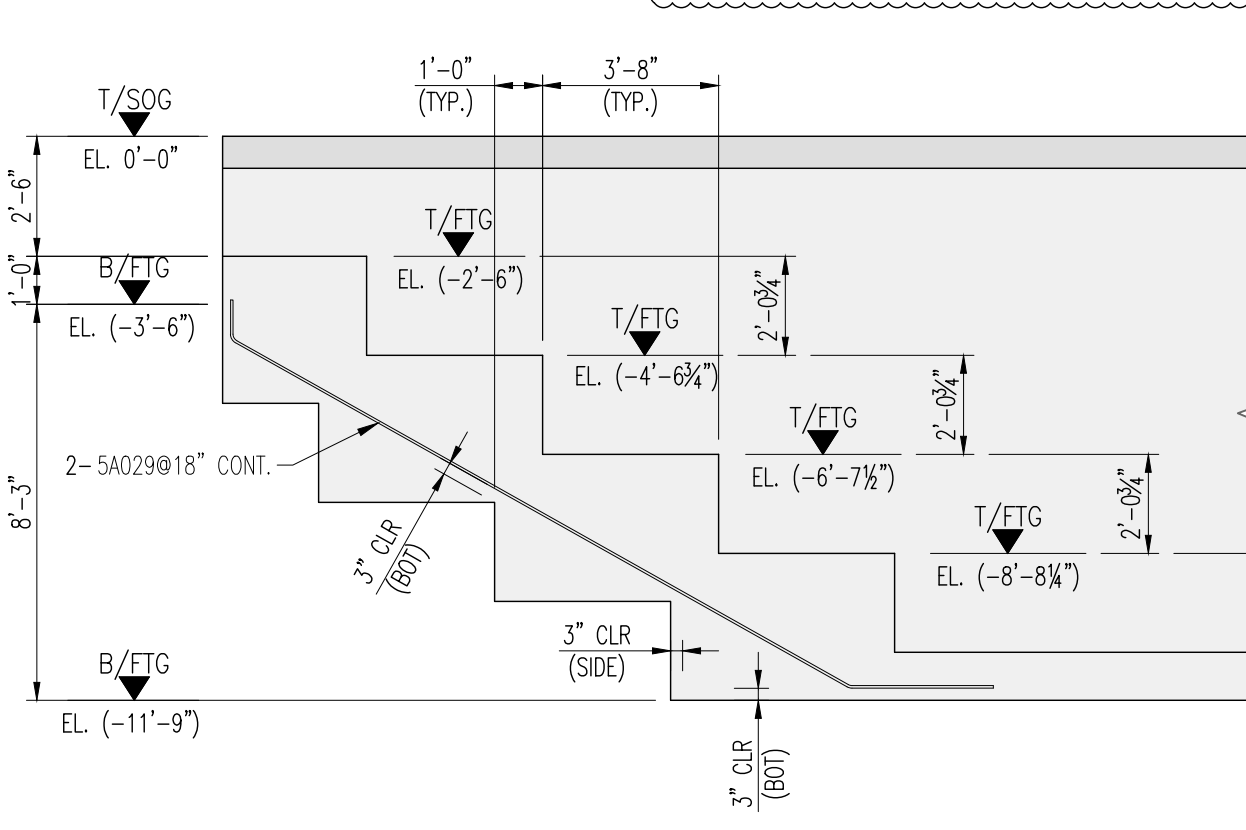

B
T-F01

FOUNDATION STEP ELEVATION

SCALE: 3/4"=1'-0"
REF: 5/S3.01 (DT: 2019/05/30)

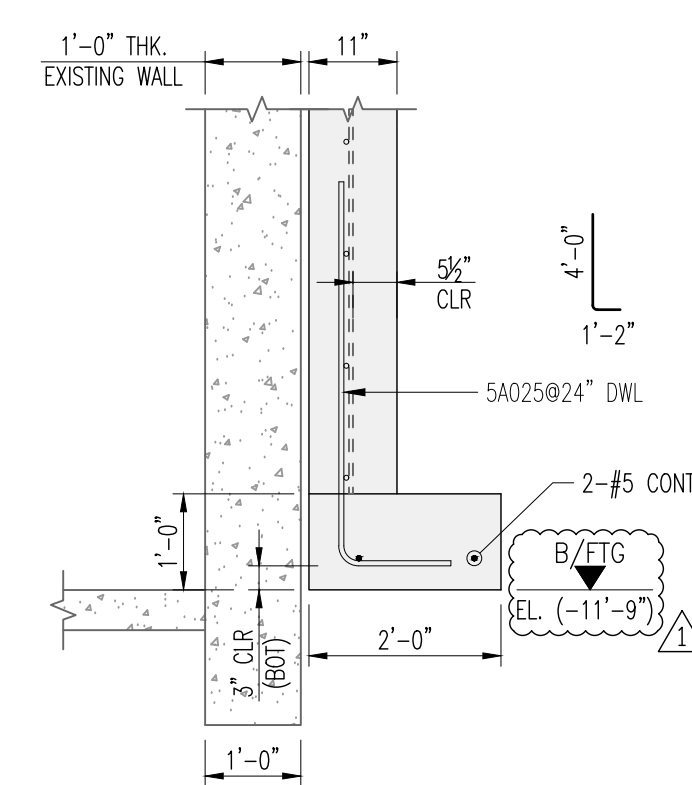


3
T-F01-T-F02

FOUNDATION STEP ELEVATION

SCALE: 3/4"=1'-0"
REF: 16/S3.01 (DT: 2019/05/30)

| Drawing Sheet: T-F01 | | | | | | | | | |
|----------------------|-----|------|--------------|------|-------|---------|-------|-------|---------|
| Bar Mark | Qty | Size | Total Length | Type | X | Y | Z | W | W |
| 5A002 | 65 | #5 | 6'-0" | 17 | 3'-0" | 3'-0" | | | |
| 5A015 | 2 | #5 | 14'-6" | 19 | 3'-0" | 8'-6" | 3'-0" | 1'-6" | 13'-8" |
| 5A016 | 8 | #5 | 22'-10" | 19 | 3'-0" | 16'-10" | 3'-0" | 1'-6" | 22'-0" |
| 5A029 | 4 | #5 | 18'-7" | 14 | 10' | 14'-9" | 3'-0" | 7'-5" | 12'-10" |
| 5A033 | 1 | #5 | 3'-4" | 3 | 2'-8" | 2'-8" | | 1'-9" | 4'-7" |

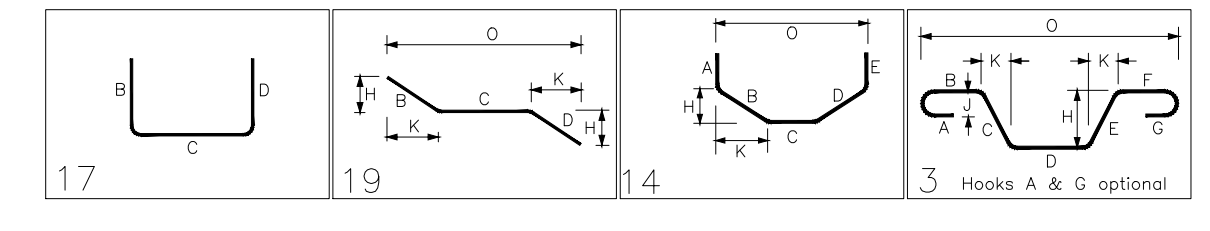

NOTES
FOR WALL FOUNDATION
BOTTOM COVER ~ 3"
SIDE COVER ~ 2"

LAP SCHEDULE
FOR WALL FOUNDATION (5000 PSI)

| BAR SIZE | LAP SCHEDULE | TOP | OTHER |
|----------|--------------|-----|-------|
| #5 | 36" | 28" | |

| BAR SIZE | LAP SCHEDULE | LAP SCHEDULE |
|----------|--------------|--------------|
| #5 | 30" | |
| #7 | 42" | |

TOP BARS ARE HORIZONTAL BARS WITH MORE THAN 12" OF CONCRETE CAST BELOW THEM.

US-CENTRAL BAR GRADE LEGEND
A615/60

ALL MATERIAL ON THIS DRAWING
SHALL BE ASTM A615 GRADE 60
U.N.O.

| Revisions and Issue Record | | | |
|--|--------------|-------|-------------------|
| No. | Description | Date | By |
| 0 | FOR APPROVAL | | |
| The full intent and purpose of this drawing is the placing of reinforcing steel bars ONLY. It is NOT to be used as a means of communication between the Architect, Engineer, Contractor or any other Sub-trades. | | | |
| THIS DRAWING IS NOT TO BE SCALED. | | | |
| Project: | | | |
| Drawing: FOUNDATION DETAILS SH 1 | | | |
| Customer: | | | |
| Contractor: | | | |
| Refer to Release: | | | |
| Date | Drawn | Chkd. | JOB No. |
| | | | Dwg. No. T-F01 |