GENERAL NOTES FOR ACCESS: (TO COMPLY WITH SECTIONS AS 1228.1-2009 & PART D3 OF THE

SECTION 6.6 VISUAL INDICATORS ON GLAZING WHERE THERE IS NO HANDRAIL OR TRANSOM ALL FULLY GLAZED DOORS. SIDELIGHTS INCLUDING GLAZING CAPABLE OF BEING MISTAKEN FOR A DOORWAY SHALL BE CLEARLY MARKED THE FULL WIDTH WITH A SOLID CONTRASTING LINE. THE CONTRASTING LINE SHALL BE NOT LESS THAT 75mm WIDE AND SHALL EXTEND ACROSS THE FULL WIDTH OF THE GLAZING. THE LOWER EDGE SHALL BE BETWEEN 900mm & 1000mm ABOVE FLOOR LEVEL. CONTRASTING LINE ON GLAZING SHALL HAVE A 30% LUMINANCE

SECTION 7 FLOOR OR GROUND SURFACES ON CONTINUOUS ACCESSIBLE PATHS OF TRAVEL

CONTRAST WHEN VIEWED AGAINST THE FLOOR SURFACE.

FLOOR SHALL HAVE A SLIP RESISTANT SURFACE WITH A MAX 5mm VARIATION IN SURFACE, CARPET OR ANY SOFT FLEXIBLE MATERIAL ON THE FLOOR SURFACE SHALL HAVE A PILE HEIGHT OF THICKNESS OF MAX OF 11mm AND CARPET BACKING SHALL BE A MAX OF 4mm IN THICKNESS. EXPOSED EDGES OF FLOOR COVERINGS SHALL HAVE A TRIM FASTENED TO THE FLOOR THE ENTIRE LENGHT OF THE EXPOSED EDGE.

SECTION 8 BRAILLE & TACTILE SIGNS

BRAILLE AND TACTILES SIGNAGE TO BE PROVIDED FOR SANITARY FACILITIES. SIGNS MUST BE NOT LESS THAN 1200mm AND NOT HIGHER THAN 1600mm ABOVE THE FLOOR SURFACE. SIGNS IDENTIFYING ROOMS MUST BE LOCATED ON THE WALL ON THE LATCH SIDE OF THE DOOR WITH THE LEADING EDGE OF THE SIGN LOCATED BETWEEN 50mm AND 300mm OR ARCHITRAVE OR WHERE NOT POSSIBLE THE SIGN MAY BE PLACED ON THE DOOR. DOORWAYS & DOOR NOTES:

(TO COMPLY WITH SECTIONS 13 AS 1428.1-2009 & PART D2.19 OF THE BCA)

- ALL EXIT DOORS TO SWING IN DIRECTION OF EGRESS.
- ALL DOORWAYS SHALL HAVE A MIN LUMINANCE CONTRAST OF 30% BETWEEN DOOR SYSTEM COMPONENTS AND
- DOORWAYS ON A CONTINUOUS PATH OF TRAVEL SHALL HAVE A 850mm CLEAR OPENING.
- DOORS THAT FORM A CONTINUOUS PATH OF TRAVEL MUST BE OPENABLE WITHOUT A KEY FROM THE SIDE THAT FACES A PERSON SEEKING EGRESS BY A SINGLE HAND DOWNWARD ACTION.

DOOR HANDLES TO BE BETWEEN 900mm AND 1100mm FROM

- CLEARANCE BETWEEN THE DOOR HAND AND DOOR FACE SHALL BE 35mm & 45mm.

O COMPLY WITH SECTIONS 13 AS 1428.1-2009 & PART F2.4 OF

- WATER TAPS TO HAVE LEVER HANDLES WITH A CLEARANCE OF 50mm FROM ADJACENT SURFACES.
- HOT & COLD WATER TO BE DELIVERED THROUGH 1 SPOUT.
- TOILET SEAT TO BE A FULL ROUND TYPE, WITH A LOAD RATING OF 150kg AND A LUMINANCE CONTRAST OF 30% WITH BACKGROUND.
- BACKREST TO BE PROVIDED AS PER DETAILS
- FLUSHING CONTROLS ZONE AS PER SECTION 15.2.5 OF AS

TOILET PAPER DISPENSER ZONE AS PER SECTION 15.2.6 OF


- AS 1428.1-2009 GRABRAILS TO BE BETWEEN 30mm & 40mm DIAMETER WITH
- A CLEARANCE OF BETWEEN 50mm & 60mm FROM ANY
- DOORS TO BE PROVIDED WITH AN IN-USE INDICATOR AND SHALL BE OPENEDED FROM THE OUTSIDE

ENERGY EFFICIENCY NOTES:

MECHANICAL VENTILATION AND AIR-CONDITIONING SYSTEM INSTALLED TO PROVIDE VENTILATION IN ACCORDANCE WITH BCA VOLUME 1 ARE TO BE COMPLIANT WITH AS 1668.2 & AS/NZS 3666.1. MECHANICAL VENTILATION AND AIR-CONDITIONING BY OWNER


MECHANICAL VENTILATION AND AIR-CONDITIONING SYSTEM INSTALLED TO PROVIDE VENTILATION IN ACCORDANCE WITH BCA VOLUME 1 ARE TO BE COMPLIANT WITH AS 1668.2 & AS/NZS 3666.1

AIR-CONDITIONING/VENTILATION SYSTEMS AND ARTIFICIAL LIGHTING TO BE DESIGNED AND INSTALLED IN ACCORDANCE WITH PARTS J5 & J6 OF THE BCA VOLUME 1 REQUIREMENTS FOR ENERGY EFFICEIENCY ALL HOT WATER SUPPLY SYSTEMS ARE REQUIRED TO BE INSTALLED IN

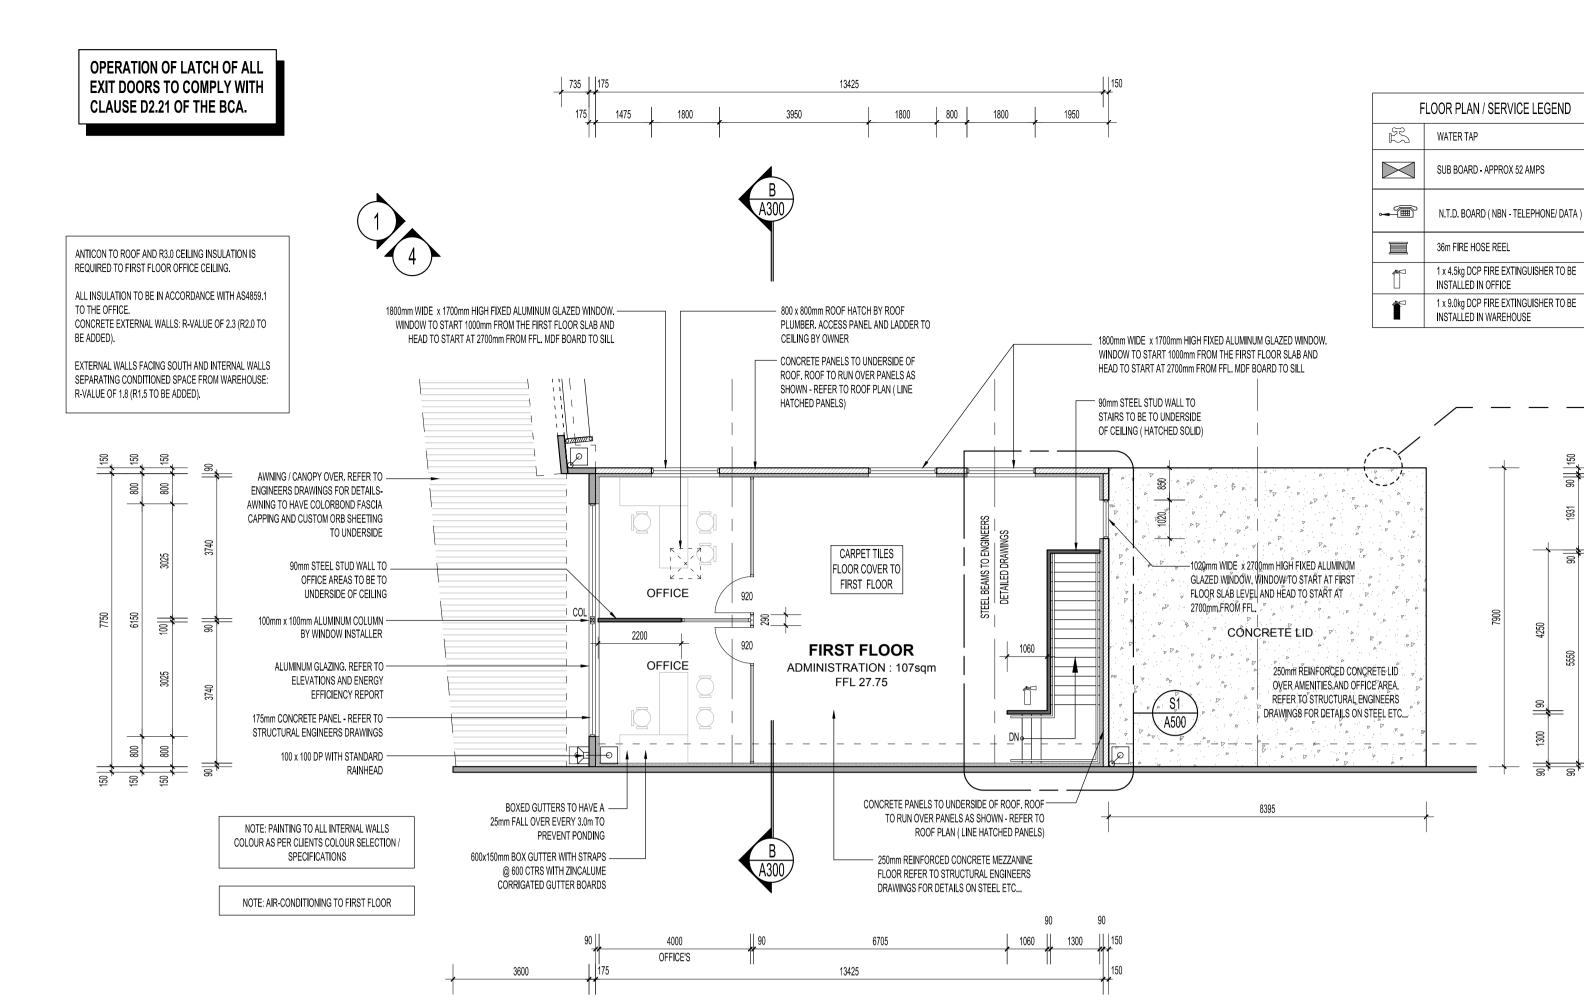

FIRST FLOOR PLAN

SCALE 1:100

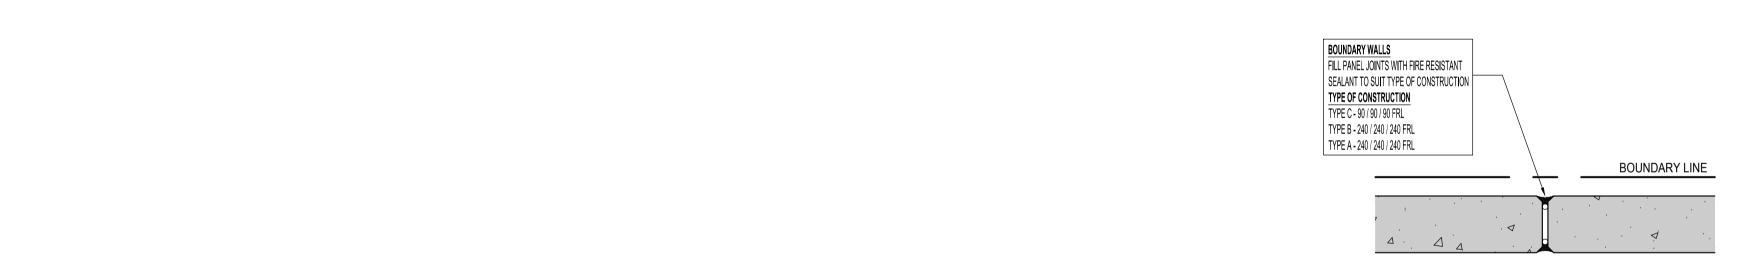

BOUNDARY PANEL JOINT DETAIL

--- CONCRETE LID / SAB

10mm GYROCK LINING

BRAILLE AND TACTILE SIGNAGE COMPLYING WITH SPECIFICATION D3.6 MUST IDENTIFY EACH DOOR REQUIRED BY

E4.5 TO BE PROVIDED WITH AN EXIT SIGN AND STATE - "EXIT"; AND "LEVEL" FOLLOWED BY THE FLOOR NUMBER.

SIGNS INCLUDING SYMBOLS, NUMBERING AND LETTERING MUST BE DESIGNED AND INSTALLED AS FOLLOWS:

SIGNS IDENTIFYING ROOMS CONTAINING FEATURES OR FACILITIES LISTED IN D3.6 MUST BE LOCATED:

AND NOT HIGHER THAN 1350MM ABOVE THE FLOOR OR GROUND SURFACE.

WHERE (I) AND (II) IS NOT POSSIBLE, THE SIGN MAY BE PLACED ON THE DOOR ITSELF.

AND 300MM FROM THE ARCHITRAVE

SIGN MUST BE PLACE ON THE CONTINUING WALL.

SIGNS MUST BE LOCATED NOT LESS THAN 1200MM AND NOT HIGHER THAN 1600MM ABOVE THE FLOOR OR GROUND

SIGNS WITH SINGLE LINES OF CHARACTERS MUST HAVE THE LINE OF TACTILE CHARACTERS NOT LESS THAN 1250MM

ON THE WALL ON THE LATCH SIDE OF THE DOOR WITH THE LEADING EDGE OF THE SIGN LOCATED BETWEEN 50MM

IN THE EVENT OF INSUFFICIENT LATCH SIDE DIMENSION, A SIGN MAY BE PLACED ON THE NON-LATCH SIDE OF THE

SIGNS IDENTIFYING PATHS OF TRAVEL MUST BE PLACED SO THEY ARE LOCATED DIRECTLY AHEAD IN THE DIRECTION

OF TRAVEL. WHERE ONE WALL CONTINUES IN THE DIRECTION OF TRAVEL AND THE OTHER FORMS A CORNER, THE

SLAB EDGE DETAIL

SCALE 1:10

250mm x 18mm MDF EDGE BEAD

FIXED TO EDGE OF SLAB WITH

PAINTED FINISH.

50 - 300

TACTILE


LOCATION OF TACTILE

EXIT SIGNS

SCALE 1:50

CHARACTERS

1250-1350mm AFL

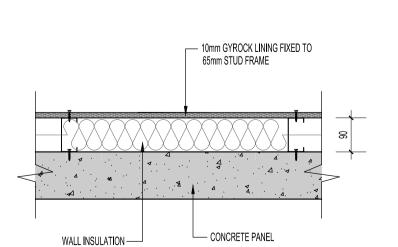

INTERNAL WALL LINING

SCALE 1:10

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PROJECT LOT 411 (#25C) BAILE ROAD

CANNING VALE WA

0 13.01.2020 J.M ISSUE FOR CONSTRUCTION

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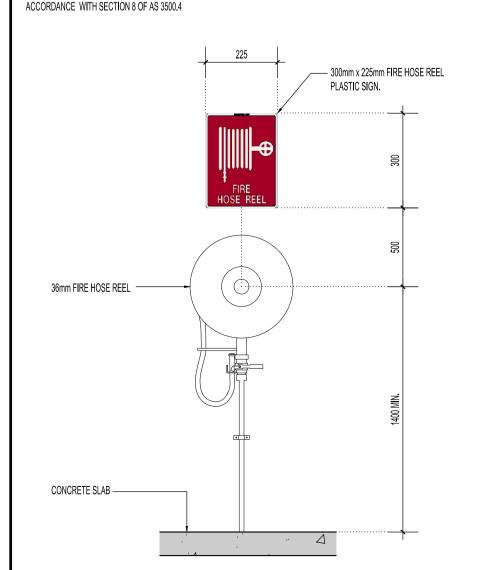
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DESCRIPTION

DRAWING TITLE: FIRST FLOOR PLAN & DETAILS


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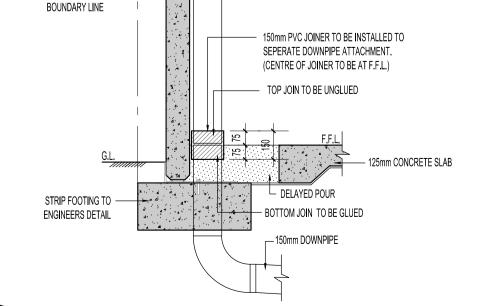
FIRE HOSE REEL SIGN

SCALE 1:20



FIRE EXTINGUISHER SIGN

TYPICAL INSTALLATION OF FIRE EXT. & SIGN SCALE 1:20

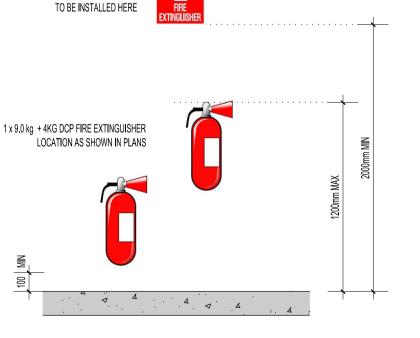

DOWNPIPE JOINER DETAIL SCALE 1:20 A102

CONCRETE PANEL

ALWAYS WITHIN -

A19014 J.MAIOLO 01/11/2019 PAGE No.