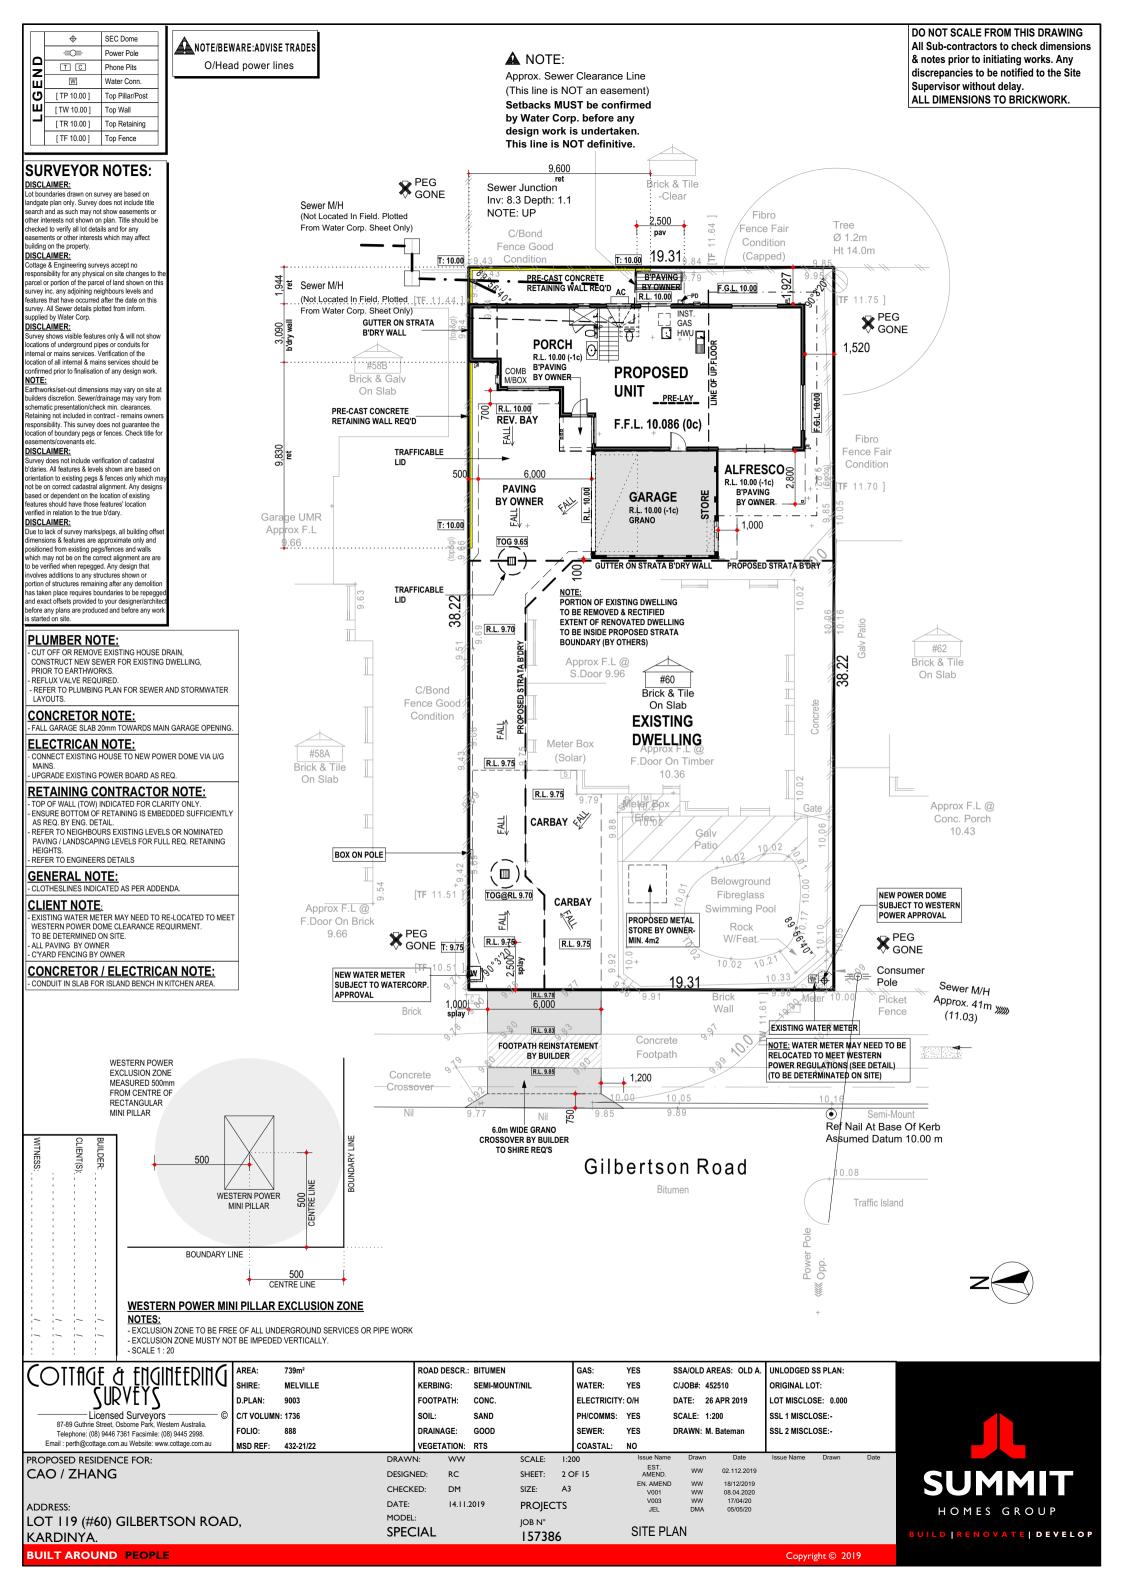


BUILT AROUND PEOPLE

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	<b>+</b>	SEC Dome
		Power Pole
	TC	Phone Pits
END	W	Water Conn.
G	[ TP 10.00 ]	Top Pillar/Post
Щ	[ TW 10.00 ]	Top Wall
-	[TR 10.00]	Top Retaining
	[TF 10.00]	Top Fence

DO NOT SCALE FROM THIS DRAWING All Sub-contractors to check dimensions & notes prior to initiating works. Any discrepancies to be notified to the Site Supervisor without delay. ALL DIMENSIONS TO BRICKWORK.

# **SURVEYOR NOTES:**

DISCLAIMER:

ot boundaries drawn on survey are based on Lot boundaries crawn on survey are based on andgate plan only. Survey does not include title search and as such may not show easements or other interests not shown on plan. Title should be checked to verify all lot details and for any assements or other interests which may affect uilding on the property.

DISCLAIMER:

DISCLAMER:
Cottage & Engineering surveys accept no responsibility for any physical on site changes to the parcel or portion of the parcel of land shown on this survey inc. any adjoining neighbours levels and features that have occurred after the date on this survey. All Sewer details plotted from inform. supplied by Water Corp.
DISCLAMED.

Supplied by Water Colp.

DISCLAIMER:

Survey shows visible features only & will not show locations of underground pipes or condults for internal or mains services. Verification of the location of all internal & mains services should be onfirmed prior to finalisation of any design work. NOTE:

arthworks/set-out dimensions may vary on site a uilders discretion. Sewer/drainage may vary from bulloers discretion. Sewerdralmage may vary from schematic presentation/check min. clearances. Retaining not included in contract - remains owners esponsibility. This survey does not guarantee the coation of boundary pegs or fences. Check title for assembls/covenants etc.

DISCLAIMER: Survey does not include verification of cadastral o'daries. All features & levels shown are based on orientation to existing pegs & fences only which man not be on correct cadastral alignment. Any designs based or dependent on the location of existing leatures should have those features' location verified in relation to the true b'dary.

DiscLaMER:

Due to lack of survey marks/pegs, all building offse dimensions & features are approximate only and positioned from existing pegs/fences and walls which may not be on the correct alignment are are which may not be on the context alignment are are to be verified when repegged. Any design that involves additions to any structures shown or portion of structures remaining after any demolition has taken place requires boundaries to be repegge and exact offsets provided to your designer/archite efore any plans are produced and before any wo

#### **ENGINEER NOTE:**

- PILING TO ENGINEER DETAILS AS INDICATED BY: ///// - CONFIRM EXTENT OF PILING.

#### CONCRETOR/BRK LAYER NOTE

NOTE BRICK WALL ON STRATA BOUNDARY HAS BEEN CALCULATED TO BE SET INSIDE THE BOUNDARY BY 100mm. NOTE BRICKWALL ON LOT BOUNDARY HAS BEEN CALCULATED TO BE SET ON BOUNDARY. - ALL ISOLATED PIERS AND POSTS TO HAVE FOOTINGS AT -3c UNLESS


NOTED OTHERWISE.

DROPPED FOOTINGS AS SPECIFIED BY MARKERS

TOP OF FOOTING DROPS FROM -2c TO -7c BETWEEN A-B.

REFER TO ELEVATIONS FOR EXTENT.

### **CONCRETOR / ELECTRICAN NOTE:**

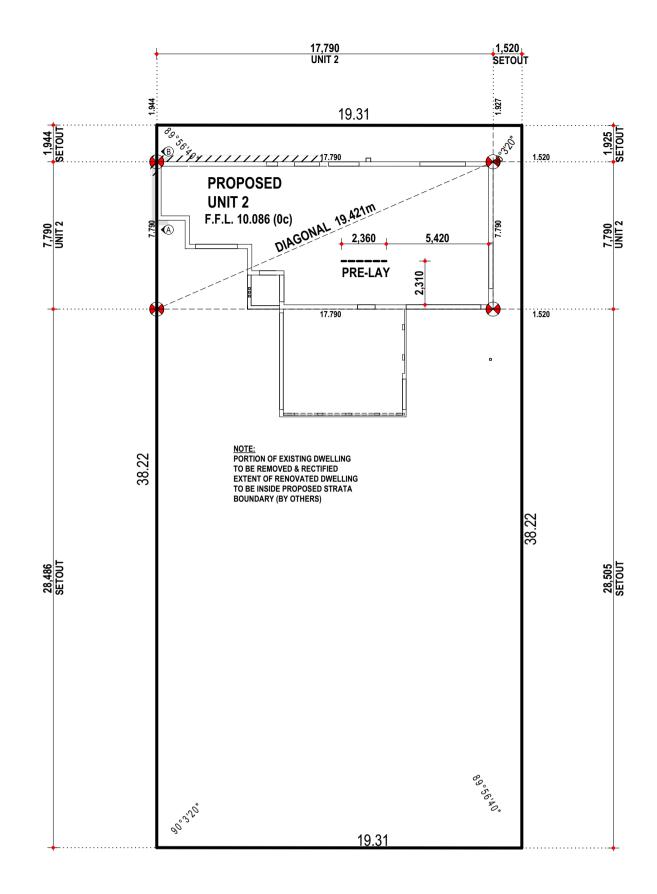

Gilbertson Road





BUILDER:

Telephone: (08) 9446 7361 Facsimile: (08) 9445 2998. Email: perth@cottage.com.au Website: www.cottage.com.au

AREA: 739m<sup>2</sup> SHIRE: MELVILLE D.PLAN: 9003 C/T VOLUMN: 1736

888

432-21/22

ROAD DESCR.: BITUMEN KERBING: SEMI-MOUNT/NIL FOOTPATH: CONC. SOIL: SAND DRAINAGE: GOOD VEGETATION: RTS

GAS: YES WATER: YES ELECTRICITY: O/H PH/COMMS: YES SEWER: YES

COASTAL:

SSA/OLD AREAS: OLD A. C/JOB#: 452510 DATE: 26 APR 2019 SCALE: 1:200 DRAWN: M. Bateman

UNLODGED SS PLAN: ORIGINAL LOT: LOT MISCLOSE: 0.000 SSL 1 MISCLOSE:-SSL 2 MISCLOSE:-

HOMES GROUP BUILD | RENOVATE | DEVELOP

PROPOSED RESIDENCE FOR: CAO / ZHANG

ADDRESS: LOT 119 (#60) GILBERTSON ROAD, KARDINYA.

FOLIO:

MSD REF:

CHECKED: DM **SPECIAL** 

ww

RC

DRAWN:

MODEL:

DESIGNED:

SCALE: 1:200 SHEET: 3 OF 15 SIZE: A3 **PROJECTS** 

JOB N°

157386

SETOUT PLAN

NO

WW WW 08.04.2020

	<del>+</del>	SEC Dome
	=0=	Power Pole
	TC	Phone Pits
Z	W	Water Conn.
G	[ TP 10.00 ]	Top Pillar/Post
Щ	[ TW 10.00 ]	Top Wall
-	[ TR 10.00 ]	Top Retaining
	[ TF 10.00 ]	Top Fence

DO NOT SCALE FROM THIS DRAWING All Sub-contractors to check dimensions & notes prior to initiating works. Any discrepancies to be notified to the Site Supervisor without delay. ALL DIMENSIONS TO BRICKWORK.

# **SURVEYOR NOTES:**

DISCLAIMER:

ot boundaries drawn on survey are based on Lot boundaries crawn on survey are based on andgate plan only. Survey does not include title search and as such may not show easements or other interests not shown on plan. Title should be checked to verify all lot details and for any assements or other interests which may affect uilding on the property.

DISCLAIMER:

DISCLAMER:
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DISCLAMED.

Supplied by Water Colp.

DISCLAIMER:

Survey shows visible features only & will not show locations of underground pipes or condults for internal or mains services. Verification of the location of all internal & mains services should be onfirmed prior to finalisation of any design work. NOTE:


arthworks/set-out dimensions may vary on site a Lardinvious/section. Identification of the control of the control

DISCLAIMER:

Survey does not include verification of cadastral o'daries. All features & levels shown are based on orientation to existing pegs & fences only which man not be on correct cadastral alignment. Any designs based or dependent on the location of existing leatures should have those features' location verified in relation to the true b'dary.

DiscLaMER:

Due to lack of survey marks/pegs, all building offse dimensions & features are approximate only and positioned from existing pegs/fences and walls which may not be on the correct alignment are are which may not be on the correct alignment are are to be verified when repegged. Any design that involves additions to any structures shown or portion of structures remaining after any demolition has taken place requires boundaries to be repegge and exact offsets provided to your designer/architer efore any plans are produced and before any wor s started on site.

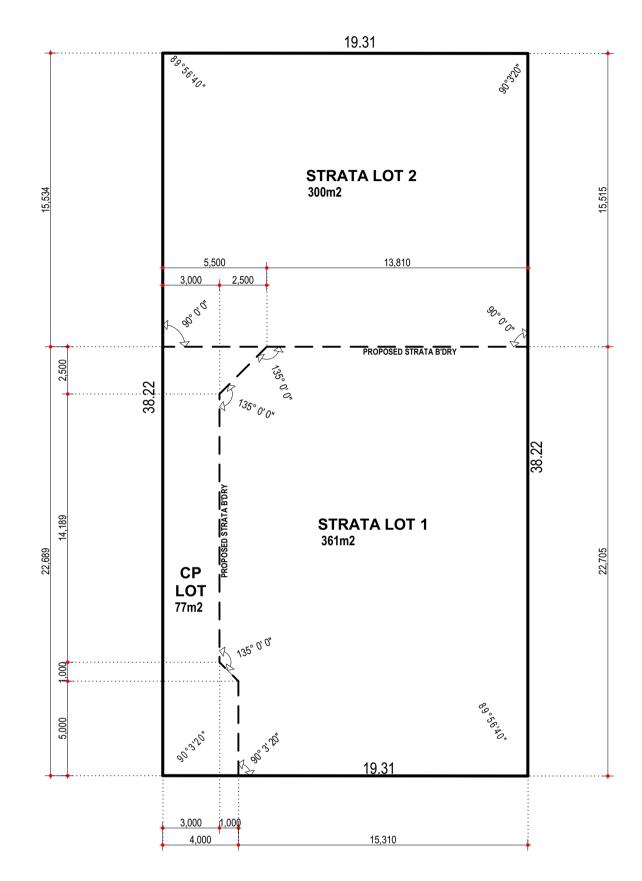

Gilbertson Road



Licensed Surveyors

87-89 Guthrie Street, Osborne Park, Western Australia.
Telephone: (08) 9446 7361 Facsimile: (08) 9445 2998. Email: perth@cottage.com.au Website: www.cottage.com.au

AREA: 739m<sup>2</sup> SHIRE: MELVILLE D.PLAN: 9003 C/T VOLUMN: 1736 FOLIO: 888

MSD REF:

ROAD DESCR.: BITUMEN KERBING: SEMI-MOUNT/NIL FOOTPATH: CONC. SOIL: SAND DRAINAGE: GOOD

GAS: YES WATER: YES ELECTRICITY: O/H PH/COMMS: YES SEWER: YES

COASTAL:

SSA/OLD AREAS: OLD A. C/JOB#: 452510 DATE: 26 APR 2019 SCALE: 1:200 DRAWN: M. Bateman

WW WW

UNLODGED SS PLAN: ORIGINAL LOT: LOT MISCLOSE: 0.000 SSL 1 MISCLOSE:-SSL 2 MISCLOSE:-

HOMES GROUP

PROPOSED RESIDENCE FOR: CAO / ZHANG

ADDRESS: LOT 119 (#60) GILBERTSON ROAD, KARDINYA.

432-21/22

DESIGNED: RC CHECKED: DM **SPECIAL** 

VEGETATION: RTS

ww

DRAWN:

MODEL:

SCALE: 1:200 SHEET: 4 OF 15 SIZE: A3 **PROJECTS** 


JOB N°

157386

STRATA PLAN

NO

08.04.2020

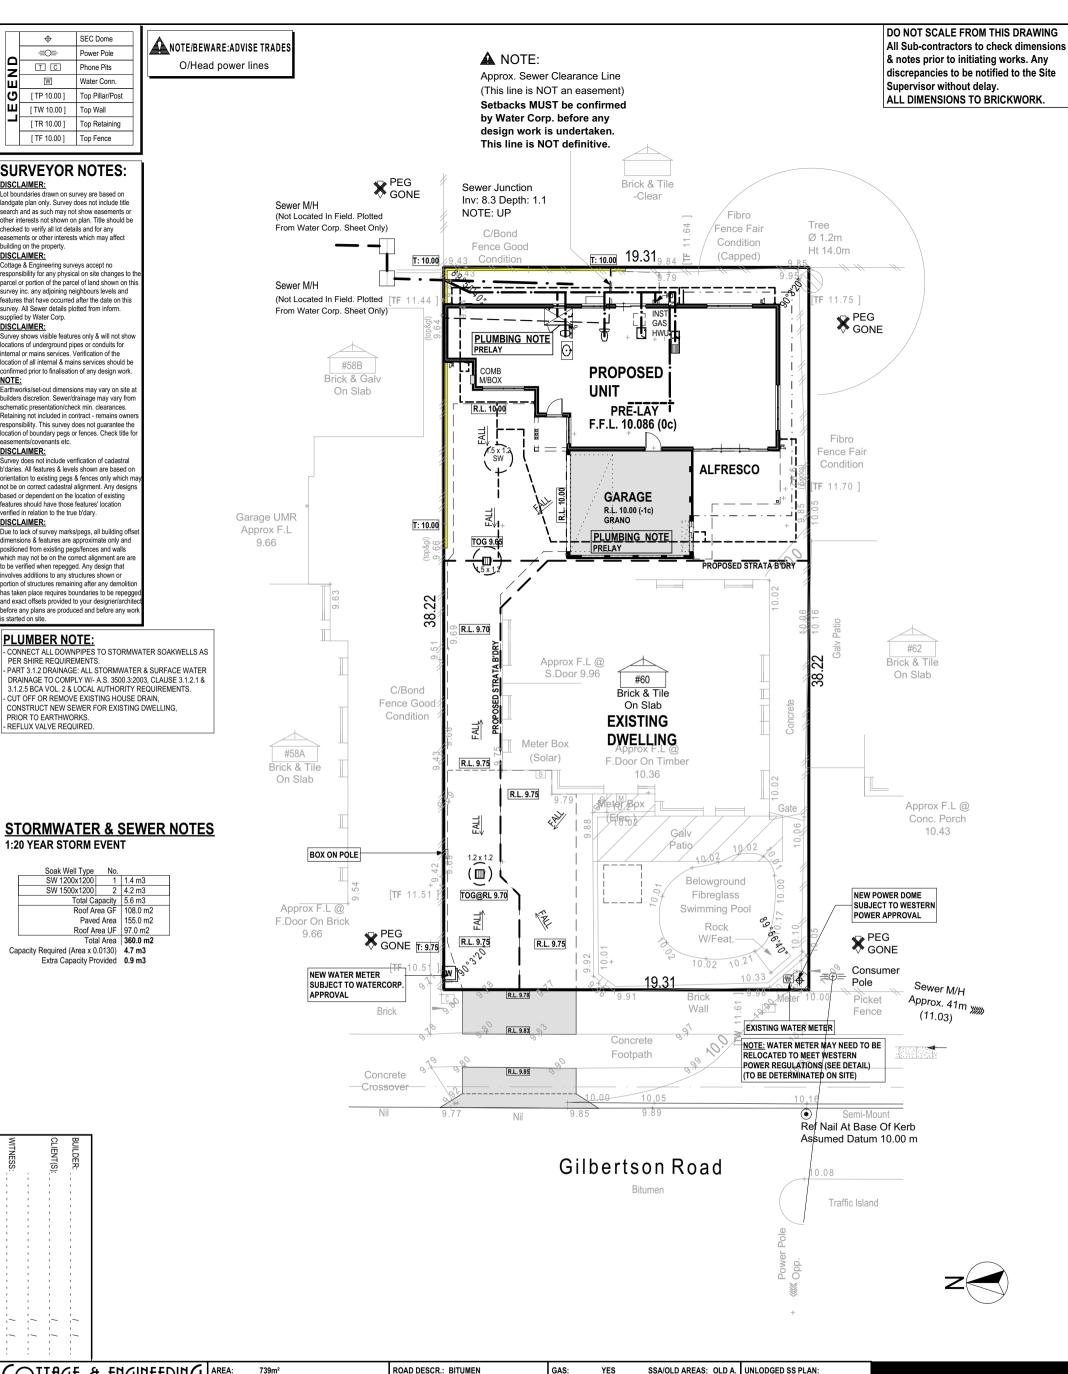



Telephone: (08) 9446 7361 Facsimile: (08) 9445 2998.

SHIRE: MELVILLE D.PLAN: 9003 C/T VOLUMN: 1736 FOLIO: 888

432-21/22

MSD REF:

KERBING: SEMI-MOUNT/NIL FOOTPATH: CONC. SOIL: SAND DRAINAGE: GOOD

VEGETATION: RTS

WATER: YES C/JOB#: 452510 ELECTRICITY: O/H DATE: 26 APR 2019 PH/COMMS: YES SCALE: 1:200 SEWER: YES DRAWN: M. Batemar

ORIGINAL LOT: LOT MISCLOSE: 0.000 SSL 1 MISCLOSE:-SSL 2 MISCLOSE:-

Email: perth@cottage.com.au Website: www.cottage.com.au PROPOSED RESIDENCE FOR: CAO / ZHANG

DRAWN: ww DESIGNED: RC CHECKED: DM DATE: 14.11.2019 MODEL:

SHEET: 5 OF 15 SIZE: A3 **PROJECTS** JOB N°

SCALE:

COASTAL:

1:200

NO

EST. AMEND. ww 02.112.2019 18/12/2019 08.04.2020 17/04/20 EN. AMEND DMA 05/05/20

PLUMBING PLAN



ADDRESS:

LOT 119 (#60) GILBERTSON ROAD, KARDINYA.

**SPECIAL** 157386 **BUILT AROUND PEOPLE** 

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SITE CLASSIFICATION - CLASS 'P' (REFER TO SITE REPORT FOR DETAILS) WIND LOAD - N1 CORROSION CLASSIFICATION - R3 DO NOT SCALE FROM THIS DRAWING **SEWER EASEMENT NOTE** TRADES / SUPERVISOR NOTE All Sub-contractors to check dimensions - PILING OR DROPPED FOOTING MAY BE REQUIRED (REFER TO ENGINEERS DETAILS) AS INDICATED BY
- CONFIRM EXTENT OF PILING. REFER TO STRUCTURAL ENGINEERS DETAILS
- ALL PLANS TO BE READ IN CONJUNCTION WITH ENGINEERS DRAWINGS & STANDARD SPECIFICATION. & notes prior to initiating works. Any //////////// discrepancies to be notified to the Site **BRICK NOTE CONCRETOR/BRK LAYER NOTE** DOOR NOTE Supervisor without delay. - NOTE BRICK WALL ON STRATA BOUNDARY HAS BEEN CALCULATED - TOILET DOOR TO COMPLY W/- CLAUSE 3 8 3 3 OF THE B C A VOL 2 ALL DIMENSIONS TO BRICKWORK. TO BE SET INSIDE THE BOUNDARY BY 100mm. - NOTE BRICKWALL ON LOT BOUNDARY HAS BEEN CALCULATED TO BE **ROOF NOTE AIRCON NOTE** TILED ROOF, GF PITCH AT 22° W/- 600W EAVES UNO STEEL ROOF FRAME TO NASH STANDARDS - GF CEILINGS AT UNDERSIDE OF TRUSSES AT 29c. - PROVIDE REVERSE CYCLE AIR CONDITIONING. OUTLET POSITIONS AS NOMINATED BY SUPPLIER.
- EXTERNAL UNIT NOT TO BE VISIBLE FROM THE STREET. SET ON BOUNDARY ALL ISOLATED PIERS AND POSTS TO HAVE FOOTINGS AT -3c UNLESS NOTED OTHERWISE. **ROOF PLUMBER NOTE PLUMBER NOTE** - DROPPED FOOTINGS AS SPECIFIED BY MARKERS (A)

TOP OF FOOTING DROPS FROM -2c TO -7c BETWEEN A-B. PROVIDE SLOTTED GUTTERS (EXC. GUTTER ON WALLS) FINAL POSITIONS OF RWP'S TO BE DETERMINED ON SITE - NO HOBS TO SHOWERS UNLESS SHOWN OTHERWISE. - PLUMBER TO INSTALL REFLUX VALVE. - REFER TO ELEVATIONS FOR EXTENT. **ROOF INSULATION NOTE ENGINEER NOTE** R4.0 CEILING INSULATION TO HOUSE, GARAGE & ANY EXTERNAL PLASTERBOARD OR VERSILUX CEILINGS IF APPL. - NOTE BLOCKOUTS TO DUCTS. - CONFIRM ROOF BEAMS AND SIZES **ELECTRICAL NOTE** ELECTRICAL NOTE

- INTERCONNECTED SMOKE DETECTORS TO COMPLY WITH AS3786-2014 AS

STORAGE ON DIAN

STORAGE ON DIAN 17,790 17,790 610 890 1,310 490 1,610 | W | 90 1,000 90 1,610 90 ens | stairs/void | store 90 950 1,90 5,790 1,190 2,410 1,460 1,490 4,870 1,410 90 1,810 230 950 µ 90 store 90 scullery 2,470 90 l'dry/pass scullery 90 660 1,160 650 90 op'ng 12,230 <u>1,500</u> 230 AC UNIT ON WALL BUILD IN SLEEVE FOR LOUVRED BRACKETS GRILLE FOR FLUMING ENS SEE ELEVATION. BUILD IN SLEEVE FOR LOUVRED GRILLE FOR FLUMING WC L'DRY, SEE ELEVATION. BRICK WALLS UNDER STAIRS HARDIFLEX SPANDREL SKIM COAT TO U/SIDE OF STAIRS GAS D.P. FROM HWU UPPER FLOOR 230 230 230 230 25x1<u>6</u>10SD D.P. 18x2410 STORE 2 WM ,620 I<sup>d</sup>y 400 x 510 SLAB NICHE UNDER UNDER CL 28c PENETRATION L'DRY 3,090 2,610 scullery CL 31c FOR A/C ABOVE SCULLER **WIR** 605W X 355H LIVING SILL AT 1100 ENS WC §8 BED 1 PROVIDE TAF CONTINUOUS BHEAD TO WISIDE UPPER FLOO / OF TRUSS / 069 D.P RAKING DW PASS 2000 AFL 1,500 HANDRAIL ,790 Α 790 UNDER STAIRS 88 8 COMB M/BOX 460 윝 90 TCHE 18x2210 CL 31c **ENTRY** ,400 D.P. FROM 4,530 kitchen DINING 2,410 510 X 310 SLAB 18x2410 **UPPER FLOOR** 820 PENETRATION GAS HP W/- UBO & R'HOOD FOR A/C ABOVE 3 x 100 **OFFICE** SHS POSTS 13,490 490 j ,800 svitv 200 500 INTERNAL B'WORK 060 D.P. MW TO 31c 820 TF 29 230 25x3954SD 810 PORCH МН B/PAVED -1c 28c CEILING 29 ja **ALFRESCO** T - BARS AT 25c 2,660 700 2cH FACE BRICK 3RD BOND TO ENG. DETAILS B/PAVED -10 1,310 28c CEILING STORE 290 **GARAGE** 5,700 100 SHS GRANO -1c CL AT 28c 2,810 pier LINTEL AT 25c W/- BWK OVER D.P **GUTTER ON WALL ON B'DRY TO DETAIL** FIXING CARPENTER NOTE 4 No. 450D SHELVES TO LINEN UNO 450D SHELF & RAIL TO ALL WIR, ROBE & ROBE REC. UNO 450D SHELF AT 1700 AFL TO BROOM CUPBOARD, IF ANY 2cH FACE BRICK 2cH FACE BRICK **(**D1) RENDER WALL NOTE PROVIDE 28mm SCOTIA TO JUNCTIONS OF RENDERED WALLS & H/FLEX / **CEILING MATERIAL NOTE** ALFRESCO (INC. AREAS SHOWN HATCHED) - VERSILUX C.L. PORCH - PLASTERBOARD C.L. GARAGE - HARDIFLEX C.L PLASTERBOARD NOTE PROVIDE PLASTERBOARD TO WALLS WHERE INDICATED BY "DW" WET AREA PLASTERBOARD TO ENSUITE AS REQUIRED. **GARAGE NOTE** CLIENT(S): - SINGLE LEAF WALL TO GARAGE IS NOT WATERPROOF 1,310 90 730 1,500 **FLOOR PLAN** - FALL GARAGE SLAB 20mm TOWARDS MAIN GARAGE OP'NG **CONCRETOR/ENGINEER NOTE** pass. 1,610 90 Area m<sup>2</sup> Perim. L/m 01. GROUND FLOOR 116.99 CONC STAIRS TO HAVE 177 RISERS & 250 GOINGS 1,510 190 ı 230 2,960 7,780 230 02. GARAGE 32.65 22.86 **BRICK LAYER NOTE** 03. PORCH 04. STORE - BUILD IN SLEEVE FOR LOUVRED GRILLE/S FOR FLUMING OF EXHAUST.FAN/VENT, SEE ELEVATION. porch 1,605 office 3.06 7.00 4,460 190 3,930 930 1,550 6.41 13.88 pos garage 6,310 05. ALFRESCO 14.44 12.05 PLUMBER/GENERAL NOTE 190 100 90 06. TOTAL AREA 171.16 62.56 - 2 STOREY FLOOR CONSTRUCTION TO BE FLOOR TECH TRUSS. REFER TO ENGINEERS DETAILS & SECTIONS. garage 290 1,210 910 400 90 07. ROOF 190 600 1,210 103.64 08. ROOF 4.64 9.18 620 880 2,210 3,954 646 6,690 4,600 1,500 3,300 11,290 1,700 17,790 PROPOSED RESIDENCE FOR: DRAWN: ww SCALE: 1:100 WW WW DMA EN. AMEND 18/12/2019 CAO / ZHANG DESIGNED: RC SHEET: 6 OF 15 V001 V003 08.04.2020 17/04/20 05/05/20 CHECKED: DM SIZE: A3 DATE: **PROIECTS** ADDRESS: HOMES GROUP MODEL: LOT 119 (#60) GILBERTSON ROAD, IOB N° FLOOR PLAN **SPECIAL** BUILD | RENOVATE | DEVELOP KARDINYA. 157386

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**BUILT AROUND PEOPLE** 

#### **BRICK NOTE**

#### **ROOF NOTE**

TILED ROOF, UF PITCH AT 25° WI- 500W EAVES UNO STEEL ROOF FRAME TO NASH STANDARDS - UF CEILINGS AT 61c + PL

## **ROOF PLUMBER NOTE**

PROVIDE SLOTTED GUTTERS (EXC. GUTTER ON WALLS)
FINAL POSITIONS OF RWP'S TO BE DETERMINED ON SITE
RWP'S IN PORCH TO BE STRAIGHT CONNECTION TO STORMWATER SYSTEM (NO KICK)

#### ROOF INSULATION NOTE

- R4.0 CEILING INSULATION TO HOUSE, GARAGE & ANY EXTERNAL PLASTERBOARD OR VERSILUX CEILINGS IF APPL.

#### **ELECTRICAL NOTE**

- INTERCONNECTED SMOKE DETECTORS TO COMPLY WITH AS3786-2014 AS INDICATED ON PLAN (S)

#### FIXING CARPENTER NOTE

- 450D SHELF & RAIL TO ALL WIR, ROBE & ROBE REC. UNO PROVIDE MID-SHELF SUPPORT WHERE NOTED "MSS" TO ANY SHELF
- OVER 1.8m LONG.
   PROVIDE MDF CAPPING TO LOW WALL, AS INDICATED.
   PROVIDE MDF SLAB EDGE TRIM, AS INDICATED
- RENDER WALL NOTE

- PROVIDE 28mm SCOTIA TO JUNCTIONS OF RENDERED WALLS & H/FLEX / VERSILUX CEILINGS

#### TRADES / SUPERVISOR NOTE

# - REFER TO STRUCTURAL ENGINEERS DETAILS - ALL PLANS TO BE READ IN CONJUNCTION WITH ENGINEERS DRAWINGS

& STANDARD SPECIFICATION

#### DOOR NOTE

230

230

TOILET DOOR TO COMPLY W/- CLAUSE 3.8.3.3 OF THE B.C.A VOL. 2

# **AIRCON NOTE**

PROVIDE REVERSE CYCLE AIR CONDITIONING. OUTLET POSITIONS AS NOMINATED BY SUPPLIER.
- EXTERNAL UNIT NOT TO BE VISIBLE FROM THE STREET.

#### PLASTERBOARD NOTE

- PROVIDE PLASTERBOARD TO WALLS WHERE INDICATED BY "DW" - WET AREA PLASTERBOARD TO ENSUITE AS REQUIRED.

#### **UPPER FLOOR NOTE**

- STAIR CONSTRUCTION STAIRWAY TREADS NON-SLIP TO TABLE 3.9.1.1 BCA VOL. 2 - HANDRAIL CONSTRUCTION

  - HANDRAILS TO COMPLY W.- CLAUSE 3.9.2.3 & 3.9.2.4 BCA VOL. 2
     PROTECTION OF OPENABLE WINDOWS
    BEDROOM WINDOWS TO COMPLY W.- CLAUSE 3.9.2.5 BCA VOL. 2

#### **ENGINEER NOTE**

- NOTE BLOCKOUTS TO DUCTS. - CONFIRM ROOF BEAMS AND SIZES.

#### **CONCRETOR/ENGINEER NOTE**

- CONC STAIRS TO HAVE 177 RISERS & 250 GOINGS


# PLUMBER/GENERAL NOTE

- 2 STOREY FLOOR CONSTRUCTION TO BE FLOOR TECH TRUSS. REFER TO ENGINEERS DETAILS & SECTIONS.


#### **PRESTART NOTE**


- NOTE LOCATION OF PLUMBING FIXTURES ON UPPER STOREY. DISCUSS POSSIBLE SOUND INSULATION OF WASTE PIPES IN BULKHEADS AND/OR

DO NOT SCALE FROM THIS DRAWING All Sub-contractors to check dimensions & notes prior to initiating works. Any discrepancies to be notified to the Site Supervisor without delay. ALL DIMENSIONS TO BRICKWORK.

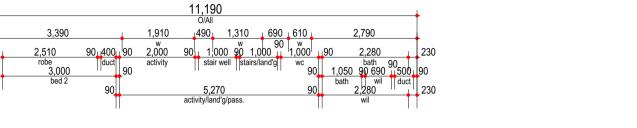



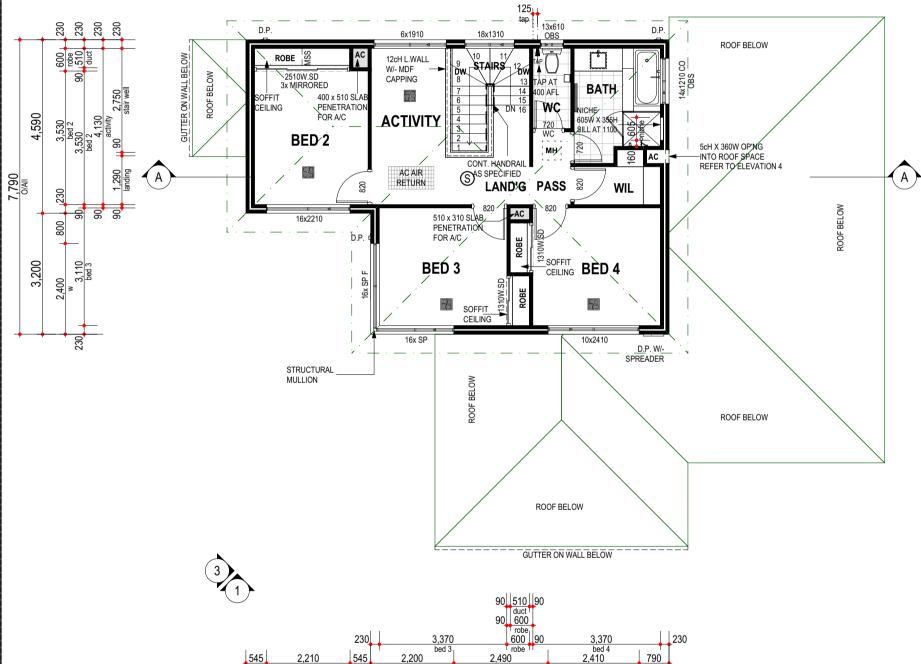

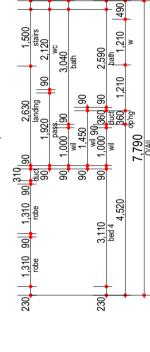



# **UPPER FLOOR PLAN**

Area m<sup>2</sup> Perim. L/m 01. UPPER FLOOR 02. ROOF 76.61 96.59



37.96 41.96

PROPOSED RESIDENCE FOR:

CAO / ZHANG

ADDRESS: LOT 119 (#60) GILBERTSON ROAD, DRAWN: ww DESIGNED: RC CHECKED: DM DATE: MODEL:

**SPECIAL** 

2,200

11,190 O/All

545

3,300

545

SCALE: 1:100 SHEET: 7 OF 15 SIZE: A3

**PROJECTS** 

157386

JOB N°

2,490

7,890


WW WW WW EN. AMEND


UPPER FLOOR PLAN


790

18/12/2019 08.04.2020 17/04/20 05/05/20

BUILD | RENOVATE | DEVELOP

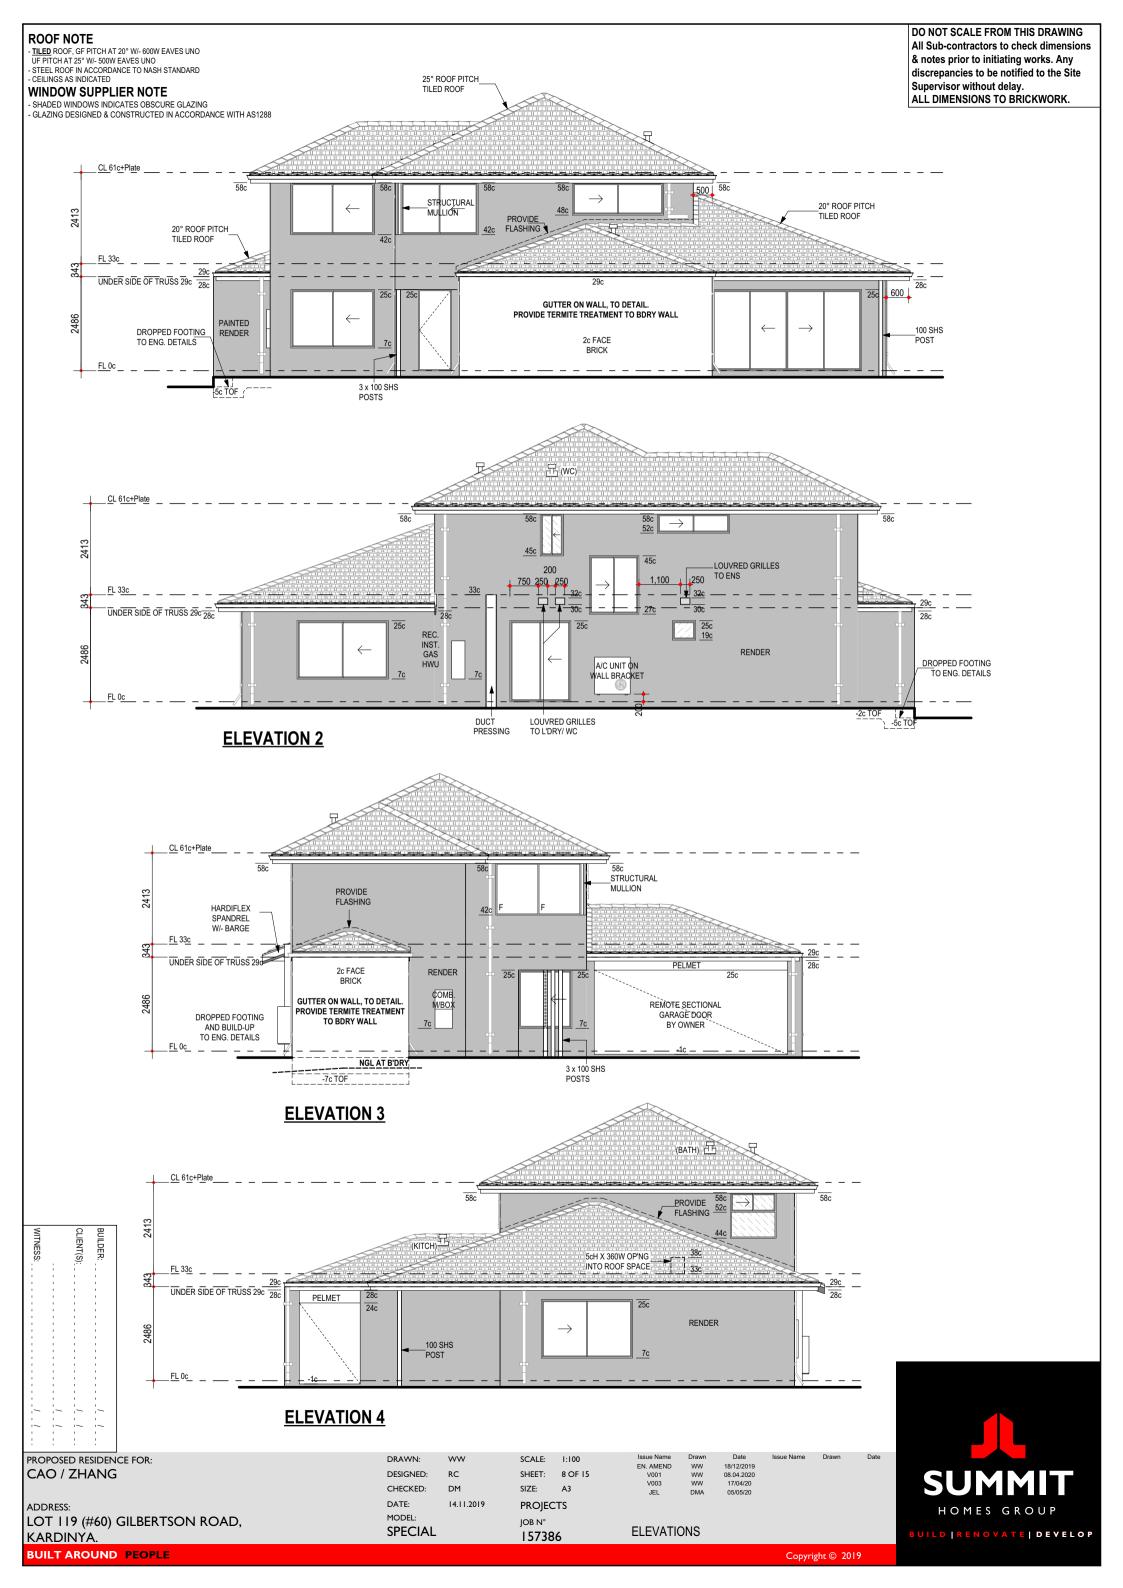

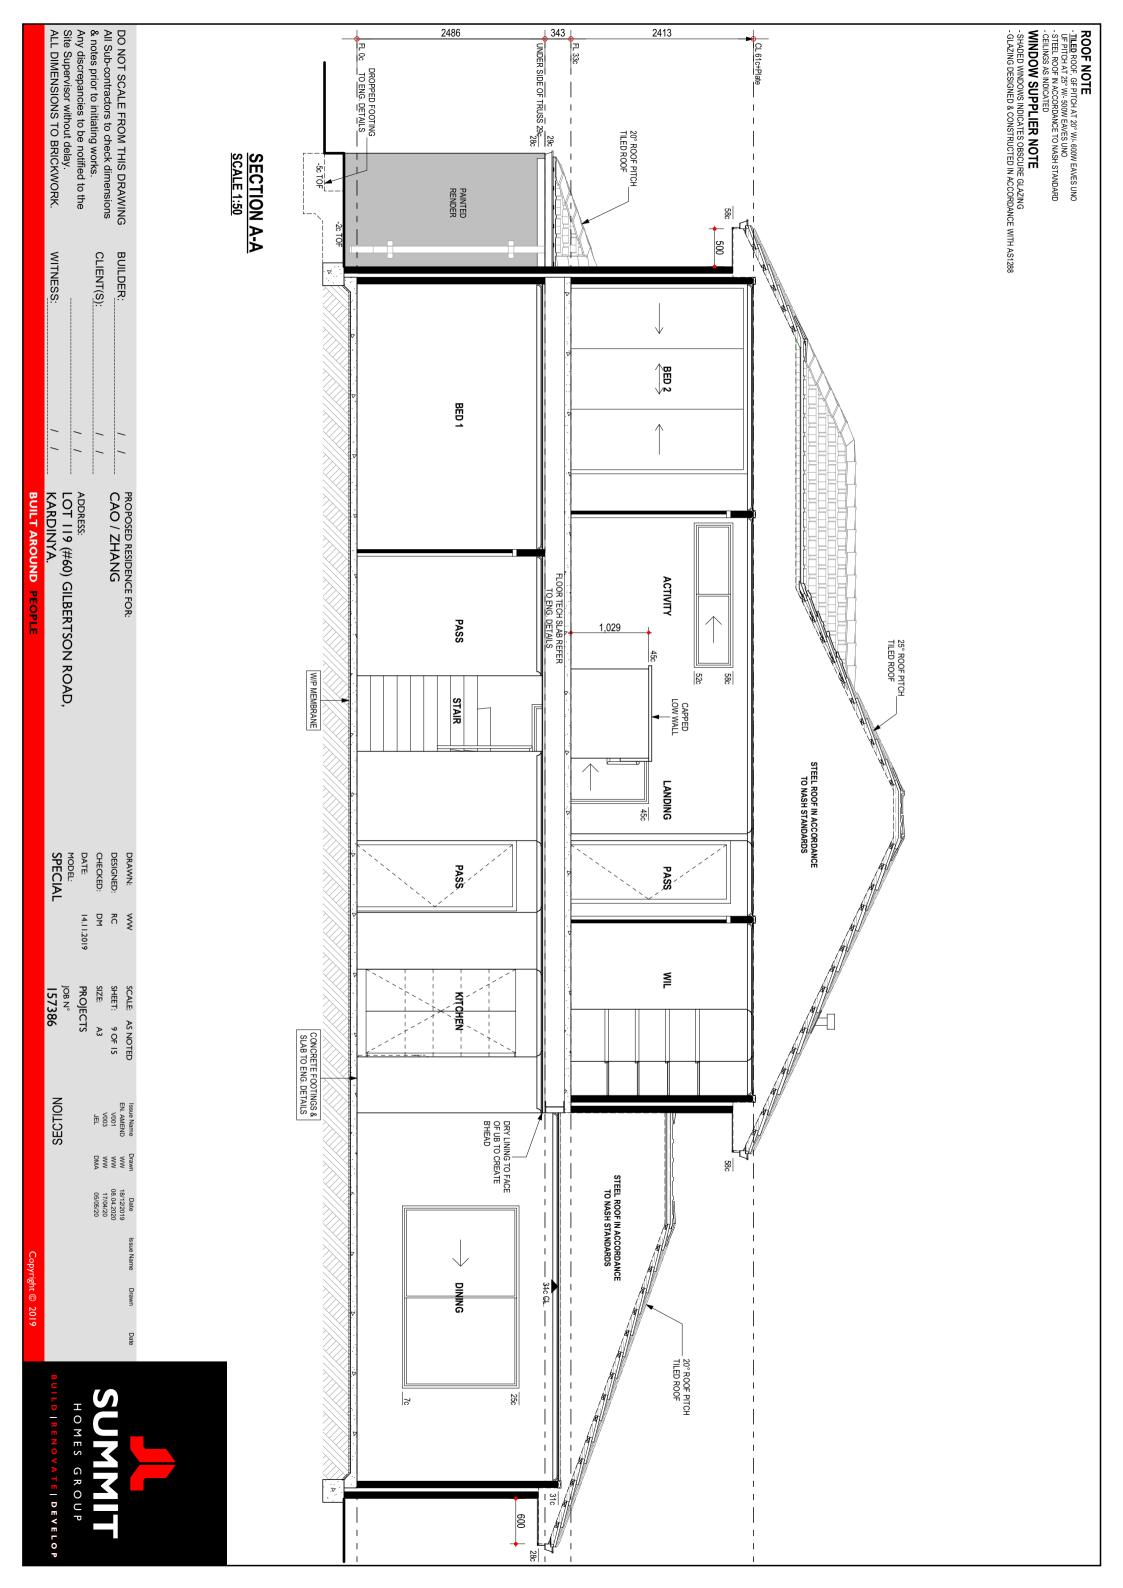


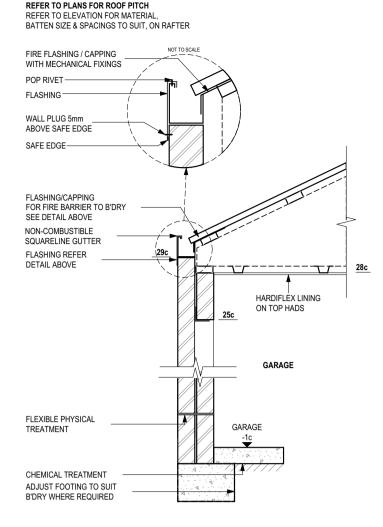

#### **D1 - GUTTER ON WALL / FLASHING DETAIL TO GARAGE** W/- PHYSICAL TERMITE TREATMENT


#### NOTES:

- REFER TO ENGINEERS DRAWINGS FOR TIE DOWN DETAILS & BULKHEAD DETAILS WALL THICKNESS & FINISH NOT SHOWN FOR CLARITY. REFER TO PLANS
- REFER TO ENGINEERS DRAWINGS FOR FOOTING AND SLAB DETAILS STEEL ROOF CONSTRUCTED IN ACCORDANCE TO MANUFACTURER'S SPEC.

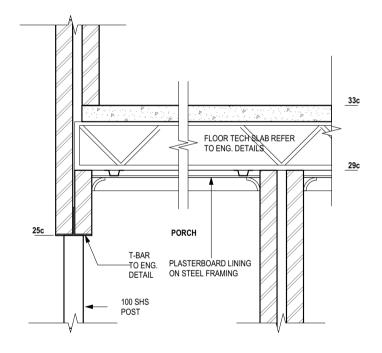


# **D3 - PORCH DETAILS**

- REFER TO ENGINEERS DRAWINGS FOR TIE DOWN DETAILS SCALE 1: 20

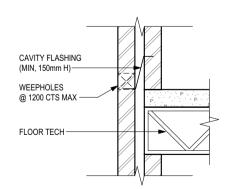


## TYPICAL CAVITY FLASHING DETAIL - TO UPPER FLOOR FLOOR TECH & CONC. SLAB

- ENSURE CAVITY IS CLEAN
- MAINTAIN WEEHOLES THROUGH RENDER (IF ANY)
- SCALE 1:20

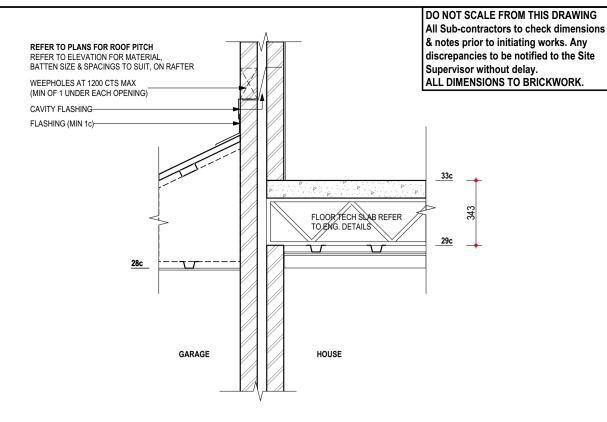

### **D2 - GARAGE DETAIL**

- NOTES:
   REFER TO ENGINEERS DRAWINGS FOR TIE DOWN DETAILS & BULKHEAD DETAILS
- WALL THICKNESS & FINISH NOT SHOWN FOR CLARITY. REFER TO PLANS REFER TO ENGINEERS DRAWINGS FOR FOOTING AND SLAB DETAILS
- STEEL ROOF CONSTRUCTED IN ACCORDANCE TO MANUFACTURER'S SPEC
- SCALE 1 : 20

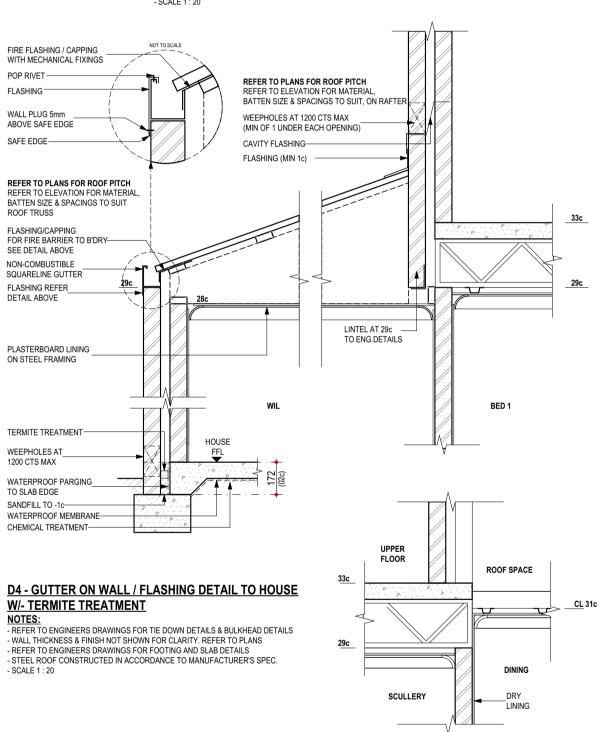

PROPOSED RESIDENCE FOR: CAO / ZHANG

ADDRESS: LOT 119 (#60) GILBERTSON ROAD, DRAWN: ww DESIGNED: RC CHECKED: DM MODEL:

**SPECIAL** 

SCALE: AS NOTED SHEET: 10 OF 15 SIZE: **PROJECTS** 

JOB N°

157386

EN. AMEND

**DETAILS** 


18/12/2019 08.04.2020 17/04/20 05/05/20


WW WW DMA


**D5 - DETAIL** - SCALE 1 : 20




BUILD | RENOVATE | DEVELOP

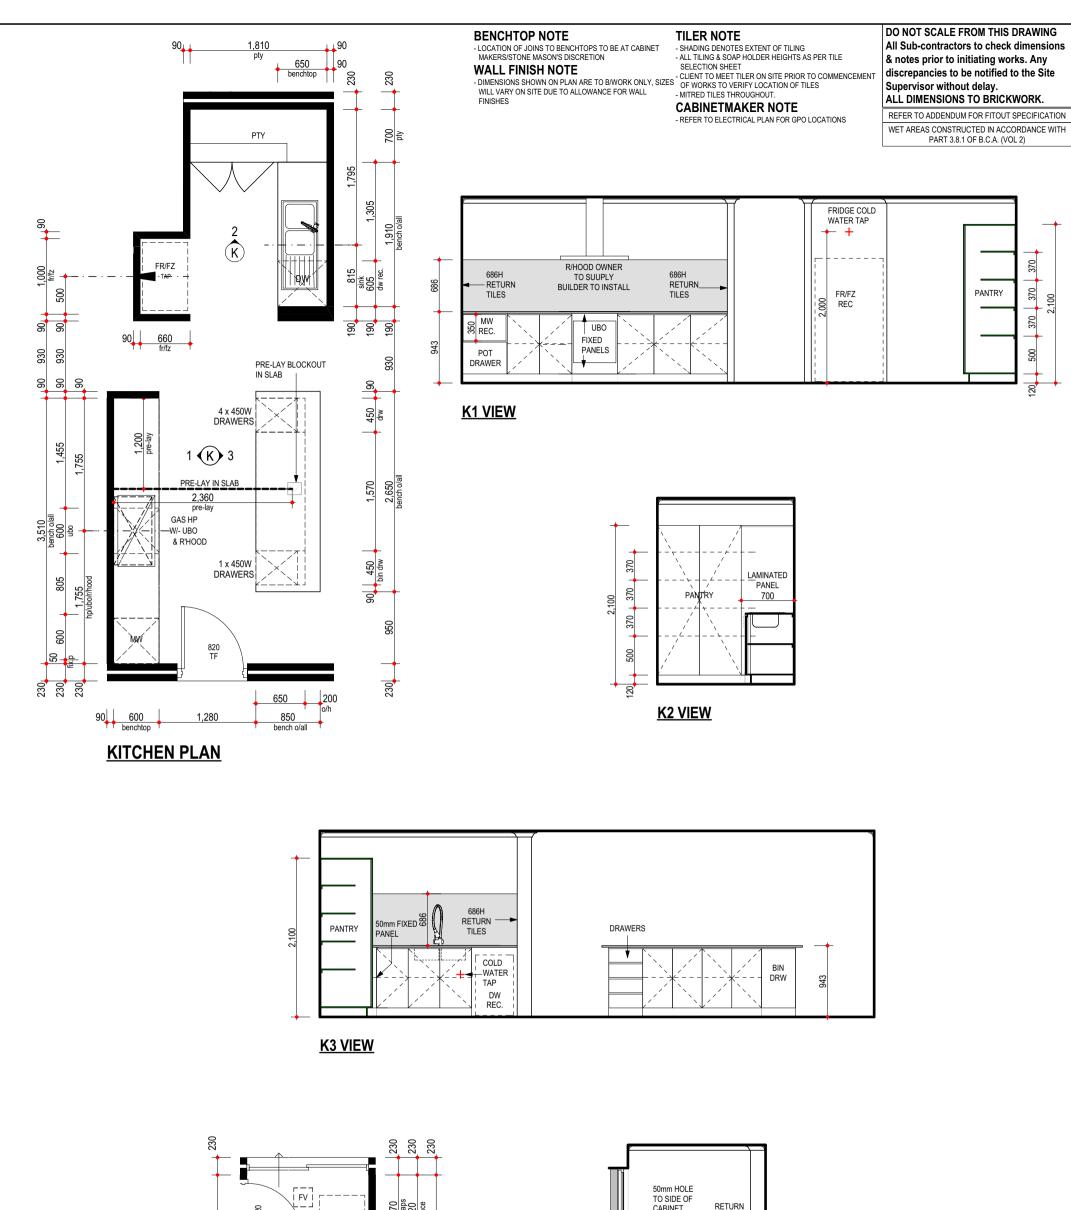

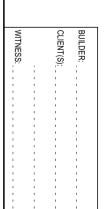

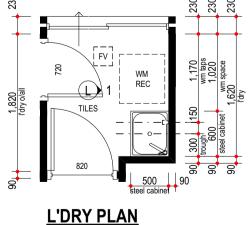

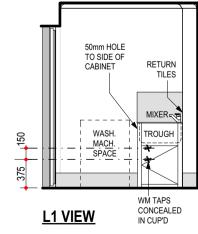

;	:	- ;	- :		
PRC	)POS	ED RI	ESIDI	NCE	FOR:
CA	10/	ZH	AN	G	

ADDRESS: LOT 119 (#60) GILBERTSON ROAD, KARDINYA.

DRAWN: ww DESIGNED: RC CHECKED: DM MODEL:

**SPECIAL** 

SCALE: 1:50 SHEET: 11 OF 15 SIZE: A3 **PROJECTS** 

JOB N°

157386

EN. AMEND V001 V003 JEL WW WW DMA


**ROOM LAYOUTS** 

18/12/2019 08.04.2020 17/04/20 05/05/20

BUILD | RENOVATE | DEVELOP


**BUILT AROUND PEOPLE** 

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DO NOT SCALE FROM THIS DRAWING All Sub-contractors to check dimensions & notes prior to initiating works. Any discrepancies to be notified to the Site Supervisor without delay. ALL DIMENSIONS TO BRICKWORK.

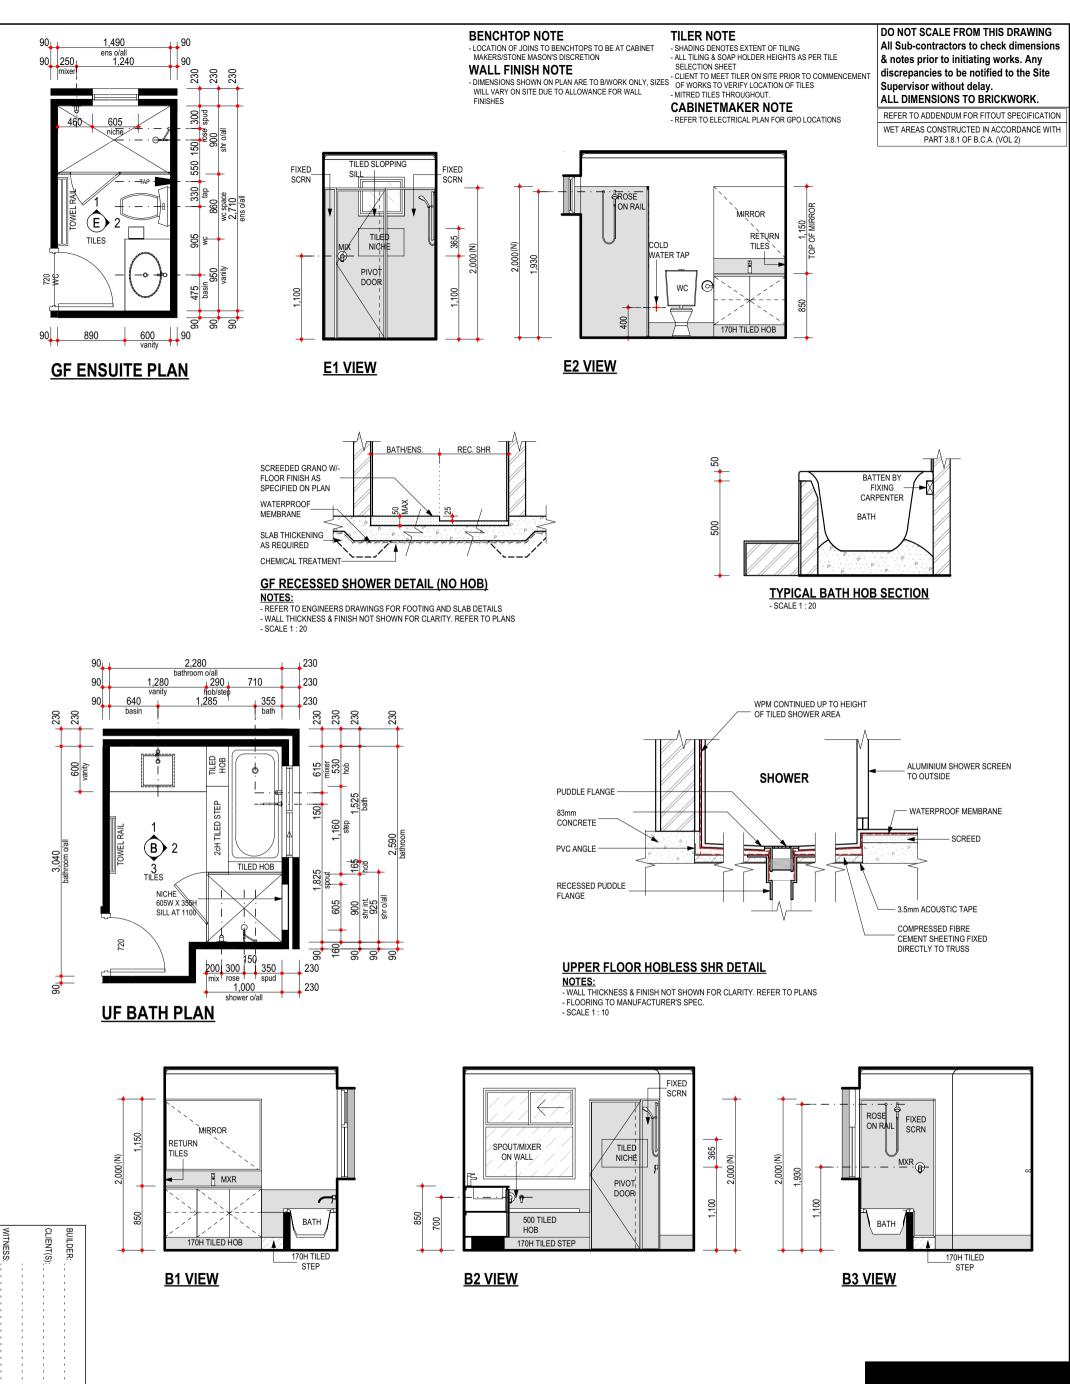

2,090 230 230 3 **⊀** S 577 250 250 14 2,840 |.wall | 2,750 | stair well/vi 6 1 **(S)** 2 15 DN 16 4 3 LOW WALL W/-MDF CAPPING stair well/void 1,180


# **GF. STAIR/ WC PLAN**

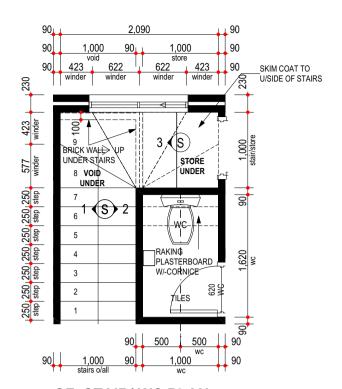
**CONCRETOR/ENGINEER NOTE** 1. CONC STAIRS TO HAVE 177 RISERS & 250 GOINGS.


# **UF STAIR PLAN**

#### **CONCRETOR/ENGINEER NOTE**

1. CONC STAIRS TO HAVE 177 RISERS & 250 GOINGS.

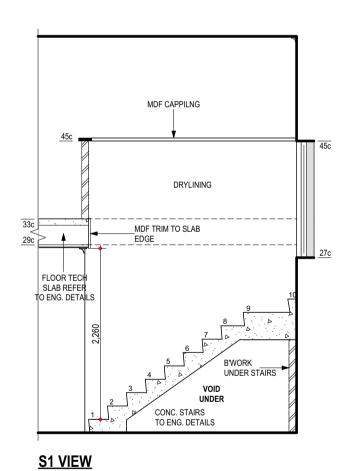

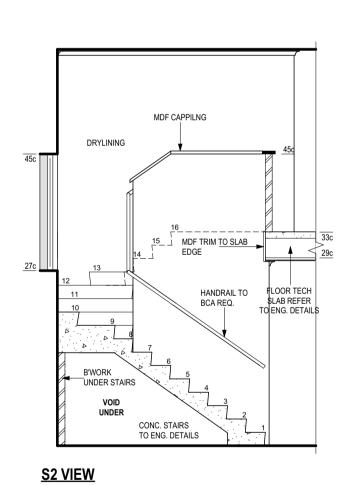

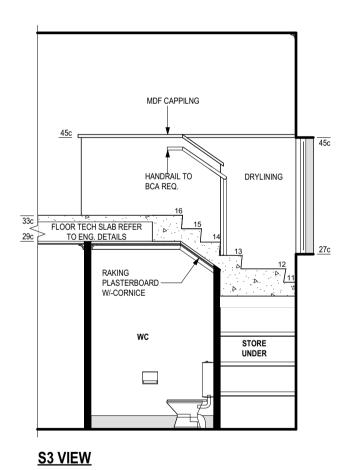

PROPOSED RESIDENCE FOR: CAO / ZHANG

ADDRESS: LOT 119 (#60) GILBERTSON ROAD, KARDINYA.

DRAWN: ww DESIGNED: RC CHECKED: DM DATE: MODEL:

**SPECIAL** 

SCALE: AS NOTED SHEET: 13 OF 15 SIZE: A3 **PROJECTS** JOB N°

157386

EN. AMEND V001 V003 JEL

STAIR LAYOUT

WW WW DMA 18/12/2019 08.04.2020 17/04/20 05/05/20



## **ELECTRICAL LEGEND**

Qty	Id Floor Sym.	Description	Watts	Insulation Penetration
1	1011w*	EXTERNAL WALL LIGHT @ 1800 AFL Perimeter Lighting	11*	*
1	● 7w*	EXTERNAL RECESSED LED DOWN-LIGHT (11w) Perimeter Lighting	7*	*
2	O11w*	CEILING LIGHT (11w) Class 10	22*	*
1	<b>O</b> 11w*	CEILING LIGHT (11w) Class 1 External	11*	*
2	₩ 11w	WALL LIGHT @ 1800 AFL	22	
1	₩ <sub>11w</sub>	MOTION SENSOR WITH SPOT LIGHT (11w)	11	
1	S	H.WIRED SMOKE DETECTOR	0	
1	•	EXHAUST FAN	0	0.045
2	Ь	DIMMER SWITCH	0	
21	◯ 11w	CEILING LIGHT (11w)	231	
1	©© 7w	2x HEATER/FAN/LIGHT ( 7w)	7	
4	2 WAY	2 WAY SWITCH	0	
1	•	W/P SGPO INSTALLED IN HWU	0	
2	•	SINGLE GPO IN/ON CEILING	0	
5	•	SINGLE GPO @ NOTED HT	0	
1	С	NBN LEAD IN CONDUIT (25mm) W/- BLANK FACE PLATE AT 1500 AFL	0	
2	•••	DOUBLE WATER PROOF GPO	0	
8	<b>A</b>	DOUBLE GPO @ NOTED HT	0	
9		DOUBLE GPO @ 200 AFL	0	
1	<b>~</b>	DOUBLE GPO @ 1500 AFL W/ 20mm CONDUIT FOR PSU CONNECTION	0	
1	O	CONDUIT FOR NBN (25mm)	0	
3	©	CONDUIT 20mm	0	
1	0	CONDUIT (32mm)	0	
1	©	CONDUIT (25mm)	0	
1	<u> </u>	25 AMP GPO & ISO SWITCH FOR AC	0	
1	D2	D2 (2x DATA/PHONE) FOR NBN PROVISION @ 1500 AFL	0	
1	C1D2	C1 (TV) + D2 (PH/DATA)	0	
1	C1(TV)	C1 (TV) + CONDUIT BY O.N.C	0	

NOT INC. IN CLASS 1 CALC. SEE PLAN FOR MORE INFO. Subtotal: PERIMETER LIGHTING MIN. 40 LUMENS/V Total Class 1 Wattage= 366

Wattage Calculations (C	lass 1)	Allowed	Actual	
Story Name	Area	Wattage	Wattage	
2   Upper Floor 0   Ground Floor	67.34 Sqm 106.36 Sqm	337 w 532 w	95 w 271 w	
	173.70 sqm	869 w	366 w	

Recessed Fitting Penetration	ons (Class 1)	Maximum	Actual	
Story Name	Area	Penetrations	Penetrations	
2   Upper Floor 0   Ground Floor Vents\RangeHoods	67.34 Sqm 35.70 Sqm	0.337 Sqm 0.178 Sqm	-0.049 Sqm -0.049 Sqm 0.094 Sqm	
	103 04 sam	0.515 sam	0.184 sam	PASS

0.18 % R4.0 Insulation Adjustment Not Required

DO NOT SCALE FROM THIS DRAWING All Sub-contractors to check dimensions & notes prior to initiating works. Any discrepancies to be notified to the Site Supervisor without delay. ALL DIMENSIONS TO BRICKWORK.

#### **ELECTRICAL NOTE**

- INTERCONNECTED SMOKE DETECTORS TO AS3786-2014

- FINAL POSITION OF ELECTRICAL ITEMS SUCH AS GPO'S, LIGHT SWITCHES ETC. MAY VARY ON SITE DUE TO ELECTRICAL REGULATIONS. LIGHT SWITCH HEIGHT TO BE AT 1200 AFL U.N.O.

- NEUTRAL CABLING REQUIRED TO ALL LIGHT SWITCHES.
- ALL EXHAUST FANS TO BE FLUED TO EXTERNAL AIR

TV ANTENNA NOTE


# **AIRCON NOTE**

- PROVIDE TV ANTENNA AS PER ADDENDA

- PROVIDE DUCTED REVERSE CYCLE AIR CONDITIONING. OUTLET POSITIONS TO BE NOMINATED BY SUPPLIER.
- EXTERNAL UNIT NOT TO BE VISIBLE FROM THE STREET.

#### **CLIENT / PRESTART NOTE**

- CLIENT TO CONFIRM W/- ADMINISTRATOR POSITIONING OF ALL TV, PHONE AND ROOM GPO POSITIONS.

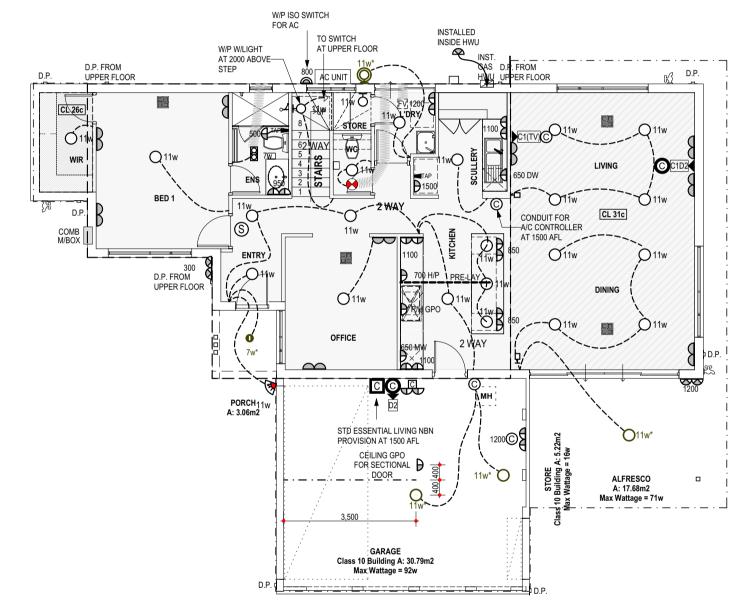

# LIGHT AND VENTILATION CALC.

LIGITI AND V			U,	ALU.
Room Name	Opn %			Vent.
2   SCULLERY   LI Min. Ventilation = 4.05   Min. Li			DII	NING
W07   Sliding Door	50 %	8.47 m2		4.24 m2
W06   Sliding	50 %	3.72 m2		1.86 m2
W05   Sliding	50 %	3.72 m2		1.86 m2
D14   Door	100 %	1.89 m2		1.89 m2
Totals	Light	17.80 m2	Vent	9.84 m2
1   BED 1 Min. Ventilation = 1.09   Min. Li	ight= 1.45 To	otal Area= 14.50		
W01   Sliding	50 %	3.41 m2		1.71 m2
Totals	Light	3.41 m2	Vent	1.71 m2

nputs for Airmovement and Light are Valid



				CLIENT(S):	BUILDER:	
		1	1	1	1	
1 1 1 1		_	_	_	_	1
1 1 1 1		1	1	1	1	1
	1 1 1 1	1	1	1	1	1
						1

PROPOSED RESIDENCE FOR:

CAO / ZHANG

ADDRESS: LOT 119 (#60) GILBERTSON ROAD, DRAWN: ww DESIGNED: RC CHECKED: DM DATE: MODEL:

SCALE: 1:100 SHEET: 14 OF 15 SIZE: A3 **PROJECTS** 

JOB N°

EN. AMEND V001 V003 JEL WW WW DMA

18/12/2019 08.04.2020 17/04/20 05/05/20

GF ELECTRICAL/BCA PLAN

**SUMMIT** HOMES GROUP BUILD | RENOVATE | DEVELOP

KARDINYA. 157386 BUILT AROUND PEOPLE

**SPECIAL** 

#### **ELECTRICAL LEGEND**

Upper	Floor			l
Qty	Sym.	Description	Watts	Insulation Penetrations
1	Ю 11w	WALL LIGHT @ 1800 AFL	11	
1	S	H.WIRED SMOKE DETECTOR	0	
1	•	EXHAUST FAN	0	0.045
1	Б	DIMMER SWITCH at 900	0	
7	◯ 11w	CEILING LIGHT (11w)	77	
1	89 7w	4x HEATER/FAN/LIGHT ( 7w)	7	
2	2 WAY	2 WAY SWITCH	0	
1	•	SINGLE GPO @ NOTED HT	0	
5	<b>~</b>	DOUBLE GPO @ NOTED HT	0	
6		DOUBLE GPO @ 200 AFL	0	
2	©	CONDUIT 20mm	0	
1	C1(TV)	C1 (TV) + CONDUIT BY O.N.C	0	

NOT INC. IN CLASS 1 CALC. SEE PLAN FOR MORE INFO. Subtotal: 95
PERIMETER LIGHTING MIN. 40 LUMENS/W.

Total Class 1 Wattage= 366

PASS

Wattage Calculations	(Class 1)	Allowed	Actual
Story Name	Area	Wattage	Wattage
2   Upper Floor 0   Ground Floor	67.34 Sqm 106.36 Sqm	337 w 532 w	95 w 271 w
	173.70 sqm	869 w	366 w

Recessed Fitting Pene	trations (Class 1)	Maximum	Actual	
Story Name	Area	Penetrations	Penetrations	
2   Upper Floor 0   Ground Floor Vents\RangeHoods	67.34 Sqm 35.70 Sqm	0.337 Sqm 0.178 Sqm	-0.049 Sqm -0.049 Sqm 0.094 Sqm	
		•		

103.04 sqm 0.515 sqm 0.184 sqm 0.18 % R4.0 Insulation Adjustment Not Required

#### TO SWITCH AT 2000 ABOVE AT GROUD FLOOR STEP D.P. D.P. **ACTIVITY** BATH □ 1700 1700 □ □ (T(TV) ①11w WC LAND'G МН BED 2 2 WAY <del>-2₩</del>ΑΥ 900 (S) → will AC BED 3 BED 4 **O**11w **11w 3**© D.P. W/-SPREADER

W/P W/LIGHT

# LIGHT AND VENTILATION CALCULATIONS

Room Name	Opn %	Light		Vent.	
7   ACTIVITY					
Min. Ventilation = 1.08   Min. L	ight= 1.45 T	otal Area=	14.45		
W13   Sliding	50 %	2.02 m2		1.01 m2	
W12   Sliding	50 %	0.98 m2		0.49 m2	
Totals	Light	3.00 m2	Vent	1.50 m2	
6   BED 4 Min. Ventilation = 0.79   Min. L	ight= 1.05 To	otal Area=	10.48		
W16   Sliding	50 %	2.07 m2		1.03 m2	
Totals	Light	2.07 m2	Vent	1.03 m2	
5   BED 3 Min. Ventilation = 0.79   Min. L	ight= 1.05 Te	otal Area=	10.48		
W10   Fixed	0 %	3.29 m2		0.00 m2	
W09   Sliding	47 %	3.00 m2		1.40 m2	
Totals	Light	6.30 m2	Vent	1.40 m2	
4   BED 2					
Min. Ventilation = 0.79   Min. L	ight= 1.06 T	otal Area=	10.59		
W11   Sliding	50 %	3.03 m2		1.52 m2	
Totals	Light	3.03 m2	Vent	1.52 m2	

Inputs for Airmovement and Light are Valid





DO NOT SCALE FROM THIS DRAWING All Sub-contractors to check dimensions

& notes prior to initiating works. Any

**ELECTRICAL NOTE** 

TV ANTENNA NOTE - PROVIDE TV ANTENNA AS PER ADDENDA

**AIRCON NOTE** 

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discrepancies to be notified to the Site Supervisor without delay.
ALL DIMENSIONS TO BRICKWORK.

	•			
PRC	OPOS	ED R	ESIDE	NCE FOR
CA	AO /	ZΗ	IAN	G

ADDRESS: LOT 119 (#60) GILBERTSON ROAD, KARDINYA.

DRAWN: ww DESIGNED: RC CHECKED: DM DATE: MODEL:

SCALE: 1:100 SHEET: 15 OF 15 SIZE: A3 **PROJECTS** 

JOB N°

EN. AMEND V001 V003 JEL WW WW DMA

18/12/2019 08.04.2020 17/04/20 05/05/20

UF ELECTRICAL/BCA PLAN

HOMES GROUP

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