# **GENERAL NOTES FOR ACCESS:** (TO COMPLY WITH SECTIONS AS 1228.1-2009 & PART D3 OF THE • SECTION 6.6 VISUAL INDICATORS ON GLAZING SECTION 7 FLOOR OR GROUND SURFACES ON FLOOR SHALL HAVE A SLIP RESISTANT SURFACE WITH A MAX 5mm ENTIRE LENGHT OF THE EXPOSED EDGE. SECTION 8 BRAILLE & TACTILE SIGNS

#### WHERE THERE IS NO HANDRAIL OR TRANSOM ALL FULLY GLAZED DOORS . SIDELIGHTS INCLUDING GLAZING CAPABLE OF BEING MISTAKEN FOR A DOORWAY SHALL BE CLEARLY MARKED THE FULL WIDTH WITH A SOLID CONTRASTING LINE. THE CONTRASTING LINE SHALL BE NOT LESS THAT 75mm WIDE AND SHALL EXTEND ACROSS THE FULL WIDTH OF THE GLAZING. THE LOWER EDGE SHALL BE BETWEEN 900mm & 1000mm ABOVE FLOOR LEVEL. CONTRASTING LINE ON GLAZING SHALL HAVE A 30% LUMINANCE CONTRAST WHEN VIEWED AGAINST THE FLOOR SURFACE.

#### CONTINUOUS ACCESSIBLE PATHS OF TRAVEL

VARIATION IN SURFACE, CARPET OR ANY SOFT FLEXIBLE MATERIAL ON THE FLOOR SURFACE SHALL HAVE A PILE HEIGHT OF THICKNESS OF MAX OF 11mm AND CARPET BACKING SHALL BE A MAX OF 4mm IN THICKNESS, EXPOSED EDGES OF FLOOR COVERINGS SHALL HAVE A TRIM FASTENED TO THE FLOOR THE

BRAILLE AND TACTILES SIGNAGE TO BE PROVIDED FOR SANITARY FACILITIES. SIGNS MUST BE NOT LESS THAN 1200mm AND NOT HIGHER THAN 1600mm ABOVE THE FLOOR SURFACE. SIGNS IDENTIFYING ROOMS MUST BE LOCATED ON THE WALL ON THE LATCH SIDE OF THE DOOR WITH THE LEADING EDGE OF THE SIGN LOCATED BETWEEN 50mm AND 300mm OR ARCHITRAVE OR WHERE NOT POSSIBLE THE SIGN MAY BE PLACED ON THE DOOR. DOORWAYS & DOOR NOTES: (TO COMPLY WITH SECTIONS 13 AS 1428.1-2009 & PART D2.19 OF

- ALL EXIT DOORS TO SWING IN DIRECTION OF EGRESS.
- ALL DOORWAYS SHALL HAVE A MIN LUMINANCE CONTRAST OF 30% BETWEEN DOOR SYSTEM COMPONENTS AND
- DOORWAYS ON A CONTINUOUS PATH OF TRAVEL SHALL HAVE A 850mm CLEAR OPENING.
- DOORS THAT FORM A CONTINUOUS PATH OF TRAVEL MUST BE OPENABLE WITHOUT A KEY FROM THE SIDE THAT FACES A PERSON SEEKING EGRESS BY A SINGLE HAND DOWNWARD ACTION.
- DOOR HANDLES TO BE BETWEEN 900mm AND 1100mm FROM THE FLOOR.
- CLEARANCE BETWEEN THE DOOR HAND AND DOOR FACE SHALL BE 35mm & 45mm.

## TO COMPLY WITH SECTIONS 13 AS 1428.1-2009 & PART F2.4 OF

- WATER TAPS TO HAVE LEVER HANDLES WITH A CLEARANCE
- OF 50mm FROM ADJACENT SURFACES. HOT & COLD WATER TO BE DELIVERED THROUGH 1 SPOUT.
- TOILET SEAT TO BE A FULL ROUND TYPE , WITH A LOAD RATING OF 150kg AND A LUMINANCE CONTRAST OF 30%
- BACKREST TO BE PROVIDED AS PER DETAILS

WITH BACKGROUND.

AS 1428.1-2009

SURFACE.

• FLUSHING CONTROLS ZONE AS PER SECTION 15.2.5 OF AS

TOILET PAPER DISPENSER ZONE AS PER SECTION 15.2.6 OF

- GRABRAILS TO BE BETWEEN 30mm & 40mm DIAMETER WITH A CLEARANCE OF BETWEEN 50mm & 60mm FROM ANY
- DOORS TO BE PROVIDED WITH AN IN-USE INDICATOR AND SHALL BE OPENEDED FROM THE OUTSIDE


### **ENERGY EFFICIENCY NOTES:**


MECHANICAL VENTILATION AND AIR-CONDITIONING SYSTEM INSTALLED TO PROVIDE VENTILATION IN ACCORDANCE WITH BCA VOLUME 1 ARE TO BE COMPLIANT WITH AS 1668.2 & AS/NZS 3666.1. MECHANICAL VENTILATION AND AIR-CONDITIONING BY OWNER

MECHANICAL VENTILATION AND AIR-CONDITIONING SYSTEM INSTALLED TO PROVIDE VENTILATION IN ACCORDANCE WITH BCA VOLUME 1 ARE TO BE COMPLIANT WITH AS 1668.2 & AS/NZS 3666.1


AIR-CONDITIONING/VENTILATION SYSTEMS AND ARTIFICIAL LIGHTING TO BE DESIGNED AND INSTALLED IN ACCORDANCE WITH PARTS J5 & J6 OF THE BCA VOLUME 1 REQUIREMENTS FOR ENERGY EFFICEIENCY

ALL HOT WATER SUPPLY SYSTEMS ARE REQUIRED TO BE INSTALLED IN ACCORDANCE WITH SECTION 8 OF AS 3500.4

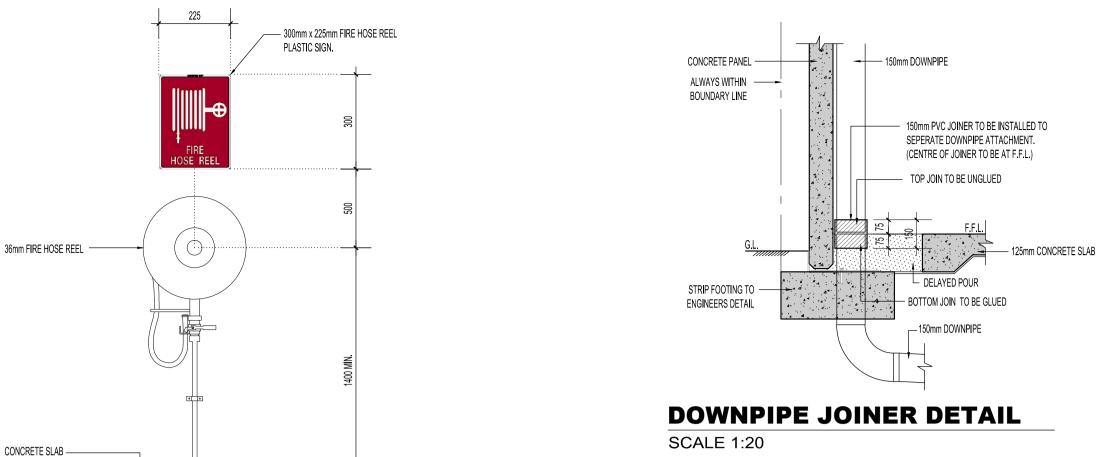

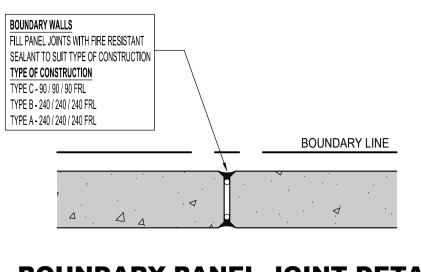



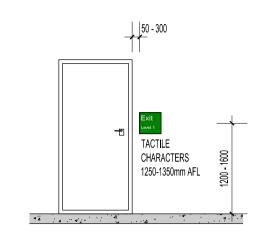

**LOCATION OF TACTILE EXIT SIGNS** 

SCALE 1:50

BRAILLE AND TACTILE SIGNAGE COMPLYING WITH SPECIFICATION D3.6 MUST IDENTIFY EACH DOOR REQUIRED BY E4.5 TO BE PROVIDED WITH AN EXIT SIGN AND STATE - "EXIT"; AND "LEVEL" FOLLOWED BY THE FLOOR NUMBER.

LOCATION OF BRAILLE AND TACTILE SIGNS SIGNS INCLUDING SYMBOLS, NUMBERING AND LETTERING MUST BE DESIGNED AND INSTALLED AS FOLLOWS:


SIGNS MUST BE LOCATED NOT LESS THAN 1200MM AND NOT HIGHER THAN 1600MM ABOVE THE FLOOR OR GROUND SIGNS WITH SINGLE LINES OF CHARACTERS MUST HAVE THE LINE OF TACTILE CHARACTERS NOT LESS THAN 1250MM


AND NOT HIGHER THAN 1350MM ABOVE THE FLOOR OR GROUND SURFACE. SIGNS IDENTIFYING ROOMS CONTAINING FEATURES OR FACILITIES LISTED IN D3.6 MUST BE LOCATED: ON THE WALL ON THE LATCH SIDE OF THE DOOR WITH THE LEADING EDGE OF THE SIGN LOCATED BETWEEN 50MM

AND 300MM FROM THE ARCHITRAVE IN THE EVENT OF INSUFFICIENT LATCH SIDE DIMENSION, A SIGN MAY BE PLACED ON THE NON-LATCH SIDE OF THE

WHERE (I) AND (II) IS NOT POSSIBLE, THE SIGN MAY BE PLACED ON THE DOOR ITSELF.

SIGNS IDENTIFYING PATHS OF TRAVEL MUST BE PLACED SO THEY ARE LOCATED DIRECTLY AHEAD IN THE DIRECTION OF TRAVEL. WHERE ONE WALL CONTINUES IN THE DIRECTION OF TRAVEL AND THE OTHER FORMS A CORNER, THE

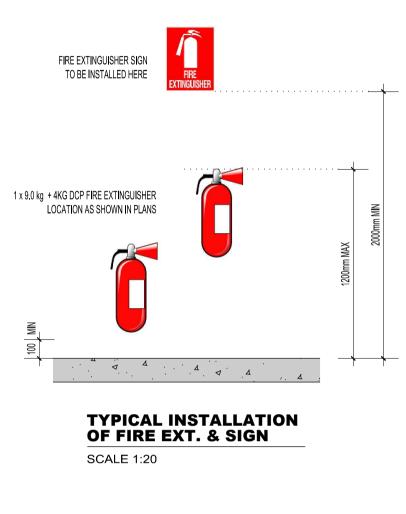

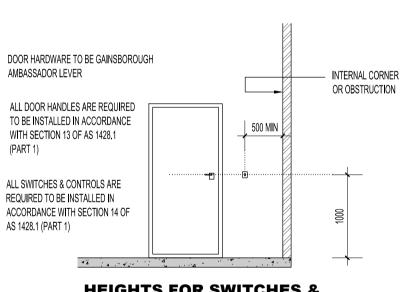

CONSTRUCTIONS

0 19.08.2020 J.M ISSUE FOR CONSTRUCTION

REV. DATE I.N.

A 27.07.2020 J.M ISSUE FOR TENDER / CDC / BP

DESCRIPTION

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PROPOSED

**PROJECT** LOT 345 # 4 FELLOWSHIP ROAD GNANGARA WA

**WAREHOUSE** 

DRAWING TITLE: **FLOOR PLAN** 

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