	<b>+</b>	SEC Dome
	=0=	Power Pole
닐	TC	Phone Pits
Ш	W	Water Conn.
<u> </u> ල	[ TP 10.00 ]	Top Pillar/Post
Щ	[ TW 10.00 ]	Top Wall
╽╽┻	[ TR 10.00 ]	Top Retaining
	[TF 10.00]	Top Fence

BEWARE: NOTE:

ositions of all sewer manholes. junctions and sewer lines are approximate only due to lack of information. Please confirm all positions with Water Corp.

ANOTE:

Approx. Sewer Clearance Line

# **SURVEYOR NOTES:**

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builders discretion. Sewer/drainage may vary from schematic presentation/check min. clearances. Retaining not included in contract - remains owner-responsibility. This survey does not guarantee the location of boundary pegs or fences. Check title for

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DISCLAIMER:


Due to lack of survey marks/pegs, all building offset dimensions & features are approximate only and positioned from existing pegs/fences and walls which may not be on the correct alignment are are to be verified when repegged. Any design that to be verified wither theyegyed. Any design mai involves additions to any structures shown or portion of structures remaining after any demolition has taken place requires boundaries to be repegge and exact offsets provided to your designer/archite before any plans are produced and before any wor

#### **DEMOLITION NOTES**

### **CLIENT NOTE:**

ALL DEMOLITION BY CLIENT UNLESS OTHERWISE NOTED.
ALL TREES/SHRUBS TO BE LOPPED (TRIMMED) TO WITHIN 2m
OF THE BUILDING ENVELOPE.

EXISTING BUILDING, TREES AND ALL RUBBLE TO BE REMOVED BY CLIENT PRIOR TO CONSTRUCTION.

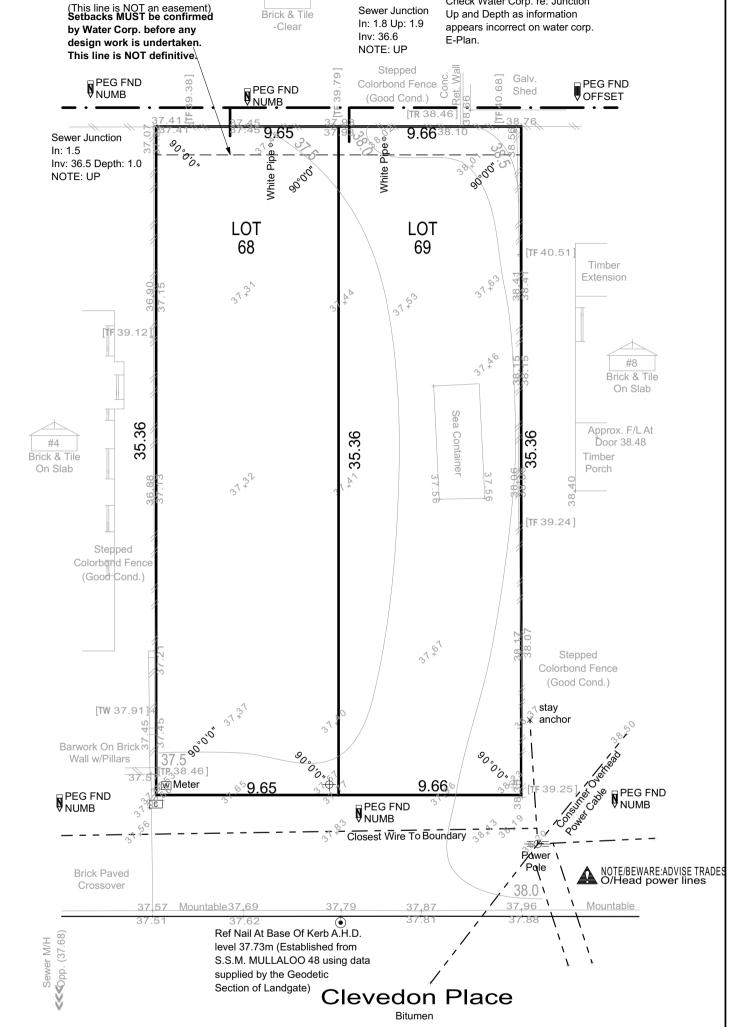

A NOTE:

Check Water Corp. re: Junction

A NOTE: CHECK SHIRE RE: AMALGAMATION BEWARE COULD DELAY BUILDING LICENSE (AMALGAMATION PROCESS APPROX. 6-9 MONTHS)



TTAGE & ENGINEERING

CLIENT(S): BUILDER:

> AREA: SHIRE: D.PLAN: FOLIO:

> > MSD REF:

683m<sup>2</sup> **JOONDALUP** 9836 C/T VOLUMN: 492

250 13/04

KERBING: MOUNT FOOTPATH: NIL SAND / LIMESTONE (POSS) SOIL: DRAINAGE: GOOD VEGETATION: RTS

ROAD DESCR.: BITUMEN

GAS: YES WATER: YES ELECTRICITY: O/H PH/COMMS: YES SEWER: YES

NO

V008

COASTAL:

SSA/OLD AREAS: OLD A. C/JOB#: 438547 DATE: 27 JUN 18 SCALE: 1:200 DRAWN: C. WEIGHTMAN

UNLODGED SS PLAN: N/A ORIGINAL LOT: N/A LOT MISCLOSE: 0.000 SSL 1 MISCLOSE: N/A SSL 2 MISCLOSE: N/A

HOMES GROUP

PROPOSED RESIDENCE FOR:

**FAIRHEAD** 

ADDRESS: LOT 9 (#6) CLEVEDON PLACE, KALLAROO.

Telephone: (08) 9446 7361 Facsimile: (08) 9445 2998.

DRAWN: DESIGNED: ALI CHECKED: DM MODEL:

**SPECIAL** 

SHEET: I OF 10 SIZE: A3 DIVISION: SUMMIT PROJECTS JOB N°

1:200

SCALE:

155652

V01-2 5/03/19 JS DMA 17/01/20 24/01/20 06/02/20 14/02/20 SURVEY DMA

**DEMOLITION PLAN** 

**BUILT AROUND PEOPLE** 

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	<b>+</b>	SEC Dome
	=0=	Power Pole
Z	TC	Phone Pits
ш	W	Water Conn.
G	[TP 10.00]	Top Pillar/Post
Щ	[ TW 10.00 ]	Top Wall
<b>│</b> ┛	[ TR 10.00 ]	Top Retaining
	[TF 10.00]	Top Fence

BEWARE: NOTE:

ositions of all sewer manholes. unctions and sewer lines are approximate only due to lack of nformation. Please confirm all ositions with Water Corp

# **SURVEYOR NOTES:**

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#### **CONSTRUCTION NOTES**

**CLIENT NOTE:** 

ALL FENCING BY CLIEN ALL RETAINING BY CLIENT

**CONCRETOR NOTE:** 

ALL GARAGE SLAB 20mm TOWARDS MAIN GARAGE OPENING.

**CONCRETOR / BRICKLAYER NOTE:** 

INSIDE THE B'DRY BY 5mm.

**PLUMBER NOTE:** 

- REFER TO PLUMBING PLAN FOR SEWER AND STORMWATER

**RETAINING CONTRACTOR NOTE:** 

- TOP OF WALL (TOW) INDICATED FOR CLARITY ONLY. - ENSURE BOTTOM OF RETAINING IS EMBEDDED SUFFICIENTLY AS REQ. BY ENG. DETAIL

REFER TO NEIGHBOURS EXISTING LEVELS OR NOMINATED PAVING / LANDSCAPING LEVELS FOR FULL REQ. RETAINING **HEIGHTS** 

REFER TO ENGINEERS DETAILS **BRICKPAVER NOTE:** 


CARBAYS, EXTENT AS INDICATED. WIDTHS OF BRICK PAVED PATHS TO BE APPROX. 1.0m WIDE UNLESS OTHERWISE INDICATED. MAINTAIN NOMINATED PAVING LEVELS FOR STORMWATER

PRE-LAY 900mm PVC RETIC SLEEVE UNDER DRIVEWAY PRIOR

TO PAVING FOR LANDSCAPING. **GENERAL NOTE:** 

> CLIENT(S): BUILDER:

CLOTHESLINES INDICATED AS PER ADDENDA

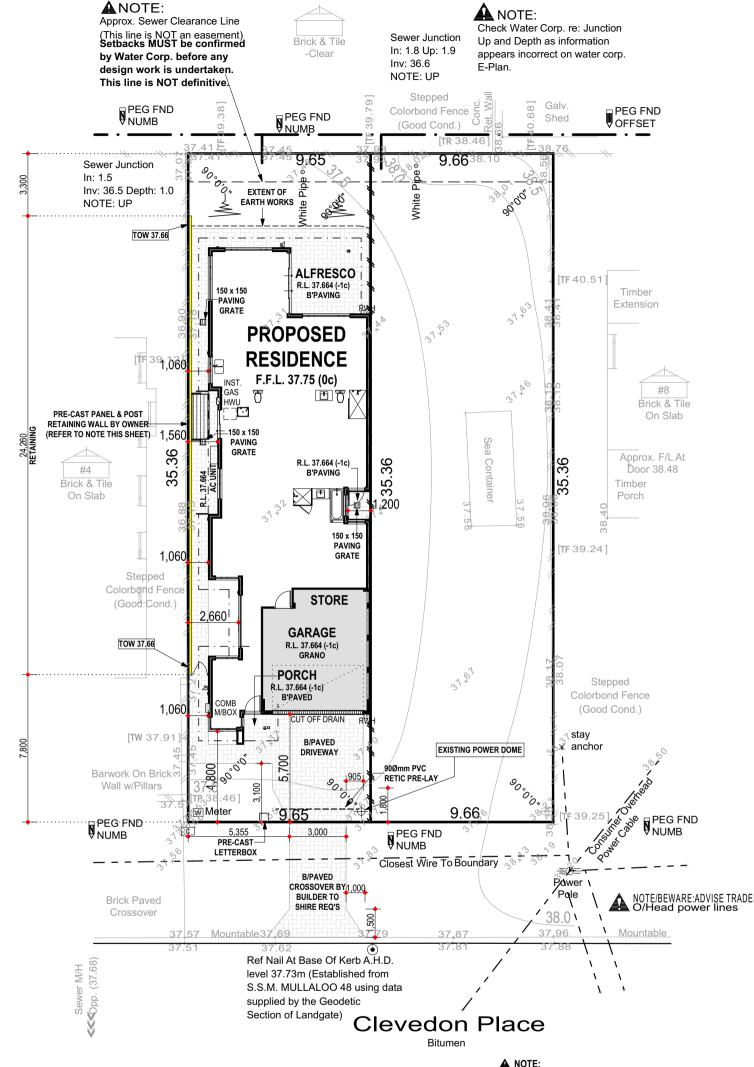

CHECK SHIRE RE: AMALGAMATION BEWARE COULD DELAY BUILDING LICENSE (AMALGAMATION PROCESS APPROX. 6-9 MONTHS)



TAGE & ENGINEERING

Telephone: (08) 9446 7361 Facsimile: (08) 9445 2998.

683m<sup>2</sup> JOONDALUP D.PLAN: 9836 C/T VOLUMN: 492

250 13/04

KERBING: MOUNT FOOTPATH: NIL SAND / LIMESTONE (POSS) SOIL: DRAINAGE: GOOD

ROAD DESCR.: BITUMEN

GAS: YES WATER: YES ELECTRICITY: O/H PH/COMMS: YES

YES

NO

SEWER:

COASTAL:

SSA/OLD AREAS: OLD A. C/JOB#: 438547 DATE: 27 JUN 18 SCALE: 1:200

DRAWN: C. WEIGHTMAN

UNLODGED SS PLAN: N/A ORIGINAL LOT: N/A LOT MISCLOSE: 0.000 SSL 1 MISCLOSE: N/A SSL 2 MISCLOSE: N/A

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PROPOSED RESIDENCE FOR:

**FAIRHEAD** 

ADDRESS: LOT 9 (#6) CLEVEDON PLACE, KALLAROO.

AREA:

SHIRE:

FOLIO:

MSD REF:

DESIGNED: ALI CHECKED: DM MODEL:

DRAWN:

**SPECIAL** 

VEGETATION: RTS

SCALE: 1:200 SHEET: 2 OF 10 SIZE: A3 DIVISION: SUMMIT PROJECTS JOB N°

155652

JS DMA V003 DMA V010 V014 DMA

SITE PLAN

5/03/19 21/03/19 17/01/20 24/01/20 06/02/20 14/02/20 28/04/20

	<del>+</del>	SEC Dome
	=0=	Power Pole
	T C	Phone Pits
IШ	W	Water Conn.
ტ	[ TP 10.00 ]	Top Pillar/Post
Ш	[ TW 10.00 ]	Top Wall
╽╽┻	[ TR 10.00 ]	Top Retaining
	[TF 10.00]	Top Fence

BEWARE: NOTE: Positions of all sewer manholes. junctions and sewer lines are approximate only due to lack of

information. Please confirm all positions with Water Corp.

## **SURVEYOR NOTES:**

DISCLAIMER:

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builders discretion. Sewer/drainage may vary from schematic presentation/check min. clearances. Retaining not included in contract - remains owners responsibility. This survey does not guarantee the location of boundary pegs or fences. Check title for easements/covenants etc.

DISCLAIMER:


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# **CONCRETOR / BRICKLAYER NOTE:**

B'WALL ON STRATA B'DRY HAS BEEN CALCULATED TO BE SET







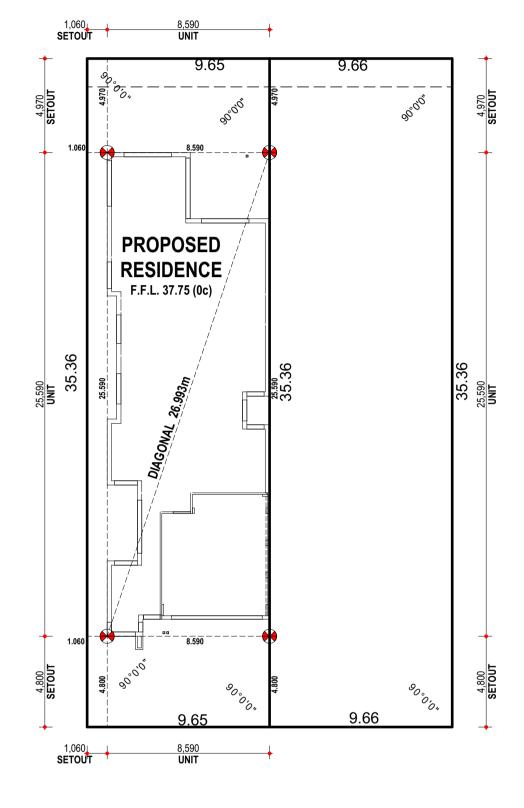

Telephone: (08) 9446 7361 Facsimile: (08) 9445 2998. Email: perth@cottage.com.au Website: www.cottage.com.au

AREA: 683m² SHIRE: **JOONDALUP** D.PLAN: 9836 C/T VOLUMN: 492

250 13/04

FOLIO:

MSD REF:

KERBING: MOUNT FOOTPATH: NIL SOIL: SAND / LIMESTONE (POSS) DRAINAGE: GOOD VEGETATION: RTS

ROAD DESCR.: BITUMEN

GAS: YES WATER: YES ELECTRICITY: O/H PH/COMMS: YES SEWER: YES

NO

COASTAL:

SSA/OLD AREAS: OLD A. C/JOB#: 438547 DATE: 27 JUN 18 SCALE: 1:200 DRAWN: C. WEIGHTMAN

UNLODGED SS PLAN: N/A ORIGINAL LOT: N/A LOT MISCLOSE: 0.000 SSL 1 MISCLOSE: N/A SSL 2 MISCLOSE: N/A

PROPOSED RESIDENCE FOR: **FAIRHEAD** 

ADDRESS:

LOT 9 (#6) CLEVEDON PLACE, KALLAROO.

DRAWN: DESIGNED: ALI CHECKED: DM DATE: MODEL:

**SPECIAL** 

SCALE: 1:200 SHEET: 3 OF 10 SIZE: A3 DIVISION: SUMMIT PROJECTS JOB N°

155652

V01-2 V008 JS DMA 5/03/19 17/01/20 24/01/20 06/02/20 14/02/20 DMA

SETOUT PLAN



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	<del>+</del>	SEC Dome
	=0=	Power Pole
	TC	Phone Pits
Ш	W	Water Conn.
G	[TP 10.00]	Top Pillar/Post
Щ	[ TW 10.00 ]	Top Wall
│ │ <b>─</b> ┛	[ TR 10.00 ]	Top Retaining
	[TF 10.00]	Top Fence

BEWARE: NOTE:

Positions of all sewer manholes. junctions and sewer lines are approximate only due to lack of information. Please confirm all positions with Water Corp

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#### **PLUMBER NOTE:**

is started on site.


CONNECT ALL DOWNPIPES TO STORMWATER SOAKWELLS AS PER SHIRE REQUIREMENTS.
- PART 3.1.2 DRAINAGE: ALL STORMWATER & SURFACE WATER

DRAINAGE TO COMPLY W.- A.S. 3500.3:2003, CLAUSE 3.1.2.1 & 3.1.2.5 BCA VOL. 2 & LOCAL AUTHORITY REQUIREMENTS. - REFLUX VALVE REQUIRED.

# **STORMWATER & SEWER NOTES** 1:20 YEAR STORM EVENT

-				
		Soak Well Type	No.	
		SW 1500x1500	2	5.3 m3
		Total Ca		
		Roof Are	ea GF	222.1 m2
		Paved	Area	77.8 m2
		Tota	l Area	299.9 m2
Ca	pacity F	Required (Area x 0.	0130)	3.9 m3

Extra Capacity Provided 1.4 m3

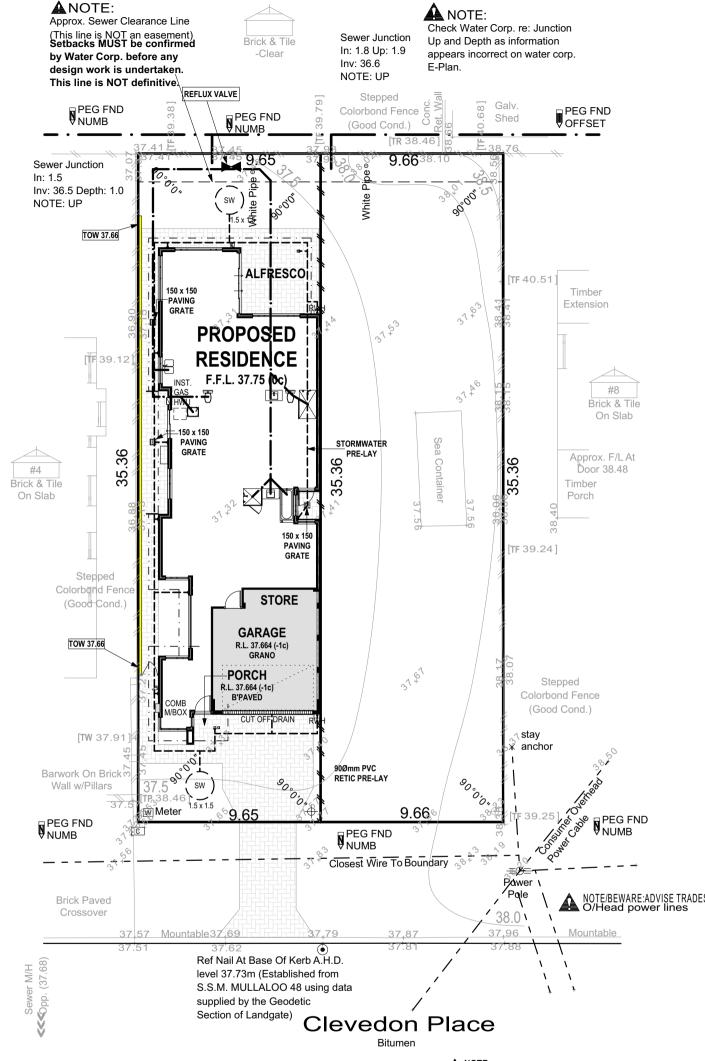

A NOTE: CHECK SHIRE RE: AMALGAMATION BEWARE COULD DELAY BUILDING LICENSE (AMALGAMATION PROCESS APPROX. 6-9 MONTHS)



THOE & ENGINEERING

Telephone: (08) 9446 7361 Facsimile: (08) 9445 2998.

AREA: 683m<sup>2</sup> SHIRE: JOONDALUP D.PLAN: 9836 C/T VOLUMN: 492

19A

250 13/04

FOLIO:

MSD REF:

KERBING: MOUNT FOOTPATH: NIL SAND / LIMESTONE (POSS) SOIL: DRAINAGE: GOOD VEGETATION: RTS

ROAD DESCR.: BITUMEN

GAS: YES WATER: YES ELECTRICITY: O/H PH/COMMS: YES SEWER: YES

NO

V01-2

COASTAL:

SSA/OLD AREAS: OLD A. C/JOB#: 438547 DATE: 27 JUN 18 SCALE: 1:200 DRAWN: C. WEIGHTMAN

UNLODGED SS PLAN: N/A ORIGINAL LOT: N/A LOT MISCLOSE: 0.000 SSL 1 MISCLOSE: N/A SSL 2 MISCLOSE: N/A

HOMES GROUP

PROPOSED RESIDENCE FOR:

CLIENT(S): BUILDER:

**FAIRHEAD** 

ADDRESS: LOT 9 (#6) CLEVEDON PLACE, KALLAROO.

JS DESIGNED: ALI CHECKED: DM MODEL: **SPECIAL** 

DRAWN:

SHEET: 4 OF 10 SIZE: A3 DIVISION: SUMMIT PROJECTS JOB N°

1:200

SCALE:

155652

V008 SURVEY DMA

PLUMBING PLAN

5/03/19 JS DMA 17/01/20 24/01/20 06/02/20 14/02/20 SITE CLASSIFICATION - CLASS 'A'
(REFER TO SITE REPORT FOR
DETAILS) WIND LOAD - N1
CORROSION CLASSIFICATION - R3 BRICK NOTE

ROOF NOTE

ELECTRICAL NOTE

- <u>COLORBOND</u> ROOF, PITCH AT 25° W/- 500W EAVES UNO - STEEL ROOF FRAME TO NASH STANDARDS - CEILINGS AT 31c + PLATE UNLESS NOTED OTHERWISE

ROOF PLUMBER NOTE

- PROVIDE SLOTTED GUTTERS (EXC. GUTTER ON WALLS) - FINAL POSITIONS OF RWP'S TO BE DETERMINED ON SITE - RWP'S IN PORCH TO BE STRAIGHT CONNECTION TO STORMWATER SYSTEM (NO KICK) **ROOF INSULATION NOTE** 

- R4.0 CEILING INSULATION TO HOUSE, GARAGE & ANY EXTERNAL PLASTERBOARD OR VERSILUX CEILINGS IF APPL.

CEILING MATERIAL NOTE - PORCH - HARDIFLEX C.L. - GARAGE - HARDIFLEX C.L. - ALFRESCO - PLASTERBOARD C.L.

- INTERCONNECTED SMOKE DETECTORS TO COMPLY WITH AS3786-2014 AS INDICATED ON PLAN FIXING CARPENTER NOTE - 4 No. 450D SHELVES TO PANTRY AND LINEN UNO - 450D SHELF & RAIL TO ALL WIR, ROBE & ROBE REC. UNO

- 450D SHELF AT 1700 AFL TO BROOM CUPBOARD, IF ANY - PROVIDE MID-SHELF SUPPORT WHERE NOTED "MSS" TO ANY SHELF OVER 1.8m LONG. TRADES / SUPERVISOR NOTE

- REFER TO STRUCTURAL ENGINEERS DETAILS - ALL PLANS TO BE READ IN CONJUNCTION WITH ENGINEERS DRAWINGS & STANDARD SPECIFICATION. GARAGE NOTE

- SINGLE LEAF WALL TO GARAGE IS NOT WATERPROOF - FALL GARAGE SLAB 20mm TOWARDS MAIN GARAGE OP'NG RENDER WALL NOTE PROVIDE 28mm SCOTIA TO JUNCTIONS OF RENDERED WALLS & H/FLEX / VERSILUX CEILINGS

SANITARY COMPARTMENTS NOTE - WHERE INDICATED BY "WC" DOORS TO SANITARY FACILITIES ARE INSTALLED WITH LIFT-OFF HINGES AS PER PART 3.8.3.3 OF B.C.A. (VOL. 2)

BRICKLAYER NOTE

- 1ST FACE BRICKWORK WHERE EVER POSSIBLE. - FOR 2c GARAGE; - 25c & 31c GARAGE HAS 4c LINTEL - 28c GARAGE HAS 3c LINTEL

CONCRETOR/BRK LAYER NOTE - NOTE BRICK WALL ON STRATA BOUNDARY HAS BEEN CALCULATED TO BE SET INSIDE THE BOUNDARY BY 5mm. - ALL ISOLATED PIERS AND POSTS TO HAVE FOOTINGS AT -3c UNLESS


- PROVIDE REVERSE CYCLE AIR CONDITIONING. OUTLET POSITIONS TO BE NOMINATED BY SUPPLIER.
- EXTERNAL UNIT NOT TO BE VISIBLE FROM THE STREET.


PLUMBER NOTE - NO HOBS TO SHOWERS UNLESS SHOWN OTHERWISE. - PLUMBER TO INSTALL REFLUX VALVE.


AIRCON NOTE

PLASTERBOARD NOTE

PROVIDE PLASTERBOARD TO WALLS WHERE INDICATED BY "DW"

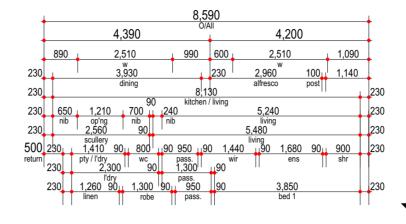

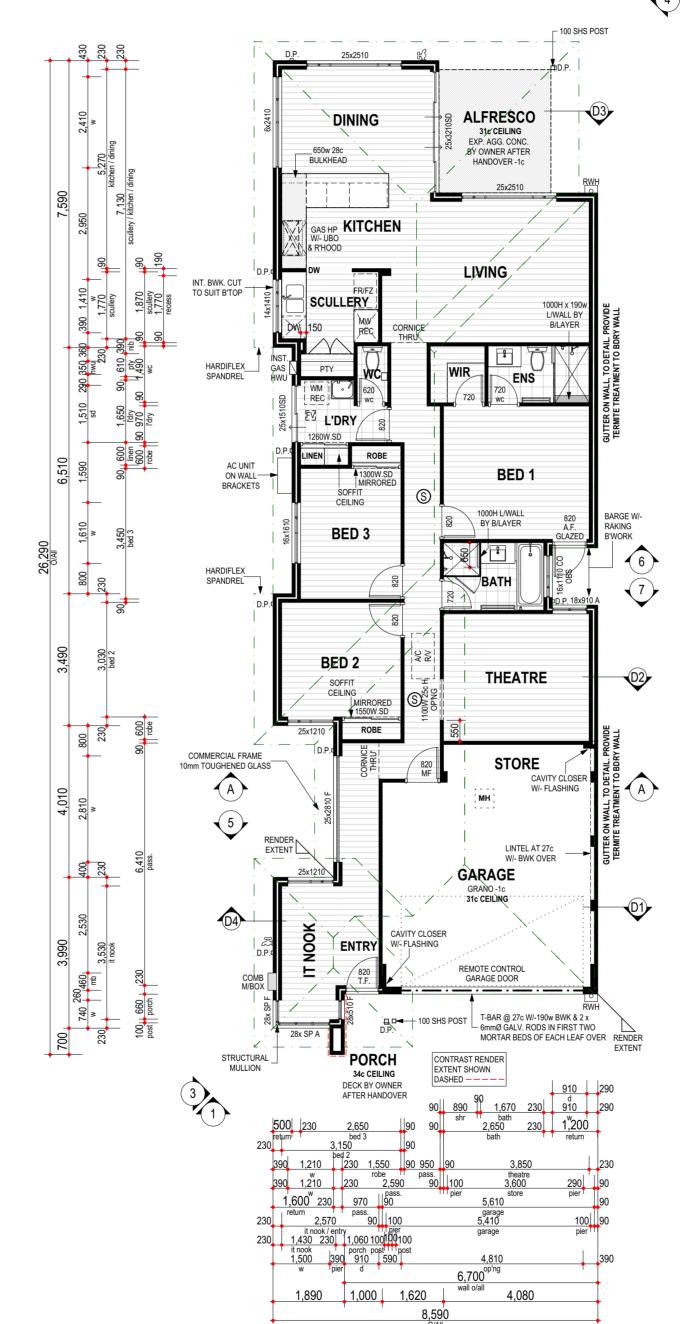


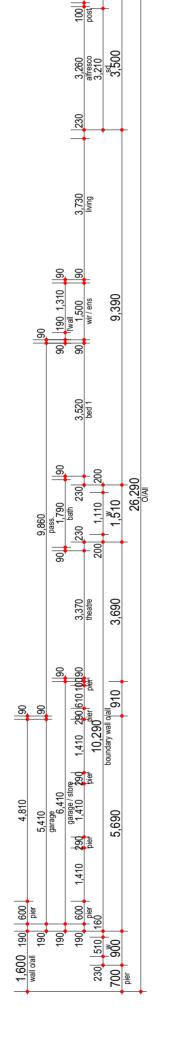




# **FLOOR PLAN**

	Area m²	Perim. L/m
1. FLOOR PLAN	151.61	74.96
2. GARAGE	31.92	22.60
3. STORE	4.08	10.16
4. PORCH	1.35	4.80
5. ALFRESCO	11.20	13.40
6. TOTAL AREA	200.16	74.96
7. ROOF	222 12	77 78

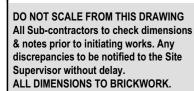

BUILDER:	
CLIENT(S):	
WITNESS:	


DO NOT SCALE FROM THIS DRAWING All Sub-contractors to check dimensions & notes prior to initiating works. Any discrepancies to be notified to the Site Supervisor without delay. ALL DIMENSIONS TO BRICKWORK.

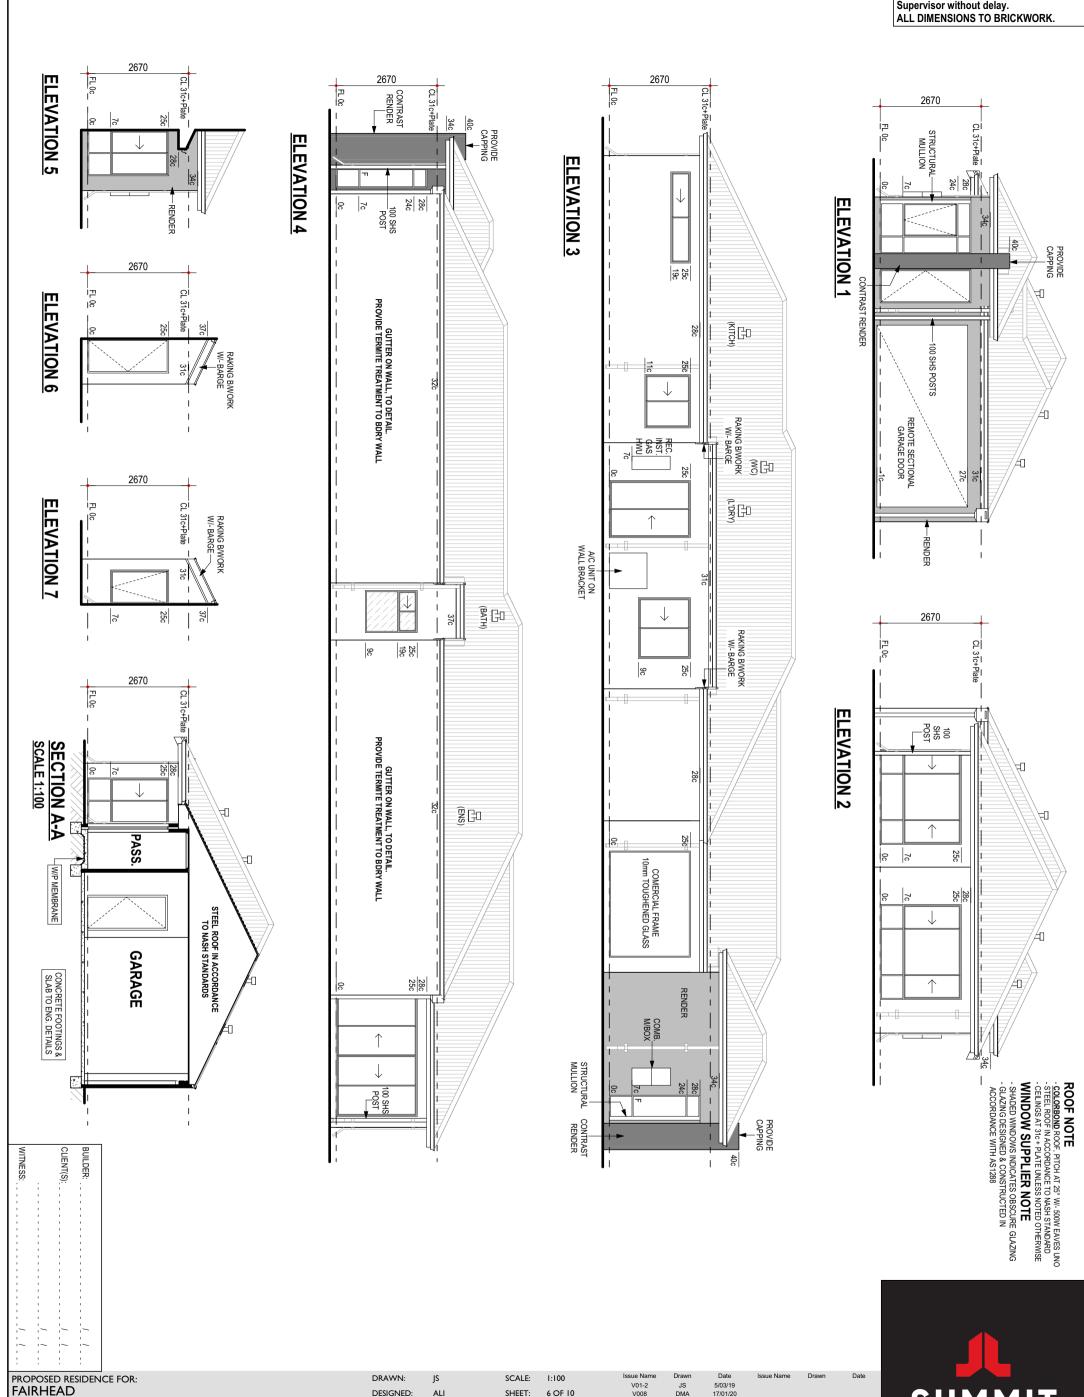

HOMES GROUP


155652

DO NOT SCALE FROM THIS DRAWING All Sub-contractors to check dimensions & notes prior to initiating works. Any discrepancies to be notified to the Site Supervisor without delay. ALL DIMENSIONS TO BRICKWORK.

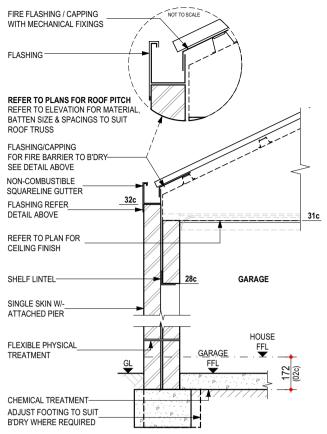

### **D01 - GUTTER ON WALL/FLASHING DETAIL TO GARAGE W/- TERMITE TREATMENT**

- REFER TO ENGINEERS DRAWINGS FOR TIE DOWN DETAILS & BULKHEAD DETAILS WALL THICKNESS & FINISH NOT SHOWN FOR CLARITY. REFER TO PLANS
- REFER TO ENGINEERS DRAWINGS FOR FOOTING AND SLAB DETAILS STEEL ROOF CONSTRUCTED IN ACCORDANCE TO MANUFACTURER'S SPEC
- SCALE 1:20

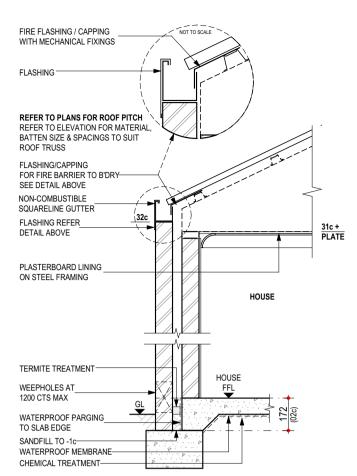


#### **D02 - GUTTER ON WALL / FLASHING DETAIL TO HOUSE** W/- TERMITE TREATMENT

- REFER TO ENGINEERS DRAWINGS FOR TIE DOWN DETAILS & BULKHEAD DETAILS WALL THICKNESS & FINISH NOT SHOWN FOR CLARITY. REFER TO PLANS
- REFER TO ENGINEERS DRAWINGS FOR FOOTING AND SLAB DETAILS STEEL ROOF CONSTRUCTED IN ACCORDANCE TO MANUFACTURER'S SPEC.
- SCALE 1:20

REFER TO PLANS FOR ROOF PITCH REFER TO ELEVATION FOR MATERIAL, **BATTEN SIZE & SPACINGS TO SUIT ROOF TRUSS** PLASTERBOARD LINING ON STEEL FRAMING P/BOARD LINING ON FURRING CHANNEL RHS W/ **OVER** 28c HARDIFI EX LINING ON STEEL FRAMING SCOTIA-ALFRESCO HOUSE 640 RONDO BULKHEAD TRIM-REFER TO PLAN FOR POST TYPE AND SIZE

# **D03 - 3c RECESSED CEILING TO ALFRESCO**

- REFER TO ENGINEERS DRAWINGS FOR TIE DOWN DETAILS & BULKHEAD DETAILS STEEL ROOF CONSTRUCTED IN ACCORDANCE TO MANUFACTURER'S SPEC.

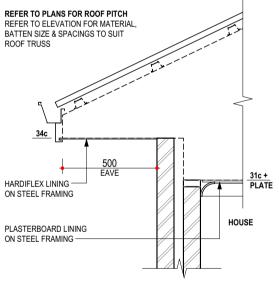

# **D04 - IT NOOK EAVE**


NOTES:
- REFER TO ENGINEERS DRAWINGS FOR TIE DOWN DETAILS & BULKHEAD DETAILS - STEEL ROOF CONSTRUCTED IN ACCORDANCE TO MANUFACTURER'S SPEC.

- SCALE 1 : 20

				_
WITNESS: _		CLIENT(S):	BUILDER:	
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1	1	1	1	L

1 1 1 PROPOSED RESIDENCE FOR: SCALE: AS NOTED DRAWN: V01-2 V008 JS DMA 5/03/19 **FAIRHEAD** SHEET: 7 OF 10 DESIGNED: ALI 17/01/20 06/02/20 14/02/20 28/04/20 V009 V010 V014 DMA DMA DMA CHECKED: SIZE: DM A3 ADDRESS: DATE: 5/03/19 DIVISION: SUMMIT PROJECTS LOT 9 (#6) CLEVEDON PLACE, MODEL: JOB N° KALLAROO. **SPECIAL** 155652 **DETAILS** 



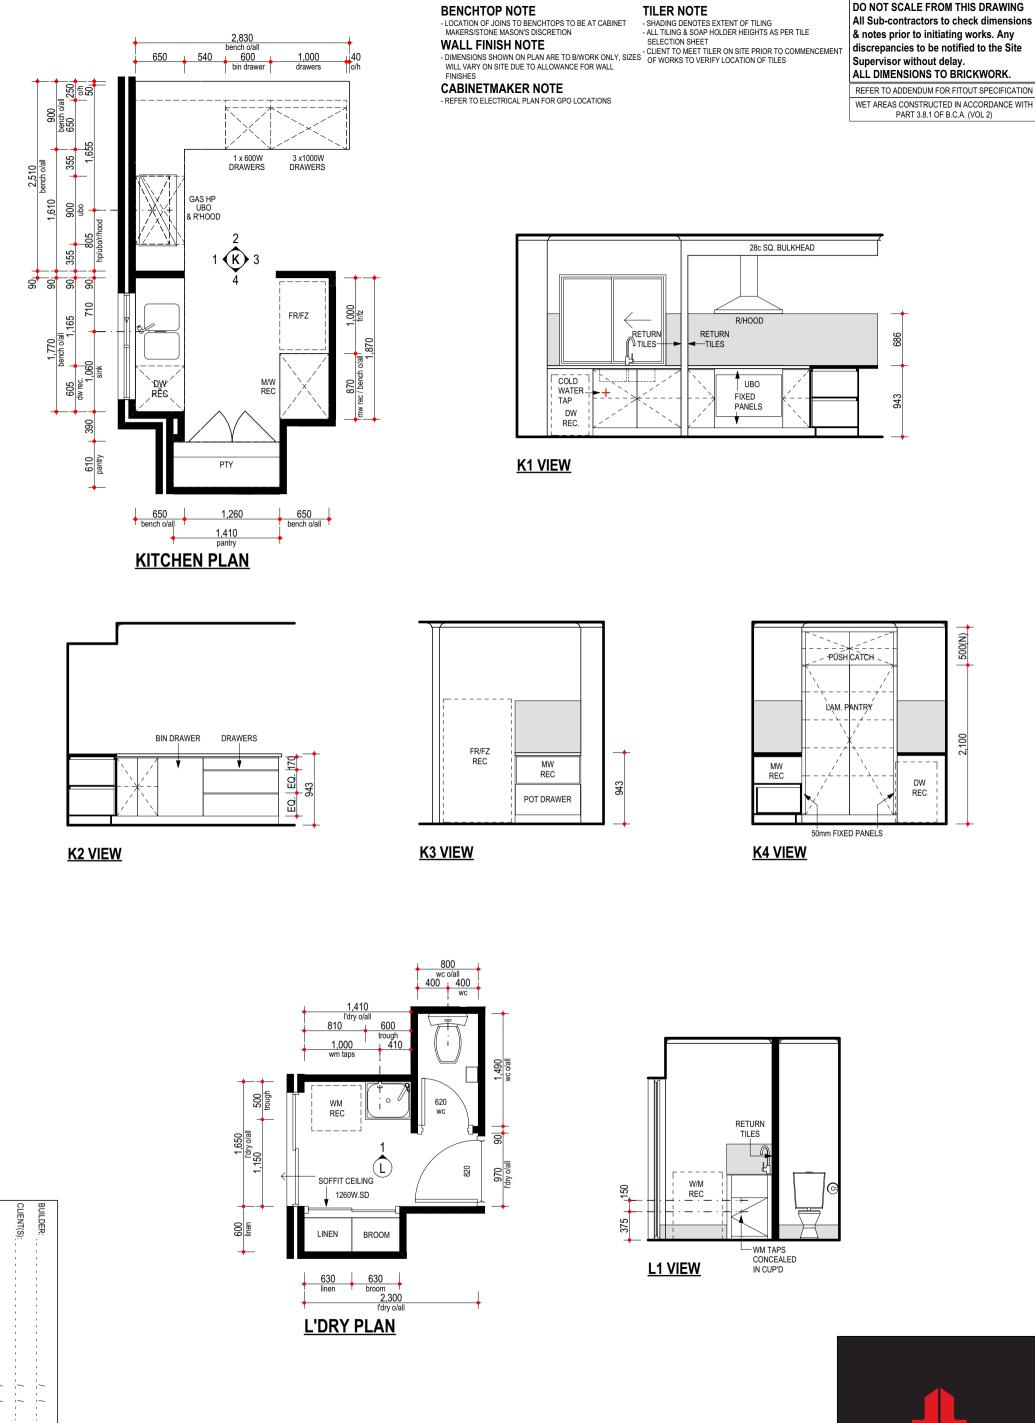

PROPOSED RESIDENCE FOR: DRAWN: SCALE: I:50 V01-2 V008 V009 V010 V014 JS DMA DMA DMA DMA 5/03/19 17/01/20 06/02/20 14/02/20 28/04/20 **FAIRHEAD** SHEET: 8 OF 10 DESIGNED: ALI CHECKED: SIZE: DM A3 ADDRESS: DIVISION: SUMMIT PROJECTS DATE: LOT 9 (#6) CLEVEDON PLACE, MODEL: JOB N° KALLAROO. **SPECIAL** 155652 KITCHEN - L'DRY LAYOUTS



BATH/ENS. REC. SHR SCREEDED GRANO W/-FLOOR FINISH AS SPECIFIED ON PLAN WATERPROOF MEMBRANE SLAB THICKENING AS REQUIRED CHEMICAL TREATMEN

#### NOTES:

- REFER TO ENGINEERS DRAWINGS FOR FOOTING AND SLAB DETAILS WALL THICKNESS & FINISH NOT SHOWN FOR CLARITY. REFER TO PLANS

### **BENCHTOP NOTE**

- LOCATION OF JOINS TO BENCHTOPS TO BE AT CABINET MAKERS/STONE MASON'S DISCRETION

# **WALL FINISH NOTE**

WALL FINISH NOTE

- DIMENSIONS SHOWN ON PLAN ARE TO B/WORK ONLY, SIZES

WILL VARY ON SITE PURE TO ALL OWANCE FOR WALL

WILL VARY ON SITE PURE TO ALL OWANCE FOR WALL

OF WORKS TO VERIFY LOCATION OF TILES WILL VARY ON SITE DUE TO ALLOWANCE FOR WALL FINISHES

### **CABINETMAKER NOTE**

- REFER TO ELECTRICAL PLAN FOR GPO LOCATIONS


#### **TILER NOTE**


- SHADING DENOTES EXTENT OF TILING ALL TILING & SOAP HOLDER HEIGHTS AS PER TILE


DO NOT SCALE FROM THIS DRAWING All Sub-contractors to check dimensions & notes prior to initiating works. Any discrepancies to be notified to the Site Supervisor without delay. ALL DIMENSIONS TO BRICKWORK.

REFER TO ADDENDUM FOR FITOUT SPECIFICATION WET AREAS CONSTRUCTED IN ACCORDANCE WITH

# **RECESSED SHOWER DETAIL (NO HOB)**

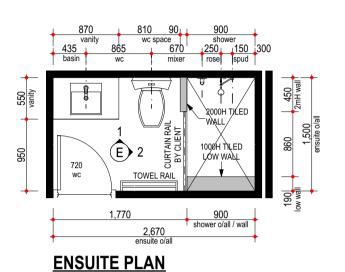


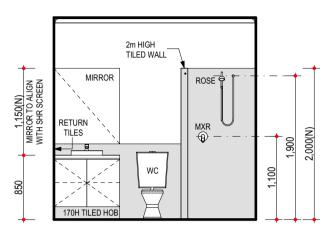


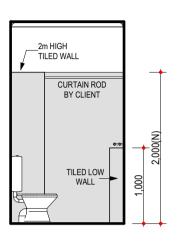



E1 VIEW


**E2 VIEW** 

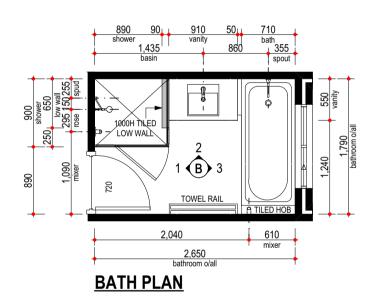

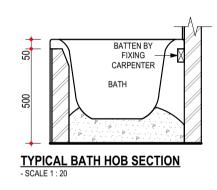

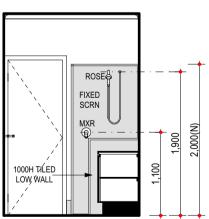

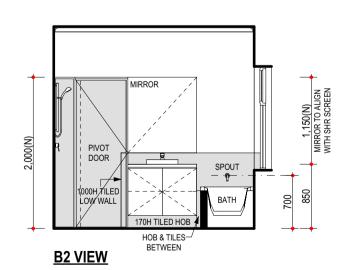

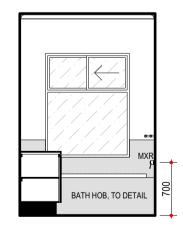

**B3 VIEW** 

**B1 VIEW** 

BUILDER:

PROPOSED RESIDENCE FOR: **FAIRHEAD** 

ADDRESS: LOT 9 (#6) CLEVEDON PLACE, KALLAROO.

DRAWN: DESIGNED: CHECKED: DATE: MODEL:

**SPECIAL** 

ALI DM 5/03/19

SCALE: 1 : 50 SHEET: 9 OF 10 SIZE: A3 DIVISION: SUMMIT PROJECTS

V01-2 V008 V009 V010 V014 JS DMA DMA DMA DMA

5/03/19 17/01/20 06/02/20 14/02/20 28/04/20



JOB N° **BATHROOM - ENSUITE LAYOUTS** 155652

# **ELECTRICAL LEGEND**

Ground Floor				
Qty	Sym.	Description  EXTERNAL WALL LIGHT @ 2000 AFL	Watts	Penetrati
2	<b>1</b> 11w*	Perimeter Lighting	22*	*
6	• 7w*	RECESSED LED DOWN-LIGHT ( 7w) External	42*	*
2	O11w*	CEILING LIGHT (11w) Class 10 22*		*
2		STARLIGHT (3w) 6		0.013
1	● 11w	RECESSED LED DOWN-LIGHT (11w) 1		
23	• 7w	RECESSED LED DOWN-LIGHT ( 7w) 161		
2		PLUG BASE	0	
2	S	H.WIRED SMOKE DETECTOR	0	
3	•	EXHAUST FAN	0	0.136
3	◯ 11w	CEILING LIGHT (11w)	33	
2	2 WAY	2 WAY SWITCH	0	
1	•	W/P SGPO INSTALLED IN HWU	0	
1		SINGLE GPO IN/ON CEILING	0	
1		SINGLE GPO FOR R/H (REFER TO PLAN FOR R/H TYPE)	0	
4		SINGLE GPO @ NOTED HT	0	
1	С	NBN LEAD IN CONDUIT (25mm) W/- BLANK FACE PLATE AT 1500 AFL	0	
2		DOUBLE WATER PROOF GPO	0	
1		DOUBLE GPO @ NOTED HT W/USB	1	
7		DOUBLE GPO @ NOTED HT	0	
1		DOUBLE GPO @ 200 AFL W/USB	1	
10	-	DOUBLE GPO @ 200 AFL	0	
1		DOUBLE GPO @ 1500 AFL W/ 20mm CONDUIT FOR PSU CONNECTION	0	
1	©	CONDUIT FOR NBN (25mm)	0	
3	©	CONDUIT 20mm	0	
1	©	CONDUIT (32mm)	0	
1	©	25mm CONDUIT TO SWITCH	0	
1	D2	D2 (2x DATA/PHONE) FOR NBN PROVISION @ 1500 AFL	0	
1	C1D2	C1 (TV) + D2 (PH/DATA)	0	
1	C1(TV)	C1 (TV)	0	

PERIMETER LIGHTING MIN. 40 LUMENS/W.

**Total Class 1 Wattage= 213** 

## LIGHT AND VENTILATION CALC

				I CA	
Room Name		Opn %	Light		Vent.
6   IT NOOK Min. Ventilation = 0.4	1   Min. Li	ght= 0.55 To	otal Area= 5.50		
W04   Sliding		36 %	2.59 m2		0.93 m2
W03   Fixed		0 %	1.78 m2		0.00 m2
W02   Awning		34 %	3.60 m2		1.24 m2
W01   Fixed		0 %	1.22 m2		0.00 m2
	Totals	Light	9.19 m2	Vent	2.17 m2
5   THEATRE Min. Ventilation = 0.9		ght= 1.30 To	otal Area= 12.9	7	
W15   Awning		100 %	1.40 m2		1.40 m2
	Totals	Light	1.40 m2	Vent	1.40 m2
4   BED 3 Min. Ventilation = 0.6	9   Min. Li	ght= 0.91 To	otal Area= 9.14		
W07   Sliding		50 %	2.21 m2		1.10 m2
	Totals	Light	2.21 m2	Vent	1.10 m2
3   BED 2 Min. Ventilation = 0.7	2   Min. Li	ght= 0.95 To	otal Area= 9.54		
W06   Sliding		36 %	2.59 m2		0.93 m2
	Totals	Light	2.59 m2	Vent	0.93 m2
2   BED 1 Min. Ventilation = 1.0	2   Min. Li	ght= 1.36 To	otal Area= 13.5	5	
D02   D		100 %	1.95 m2		1.95 m2
D02   Door					
DUZ   DOOF	Totals	Light	1.95 m2	Vent	1.95 m2
1   SCULLEF Min. Ventilation = 3.3	RY   LI	VING   I	KITCHEN	1   DIN	
1   SCULLEF Min. Ventilation = 3.3	RY   LI	VING   I	KITCHEN	1   DIN	
1   SCULLEF Min. Ventilation = 3.3 W13   Sliding	RY   LI	VING   I ght= 4.41 To 36 %	KITCHEN otal Area= 44.0	1   DIN	IING
1   SCULLEF Min. Ventilation = 3.3 W13   Sliding W12   Sliding Door	RY   LI	VING   I ght= 4.41 To 36 % 50 %	KITCHEN otal Area= 44.0 5.38 m2	1   DIN	1.94 m2
1   SCULLEF	RY   LI	VING   I ght= 4.41 To 36 % 50 % 36 %	XITCHEN otal Area= 44.0 5.38 m2 6.88 m2	1   DIN	1.94 m2 3.44 m2
1   SCULLEF Min. Ventilation = 3.3 W13   Sliding W12   Sliding Door W11   Sliding	RY   LI	VING   I ght= 4.41 To 36 % 50 % 36 % 50 %	KITCHEN tal Area= 44.0 5.38 m2 6.88 m2 5.38 m2	1   DIN	1.94 m2 3.44 m2 1.94 m2

PROPOSED RESIDENCE FOR:

**FAIRHEAD** 

ADDRESS: LOT 9 (#6) CLEVEDON PLACE, KALLAROO.

DESIGNED: ALI CHECKED: DM DATE: MODEL: **SPECIAL** 

DRAWN:

SCALE: 1:100 SHEET: SIZE: JOB N°

10 OF 10 A3 DIVISION: SUMMIT PROJECTS 155652 **ELECTRICAL PLAN** 

V01-2 V008 JS DMA DMA DMA DMA

5/03/19 17/01/20 06/02/20 14/02/20 15/04/20 28/04/20

DO NOT SCALE FROM THIS DRAWING All Sub-contractors to check dimensions & notes prior to initiating works. Any discrepancies to be notified to the Site Supervisor without delay. ALL DIMENSIONS TO BRICKWORK.

REFER TO ADDENDUM FOR ELEC. SPECIFICATION

## **ELECTRICAL NOTE**

- INTERCONNECTED SMOKE DETECTORS TO AS3786-2014 - FINAL POSITION OF ELECTRICAL ITEMS SUCH AS GPO'S, LIGHT SWITCHES ETC. MAY VARY ON SITE DUE TO ELECTRICAL REGULATIONS. LIGHT SWITCH HEIGHT TO BE AT 1200 AFL U.N.O.
- NEUTRAL CABLING REQUIRED TO ALL LIGHT SWITCHES.

- ALL EXHAUST FANS TO BE FLUED TO EXTERNAL AIR - PROVIDE SPLITTER FOR UP TO 3x C1 POINTS

#### **AIRCON NOTE**

- PROVIDE REVERSE CYCLE AIR CONDITIONING. OUTLET POSITIONS TO BE NOMINATED BY SUPPLIER. EXTERNAL UNIT NOT TO BE VISIBLE FROM THE STREET.

0.18 % R4.0 Insulation Adjustment Not Required **CLIENT NOTE: MAX WATTAGE AND** PENETRATIONS MUST NOT BE EXCEEDED

Recessed Fitting Penetrations (Class 1)

Wattage Calculations (Class 1)

Story Name

**Story Name** 

**Total Insulation Area** 

Vents\RangeHoods

0 | Ground Floor

Allowed

Wattage

681 w

681 w

Maximum

**Penetrations** 

0.681 sqm

0.681 sqm

136.28 Sqm

136.28 sqm

136.28 sqm

136.28 sqm

Area

Actual Wattage

213 w

213 w

Actual


**Penetrations** 

0.148 sqm 0.094 Sqm

0.242 sqm

PASS

PASS

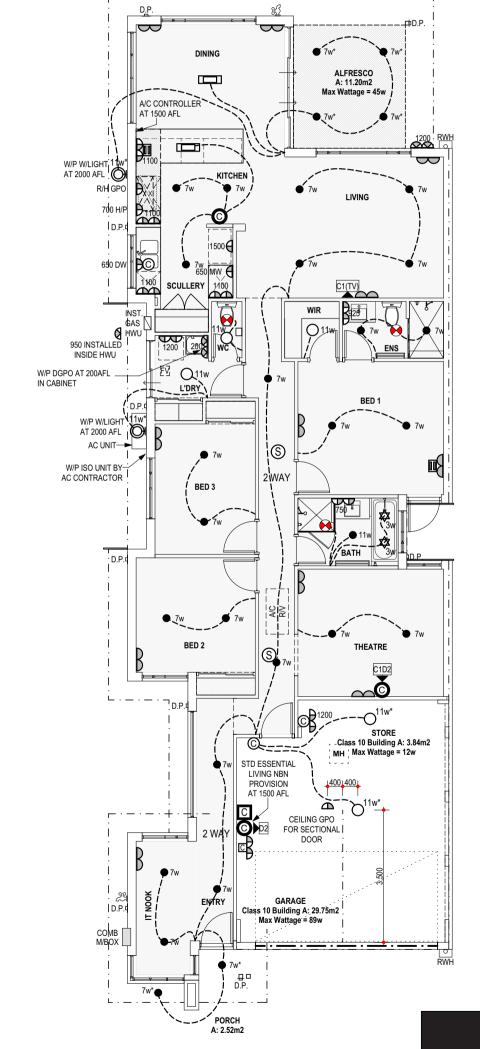

HOMES GROUP

**BUILT AROUND PEOPLE** 

Inputs for Airmovement and Light are Valid