


161700 161700 161600

Existing Location Plan (1:1250)

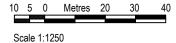

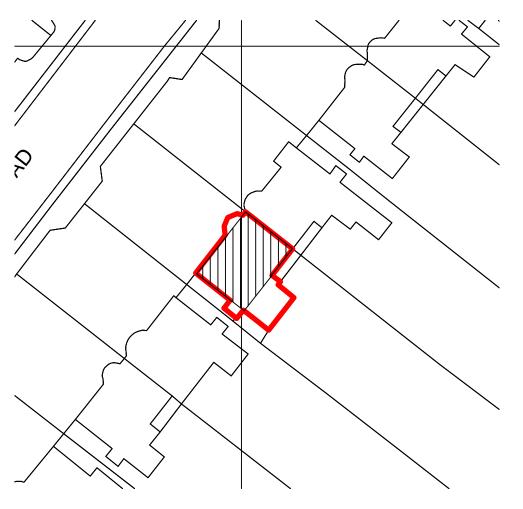

Proposed Block Plan (1:500)

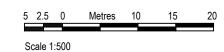



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Revision Rev Date

Client: Khalid & Bushra Khan

Project: 10 Addington Road, CR2 8RB Loft Conversion & Rear Extension

Drawing: Block & Location Plans


Armstrong Simmonds Architects

Unit 23, Battersea Business Centre, 99-109

Lavender Hill, London, SW11 5QL

t: 020 7228 1324 m: 07817127275 m: 07779668358 e: info@as-architects.co.uk

Drawing Number: 884_10AR_X000		Revision:	
Scale: 1:1250 / 1:500 @A3	Date: July 2017	Drawn: OH	

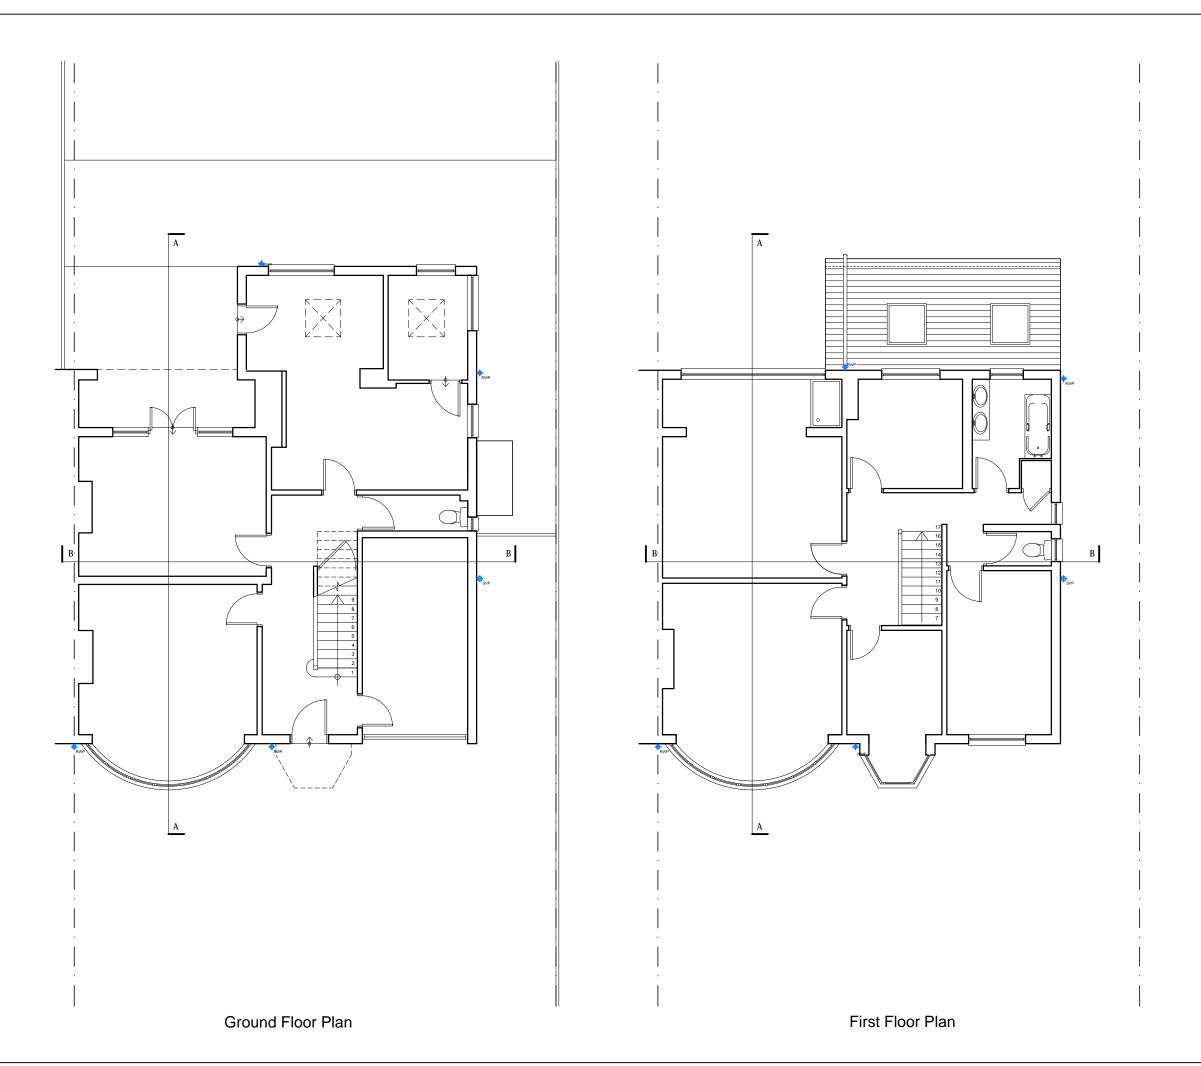

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Scale 1:100


NOT FOR CONSTRUCTION

Rev	Rev Date Revision				
	Client: Khalid & Bushra Khan				
Project: 10 Addington Road, CR2 8RB Loft Conversion & Rear Extension					
Drawing: Ground & First Floor EXISTING					
Arm	nstrong	Simmonds	Architects		
Unit 02 Patternes Business Centre 00 100					

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t: 020 7228 1324 m: 07817127275 m: 07779668358 e: info@as-architects.co.uk

Drawing Number 884_10AR_X00	Revision:	
Scale:	Date:	Drawn:
1:100 @A3	July 2017	OH

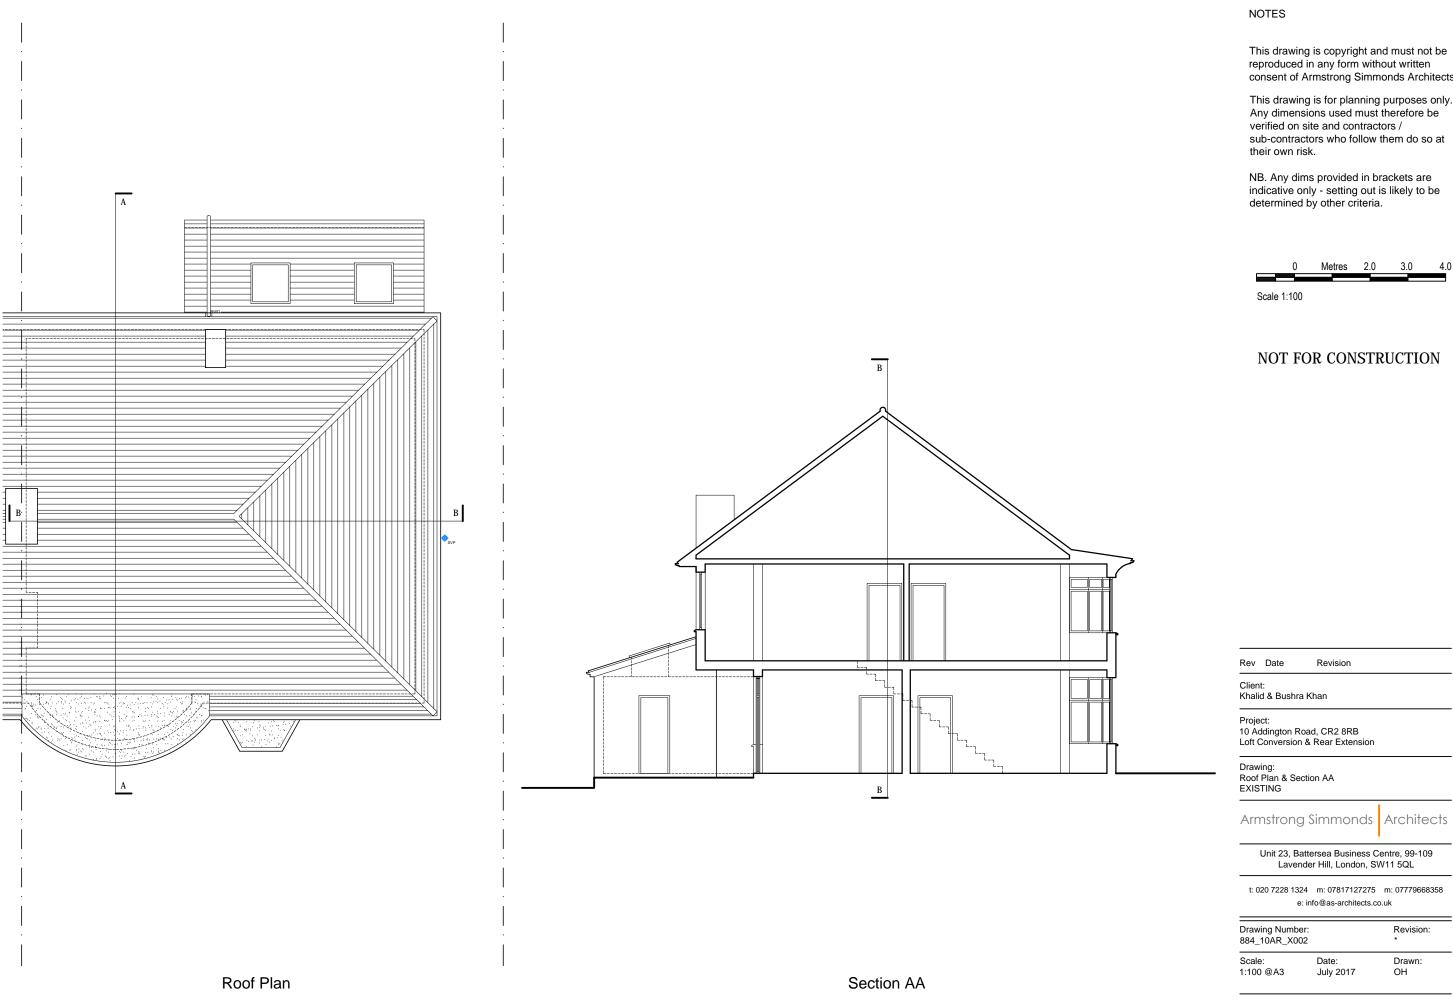

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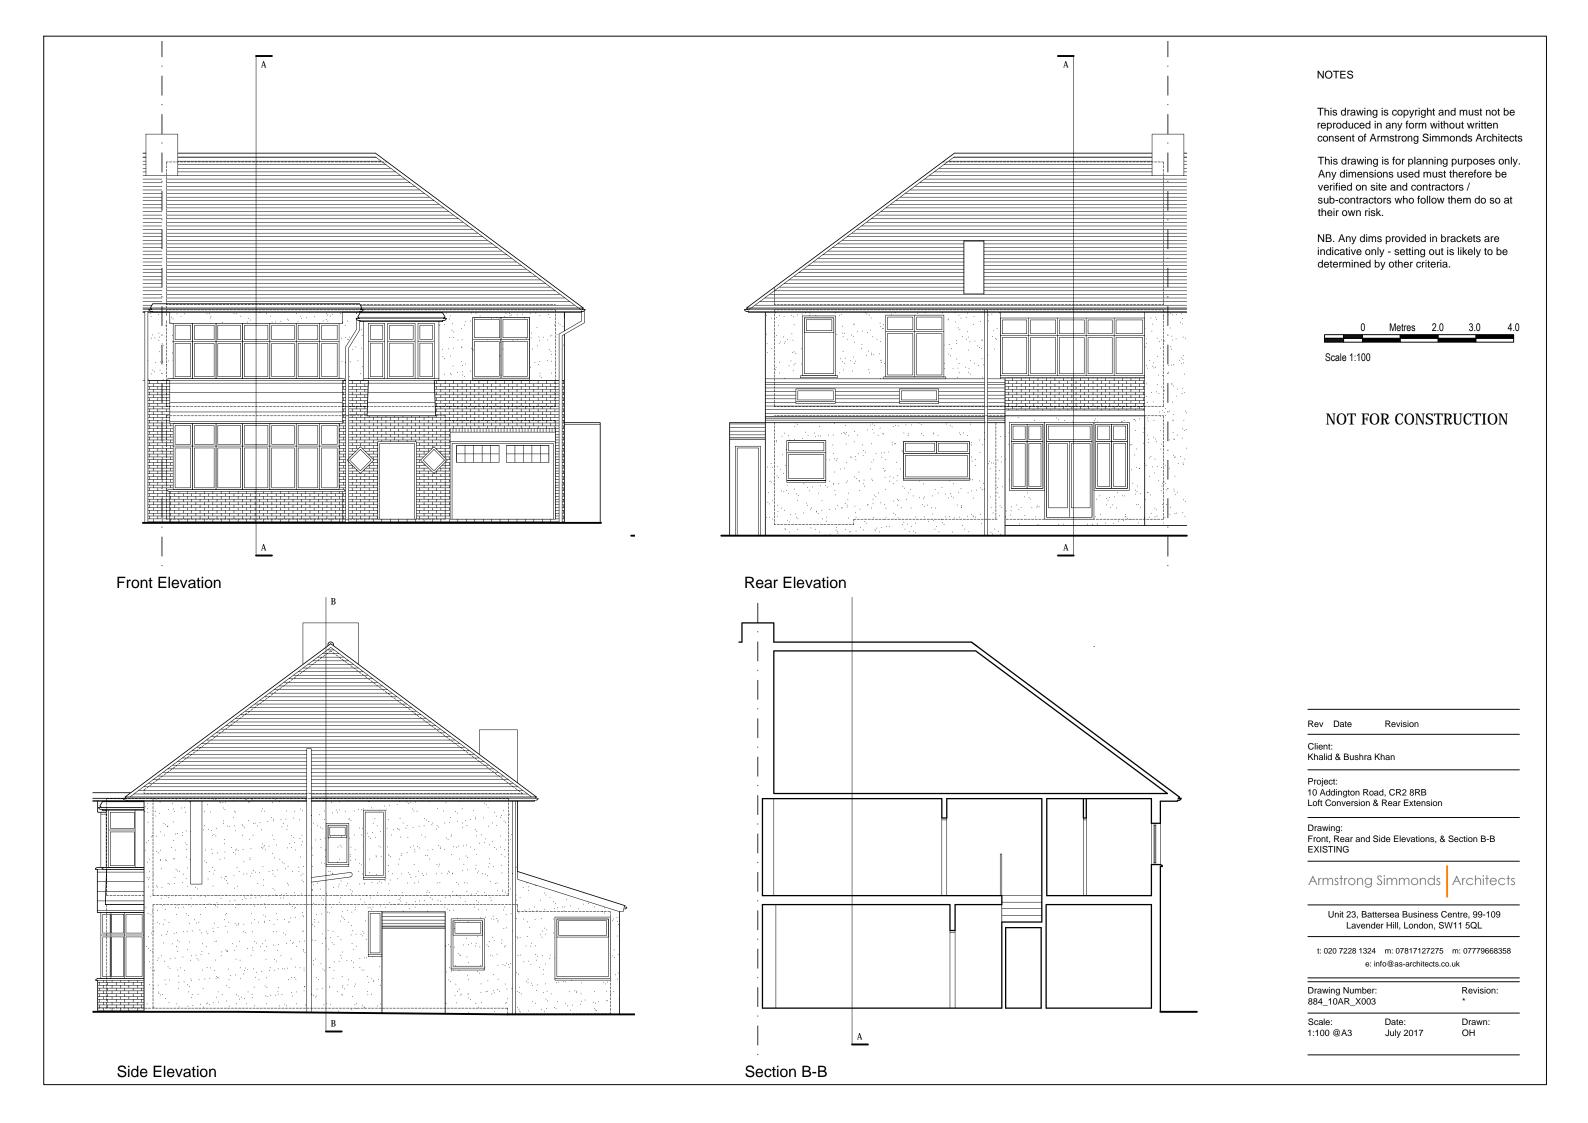



Armstrong Simmonds Architects


Lavender Hill, London, SW11 5QL

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Revision: Drawn: ОН





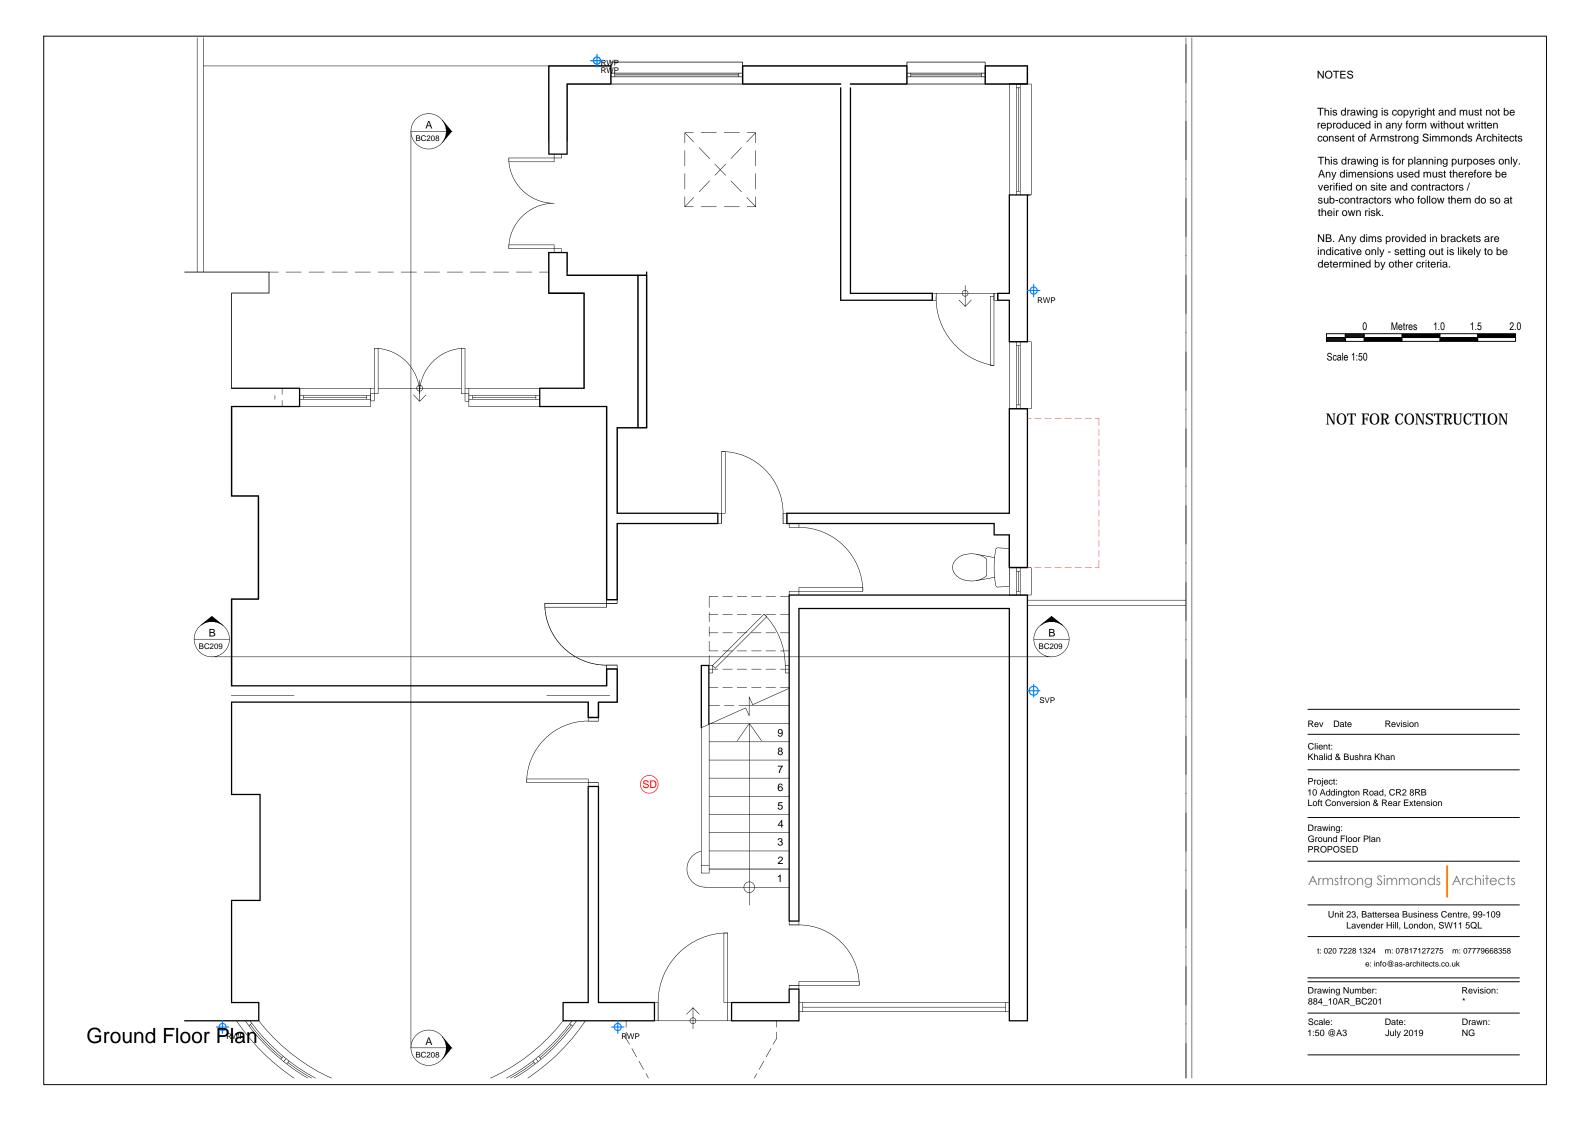

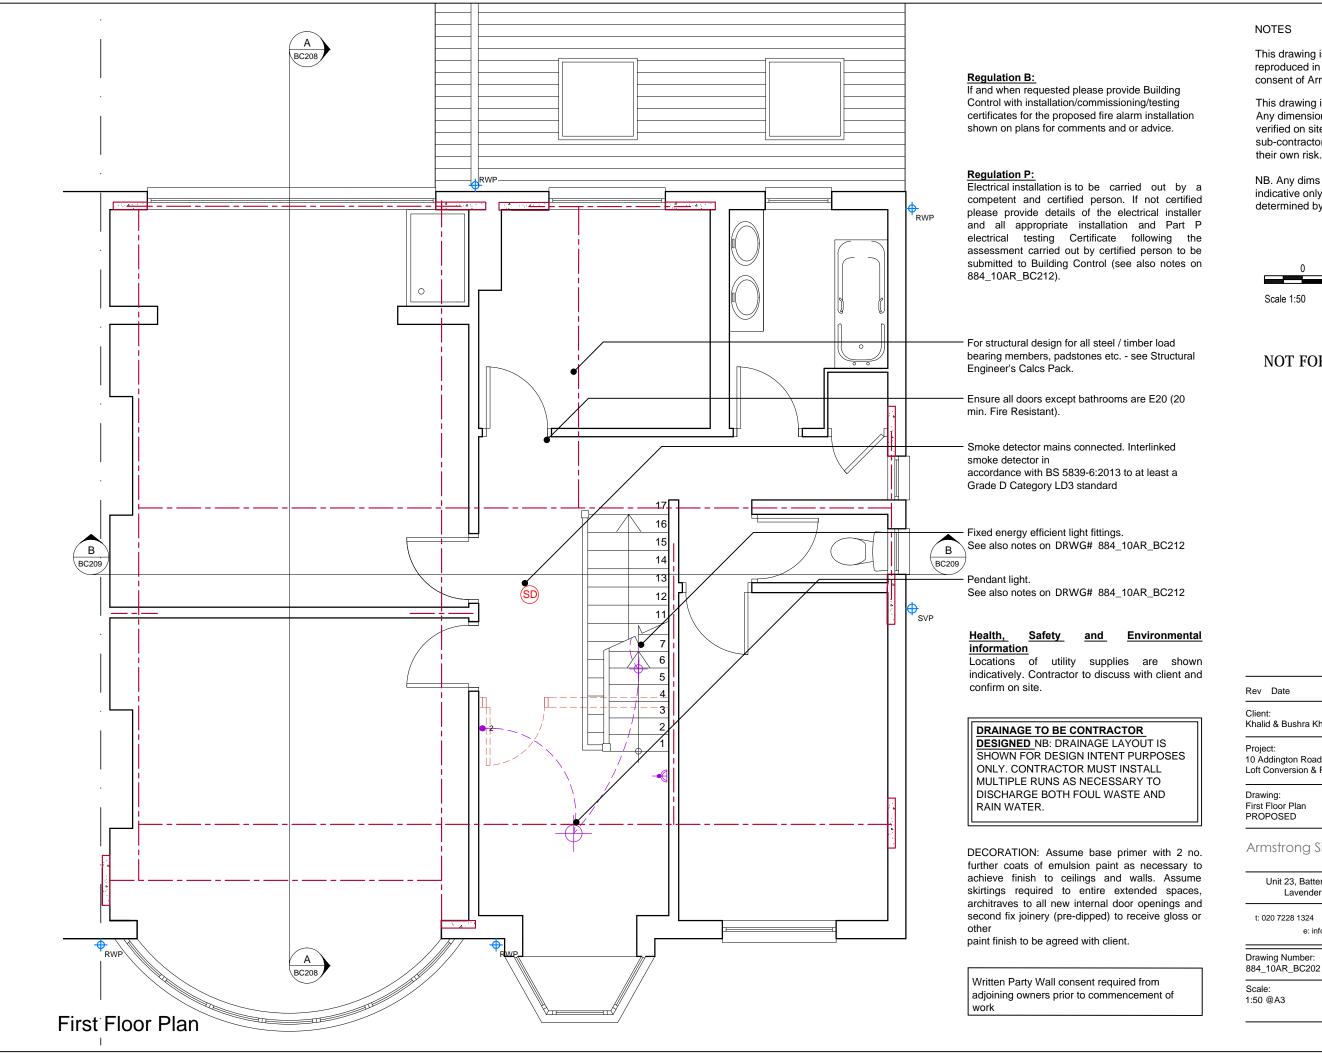
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Scale 1:50

NOT FOR CONSTRUCTION

Rev	Date	Revision	
Clien Khali	t: d & Bushra	a Khan	
Project: 10 Addington Road, CR2 8RB Loft Conversion & Rear Extension			
Drawing: First Floor Plan PROPOSED			
Armstrong Simmonds			Architects
Unit 23, Battersea Business Centre, 99-109			

Lavender Hill, London, SW11 5QL

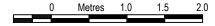
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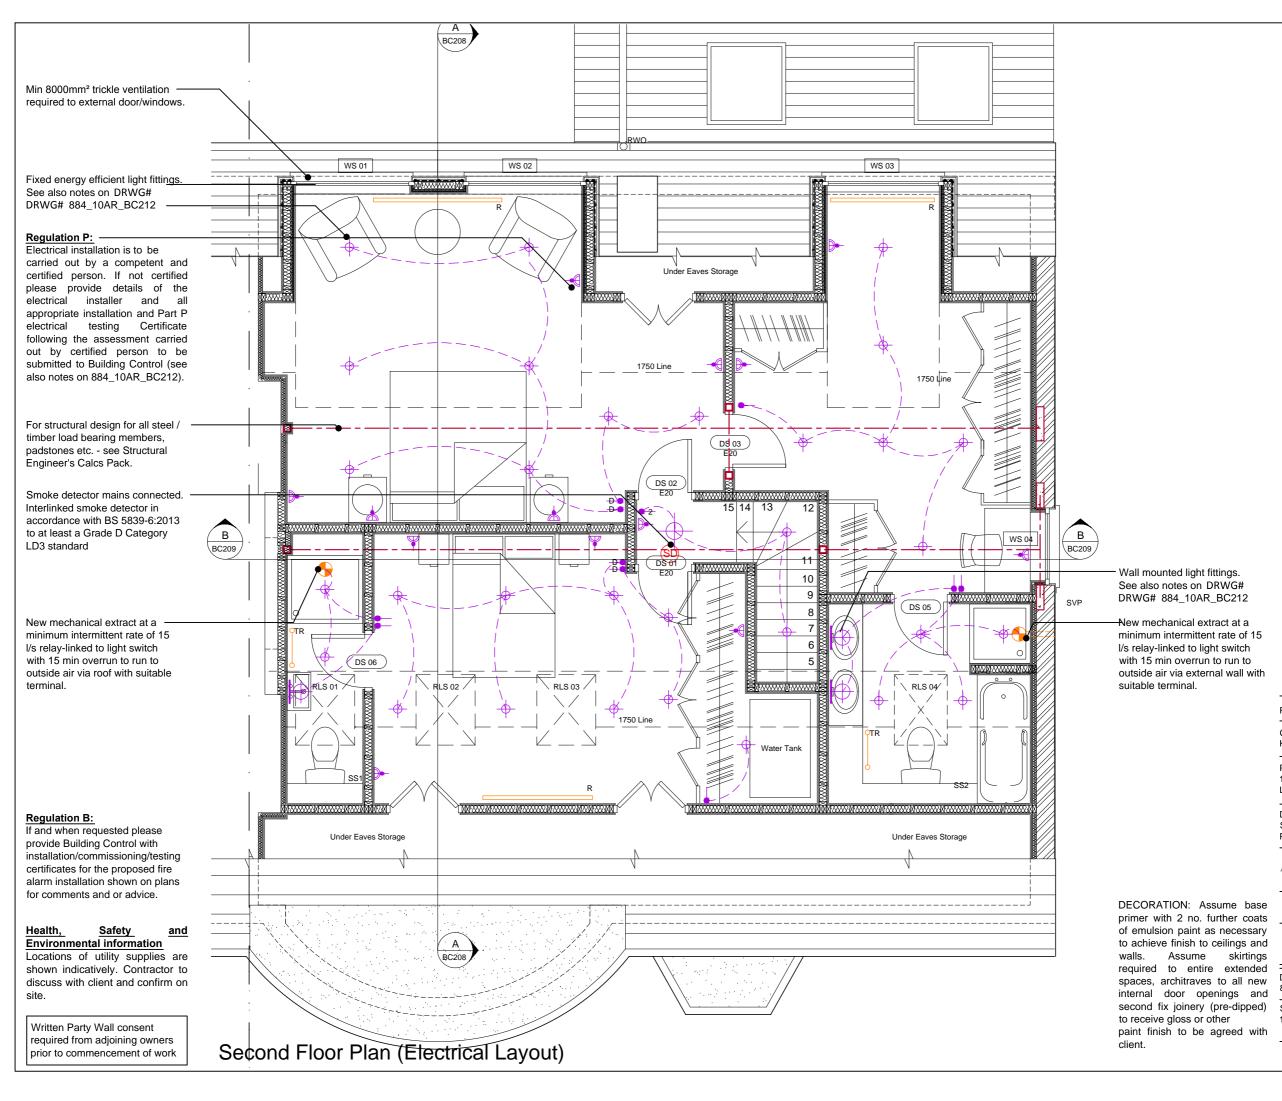
July 2019


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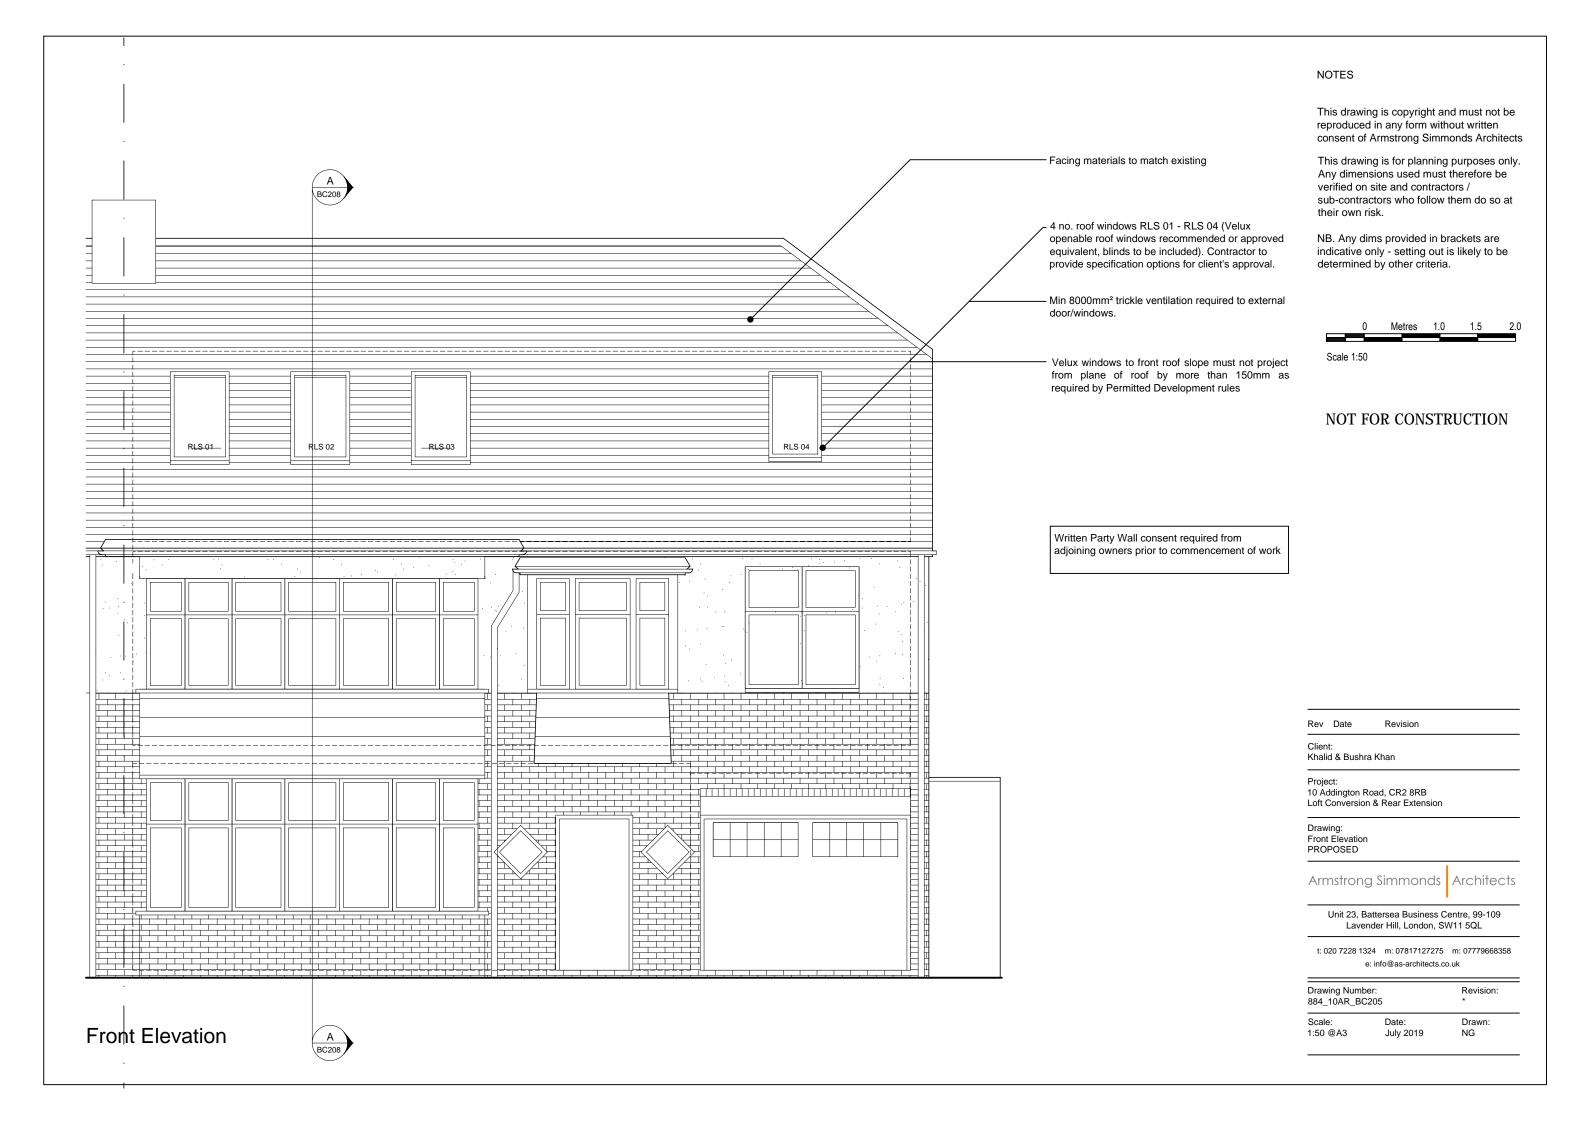
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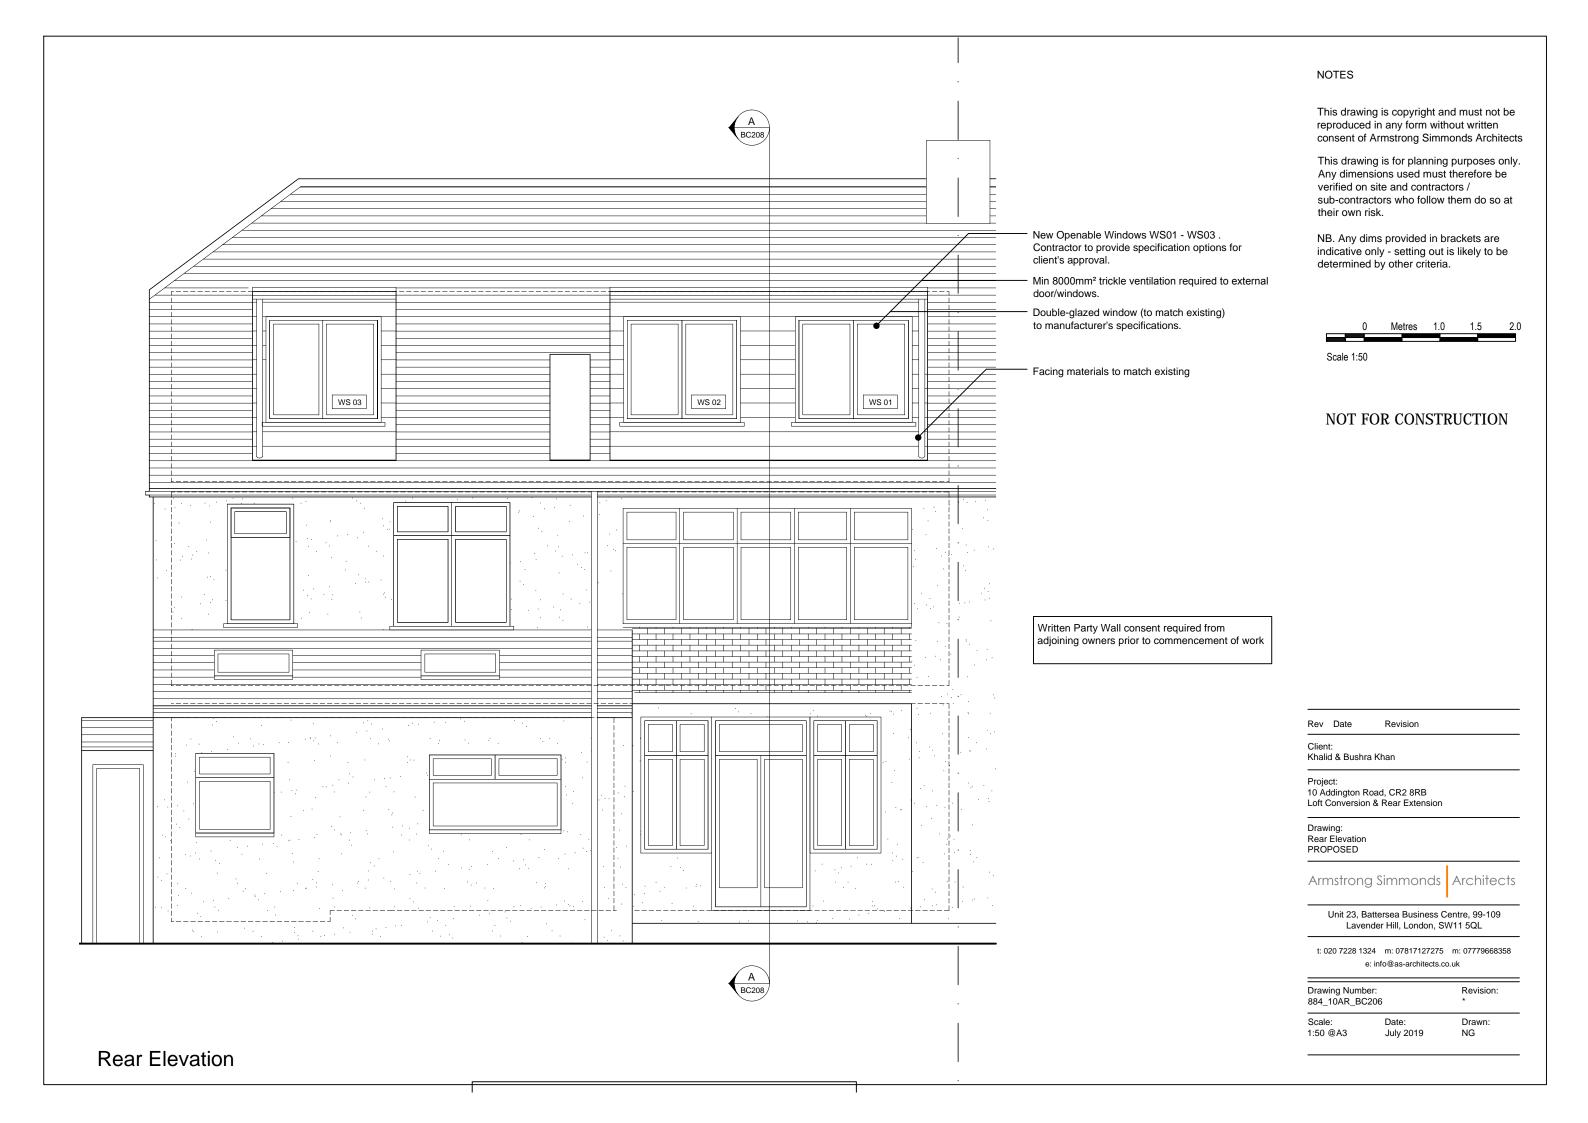
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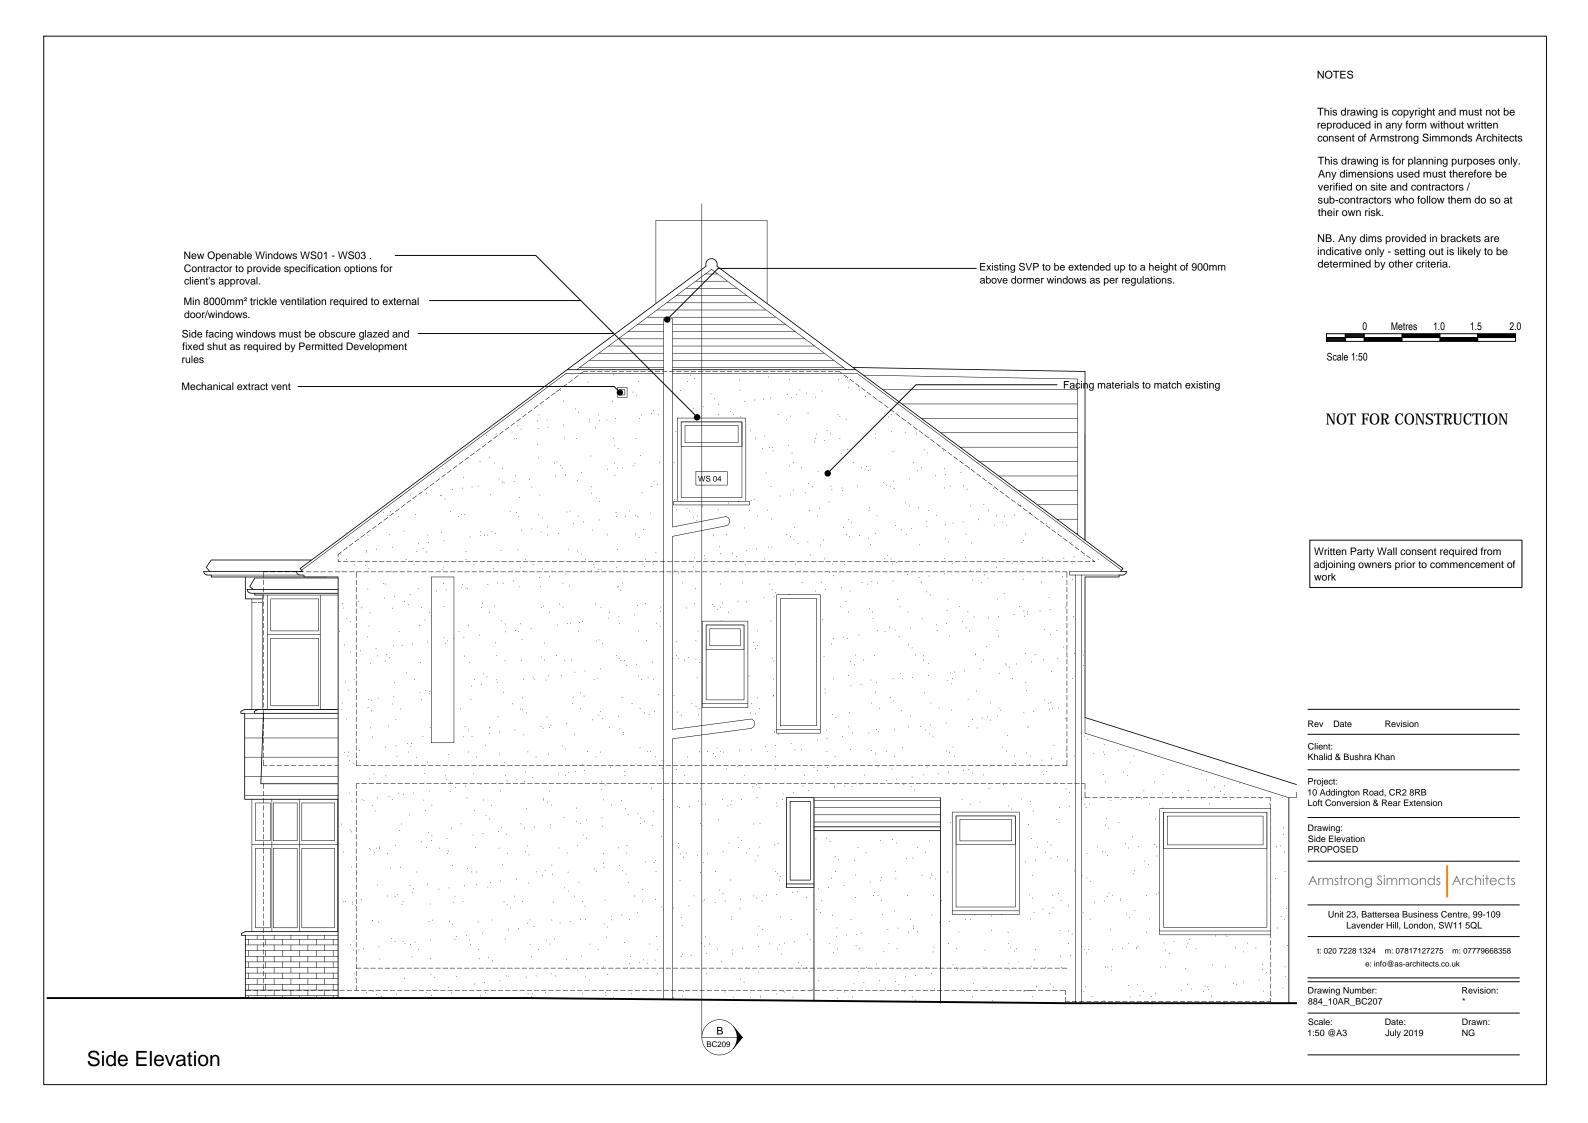











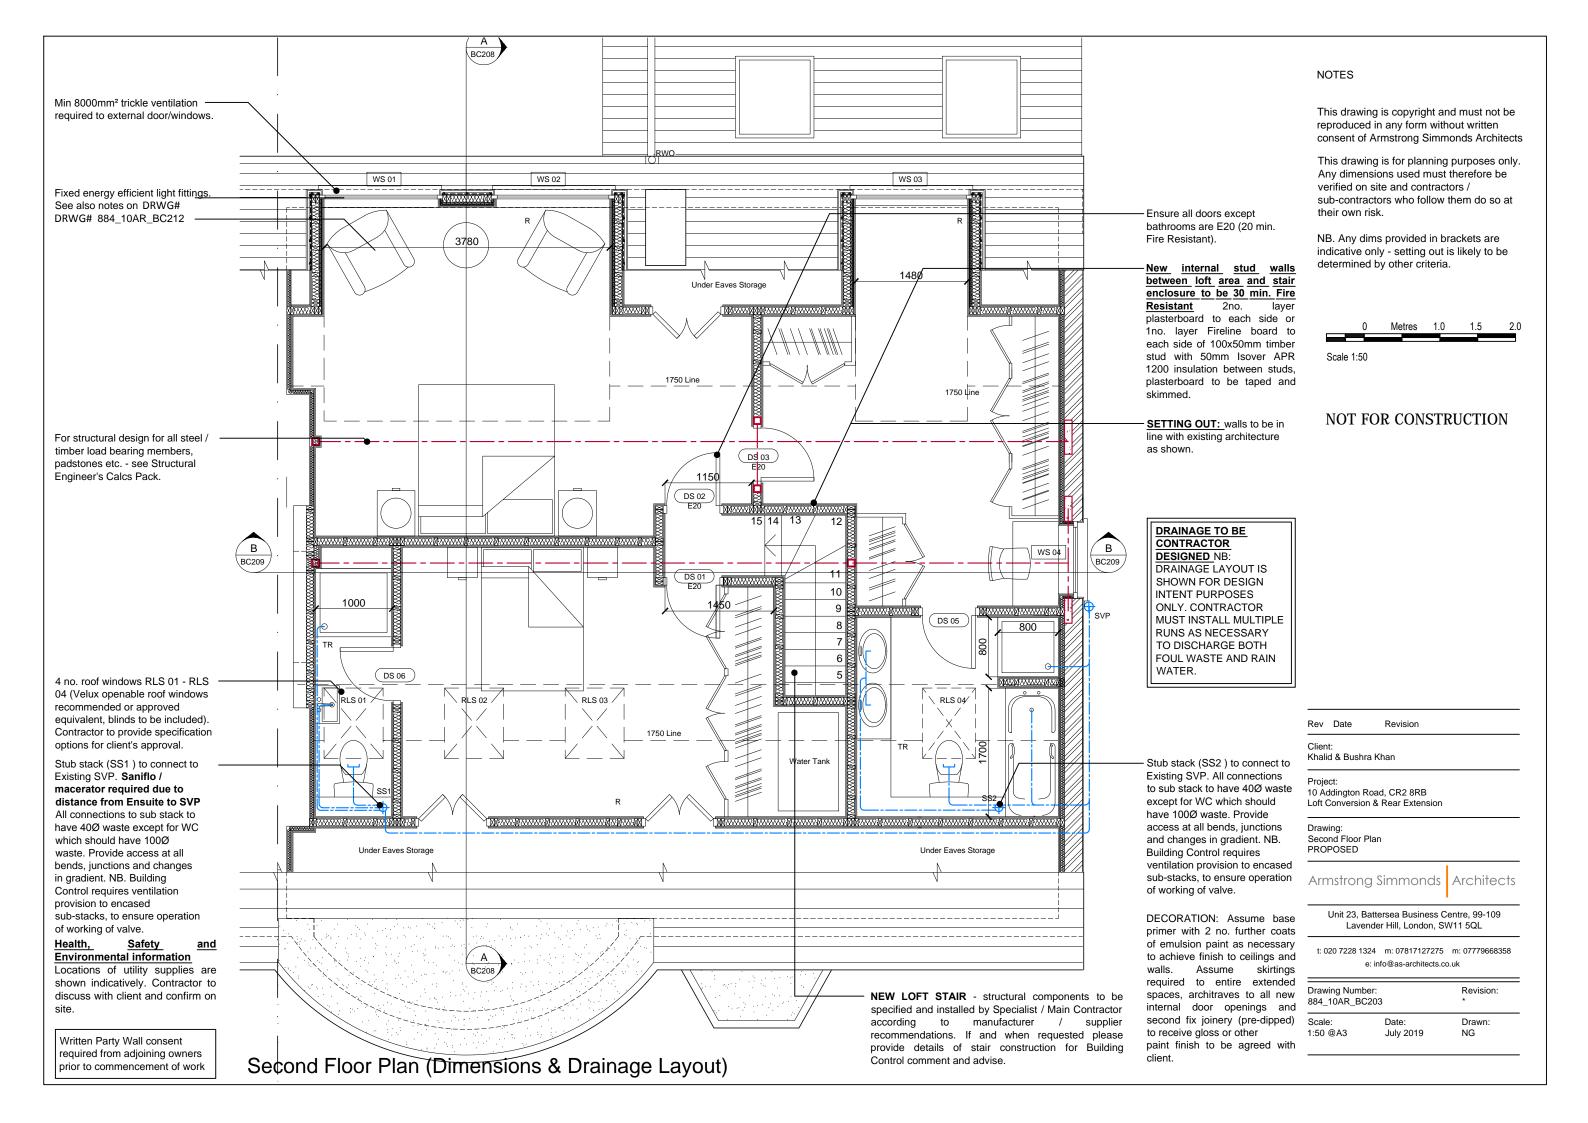


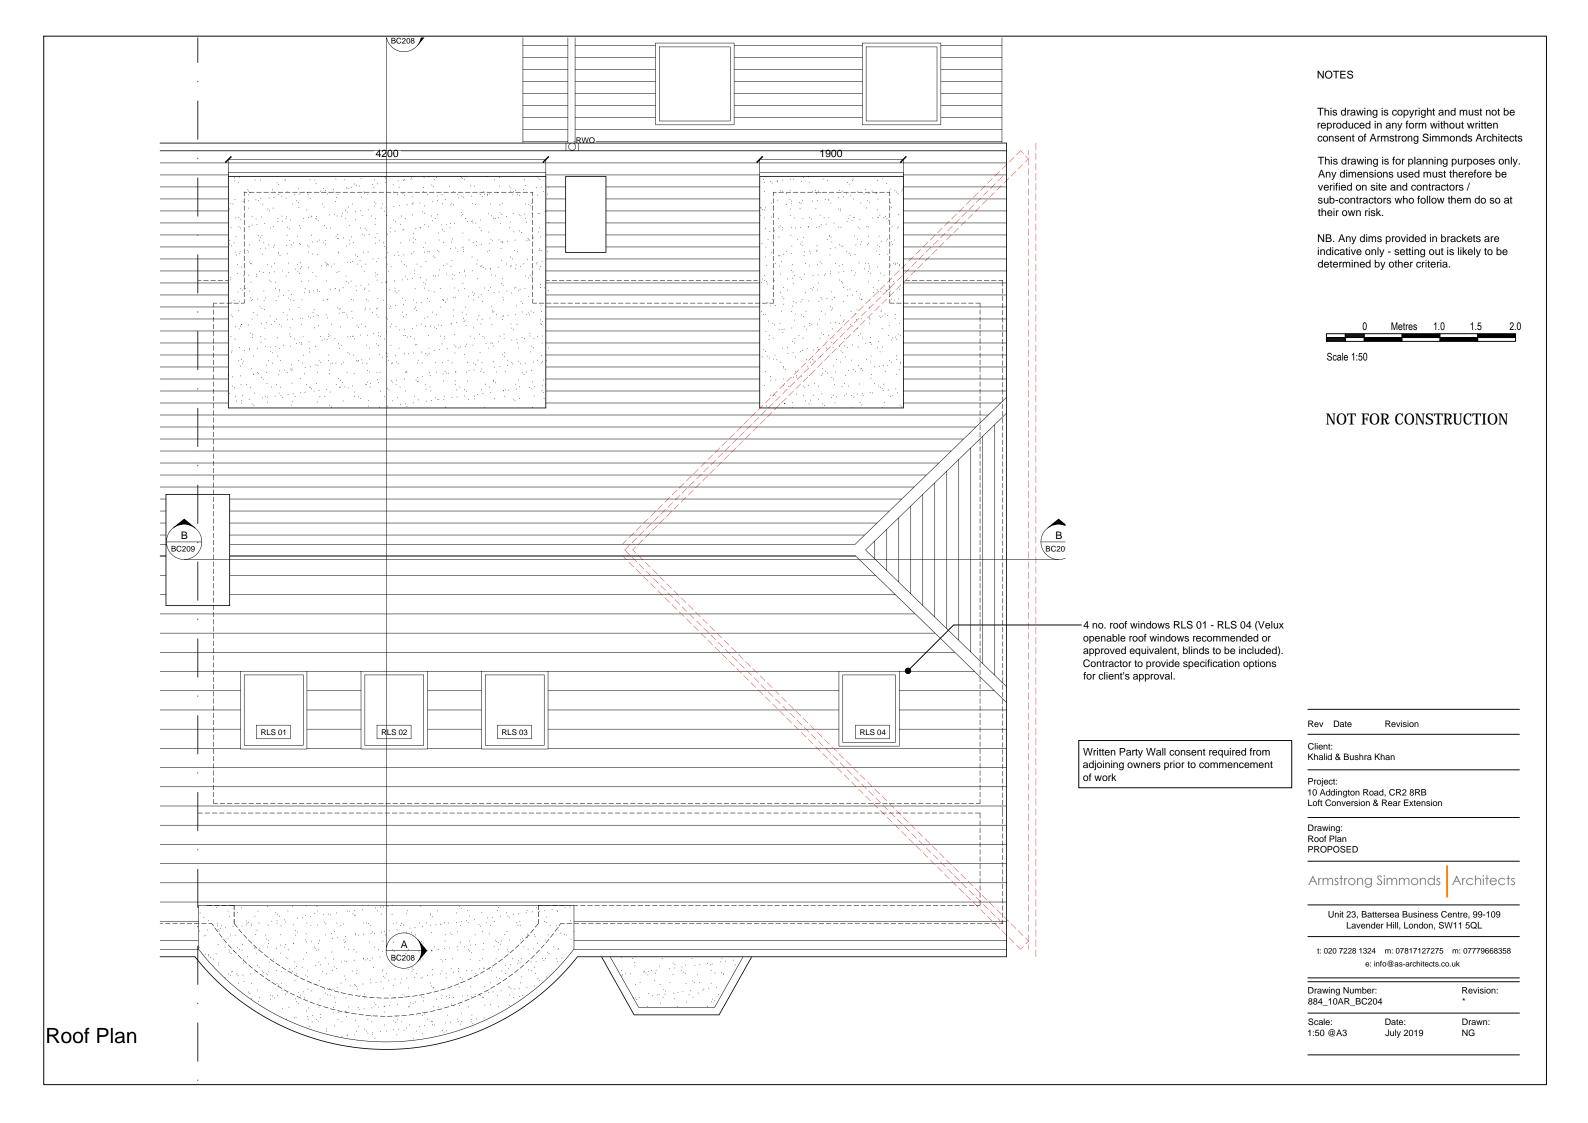

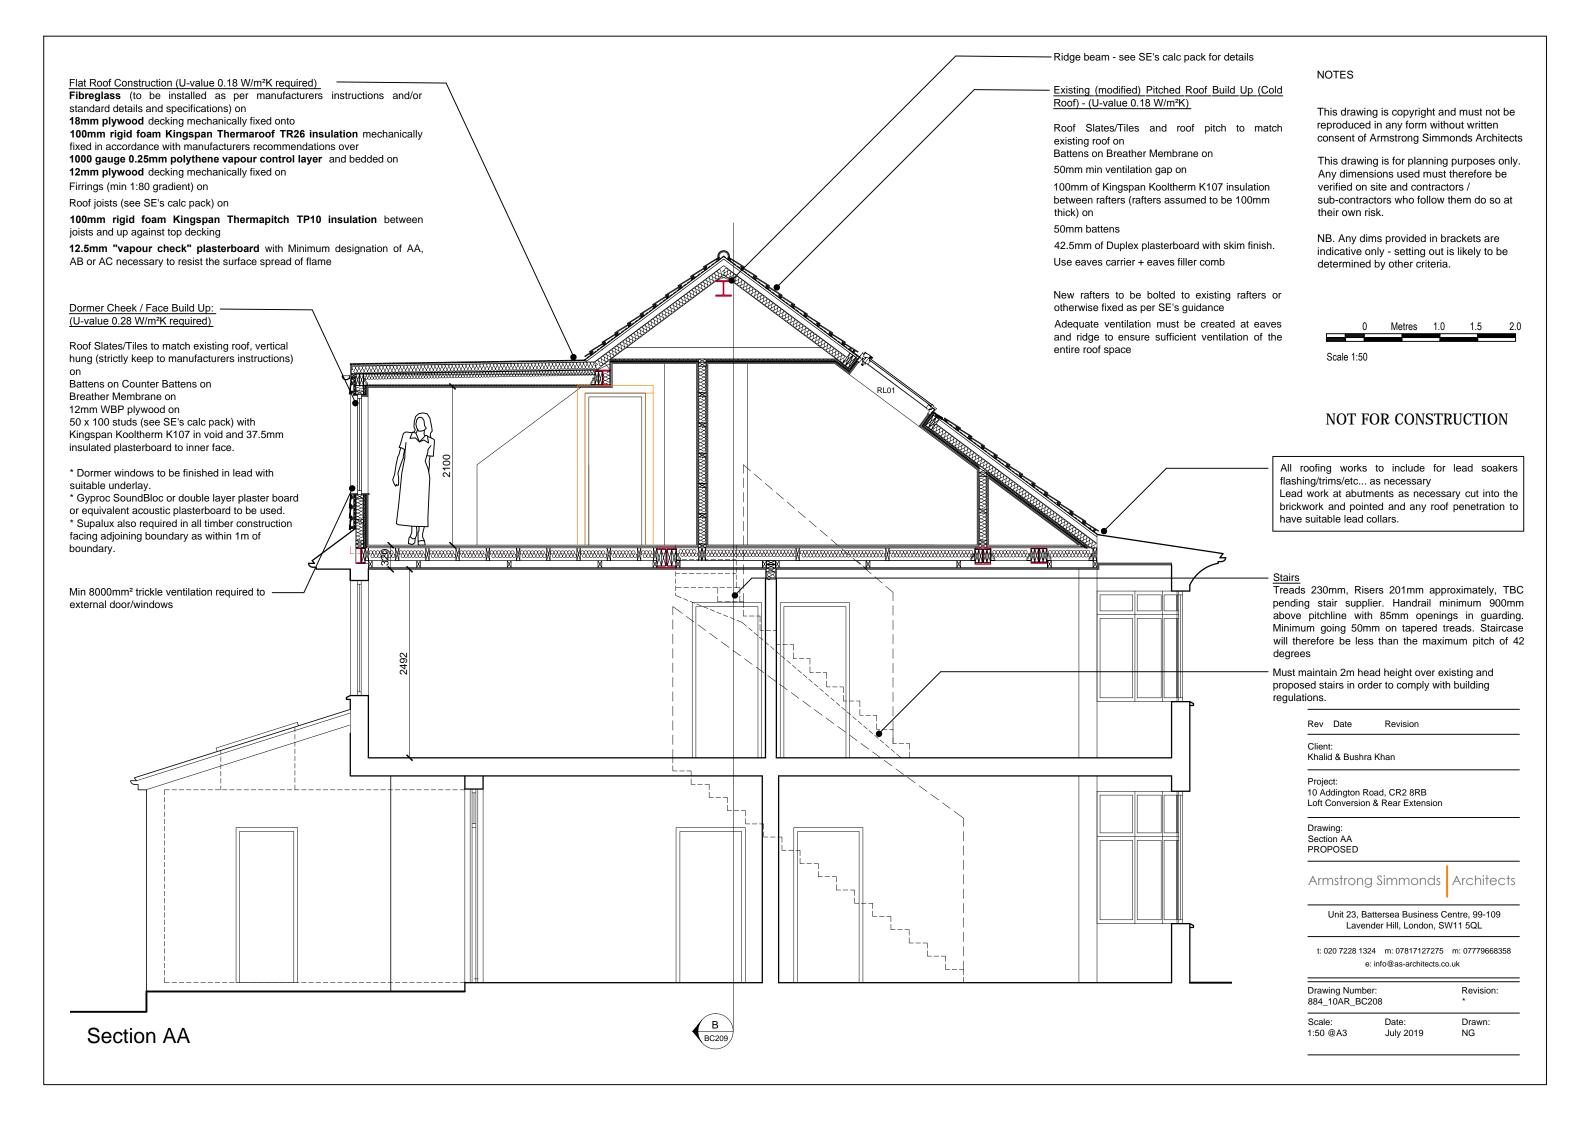

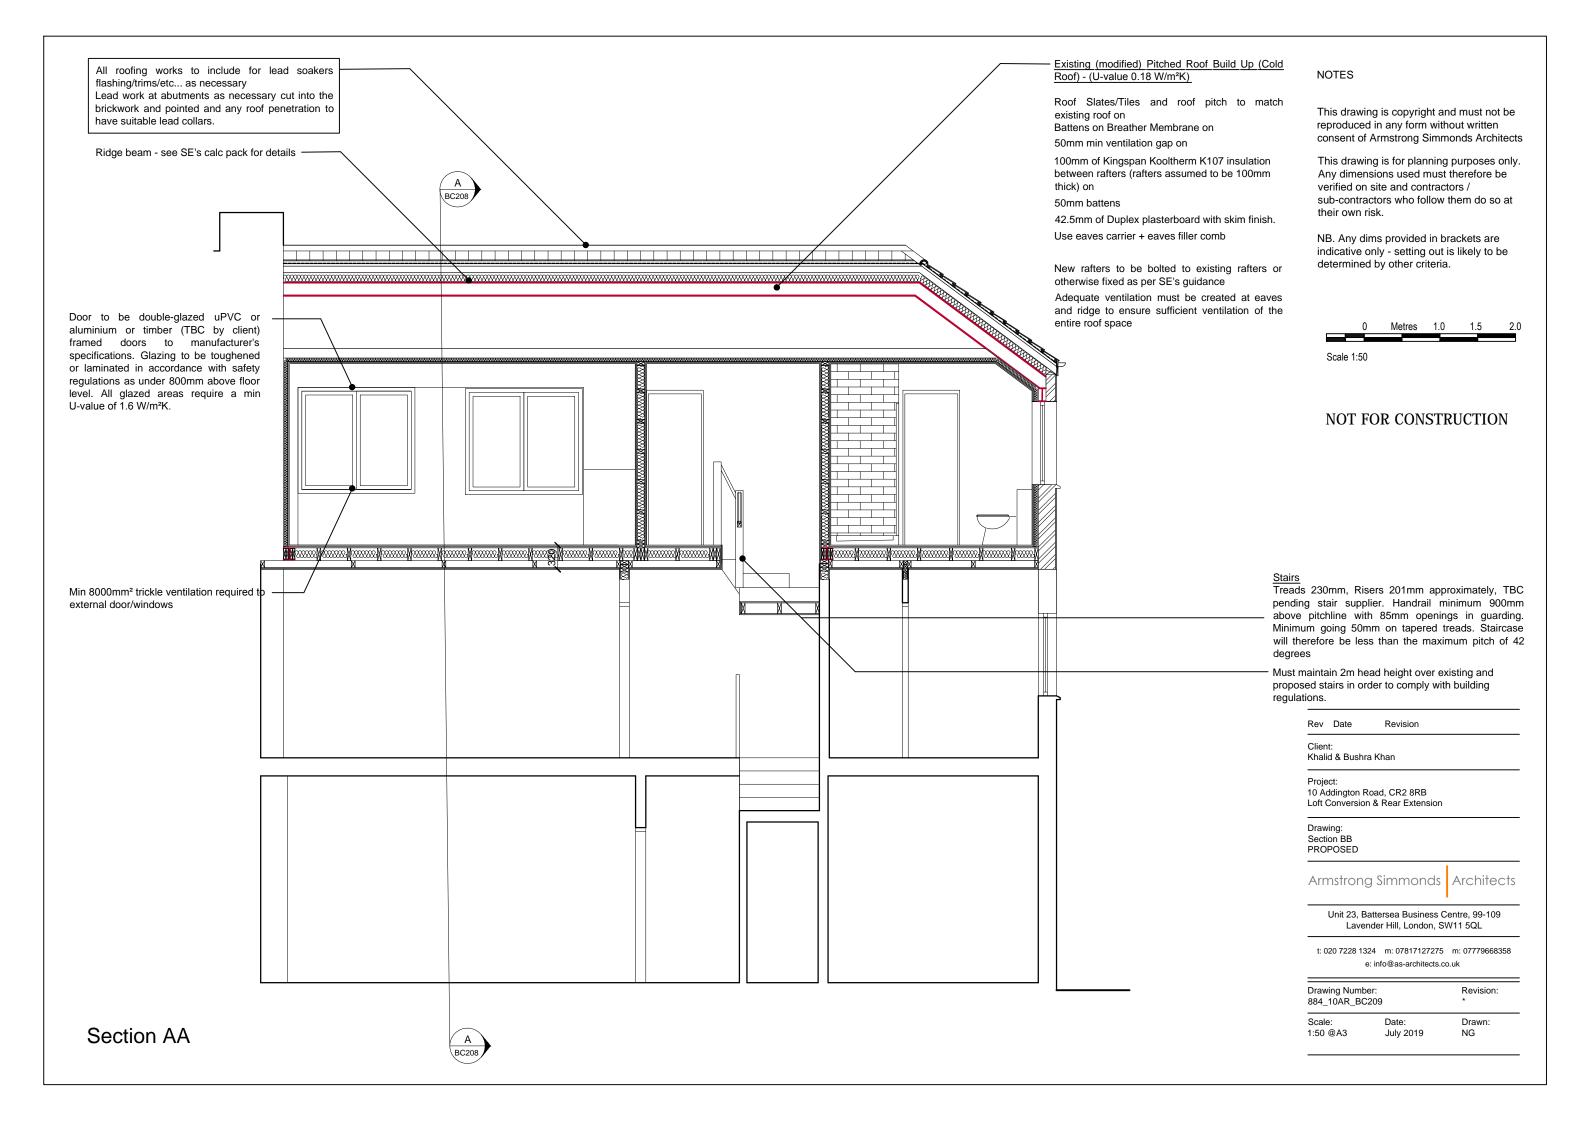

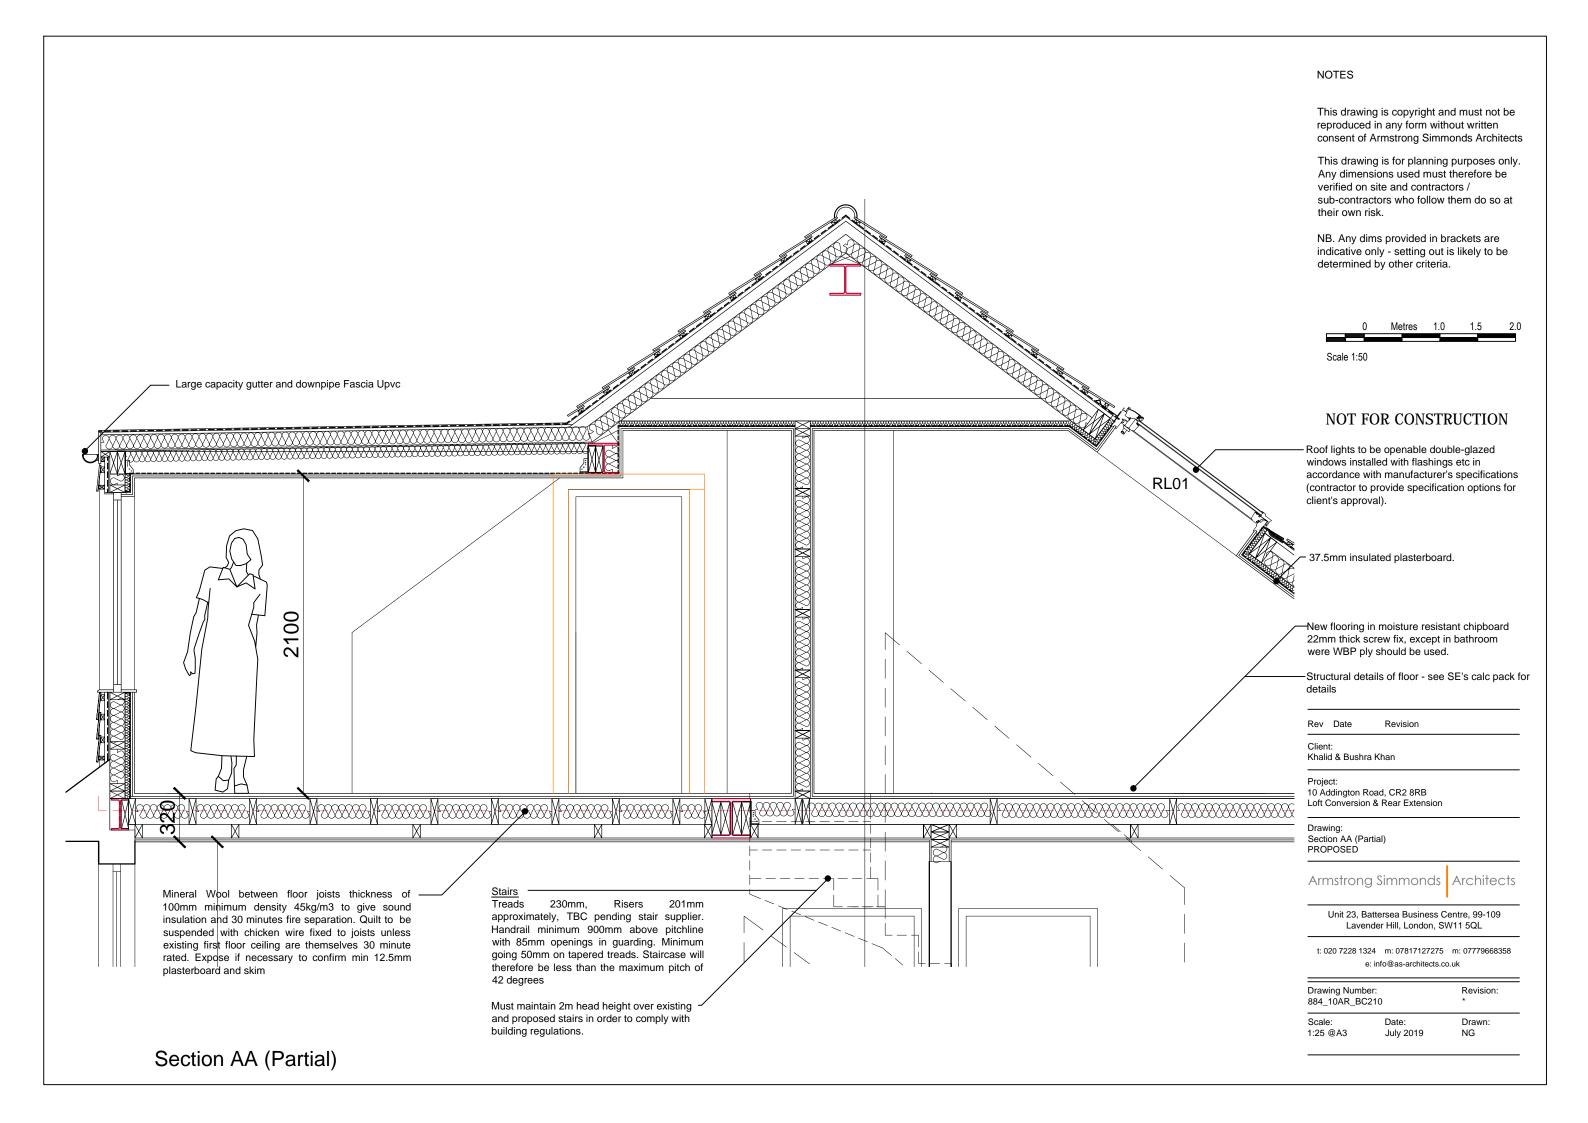

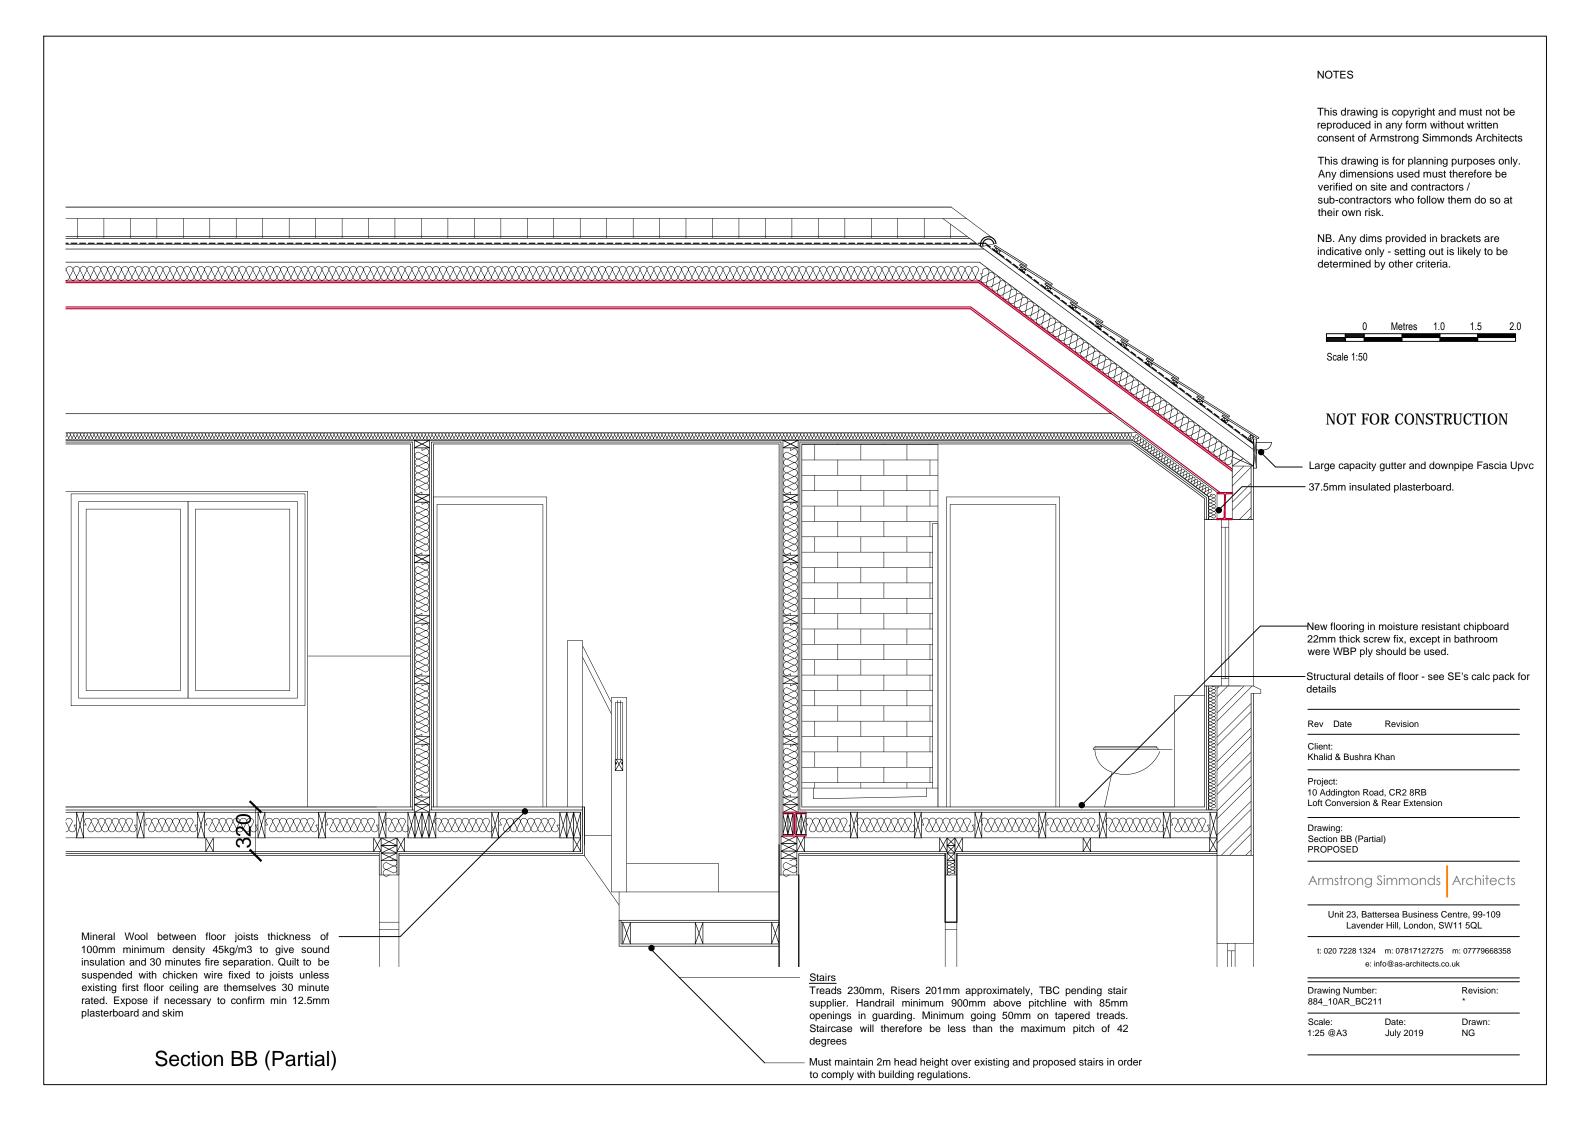

NOTES RELATING TO LOFT CONVERSIONS/ ROOF WORKS

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Contractors and sub-contractors must check all dimensions on site before fabrication

All dimensions given to unfinished structural surfaces

Where applicable, extension works are subject to party wall legislation and must not be carried out without written consent of the adjoining owner

BUILDING CONTROL NOTES

(to be be read in conjunction with additional annotations on drawings).

Part A - Structure

Please refer to Structural Engineer's calc pack for all structural design, sizing and calculations. All drawings to be read in conjunction with SE's calc pack.

Part B - Fire safety

Mains operated smoke alarms to BS 5446 - 1: 2000 to an L3 standard

Smoke detectors to BS5839-6: 2004 sited in accordance with BS 5839-1: 2002 to an L2 standard

Where a fire detection system is installed, an installation and commissioning certificate should be provided. Please note that the builder/installer should provide information to the occupants on the use of the equipment and its maintenance. BS 5839-1 and BS 5839-6 recommend that occupiers should recieve the manufacturer's instructions concerning the operation and maintenance of the alarm system.

An escape route must be provided between the converted loft and ground floor exit. This is to be ensured through the provision of fire doors (minimum E20) to all habitable rooms on ALL floors, creating a protected staircase.

The new storey should be separated from the rest of the house by fire resisting construction of at least 30 minutes, running from eaves to eaves.

Part C - Site prep and moisture

Foil backed plasterboard / VCL to be installed to internal face of all proposed external walls & ceilings.

Part E - Sound

Part F - Ventilation

For existing front roof slopes contractor to ensure adequate ventilation is afforded to new roofs at eaves, and ridges. Ventilation openings to have opening areas at least equal to a continuous strip 25mm wide at eaves and 5mm at ridge. 50mm void required for full length of

8,000mm² background ventilation is required to new habitable rooms and 4,000mm² to new bathrooms. Where possible, trickle vents to all external windows and doors to provide these required air exchange rates.

Ventilation systems should be installed & commissioned in accordance with the guidance given in the 2010 edition of the Domestic Ventilation Compliance Guide. Sufficient information about the ventilation system should be given to the building owner upon completion of the building work, so that the ventilation system can be operated to provide adequate air flow.

Part G - Sanitation

Part H - Drainage and waste disposal

All new drainage and sanitary pipework, including layout, materials, bedding/surround etc. must be discussed and approved on site by a BCO prior to installation. Air and running tests will be required on completion of works.

All existing unwanted drains to be properly decommissioned to prevent entry of vermin

Part K - Protection from falling, collision, and impact

When employed, Juliette balcony guarding must be provided at a minimum height of 1100mm. Balconies and stair balustrades to be constructed so that a 100mm sphere cannot pass through any openings in the guarding. No horizontal ballastrading acceptable. Guarding must be able to withstand a minimum horizontal design force of 0.74kN/m.

Part L1A - Conservation of fuel and power

All new & replacement windows will need to achieve a minimum 'U' value of 1.6W/m2K or WER Band C and 1.8 W/m³K for all new doors

Low energy lighting must be provided to 3 out of 4 fixed light fittings, in the areas affected by the building work (cupboards and wardrobes etc are excluded). Low energy fittings should have lamps with a luminous efficacy greater than 45 lumens per circuit-Watt and a total output greater than 400 lamp lumens. More information can be found in the Domestic Building Services Compliance Guide 2010.

The U value for the existing (front) roof slope should not exceed 0.20 W/m2K

In the event of existing gable walls in semi-detached / end of terrace properties, if the U value of the existing gable walls is 0.70 W/m²K or worse it should be upgraded to achieve a minimum 0.55 W/m²K for a cavity wall and 0.30 for all other walls.

Part M - Access and Use

A minimum 2m headroom must be provided over new staircases. Assuming goings are between 223-300mm, risers must not be higher than 200mm. Overall pitch of new staircase must not be steeper than 42°. Handrail minimum 900mm above pitchline (see also Park K section for balustrade design)

Part N - Glazing

Bi-fold doors, windows, roof lights and kitchen to supplier's details. Glazing to be toughened or laminated in accordance with safety regulations where installed <800mm above floor level.

Part P - Electrical

Electrical work must be carried out / certified by a competent person and a Part P certificate provided as a minimum. Ideally work to be carried out / certified by NICEIC approved electrician

SYMBOLS KEY				NOTES
	Mechanical extract	♦ ss	Stub stack	This drawing is copyright and must not be reproduced in any form without written consent of Armstrong Simmonds Architects
HD	Heat detector	⊕ SVP	Soil Vent pipe	This drawing is for planning purposes only. Any dimensions used must therefore be
SD	Smoke detector	+ RWP	Rainwater pipe	verified on site and contractors / sub-contractors who follow them do so at their own risk.
EL	Emergency light	⊕ WP	Waste pipe	NB. Any dims provided in brackets are indicative only - setting out is likely to be determined by other criteria.
D E	Shaver socket	IC		
-	Single socket	DW	Inspection chamber Dishwasher	
-	Double socket (low level)	WM	Washing Machine	
)	Double socket (high level)	TD	Tumble dryer (Condenser should b	e plumbed to
• 	TV /internet/phone sockets	DF 01 E20	drainage, vented should have extra First Floor Level Fire Door	act to outside air).
•2	2 way light switch (DG 01 E30 S	(20 Mins fire rated) Ground Floor Level Fire Door (30 Mins fire rated with smoke-sea	1)
● //	Pull cord switch	8	Boiler	
D	Dimable light switch			
		AWING KEY		
	Recessed spot light		Reflected ceiling line	
	Pendant (hanging) — —		-	Rev Date Revision
	Wall mounted light — -		above / below	Khalid & Bushra Khan Project:
 			above/below Plot boundary line	10 Addington Road, CR2 8RB Loft Conversion & Rear Extension
	Under Counter spotlights		:	Drawing: Section AA (Partial) PROPOSED
	Table lights			Armstrong Simmonds Architects
	Low level external lights		Foundations Line -	Unit 23, Battersea Business Centre, 99-109 Lavender Hill, London, SW11 5QL t: 020 7228 1324 m: 07817127275 m: 07779668358
• • • • •	- 0	TR	Towel Radiator	e: info@as-architects.co.uk
	LED strip lighting Drainage run	R	! !	Drawing Number: Revision: 884_10AR_BC212 * Scale: Date: Drawn:

Radiator

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July 2019

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