


ELECTRICAL LEGEND

SYMBOL	DESCRIPTION
	2x4 RECESSED FLUORESCENT LIGHT FIXTURE SEE LIGHT FIXTURE SCHEDULE
	NIGHT LIGHT FIXTURE, CONTINUOUSLY ENERGIZED
	1x8 RECESSED FLUORESCENT LIGHT FIXTURE SEE LIGHT FIXTURE SCHEDULE
	RECESSED INCANDESCENT DOWN LIGHT FIXTURE SEE LIGHT FIXTURE SCHEDULE
	PENDANT MOUNTED INCANDESCENT DOWN LIGHT FIXTURE SEE LIGHT FIXTURE SCHEDULE
	RECESSED AND ADJUSTABLE METAL HALIDE DOWN LIGHT FIXTURE-SEE LIGHT FIXTURE SCHEDULE
	EMERGENCY EGRESS LIGHT FIXTURE SEE LIGHT FIXTURE SCHEDULE
	UNIVERSAL EXIT LIGHT FIXTURE WITH BATTERY BACK-UP-SEE LIGHT FIXTURE SCHEDULE
	SMOKE DETECTOR (120VAC)
	18" TELEPHONE/DATA CONNECTION-MT 18" AFF
	48" TELEPHONE/DATA CONNECTION-MT 48" AFF
	EXHAUST FAN
	DUPLEX RECEPTACLE-MT 18" AFF-20A,125VAC
	20A,208V RECEPTACLE
	GFI RECEPTACLE-MT 18" AFF CIRCUIT, 20A,125VAC
	RECEPTACLE ON ISOLATED GROUND
	SINGLE POLE-120/277V-MT 48" AFF (INTERMATIC#FF12HC)
	INTERMATIC#FF312H, AUTO SHUT-OFF, THREE WAY 12 HR, 20A, 120/277V, SPRING WOUND TIMER/SWITCH, MT 48" AFF
	FOUR WAY SWITCH-MT 48" AFF
	ELECTRICAL SERVICE
	600W, 120V INCANDESCENT DIMMER
	1000W, 120V INCANDESCENT DIMMER
	OCCUPANCY LIGHT/MOTION SENSOR (MFGR-P&S#WSP200-W),120/277V
	INTERMATIC #K4121 1800W,120V PHOTOCCELL
	MOTOR
	18" TELEPHONE OUTLET CONNECTION-MT 18" AFF UNLESS NOTED OTHERWISE
	18" MODEM OUTLET CONNECTION-MT 18" AFF UNLESS NOTED OTHERWISE
	COMBINATION OUTLET: MODEM, COMPUTER/DATA & TELEPHONE OUTLET CONNECTION-MT 18" AFF UNLESS NOTED OTHERWISE
	18" COMPUTER/DATA OUTLET CONNECTION-MT 18" AFF UNLESS NOTED OTHERWISE
	18" CABLE TV OUTLET-MT 18" AFF UNLESS NOTED OTHERWISE

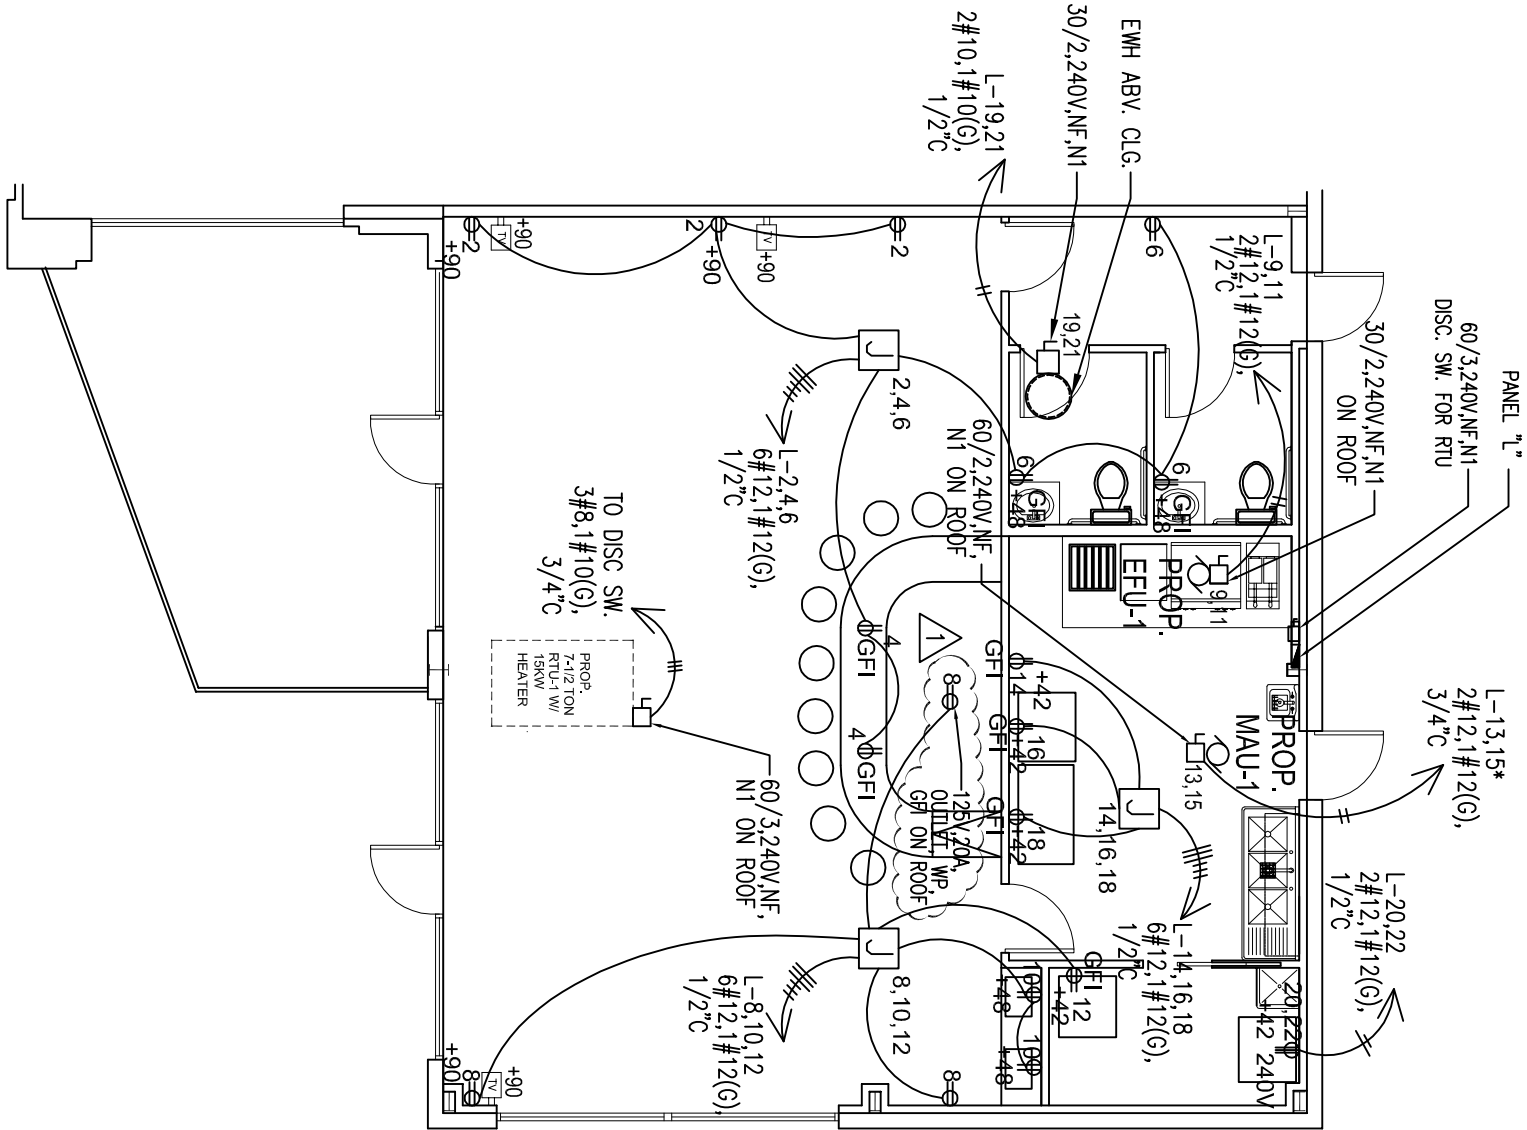

*HOOD EQUIPMENT FIRE EXTINGUISHING SYSTEM MUST BE INTERCONNECTED TO THE SHUNT TRIP BREAKERS FOR MAKE-UP AIR UNIT SO THAT THE CURRENT IS AUTOMATICALLY SHUT-DOWN WHEN THE SYSTEM IS ACTIVATED AS PER HMC SECTION 510.2.4.2

REVISION
1. 06/18/10 COH COMMENT



ELECTRICAL PLAN FOR A PROPOSED
BUILD-OUT "LA BOTANA REGIA"
LOCATED AT
7610 KEMPWOOD, STE A
HOUSTON TX 77055

02/25/10	DATE
M.A.	CHECK BY
M.A.	DRAWN BY
1/4"=1'-0"	SCALE
----	PRO. NO.

SHEET:
E1.2

ELECTRICAL POWER PLAN

1/4"=1'-0"