# **General Notes**

- All drawings to be read in conjunction with all relevant specifications, architect's drawings and services engineer's drawings.
- 2. For setting out refer to architect's drawings
- 3. All dimensions are in millimetres unless noted otherwise.
- Do not scale from the drawings or the computer digital data. Only figured dimensions to be used.
- The contractor is to provide any temporary bracing necessary to maintain structural stability during construction.
- 6. The works have been designed and shall be constructed in accordance with the following codes. This list is not exhaustive and is only intended to list the principal codes:
- a) BS EN 1991-1-1:2002, BS EN 1991-1-7:2006: Code of practice for dead and imposed loads.
- b) BS EN 1991-1-4:2005+A1:2010: Code of practice for wind loads.
- c) BS EN 1991-1-3:2003: Code of practice for imposed roof loads.
- d) BS EN 1997-1:2004: Code of practice for foundations.
- e) BS EN 1992-1-1:2004: Structural use of concrete.
- f) BS EN 1993-1-1:2005, BS EN 1993-1-5:2006, BS EN 1993-1-10:2005, BS EN 1993-5:2007, BS EN 1993-6:2007, BS EN 1993-1-8:2005: Structural use of steelwork in buildings.
- g) PD 6697:2010, BS EN 1996-3:2006, BS EN 1996-2:2006, BS EN 1996-1-1:2005+A1:2012: Structural use of un-reinforced masonry.
- h) BS EN 1995-1-1:2004+A1:2008: Structural use of timber.
- 7. The works have been designed for the finish state. The following superimposed loads have been used in the design: Floor loads - See structural engineer's calculations.
  - Roof loads See structural engineer's calculations.
- 8. All works shall comply with the Building Regulations and other relevant statutory notices e.g. Health and Safety Bylaws, COSHH etc
- 9. The client / appointed contractor must take their own assurances on:
- a) Soil conditions on site and the gradient of land;
- b) Suitability / existing methods of storm water drainage;
- c) Trees (existing or removed) and their affect on foundations;
- d) Position and condition of main sewer.
- 10. Extensions/alterations to existing structures are subject to revision depending upon such being fully exposed. The client/thier contractor must take their own assurances that any structure designated for demolition/removal are not load bearing or that alternative methods of permanent support are put in place prior to removal. Existing walls, lintels and foundations that are intended to take additional loads, must first be fully exposed and checked for adequacy prior to the commencement of works.

## Foundations

- The depth of the proposed foundations are subject to ground conditions and These are to be minimum 1000mm deep subject to be founding in good ground of minimum 100kN/m2 bearing stratum (based on London Clay).
- 2. The excavations should be free from any mature tree roots. If there are

- large trees in the vicinity then the foundations depth is to be in accordance with NHBC standards guidelines for building near trees.
- Where new foundations are to abut existing foundations, a soft joint of 75mm is to be formed using 'Claymaster' or similar approved unless noted otherwise on the drawings.
- 4. Any foundations deeper than 1.5m should have suspended floors to avoid any heave. Where the foundations are cast within highly shrinkable soils, then anti-heave precautions such as compressible materials or void formers are to be applied to the foundations.

#### Notes for Timber

- These notes are to be read in conjunction with relevant architect's and services engineer's drawings and specification.
- 2. All timber-work shall comply with BS EN 1995-1-1:2004+A1:2008.
- 3. Roof area
- a) Roof joists shall be grade C24. Evidence of grading shall be provided before work commences:
- b) Blocking and battens shall be grade C24 softwood;
- c) The sizes shown on the drawings are finished sizes;
- d) In joint zones wanes, shakes and knots are not permitted:
- e) Timber to be carefully cut and planed to ensure tight fit and continuous bearing against metalwork:
- f) All gaps between timber and metalwork to be resin-grouted, to the approval of the engineer.
- 4. All connectors, bolts, nails etc. shall be galvanised to BS 729.
- 5. Adhesive shall be to BS1204: Part 1: 1970, Type WBP.
- All timber to be treated in accordance with the British Wood Preservative and Damp-proofing Association Commodity Specification C8 for 40 years desired service life.

# Notes for Fire Resistance

- These notes are to be read in conjunction with relevant architect's services engineer's drawings and specifications.
- All habitable doors to stairs enclosure and the kitchen to be filled with self-closing devices.
- Any glazing within the stair enclosure, including glazing to doors, to be fire-resisting.
- Mains powered interconnected smoke alarms to be provided to entrance lobby and all stairs landings.
- 5. Class 1 flame spread to be provided to all new walls and ceilings.

#### Notes for Masonry

- These notes are to be read in conjunction with relevant architect's services engineer's drawings and specifications.
- 2. All brickwork shall comply with PD 6697:2010, BS EN 1996-3:2006, BS EN 1996-2:2006, BS EN 1996-1-1:2005+A1:2012 .
- 3. All bricks shall have a minimum crushing strength of 20N/mm $^{2}$ .

- 4. Blockwork shall have a minimum crushing strength of 7N/mm<sup>2</sup>.
- Mortar shall be a Class (ii) cement: lime putty: sand mix (1:1/2:4), unless indicated otherwise
- All vertical joints shall be completely filled. Bricks shall be laid frog up. The voids in perforated bricks shall be filled.
- 7. Fissured bricks or bricks with voids shall not be used.
- Horizontal chases are prohibited. Vertical chases and builderswork holes shall be agreed with the architect.

#### Notes for Structural Steelwork


- These notes are to be read in conjunction with relevant architect's and services engineer's drawings and specifications.
- All steelwork shall comply with BS EN 1993-1-1:2005, BS EN 1993-1-5:2006, BS EN 1993-1-10:2005, BS EN 1993-5:2007, BS EN 1993-6:2007, BS EN 1993-1-8:2005.
- Unless noted otherwise stipulated structural steelwork shall confirm to BS EN: Weldable structural steels.
- 4. Unless noted otherwise all steel shall be grade S355. Steel grade shall conform with EC-3.
- 5. Unless noted otherwise all butt welds shall be full penetration.
- Unless noted otherwise all fillet welds shall be full profile with a minimum leg length of 6mm.
- 7. Unless noted otherwise all ordinary bolt assemblies shall be Grade 8.8.
- 8. Unless noted otherwise all bolts shall be M16.
- 9. Unless noted otherwise all holding down bolts shall be M16 Grade 8.8 anchored a minimum of 200mm depth into the supporting concrete with a 100 x 100 x 8 thick washer plate at the embedded head of the bolt.
- 10. The clearance of base plates from supporting concrete shall be a minimum of 20mm and on completion of erection this shall be grouted solid under the full area of the base plate with 1:2 sand: cement grout.
- 11. Corrosion protection:
- a) Surface protection blast clean to SA 2.5 quality BS EN ISO 8501-1.
- b) Prefabricator primer epoxy zinc phosphate hb: 50 microns (DFT).
- c) Finishing coat see arch's spec.
- d) See arch's specification for details on colour and texture.
- 12. Fire protection:
  - 30min One layer of plasterboard and skim coat or intumescent paint to manufacturer's specification.
- 60min Two layers of plasterboard with joints staggered and skim coat or intumescent paint to manufacturer's specification.
- 13. Weather protection: Any steelwork exposed to external weather is either to be galvanized or stainless steel UNO.
- 14. All steel beams carrying load-bearing masonry walls wider than their flanges are to have 12mm thick top/bottom flange plates continuously welded along the length to suit the wall width UNO.

NOTE:	Client Name	Section	Drawing Title
- DRAWINGS NOT TO BE SCALED FOR CONSTRUCTION.		NEW BUILD	GENERAL NOTES
- CONTRACTOR TO CHECK ALL DIMENSIONS BEFORE ORDERING ANY STEEL WORK.		Stage	Drawing Status
- ALL MATERIALS AND WORKMANSHIP MUST FULLY COMPLY WITH ALL CURRENT BRITISH STANDARDS AND CODES OF PRACTICE.		ARCHITECTURAL PLANNING	For Planning Approval



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02 TOWERFIELDS WESTERHAM ROAD BROMLEY, BR2 6HF

LEGEND	Project No.	H - 001
	Drawing No.	2/5
PROPOSED	Revision	-
	Scale at A3	1:100
Designed MM	Date	23/7/2024
Drawn MM		

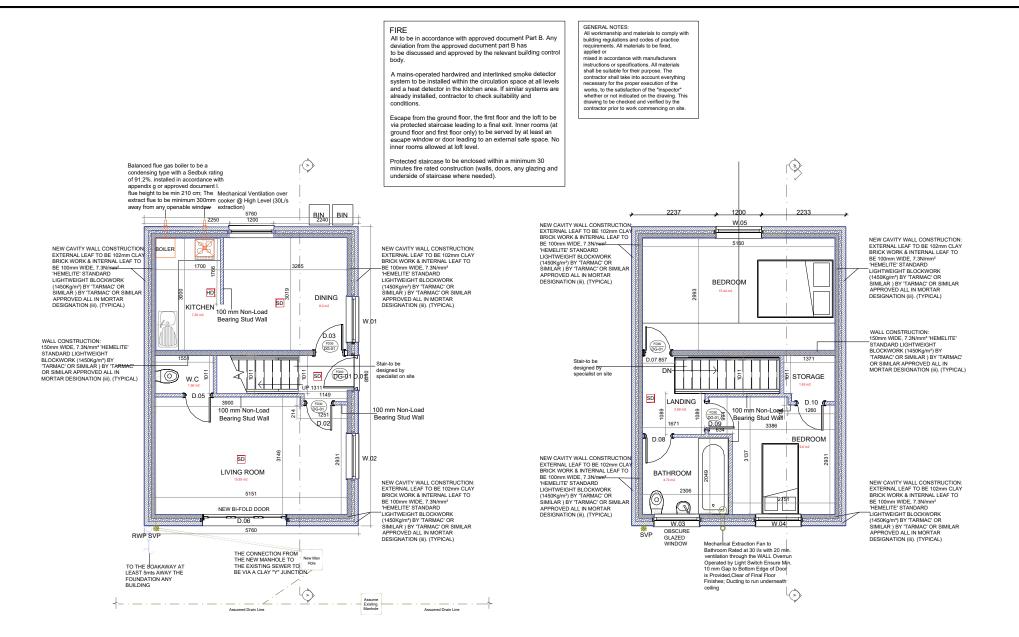

781/1000 [No Slope]

Dimension of the beam to be taken on site for fabrication

Proposed 100mm SVP

Emergency Lighting in accordance with BS 5266

Smoke Detector

Heat Detector

Heat Detector

Internally Illuminated Fire Escape Sign (BS 5266)

30min Fire Resistance Door (All Fire Doors to have intumescent strips and self closers)

Exit—

Exit—

Exit—

Exit Escape Directions - Route for escape (measured distances for fire service to gain access to outdoor assembly to comply with B1

Fire escape signs - directions shown on signs to be provided and located in a visible place in accordance with BS5499

01 Proposed Ground Floor

STANDARDS AND CODES OF PRACTICE.

02 Proposed First Floor 1:100

03 Proposed Roof Plan
1:100

10

**SCALE: 1:100** 



#### NOTES

- This drawing is to be read in conjunction with all relevant contract documentation from the design team, with any conflicting information to be brought to the attention in writing before commencing on site.
- $\label{eq:continuous} \textbf{2. All materials to match existing unless specified in drawing.}$
- The contractor is to check and verify all levels and dimensions before construction. Any discrepancies are to be in writing before commencing on site.
- 4. All dimensions in mm, unless otherwise stated
- 5. All proprietary products shall be installed in accordance with manufacturers written instructions.

NOTE:	Client Name	Section	Drawing Title
- DRAWINGS NOT TO BE SCALED FOR CONSTRUCTION.		NEW BUILD	PROPOSED FLOOR PLANS
- CONTRACTOR TO CHECK ALL DIMENSIONS BEFORE ORDERING ANY STEEL WORK.		Stage	Drawing Status
- ALL MATERIALS AND WORKMANSHIP MUST FULLY COMPLY WITH ALL CURRENT BRITISH		ARCHITECTURAL PLANNING	For Planning Approval



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12345

LEGEND	Project No.	H - 002
	Drawing No.	2/5
PROPOSED	Revision	-
	Scale at A3	1:100
Designed MM	Date	23/7/2024
Drawn MM		





#### NOTES

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**SCALE: 1:100** 

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NOTE:	Client Name	Section	Drawing Title
- DRAWINGS NOT TO BE SCALED FOR CONSTRUCTION.		NEW BUILD	PROPOSED ELEVATIONS
- CONTRACTOR TO CHECK ALL DIMENSIONS BEFORE ORDERING ANY STEEL WORK.		Stage	Drawing Status
- ALL MATERIALS AND WORKMANSHIP MUST FULLY COMPLY WITH ALL CURRENT BRITISH STANDARDS AND CODES OF PRACTICE.		ARCHITECTURAL PLANNING	For Planning Approval




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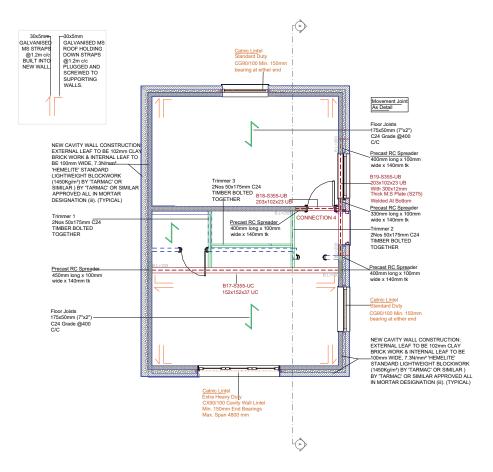
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LEGEND	Project No.	H - 003
	Drawing No.	2/5
PROPOSED	Revision	-
	Scale at A3	1:100
Designed MM	Date	23/7/2024
Drawn MM		

Dimension of the beam to be taken on site for fabrication



Ground Floor Foundation Plan 1:100

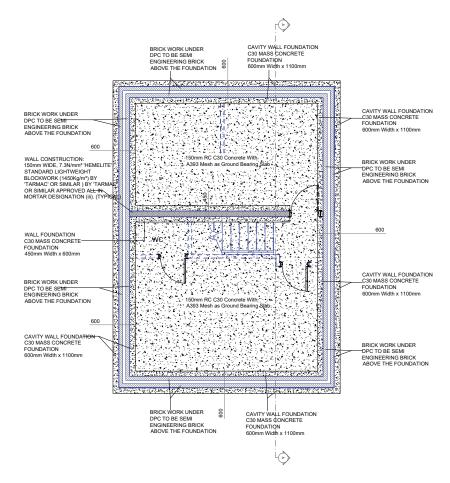

02 Ground Floor Structural Plan 1:100

0 12345



### NOTES:

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**SCALE: 1:100** 

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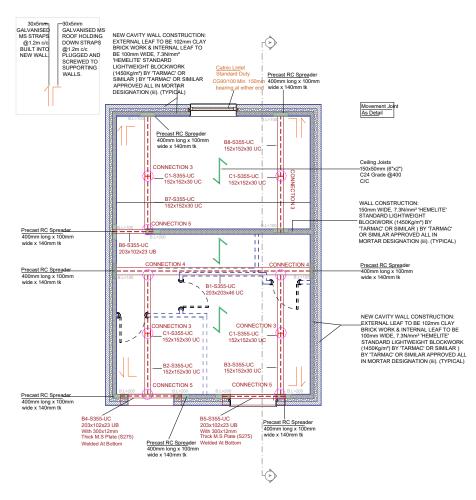
	Client Name	Castian	Drawing Title
NOTE:	Ctient Name	Section	Drawing ritte
- DRAWINGS NOT TO BE SCALED FOR CONSTRUCTION.		NEW BUILD	STRUCTURAL PLANS
- CONTRACTOR TO CHECK ALL DIMENSIONS BEFORE ORDERING ANY STEEL WORK.		Stage	Drawing Status
- ALL MATERIALS AND WORKMANSHIP MUST FULLY COMPLY WITH ALL CURRENT BRITISH STANDARDS AND CODES OF PRACTICE.		ARCHITECTURAL PLANNING	For Planning Approval




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LEGEND		Project No.	H - 004
PROPOSED		Drawing No.	2/5
		Revision	-
		Scale at A3	1:100
Designed	MM	Date	23/7/2024
Drawn	MM		

Dimension of the beam to be taken on site for fabrication



01 First Floor Structural Plan 1: 100

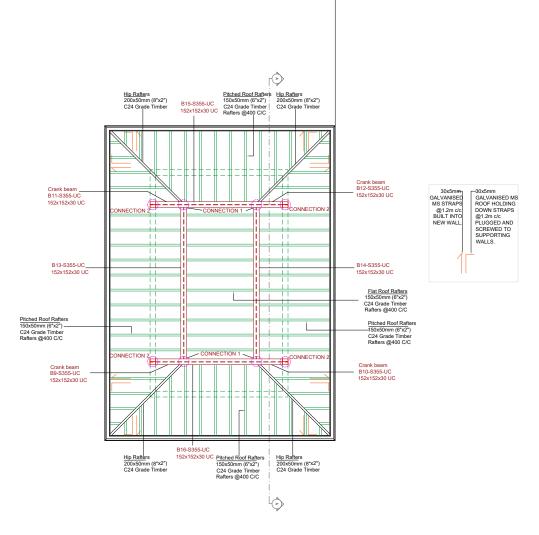

02 Structural Roof Plan 1:100

12345



### NOTES:

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**SCALE: 1:100** 

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- 3. The contractor is to check and verify all levels and dimensions before construction. Any discrepancies are to be in writing before commencing on site.
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- All proprietary products shall be installed in accordance with manufacturers written instructions.


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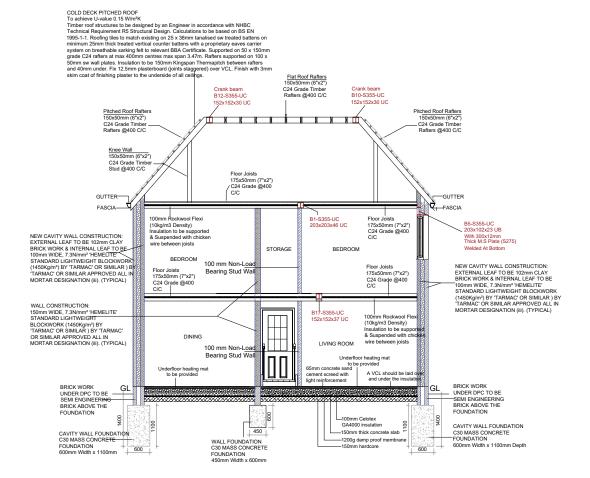
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LEGEND	Project No.	H - 005
	Drawing No.	2/5
PROPOSED	Revision	-
	Scale at A3	1:100
Designed MM	Date	23/7/2024
Drawn MM		


NOTE:	Client Name	Section	Drawing Title
- DRAWINGS NOT TO BE SCALED FOR CONSTRUCTION.		NEW BUILD	STRUCTURAL PLANS
- CONTRACTOR TO CHECK ALL DIMENSIONS BEFORE ORDERING ANY STEEL WORK.		Stage	Drawing Status
- ALL MATERIALS AND WORKMANSHIP MUST FULLY COMPLY WITH ALL CURRENT BRITISH STANDARDS AND CODES OF PRACTICE.		ARCHITECTURAL PLANNING	For Planning Approval


Dimension of the beam to be taken on site for fabrication



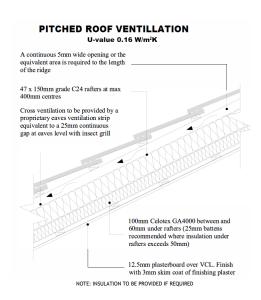

01 Structural Section A-A

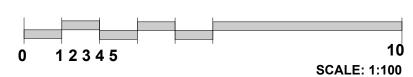

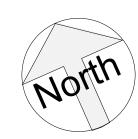

### NOTES:


- This drawing is to be read in conjunction with all relevant contract documentation from the design team, with any conflicting information to be brought to the attention in writing before commencing on site.
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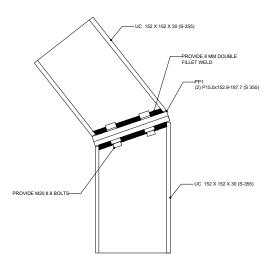
NOTE:	Client Name	Section	Drawing Title
- DRAWINGS NOT TO BE SCALED FOR CONSTRUCTION.		NEW BUILD	STRUCTURAL PLANS
- CONTRACTOR TO CHECK ALL DIMENSIONS BEFORE ORDERING ANY STEEL WORK.  - ALL MATERIALS AND WORKMANSHIP MUST FULLY COMPLY WITH ALL CURRENT BRITISH STANDARDS AND CODES OF PRACTICE.		Stage ARCHITECTURAL PLANNING	Drawing Status For Planning Approval




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LEGEND	Project No.	H - 006	
	Drawing No.	2/5	
PROPOSED	Revision	-	
	Scale at A3	1:100	
Designed MM	Date	23/7/2024	
Drawn MM			






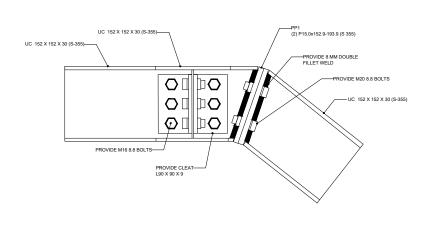


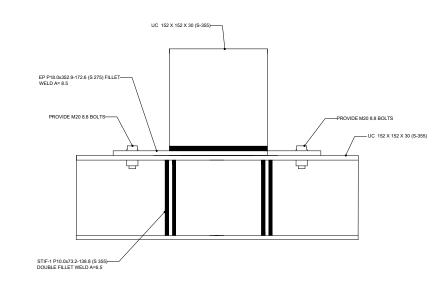






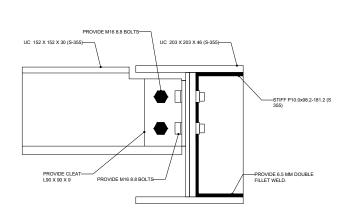

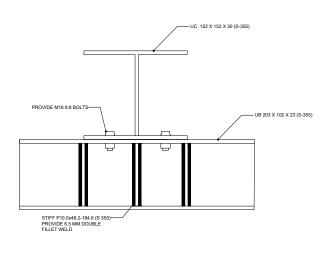

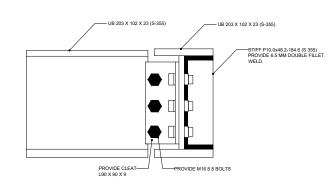

FOR CONNECTION **FABRICATION DETAIL SEE STRUCTURE** 

REPORT.

NOTE

CONNECTION-4

	NOTE:	Client Name	Section	Drawing Title
	- DRAWINGS NOT TO BE SCALED FOR CONSTRUCTION.		NEW BUILD	STRUCTURAL DETAILS
	- CONTRACTOR TO CHECK ALL DIMENSIONS BEFORE ORDERING ANY STEEL WORK.		Stage	Drawing Status
	- ALL MATERIALS AND WORKMANSHIP MUST FULLY COMPLY WITH ALL CURRENT BRITISH STANDARDS AND CODES OF PRACTICE.		ARCHITECTURAL PLANNING	For Planning Approval



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LEGEND	Project No.	H - 007
	Drawing No.	2/5
PROPOSE	D Revision	-
	Scale at A3	N/A
Designed MM	Date	23/7/2024
Drawn MM		