

**EXISTING GROUND & FIRST FLOOR PLAN,
COMPUTER BUILDING**

PROJECT:-

DIGITAL SURVEY OF COMPUTER BUILDING AT
INDIRA GANDHI DELHI TECHNICAL UNIVERSIT)
NEW DELHI - 110006.

CLIENT:-

EXECUTIVE ENGINEER, PWD
DIV. M - 321, VIKAS BHAWAN - II,
NEW DELHI - 110006.

DOOR & WINDOW SCHEDULE

| Name | Size | SLW. | LLW. |
|-----------------|-----------|------|------|
| D | 1,34x2,30 | - | 2,30 |
| D ₁ | 1,27x2,15 | - | 2,15 |
| D ₂ | 1,24x2,15 | - | 2,15 |
| D ₃ | 1,20x3,00 | - | 3,00 |
| D ₄ | 1,20x2,24 | - | 2,24 |
| D ₅ | 1,18x2,12 | - | 2,12 |
| D ₆ | 1,10x3,00 | - | 3,00 |
| D ₇ | 0,95x2,15 | - | 2,15 |
| D ₈ | 0,90x3,00 | - | 3,00 |
| D ₉ | 0,86x2,15 | - | 2,15 |
| D ₁₀ | 1,12x2,15 | - | 2,15 |
| D ₁₁ | 0,75x2,15 | - | 2,15 |
| W | 1,20x1,26 | 0,74 | 2,00 |
| W ₁ | 1,10x0,65 | 1,35 | 2,00 |
| W ₂ | 1,14x1,40 | 0,60 | 2,00 |
| W ₃ | 0,65x0,70 | 0,80 | 1,15 |
| W ₄ | 0,65x0,90 | 1,35 | 2,25 |
| W ₅ | 1,16x0,95 | 0,95 | 1,90 |

SURVEY BY: Kiran Verma&Deepika

SCALE : NTS

DATE: 24-04-2014

KIRAN VERMA

VIKRANT BHATIA

| | |
|----------|------------|
| DRAWN BY | CHECKED BY |
|----------|------------|

NOTE:-

1. All Dimensions are in meters.
2. North shown on the drawing is magnetic north.

Architects/Town Planners :

SYMMETRIX-THE DESIGN STUDIO

**LAND & QUANTITY SURVEYORS, ARCHITECTS, GOVT. REGD. VALLERS
CIVIL ENGINEERS & TOWN PLANNERS**
OFFICE :- 4-180, 1st FLOOR, PATEL MARKET, RAJOURI GARDEN,
NEW DELHI-110027.
PHONE NO:- 25757674, 4106480. MOB. NO:- 88-122-18889, 88-180-88715

AR. VIKRANT BHATT

**MASTERS IN HOUSING PLANNING(SPA,NEW DELHI),
MEMBER,INSTITUTE OF TOWN PLANNERS(INDIA)**


MEMBER, INDIAN BUILDING CONGRESS (INDIA)
MEMBER, INSTITUTION OF GOVT. APPROVED VALUERS

ER. RAJESH BHATTA


MEMBER, ROYAL INSTITUTE OF CHARTERED SURVEYORS (LONDON)

MEMBER INSITUATION OF SURVIVORS (INDIA)
GOVT. APPROVED VALUER INCOME-TAX DEPTT.

**FELLOW, INSTITUTE OF GOVT. APPROVED VALUERS
MEMBER, INDIAN COUNCIL OF ARBITRATION (INDIA)**

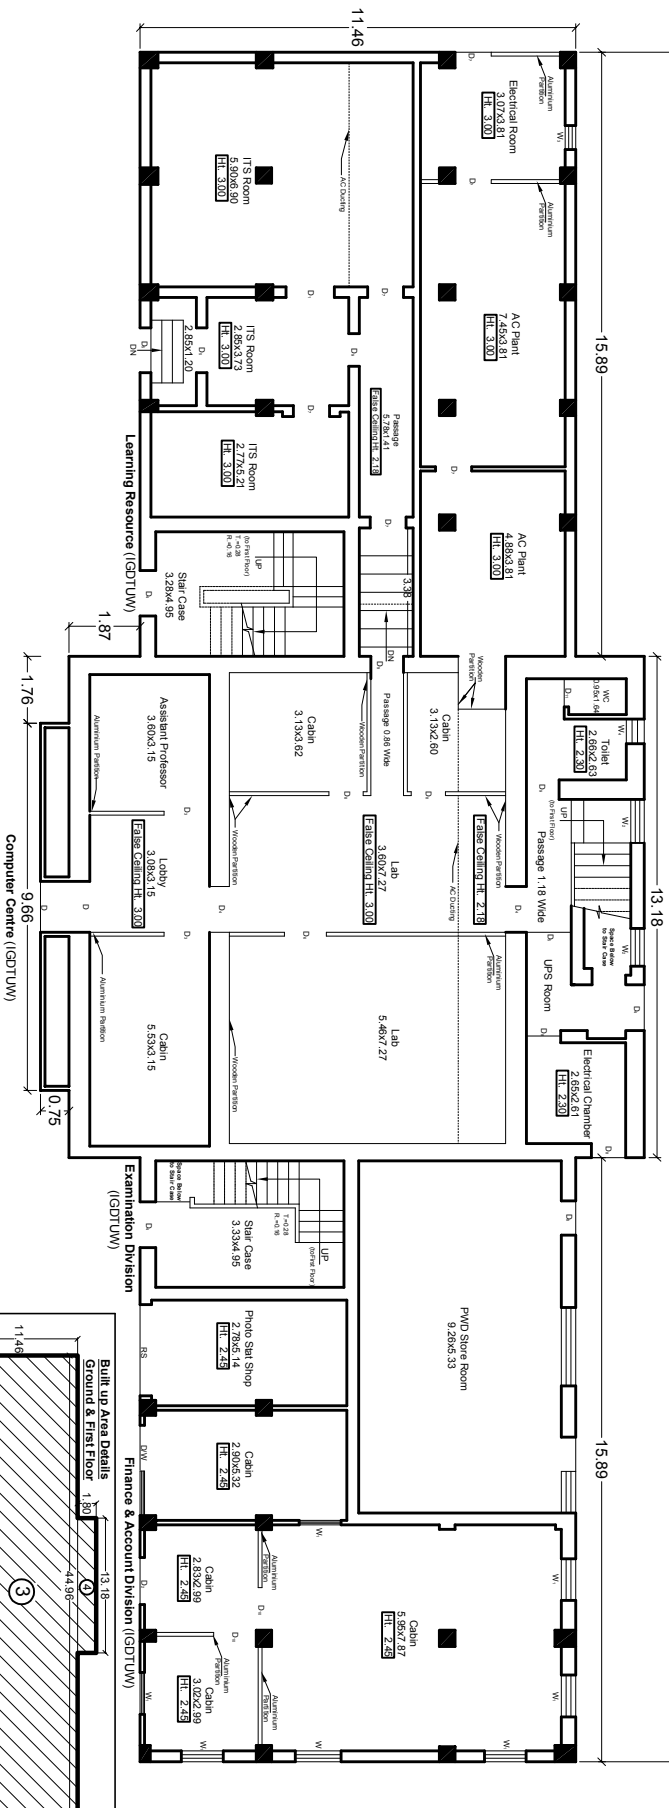

GROUND FLOOR PLAN, COMPUTER BUILDING

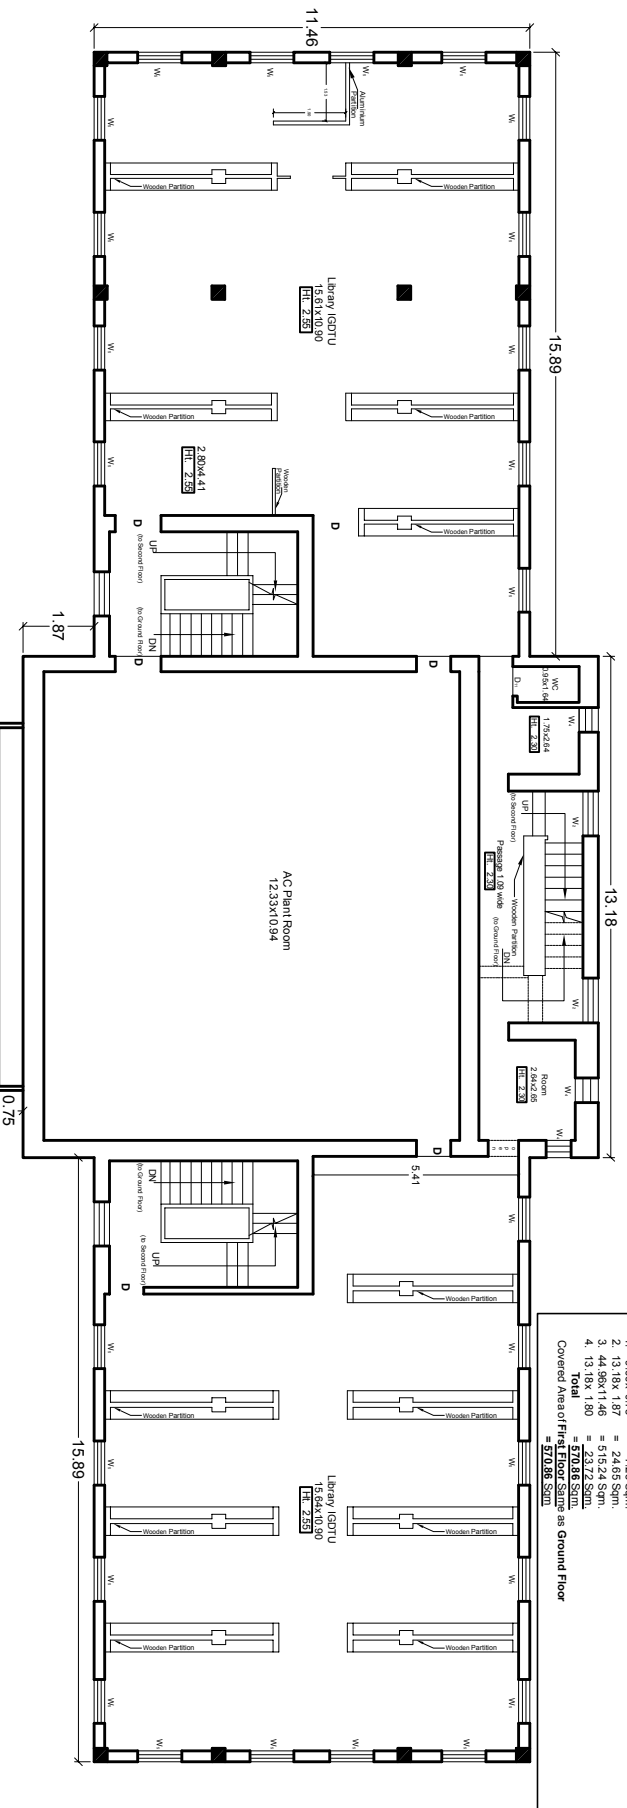

FIRST FLOOR PLAN, COMPUTER BUILDING