


2 ENLARGED MECHANICAL ROOM PLAN  
M1.11 SCALE: 1/4" = 1'-0"

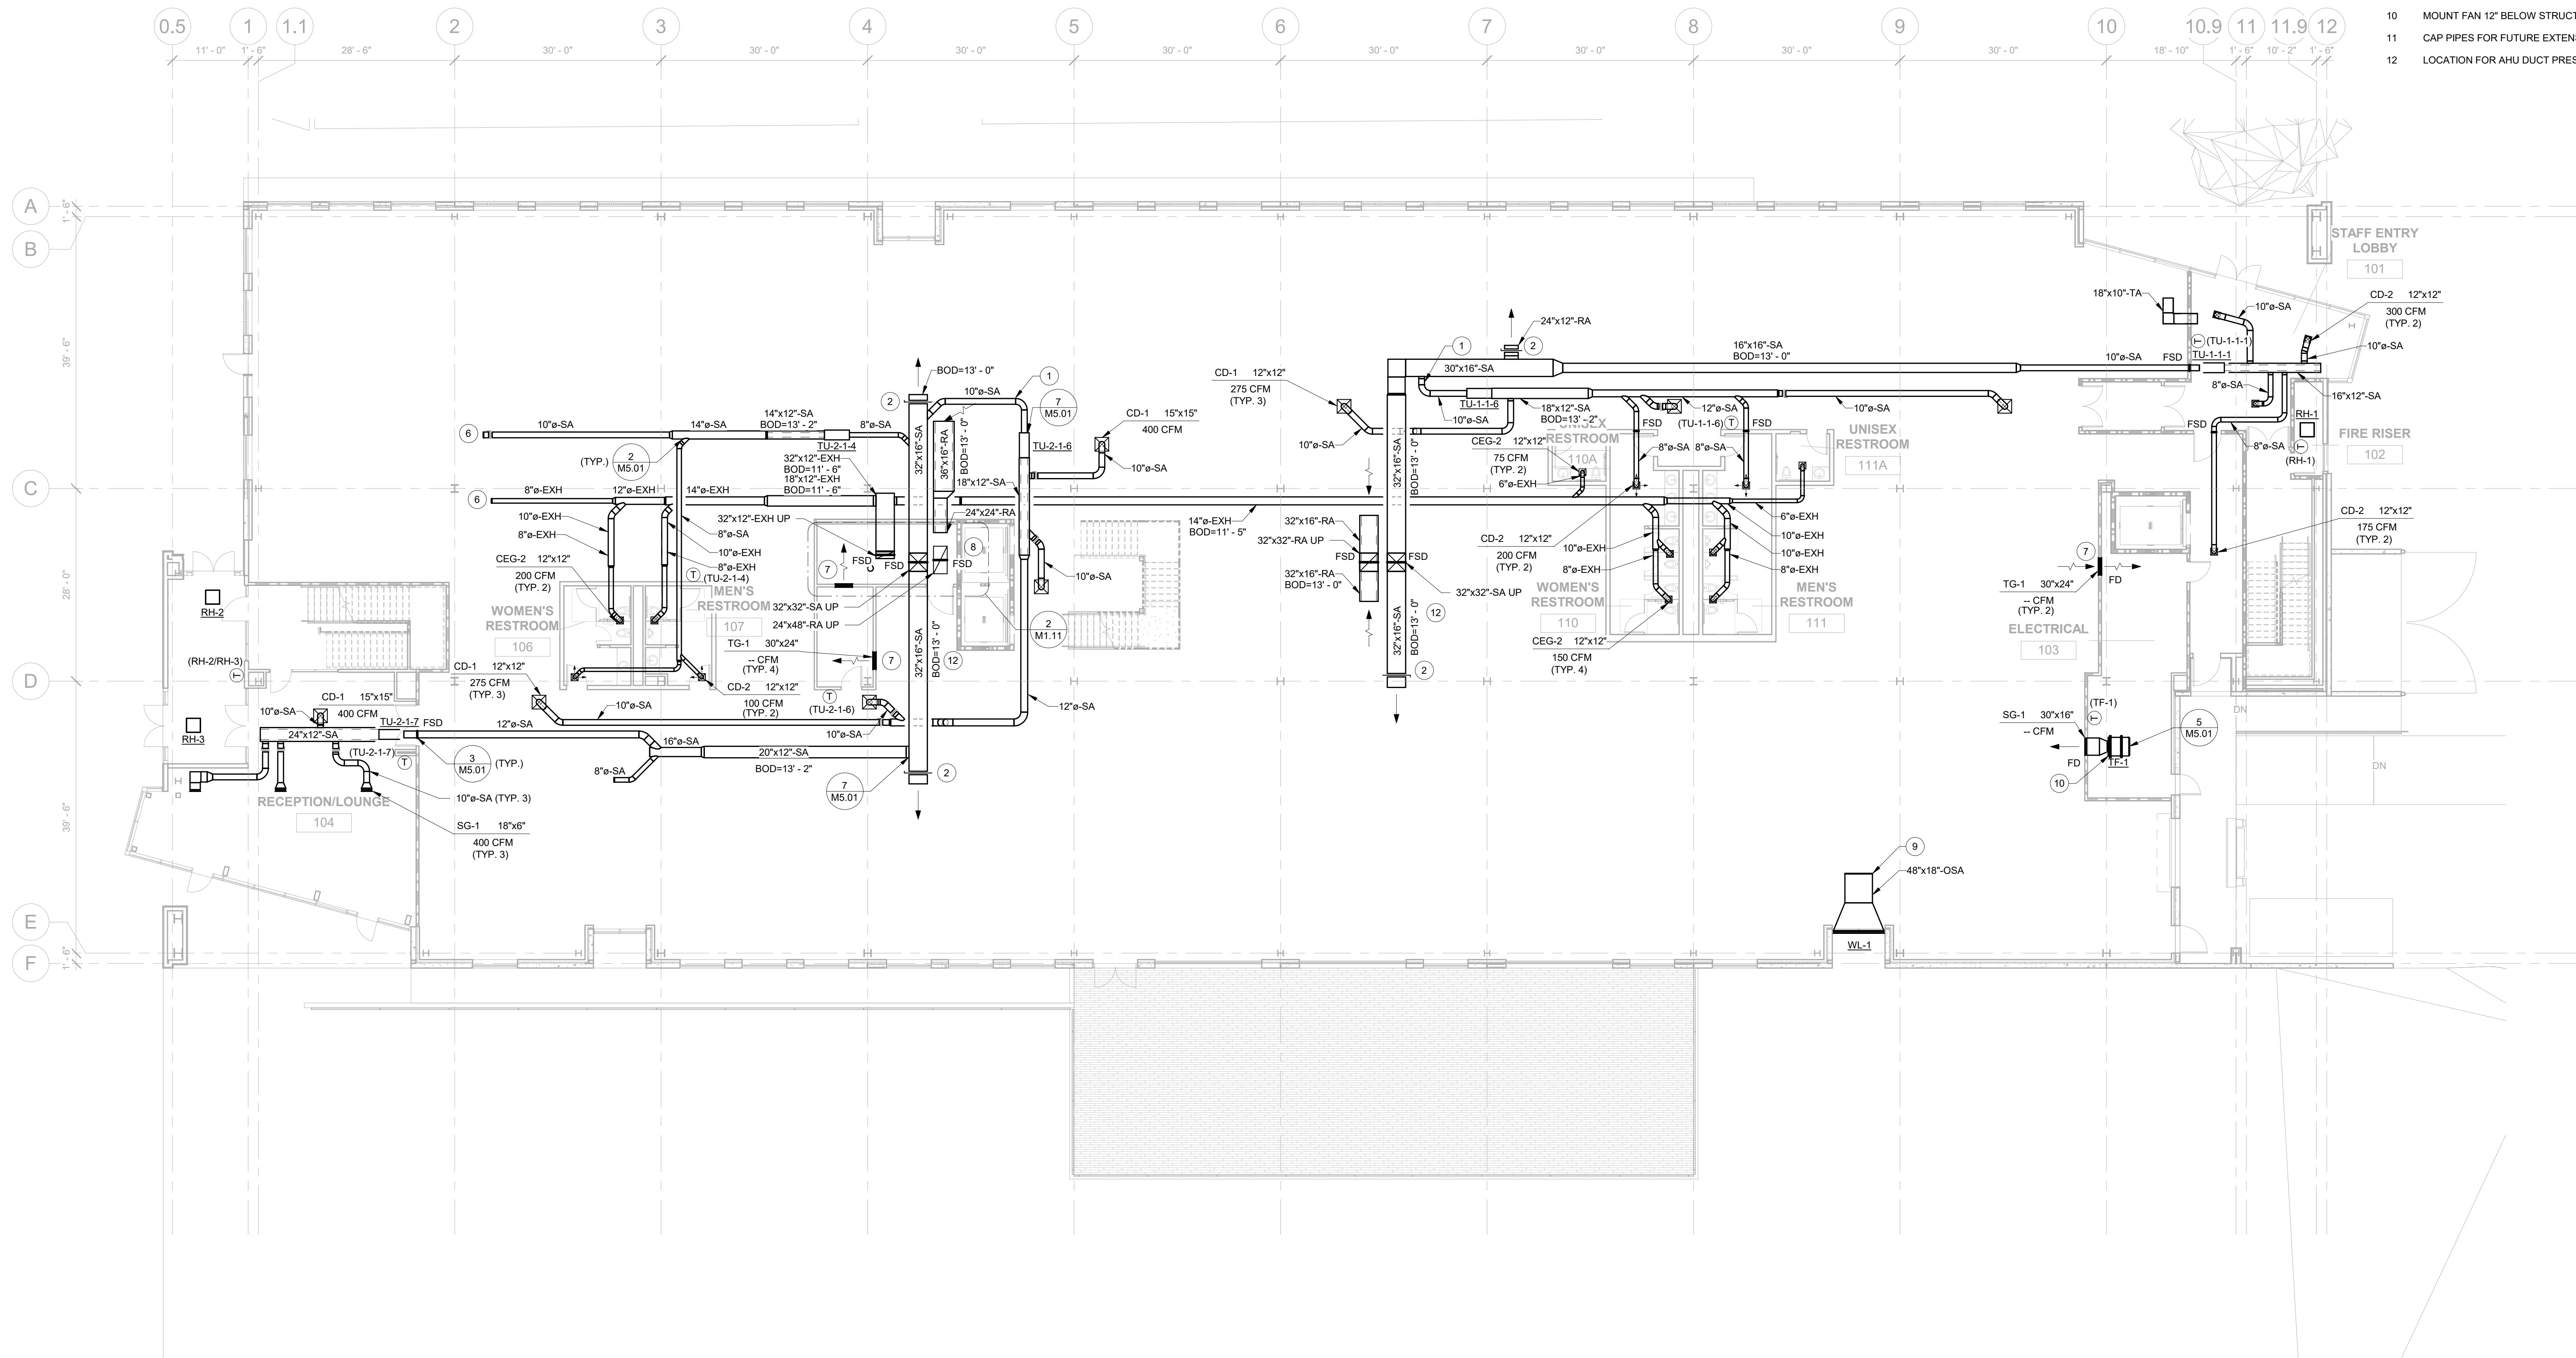

1 MECHANICAL FIRST LEVEL PLAN  
M1.11 SCALE: 3/32" = 1'-0"

- GENERAL NOTES**
- A SEE SHEET M0.01 FOR LEGEND, ABBREVIATIONS, AND GENERAL NOTES.
- B TEMPORARILY HANG DIFFUSERS WITH WIRE IN AREAS WHERE THERE WILL NOT BE A CEILING UNTIL THE TENANT IMPROVEMENT PHASE. LOCATIONS CAN BE APPROXIMATE.
- KEYED NOTES**
- 1 FUTURE EXIT CORRIDOR WALL AT THIS LOCATION. FUTURE FIRE/SMOKE DAMPER WILL BE INSTALLED.
- 2 PROVIDE VOLUME DAMPER AND BALANCE TO 1,500 CFM.
- 3 ROUTE 3"-HWS AND 3"-HWR PIPING UP IN SHAFT. PIPING CONTINUES ON SHEET M1.21.
- 4 PLUMBING EQUIPMENT SHOWN FOR COORDINATION.
- 5 CONNECT 1"-CW TO DOMESTIC COLD WATER PIPING IN MECHANICAL ROOM. PROVIDE SHUTOFF VALVE, REDUCED PRESSURE BACKFLOW DEVICE, AND PRESSURE REDUCING VALVE. SET PRV TO 48 PSI.
- 6 PROVIDE VOLUME DAMPER AND BALANCE TO 400 CFM.
- 7 MOUNT TRANSFER GRILLE 12" BELOW STRUCTURE.
- 8 EXTEND DUCT 10" DOWN BELOW CEILING. PROVIDE WIRE.
- 9 CAP DUCT FOR FUTURE EXTENSION.
- 10 MOUNT FAN 12" BELOW STRUCTURE.
- 11 CAP PIPES FOR FUTURE EXTENSION TO KITCHEN MAKEUP AIR.
- 12 LOCATION FOR AHU DUCT PRESSURE SENSOR.


PROJECT TITLE: LAM GREENFIELD OFFICE BUILDING  
LAM RESEARCH  
11155 SW LEVETON DR.  
TUALATIN, OR 97062  
CLIENT:

REV	DESCRIPTION	DATE	APPR	CCE
0	ISSUED FOR PERMIT	12/20/22		
Sheet Title: MECHANICAL FIRST LEVEL PLAN				
Sheet Number:				
M1.11				
Proj No: CC22450B				



BAR SCALE  
0 2 4 8 16 20  
SCALE: 3/32" = 1'-0"  
WHEN PRINTED ON 30"x42" SHEET



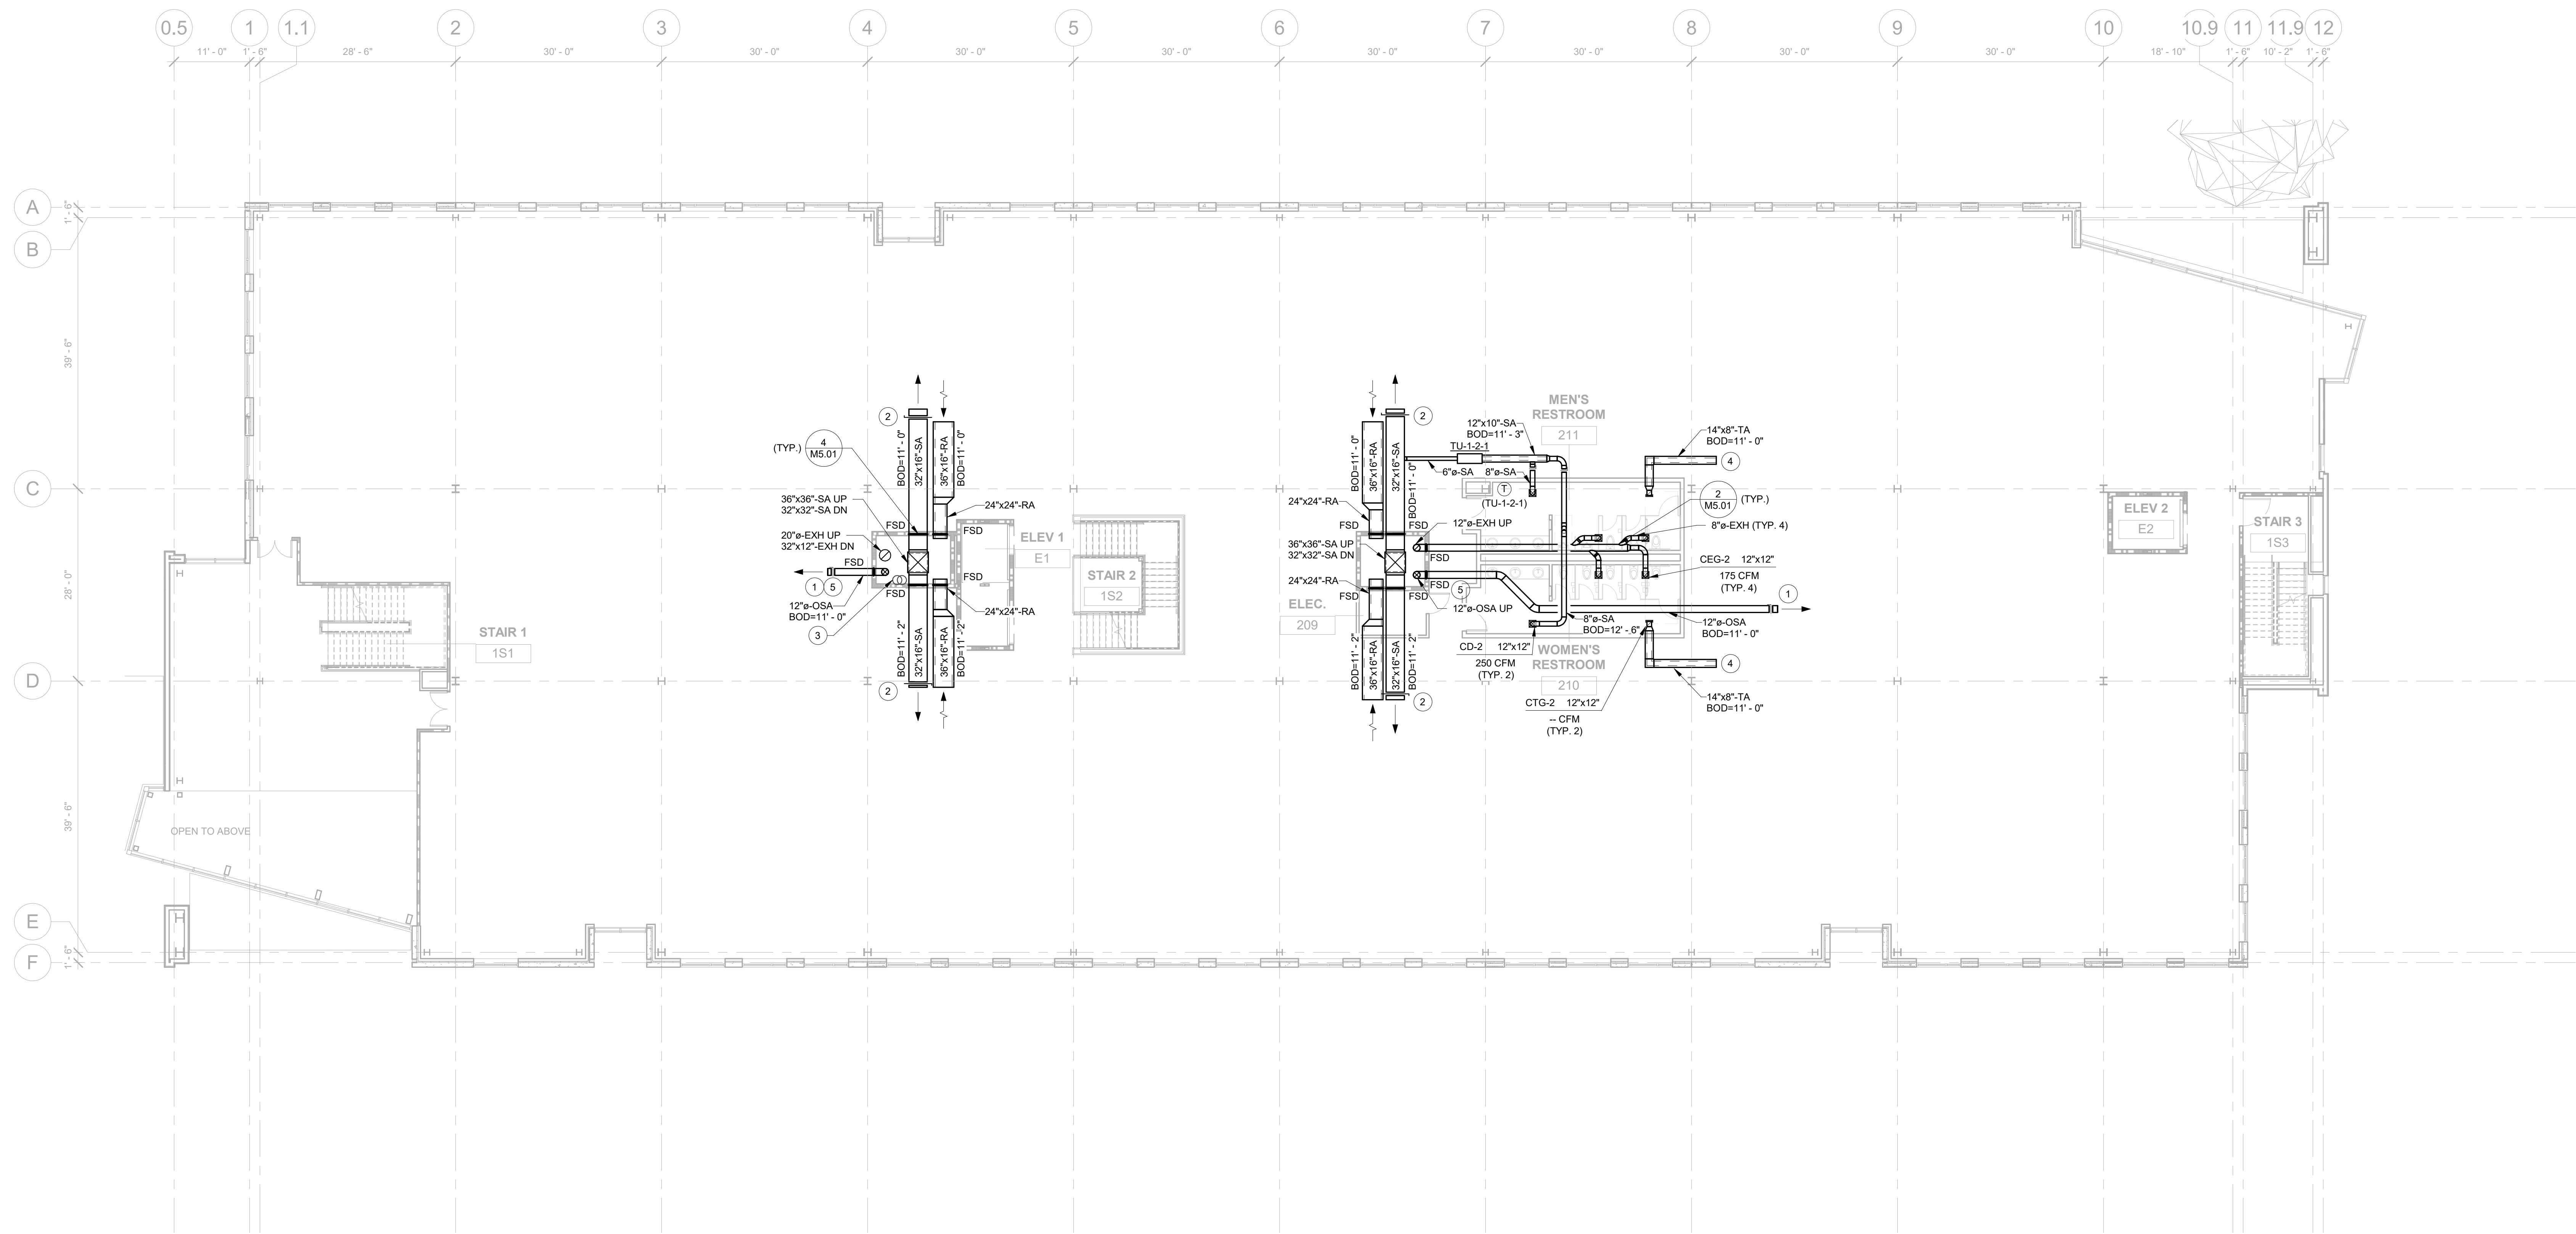

- GENERAL NOTES**
- A SEE SHEET M0.01 FOR LEGEND, ABBREVIATIONS, AND GENERAL NOTES.
- KEYED NOTES**
- 1 PROVIDE VOLUME DAMPER AND BALANCE TO 600 CFM.
  - 2 PROVIDE VOLUME DAMPER AND BALANCE TO 1,500 CFM.
  - 3 ROUTE BOTH 3"-HWR PIPING UP IN SHAFT. PIPING CONTINUES ON SHEET M1.31. ROUTE BOTH 3"-HWR PIPING DOWN THROUGH BOTTOM OF SHAFT AND INTO MECHANICAL ROOM ON SHEET M1.11.
  - 4 TRANSFER AIR DUCT TERMINATES 6" BELOW STRUCTURE.
  - 5 LOCATION FOR DOAS DUCT PRESSURE SENSOR.



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TUALATIN, OR 97062  
CLIENT:

REV.	DESCRIPTION	DATE	APPR.
0	ISSUED FOR PERMIT	12/20/22	CCE

Sheet Title:  
MECHANICAL  
SECOND LEVEL  
PLAN

Sheet Number:

M1.21


Proj No: CC22450B

1 MECHANICAL SECOND LEVEL PLAN  
M1.21

BAR SCALE  
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SCALE: 3/32" = 1'-0"  
WHEN PRINTED ON 30"x42" SHEET





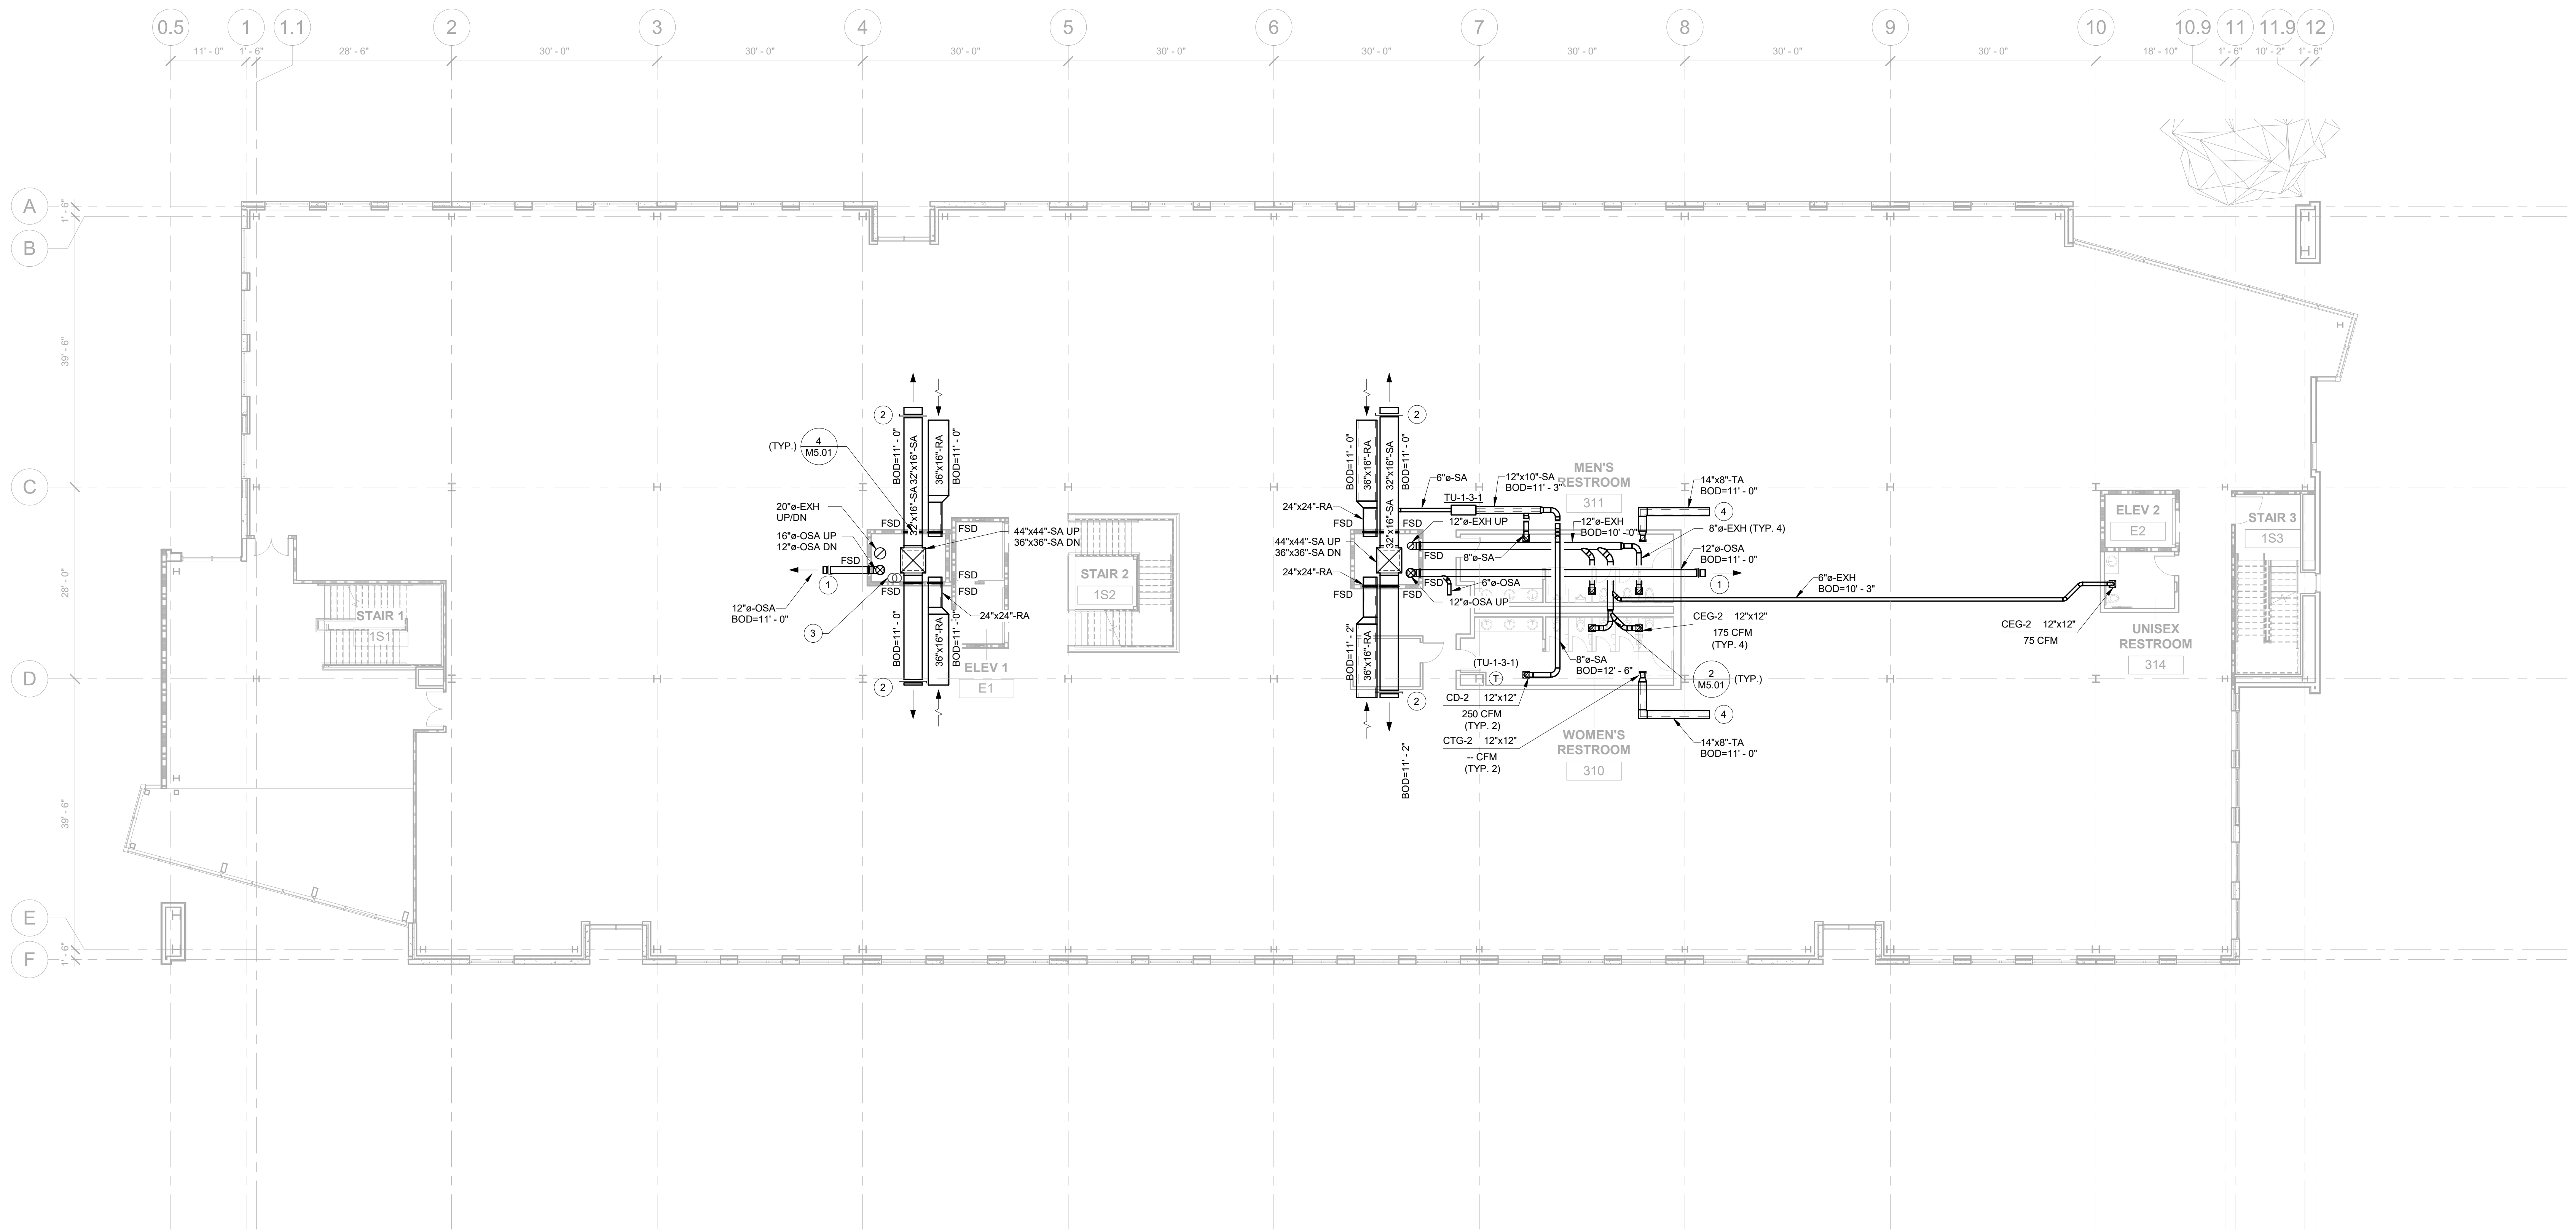

- GENERAL NOTES**
- A SEE SHEET M0.01 FOR LEGEND, ABBREVIATIONS, AND GENERAL NOTES.
- KEYED NOTES**
- 1 PROVIDE VOLUME DAMPER AND BALANCE TO 600 CFM.
  - 2 PROVIDE VOLUME DAMPER AND BALANCE TO 1,500 CFM.
  - 3 ROUTE BOTH 3"-HWR PIPING UP/DOWN IN SHAFT. PIPING CONTINUES ON SHEETS M1.21 AND M1.31.
  - 4 TRANSFER AIR DUCT TERMINATES 6" BELOW STRUCTURE.


1 MECHANICAL THIRD LEVEL PLAN  
M1.31

BAR SCALE  
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SCALE: 3/32" = 1'-0"  
WHEN PRINTED ON 30"x42" SHEET




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						CLIENT: LAM RESEARCH 11155 SW LEVETON DR. TUALATIN, OR 97062	
Sheet Number:		M1.31					
Proj No:		CC22450B					



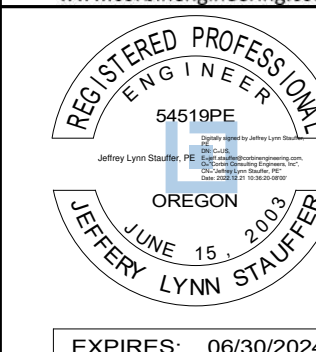

A SEE SHEET M0.01 FOR LEGEND, ABBREVIATIONS, AND GENERAL NOTES

- 1 ROUTE 3" HWYSIR THROUGH ROOF. SEE SHEET M1.51 FOR CONTINUATION.
- 2 ROUTE 2 1/2" HWYS THROUGH ROOF. SEE SHEET M1.51 FOR CONTINUATION.
- 3 50"x50" EXHAUST UP TERMINATE 6" BELOW ROOF DECK. SEE ROOF PLAN FOR LOCATION.
- 4 ROUTE 48"x48" SUPPLY AIR DUCT UP THROUGH ROOF TO AHJ. SEE SHEET M1.51 FOR CONTINUATION.
- 5 ROUTE OSA AND EXHAUST DUCTS UP THROUGH ROOF TO DOAS UNIT. SEE SHEET M1.51 FOR CONTINUATION.
- 6 PROVIDE VOLUME DAMPER AND BALANCE TO 800 CFM.
- 7 PROVIDE VOLUME DAMPER AND BALANCE TO 1,500 CFM.
- 8 ROUTE BOTH 3" HWIR PIPING DOWN IN SHAFT. PIPING CONTINUES ON SHEETS M1.51.
- 9 TRANSFER AIR DUCT TERMINATES 6" BELOW STRUCTURE.
- 10 PROVIDE BALL VALVES AND CAP REFRIGERANT PIPING BELOW DECK. ROUTE REFRIGERANT PIPING UP THROUGH ROOF AND CONTINUE ON SHEET M1.51.
- 11 ROUTE REFRIGERANT PIPING UP THROUGH ROOF AND CONTINUE ON SHEET M1.51.

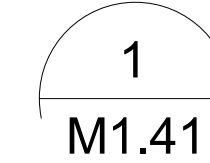

BAR SCALE  
0 2 4 8 16 20  
SCALE:  $3/32" = 1'-0"$   
WHEN PRINTED ON 30"x42" SHEET



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11155 SW LEVETON DR.  
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Sheet Title:  
MECHANICAL  
FOURTH LEVEL  
PLAN

Sheet Number:

M1.41

Proj No:	CC22450E
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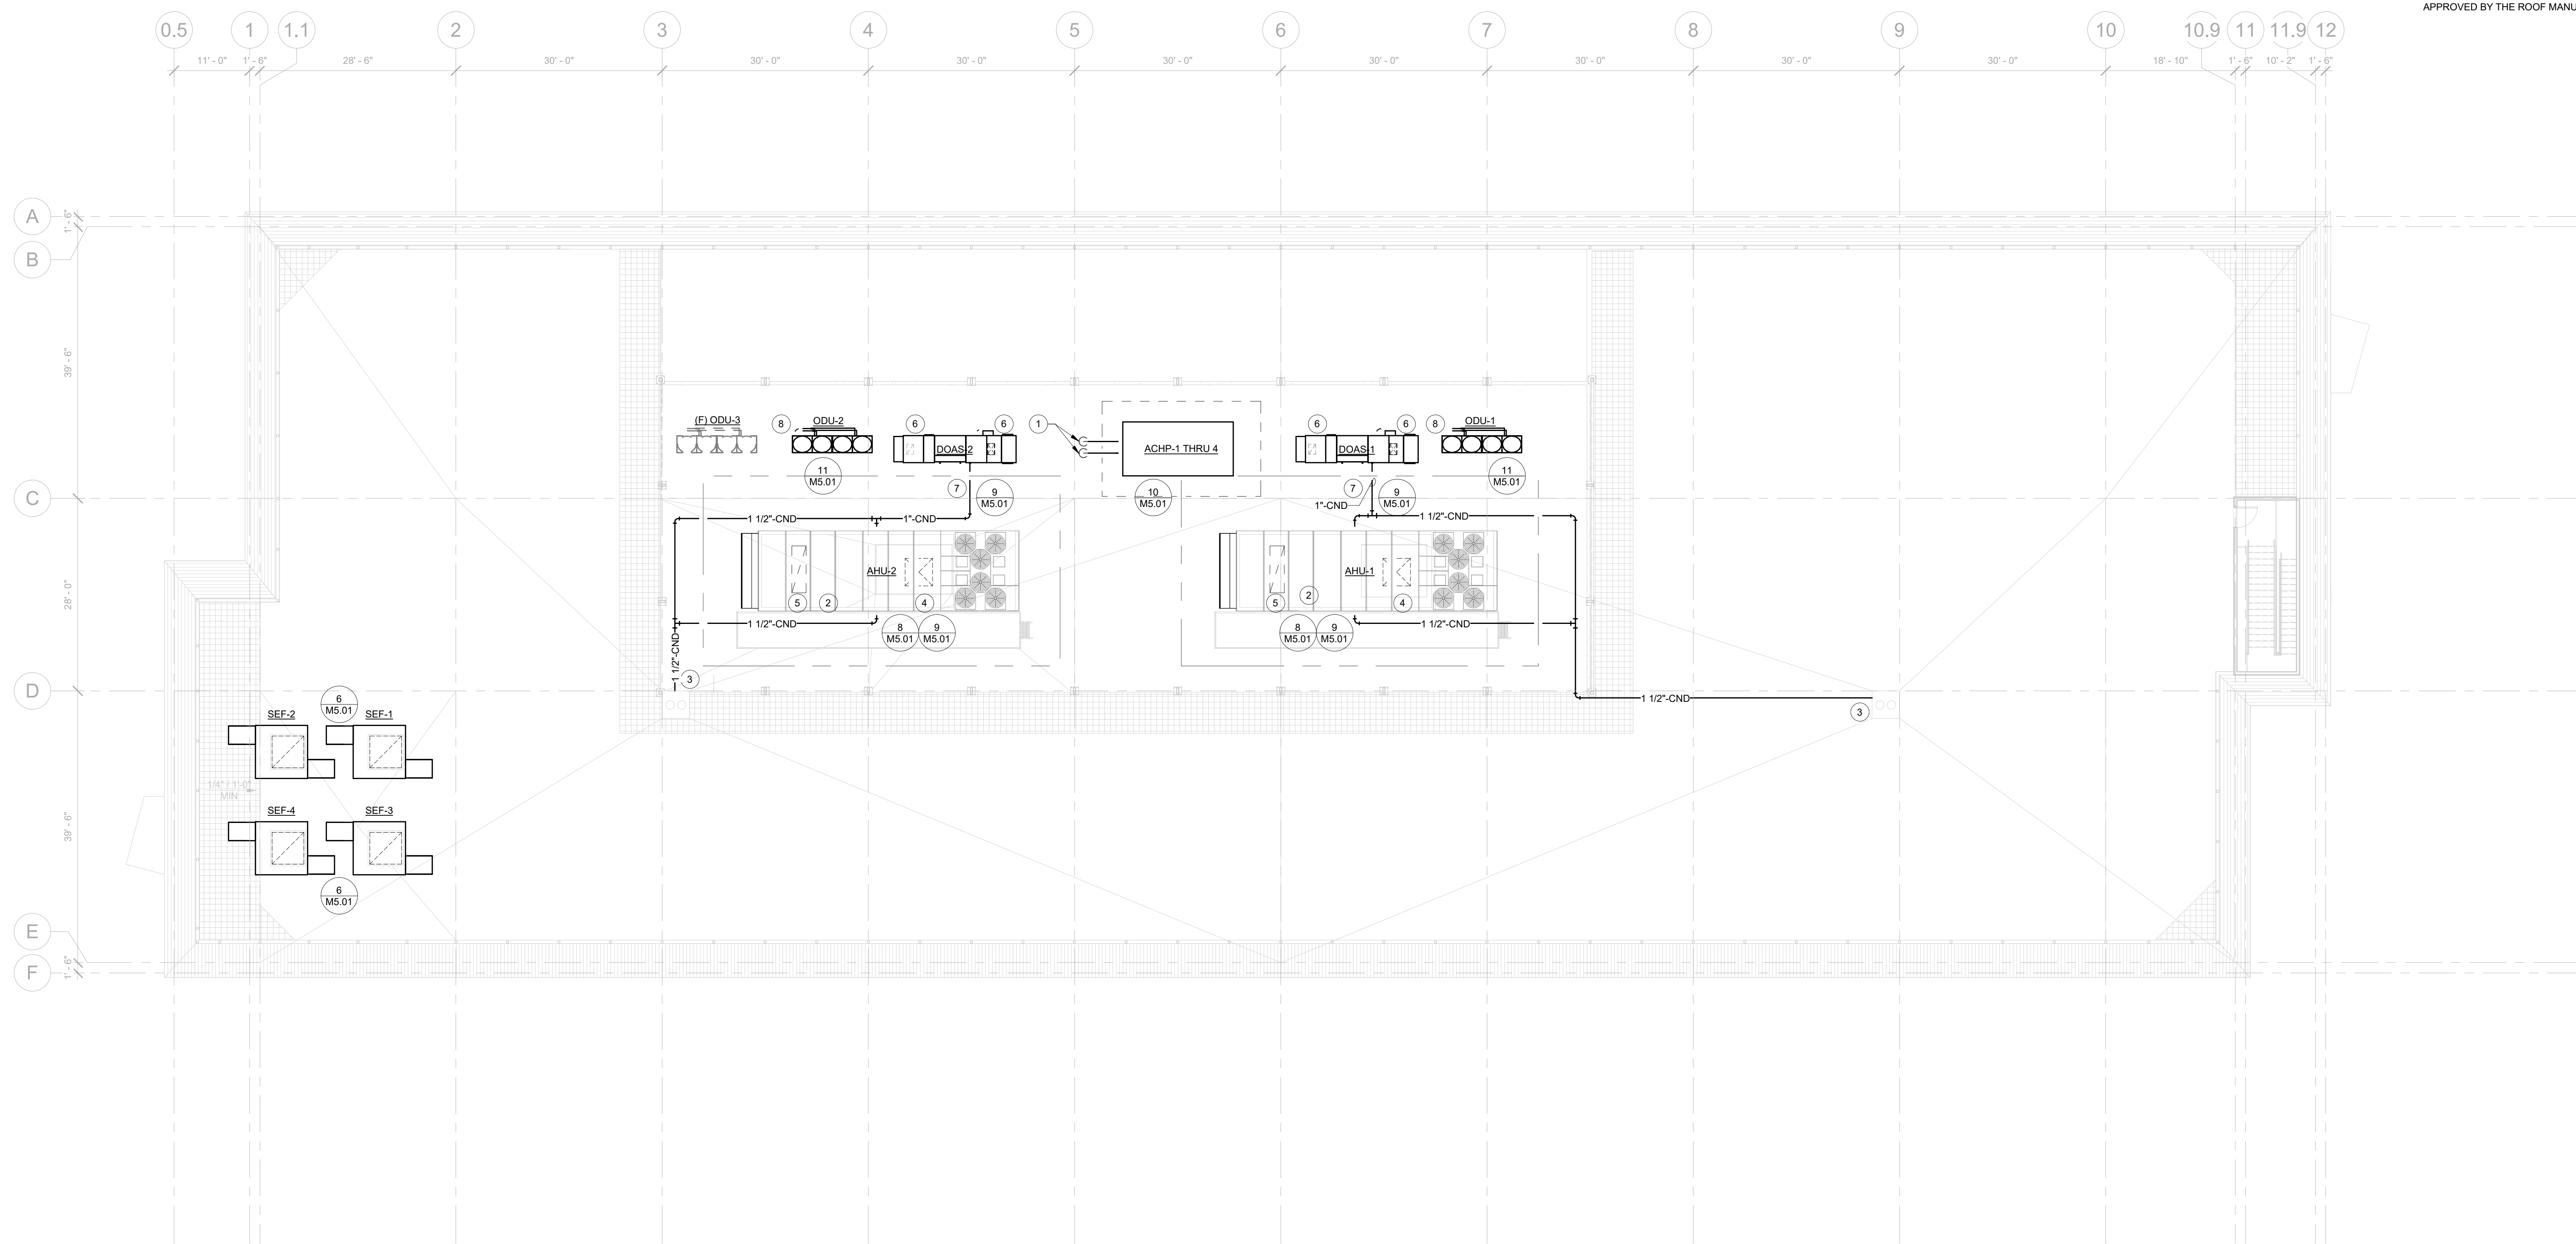


**GENERAL NOTES**

A SEE SHEET M0.01 FOR LEGEND, ABBREVIATIONS, AND GENERAL NOTES.

**KEYED NOTES**

- 1 CONNECT 6"-HWS/R TO ACHP-1. TRANSITION TO 3", ELBOW DOWN, AND PENETRATE ROOF. SEE SHEET M1.41 FOR CONTINUATION.
- 2 CONNECT 1 1/2"-HWS/R TO AHU-1&2. TRANSITION TO 2 1/2", ELBOW DOWN, AND PENETRATE ROOF WITH FLASHING APPROVED BY THE ROOF MANUFACTURER. SEE SHEET M1.41 FOR CONTINUATION.
- 3 TERMINATE CONDENSATE NEAR ROOF DRAINS.
- 4 ROUTE 48"x48" SUPPLY AIR DUCT DOWN IN SHAFT AND CONTINUE ON SHEET M1.41. TRANSITION AND MAKE CONNECTION TO UNIT.
- 5 RETURN AIR CONNECTION ON UNIT OPEN TO PLENUM BENEATH UNIT.
- 6 ROUTE OSA AND EXHAUST DUCTS DOWN THROUGH ROOF AND CONTINUE ON SHEET M1.41.
- 7 CONNECT TO (3) CONDENSATE DRAINS ON THIS UNIT.
- 8 ROUTE REFRIGERANT PIPING DOWN THROUGH ROOF WITH FLASHING APPROVED BY THE ROOF MANUFACTURER.



1 MECHANICAL ROOF PLAN  
M1.51

BAR SCALE  
0 2 4 8 16 20  
SCALE: 3/32" = 1'-0"  
WHEN PRINTED ON 30"x42" SHEET



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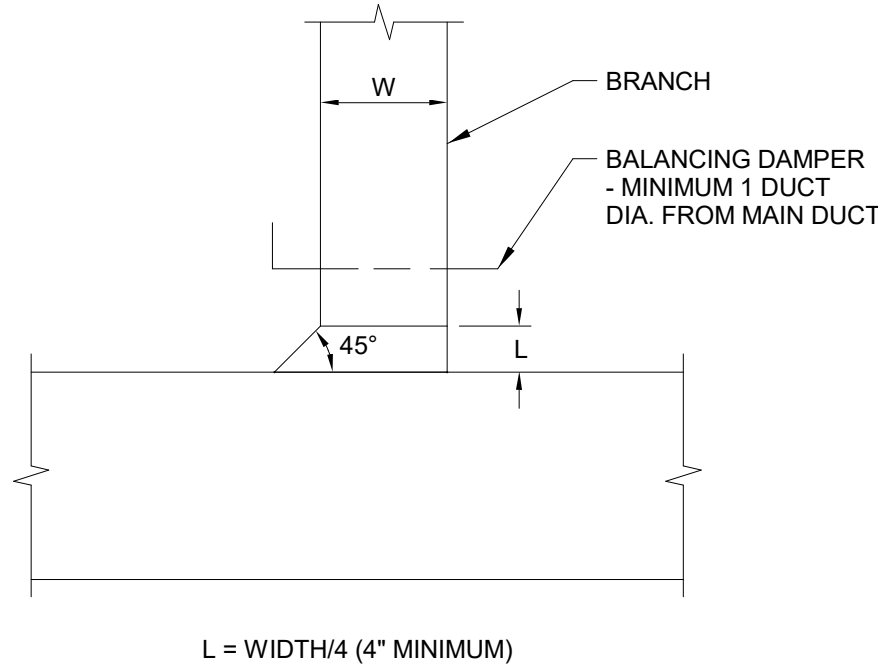
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MECHANICAL ROOF  
PLAN


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M1.51


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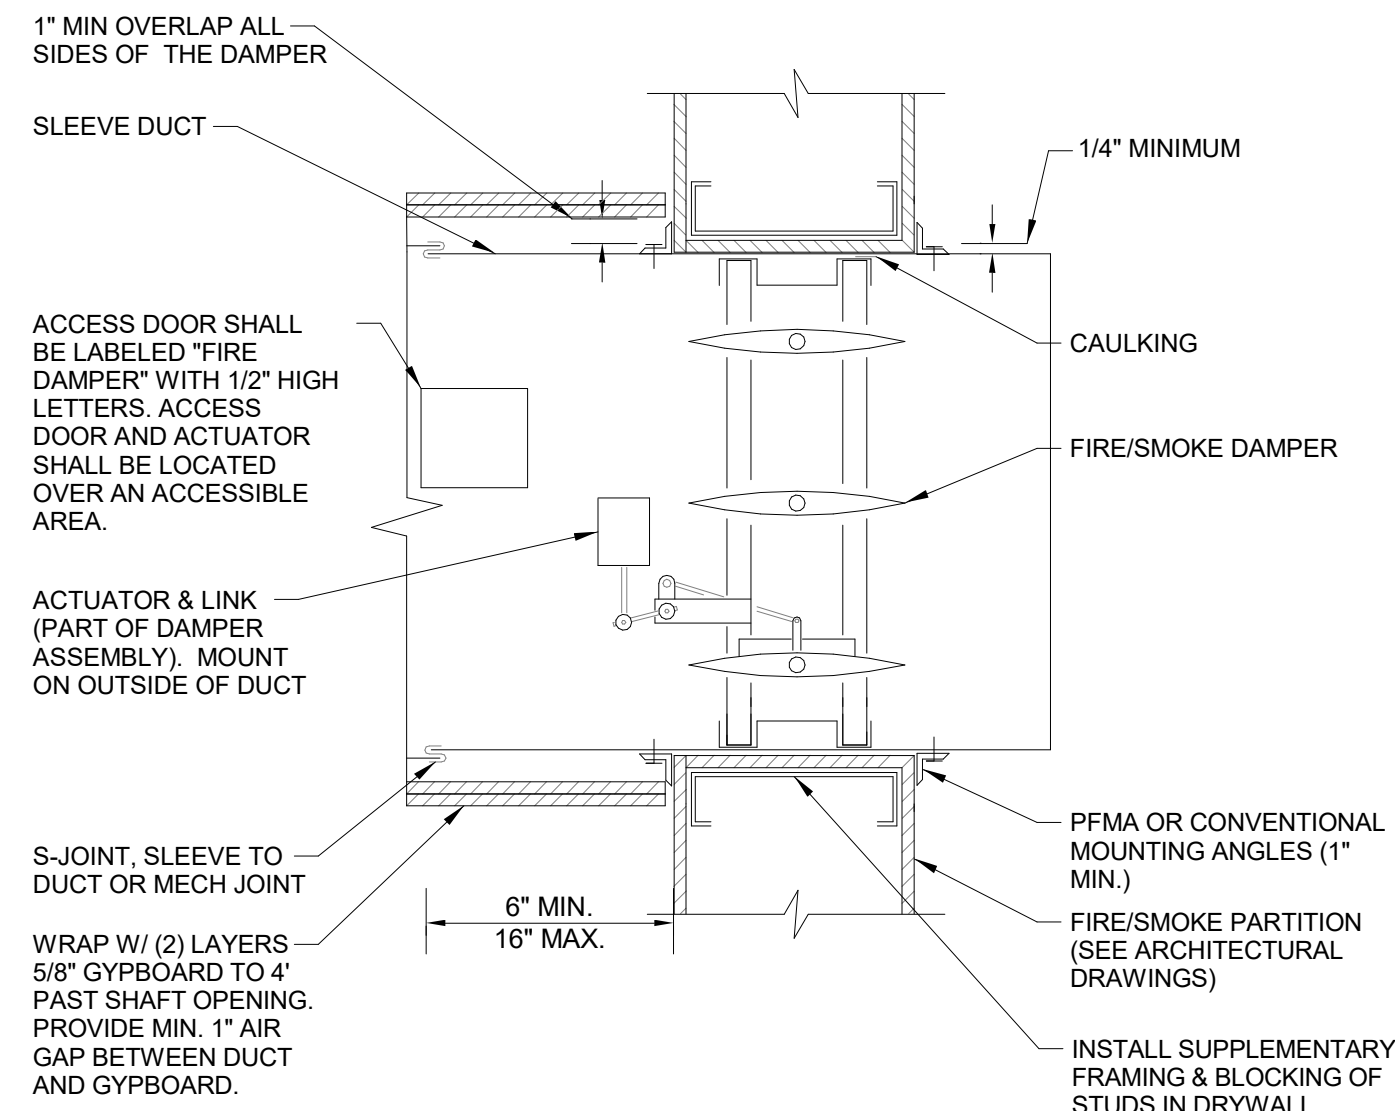
1 RECTANGULAR BRANCH  
M5.01




2 SUPPLY BRANCH - ROUND TO ROUND  
M5.01

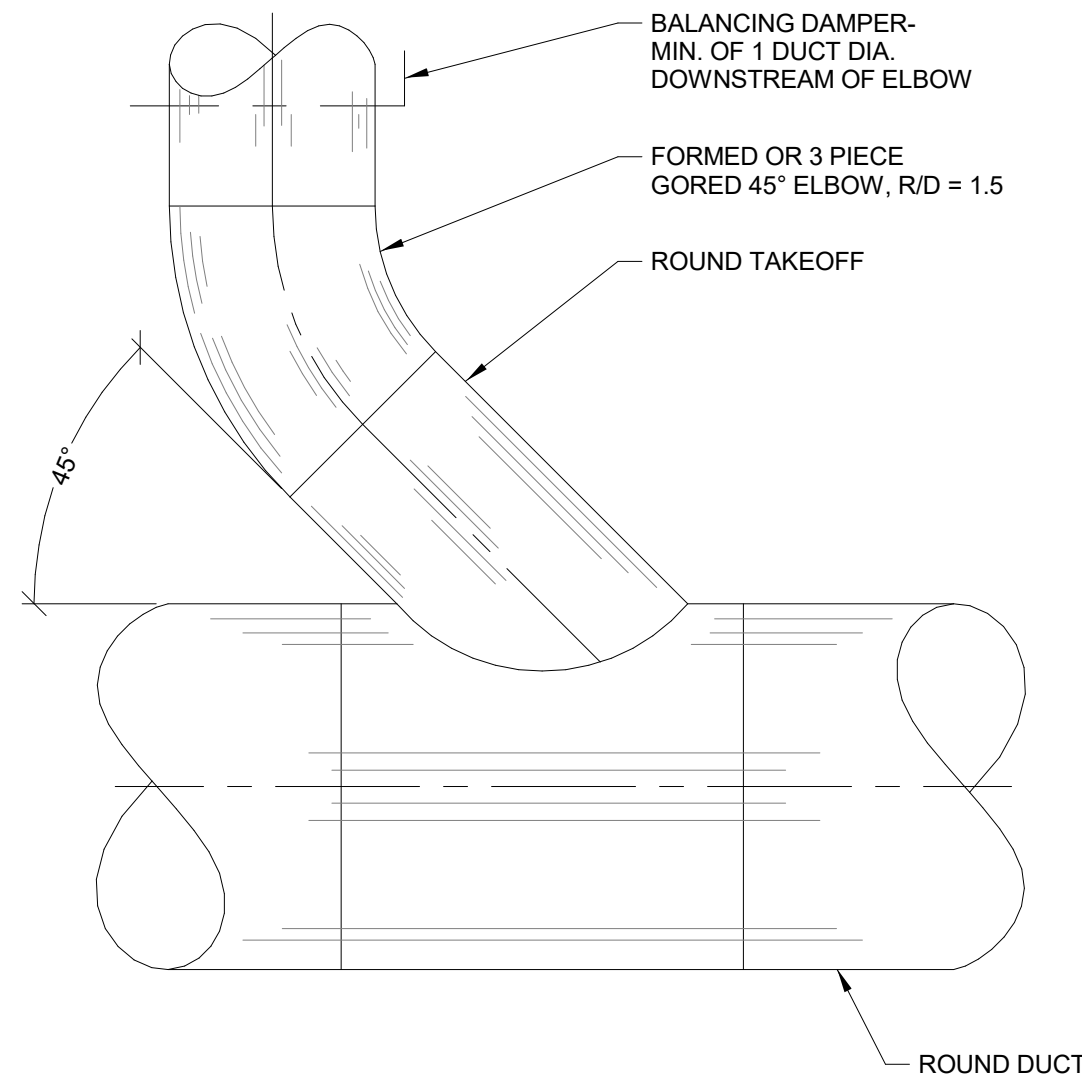


3 COMBINATION FIRE/SMOKE DAMPER  
M5.01

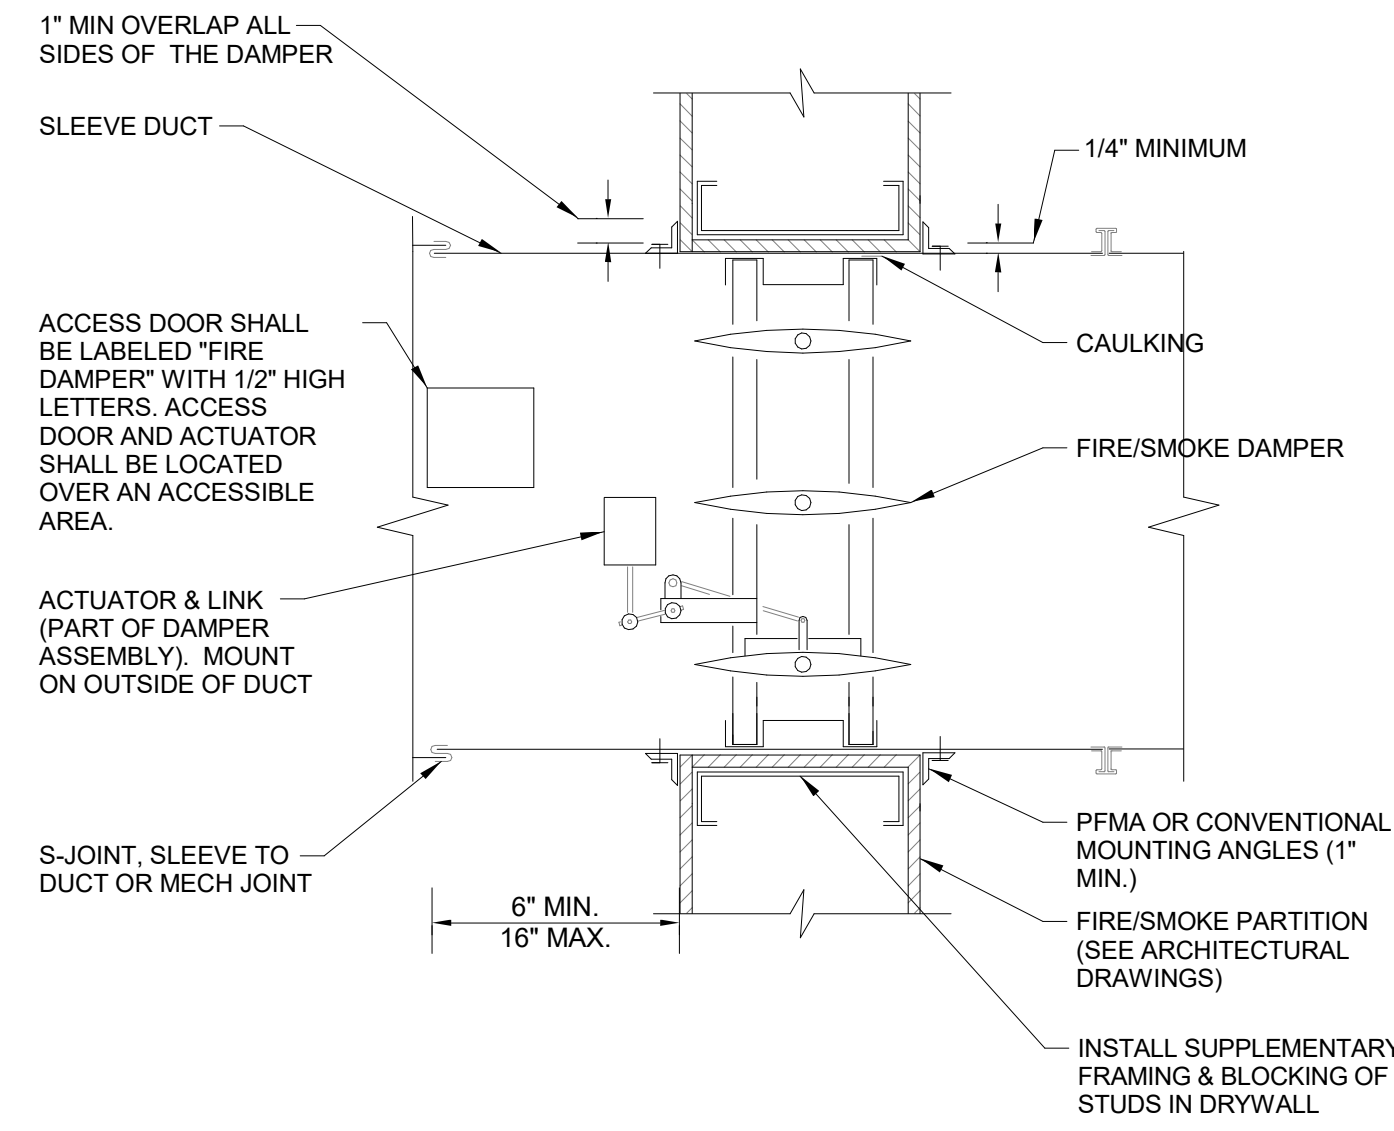


4 COMBINATION FIRE/SMOKE DAMPER  
M5.01

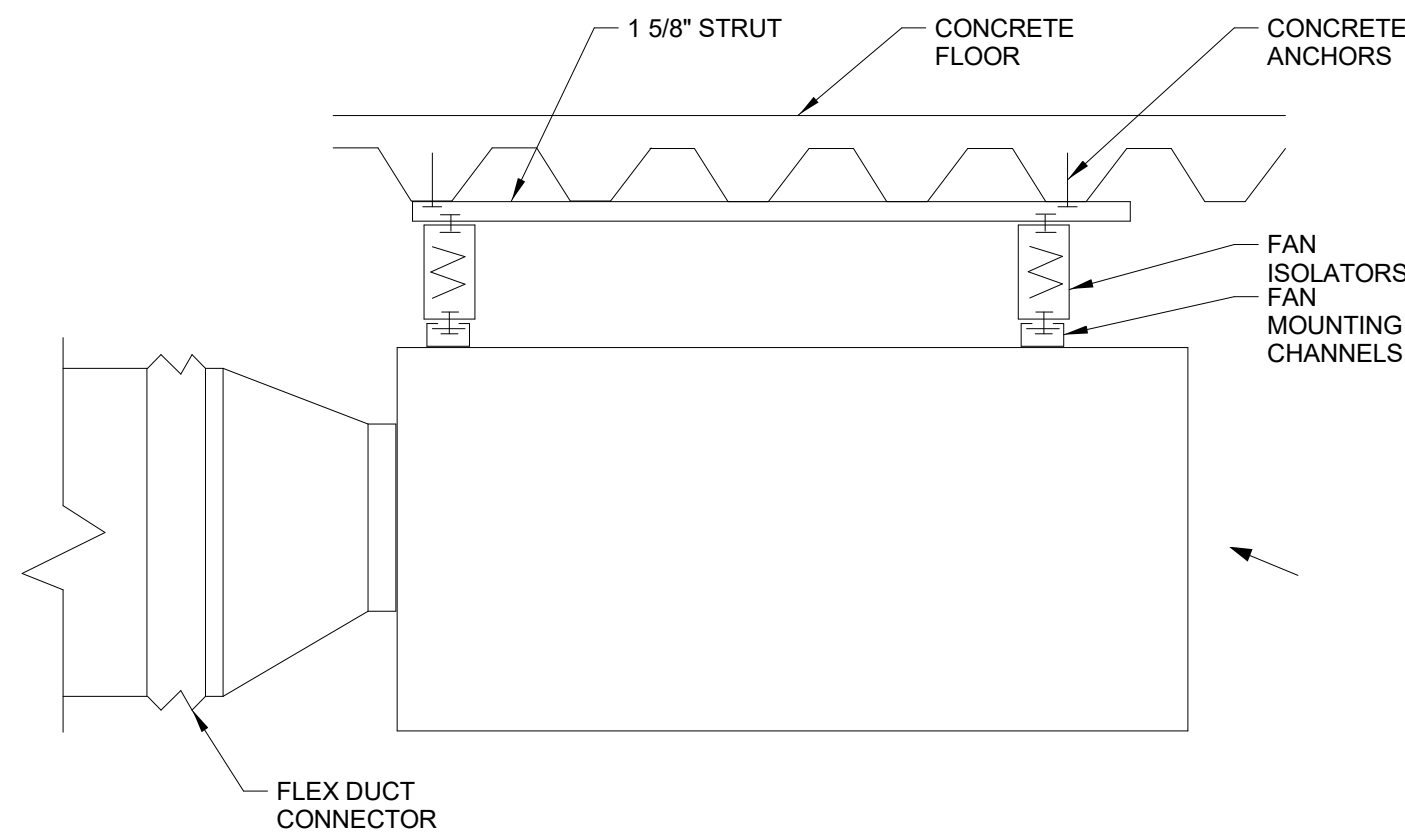


5 TRANSFER FAN  
M5.01

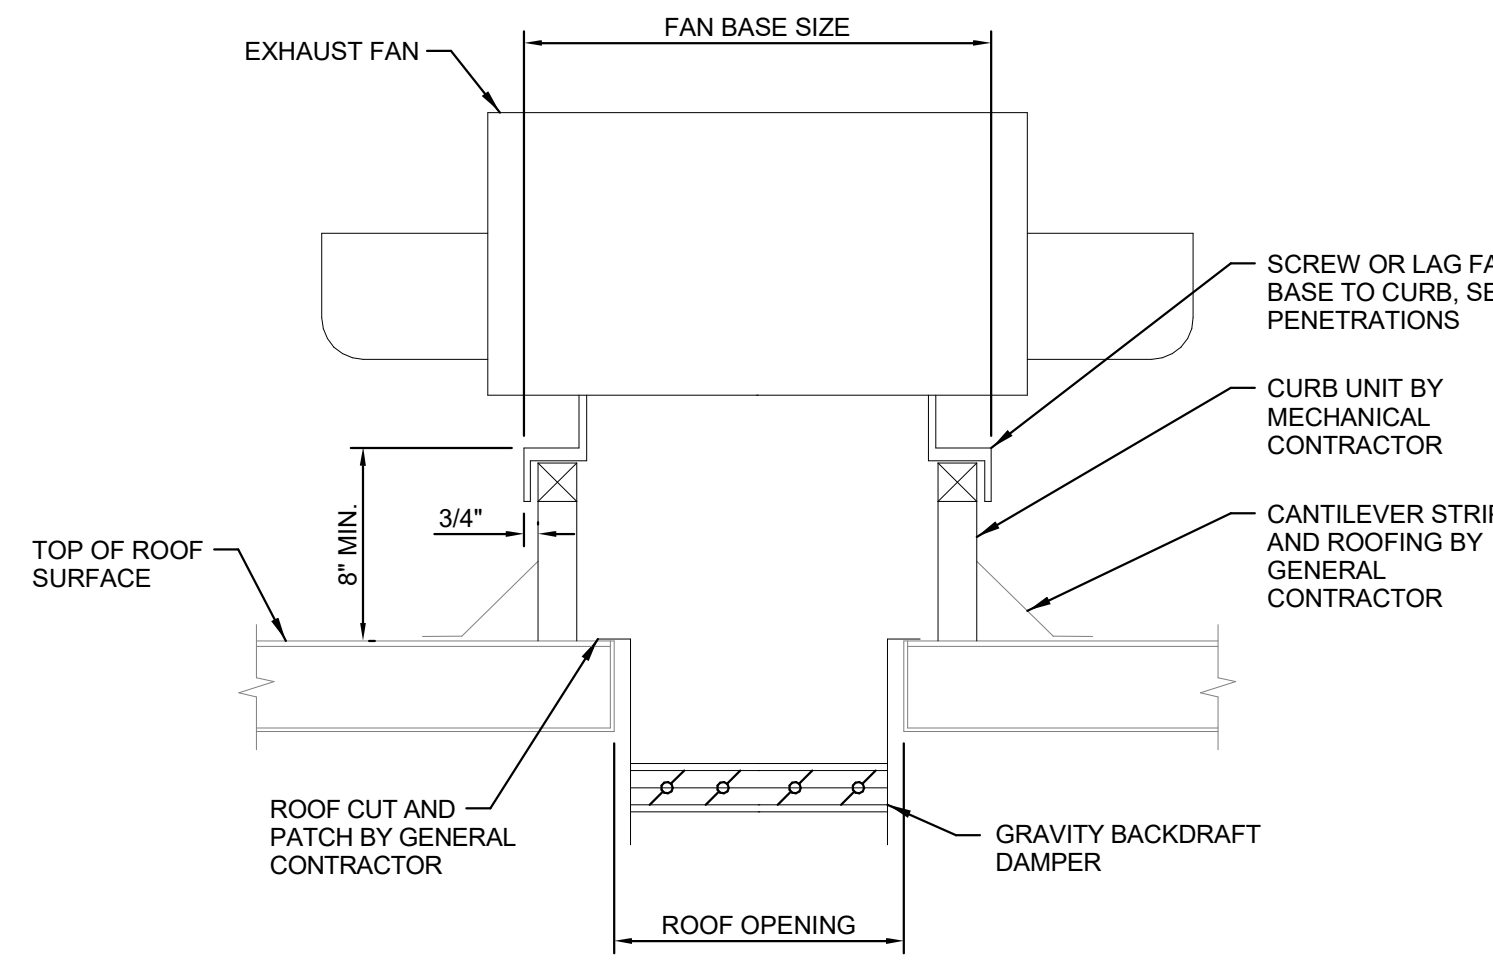


6 SMOKE EXHAUST FAN  
M5.01

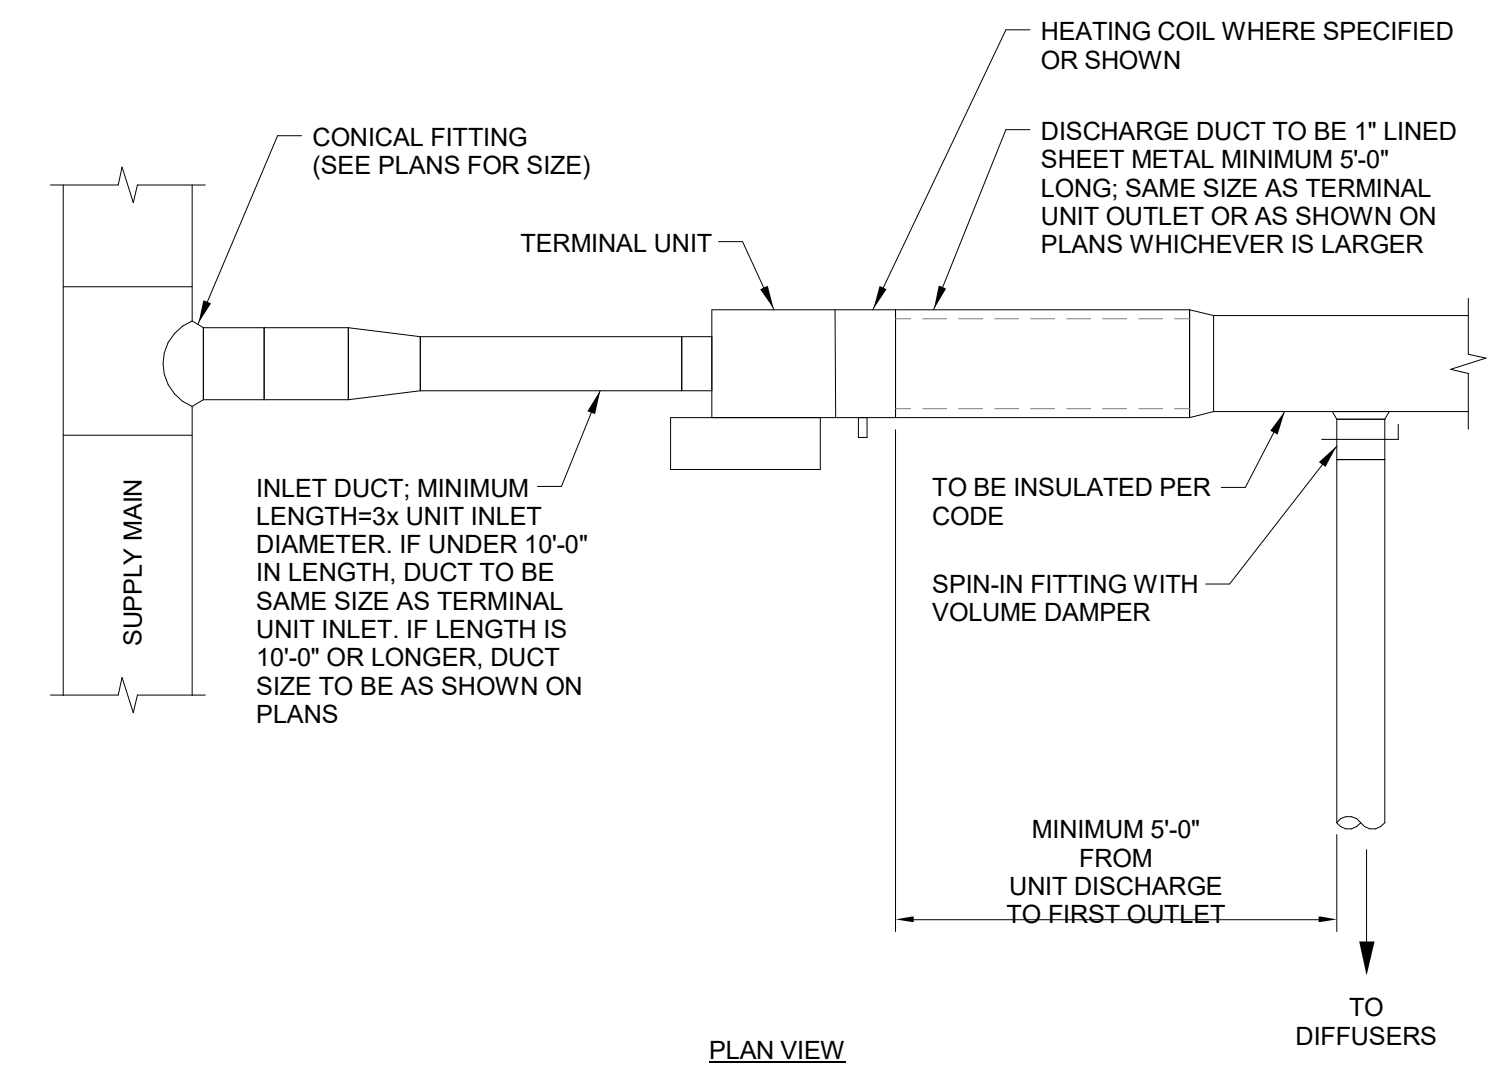


7 TERMINAL UNIT  
M5.01

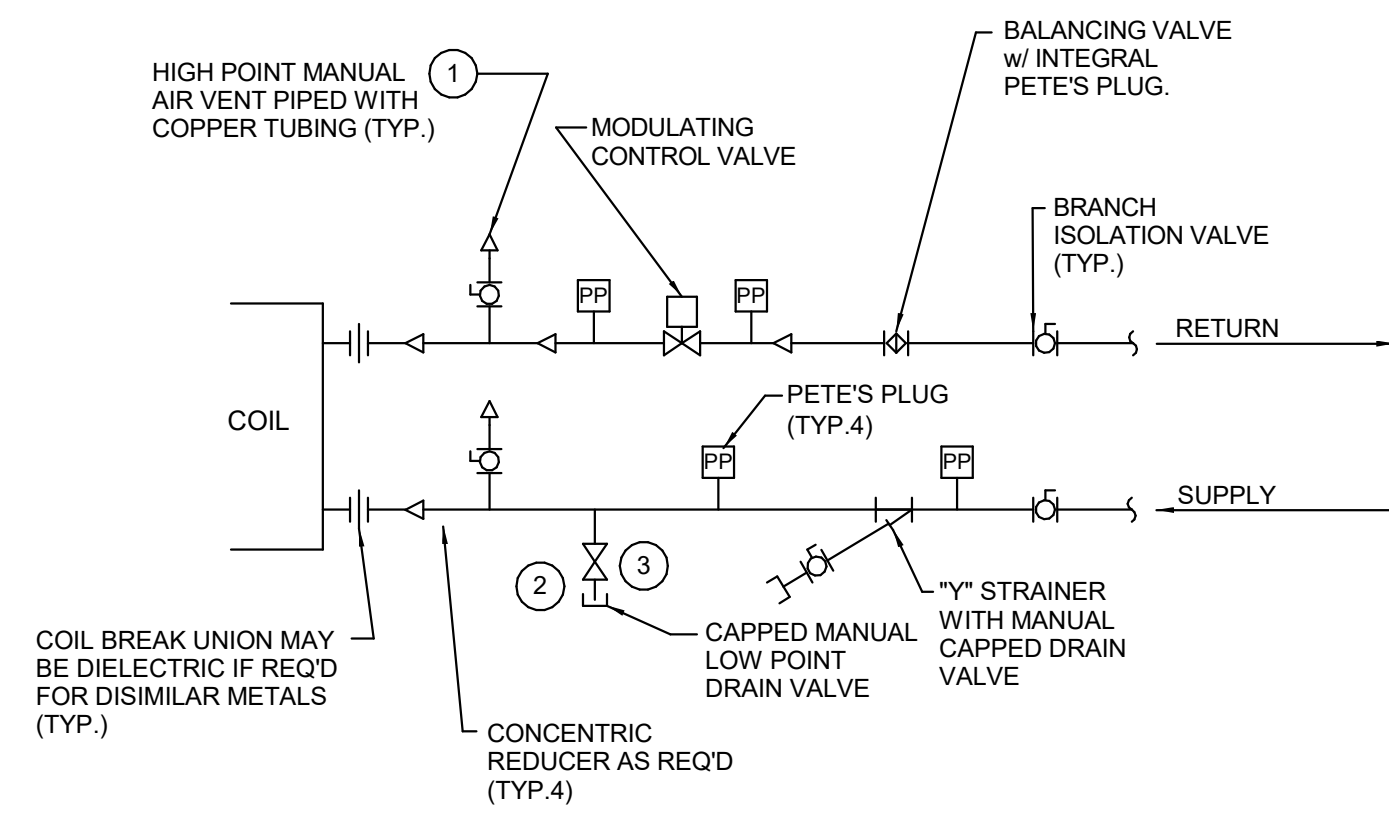


8 SENSIBLE HEATING COIL  
M5.01

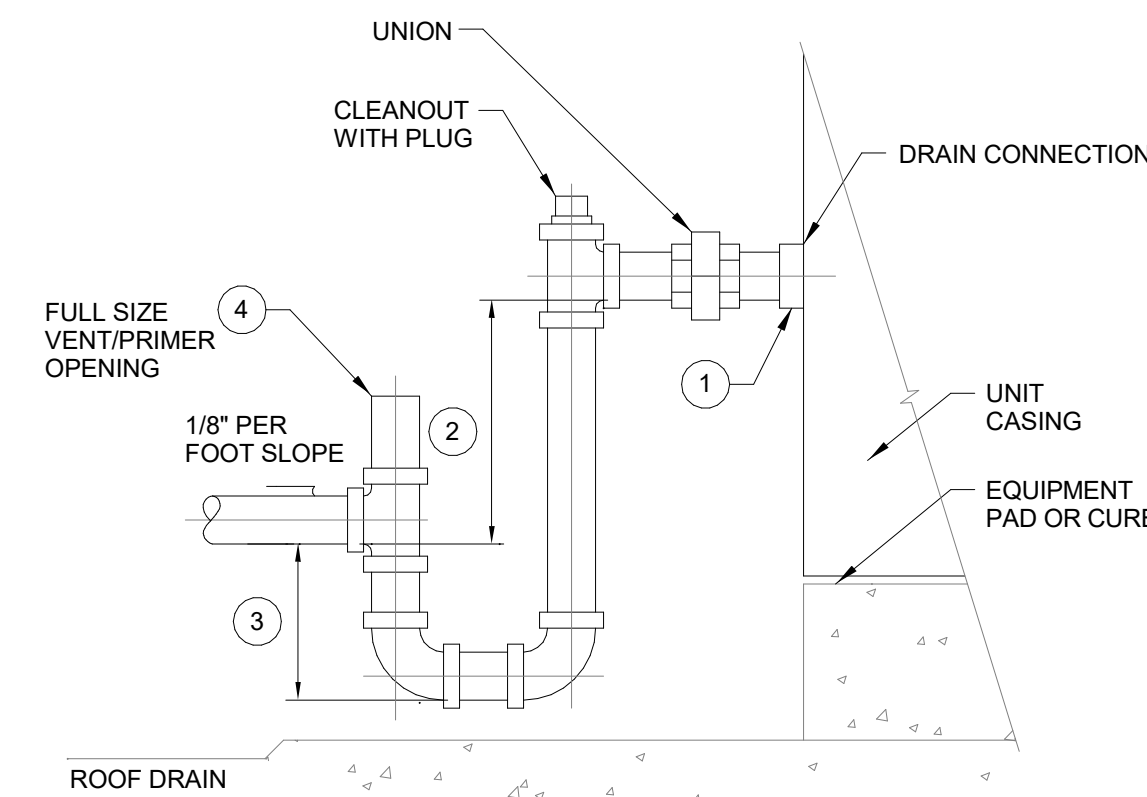

9 AHU & DOAS COIL CONDENSATE RETURN  
M5.01

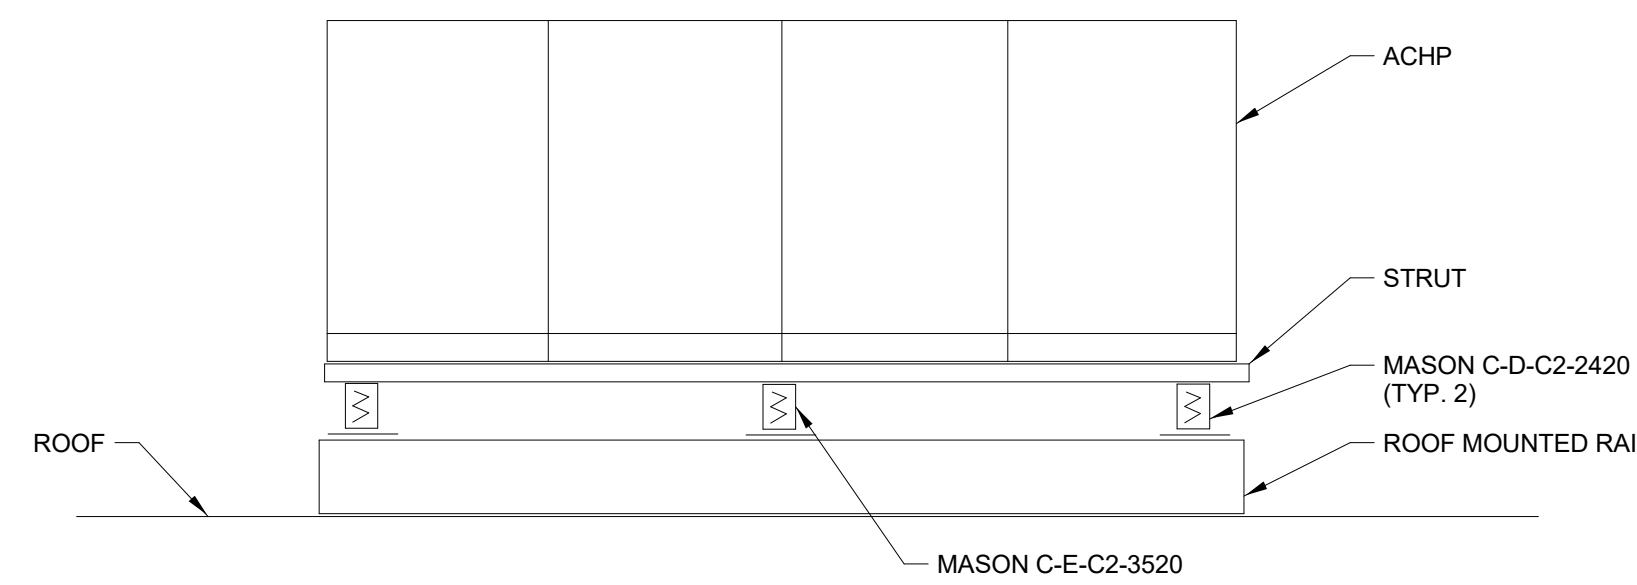

10 ACHP MOUNTING  
M5.01

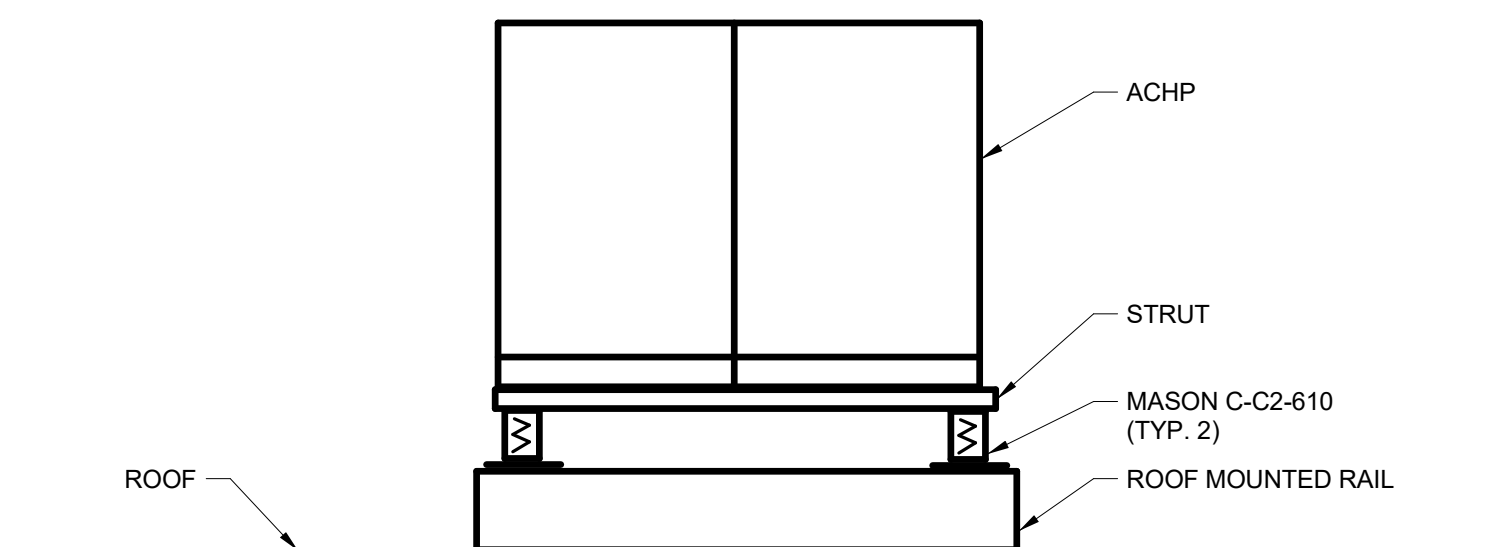

11 ODU MOUNTING  
M5.01

**GENERAL NOTES**  
A SEE SHEET M0.01 FOR LEGEND, ABBREVIATIONS, AND GENERAL NOTES.


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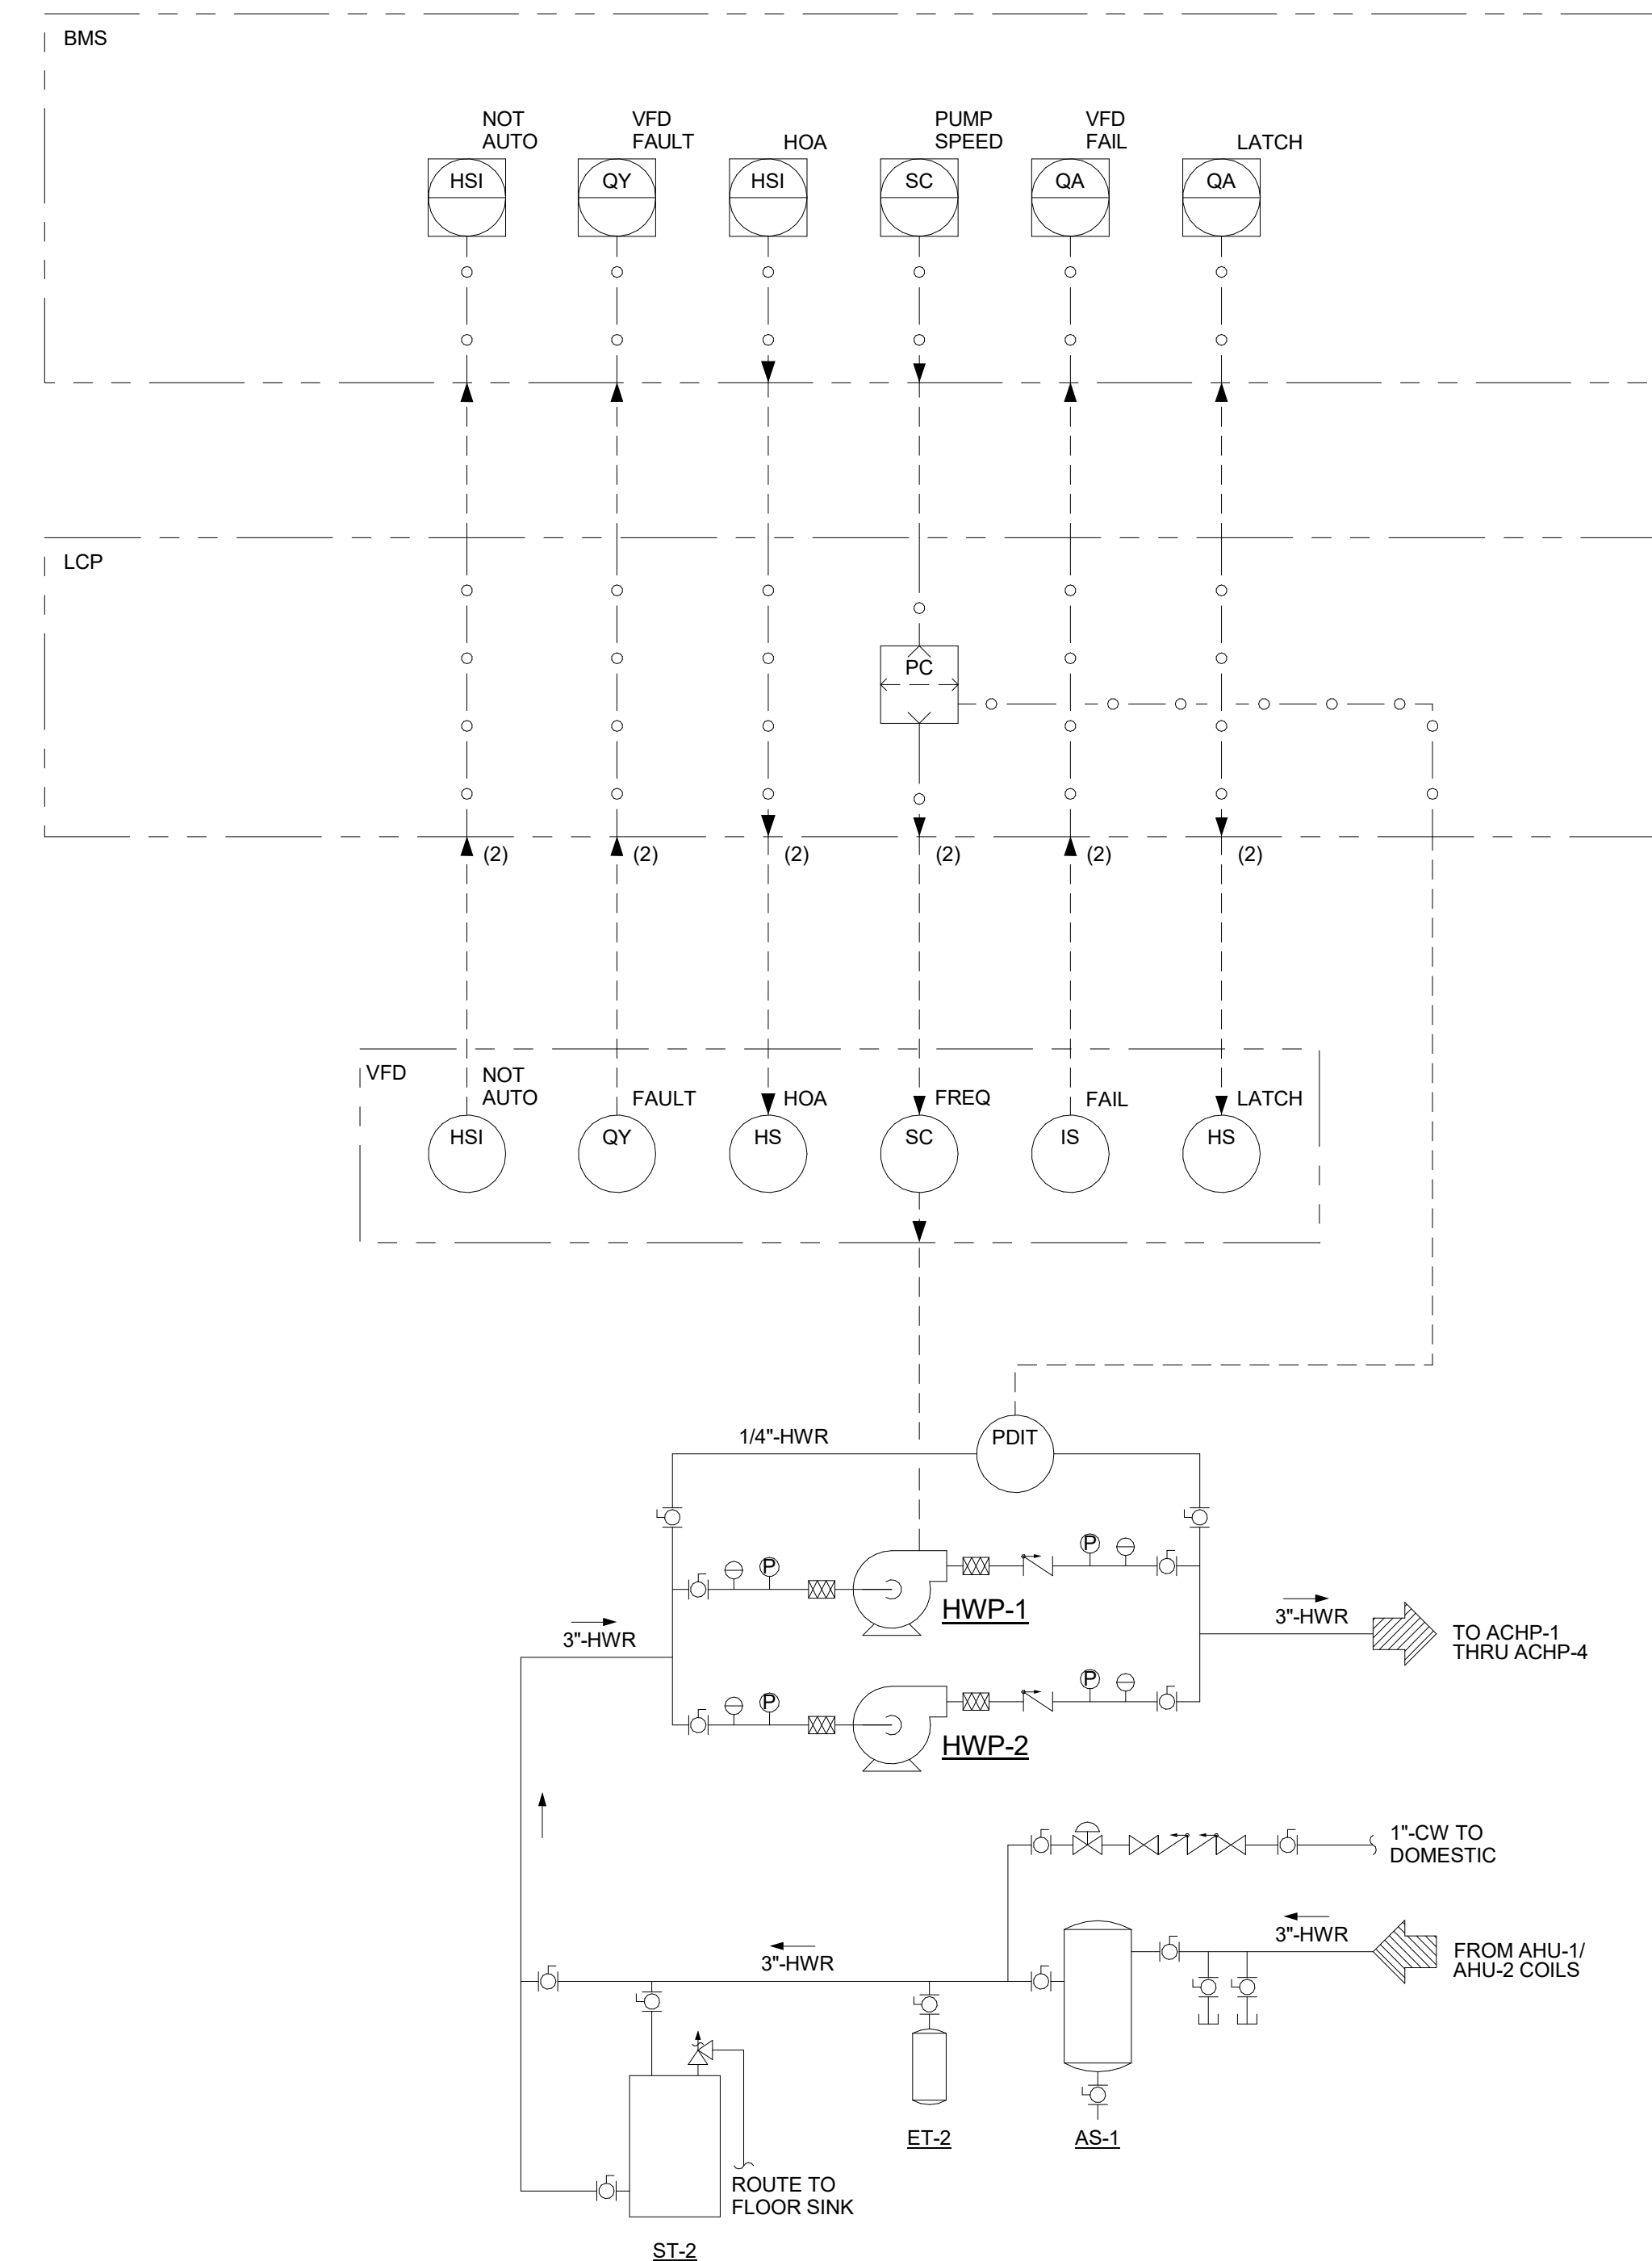








1 AHU-1/AHU-2 P&ID  
M6.02

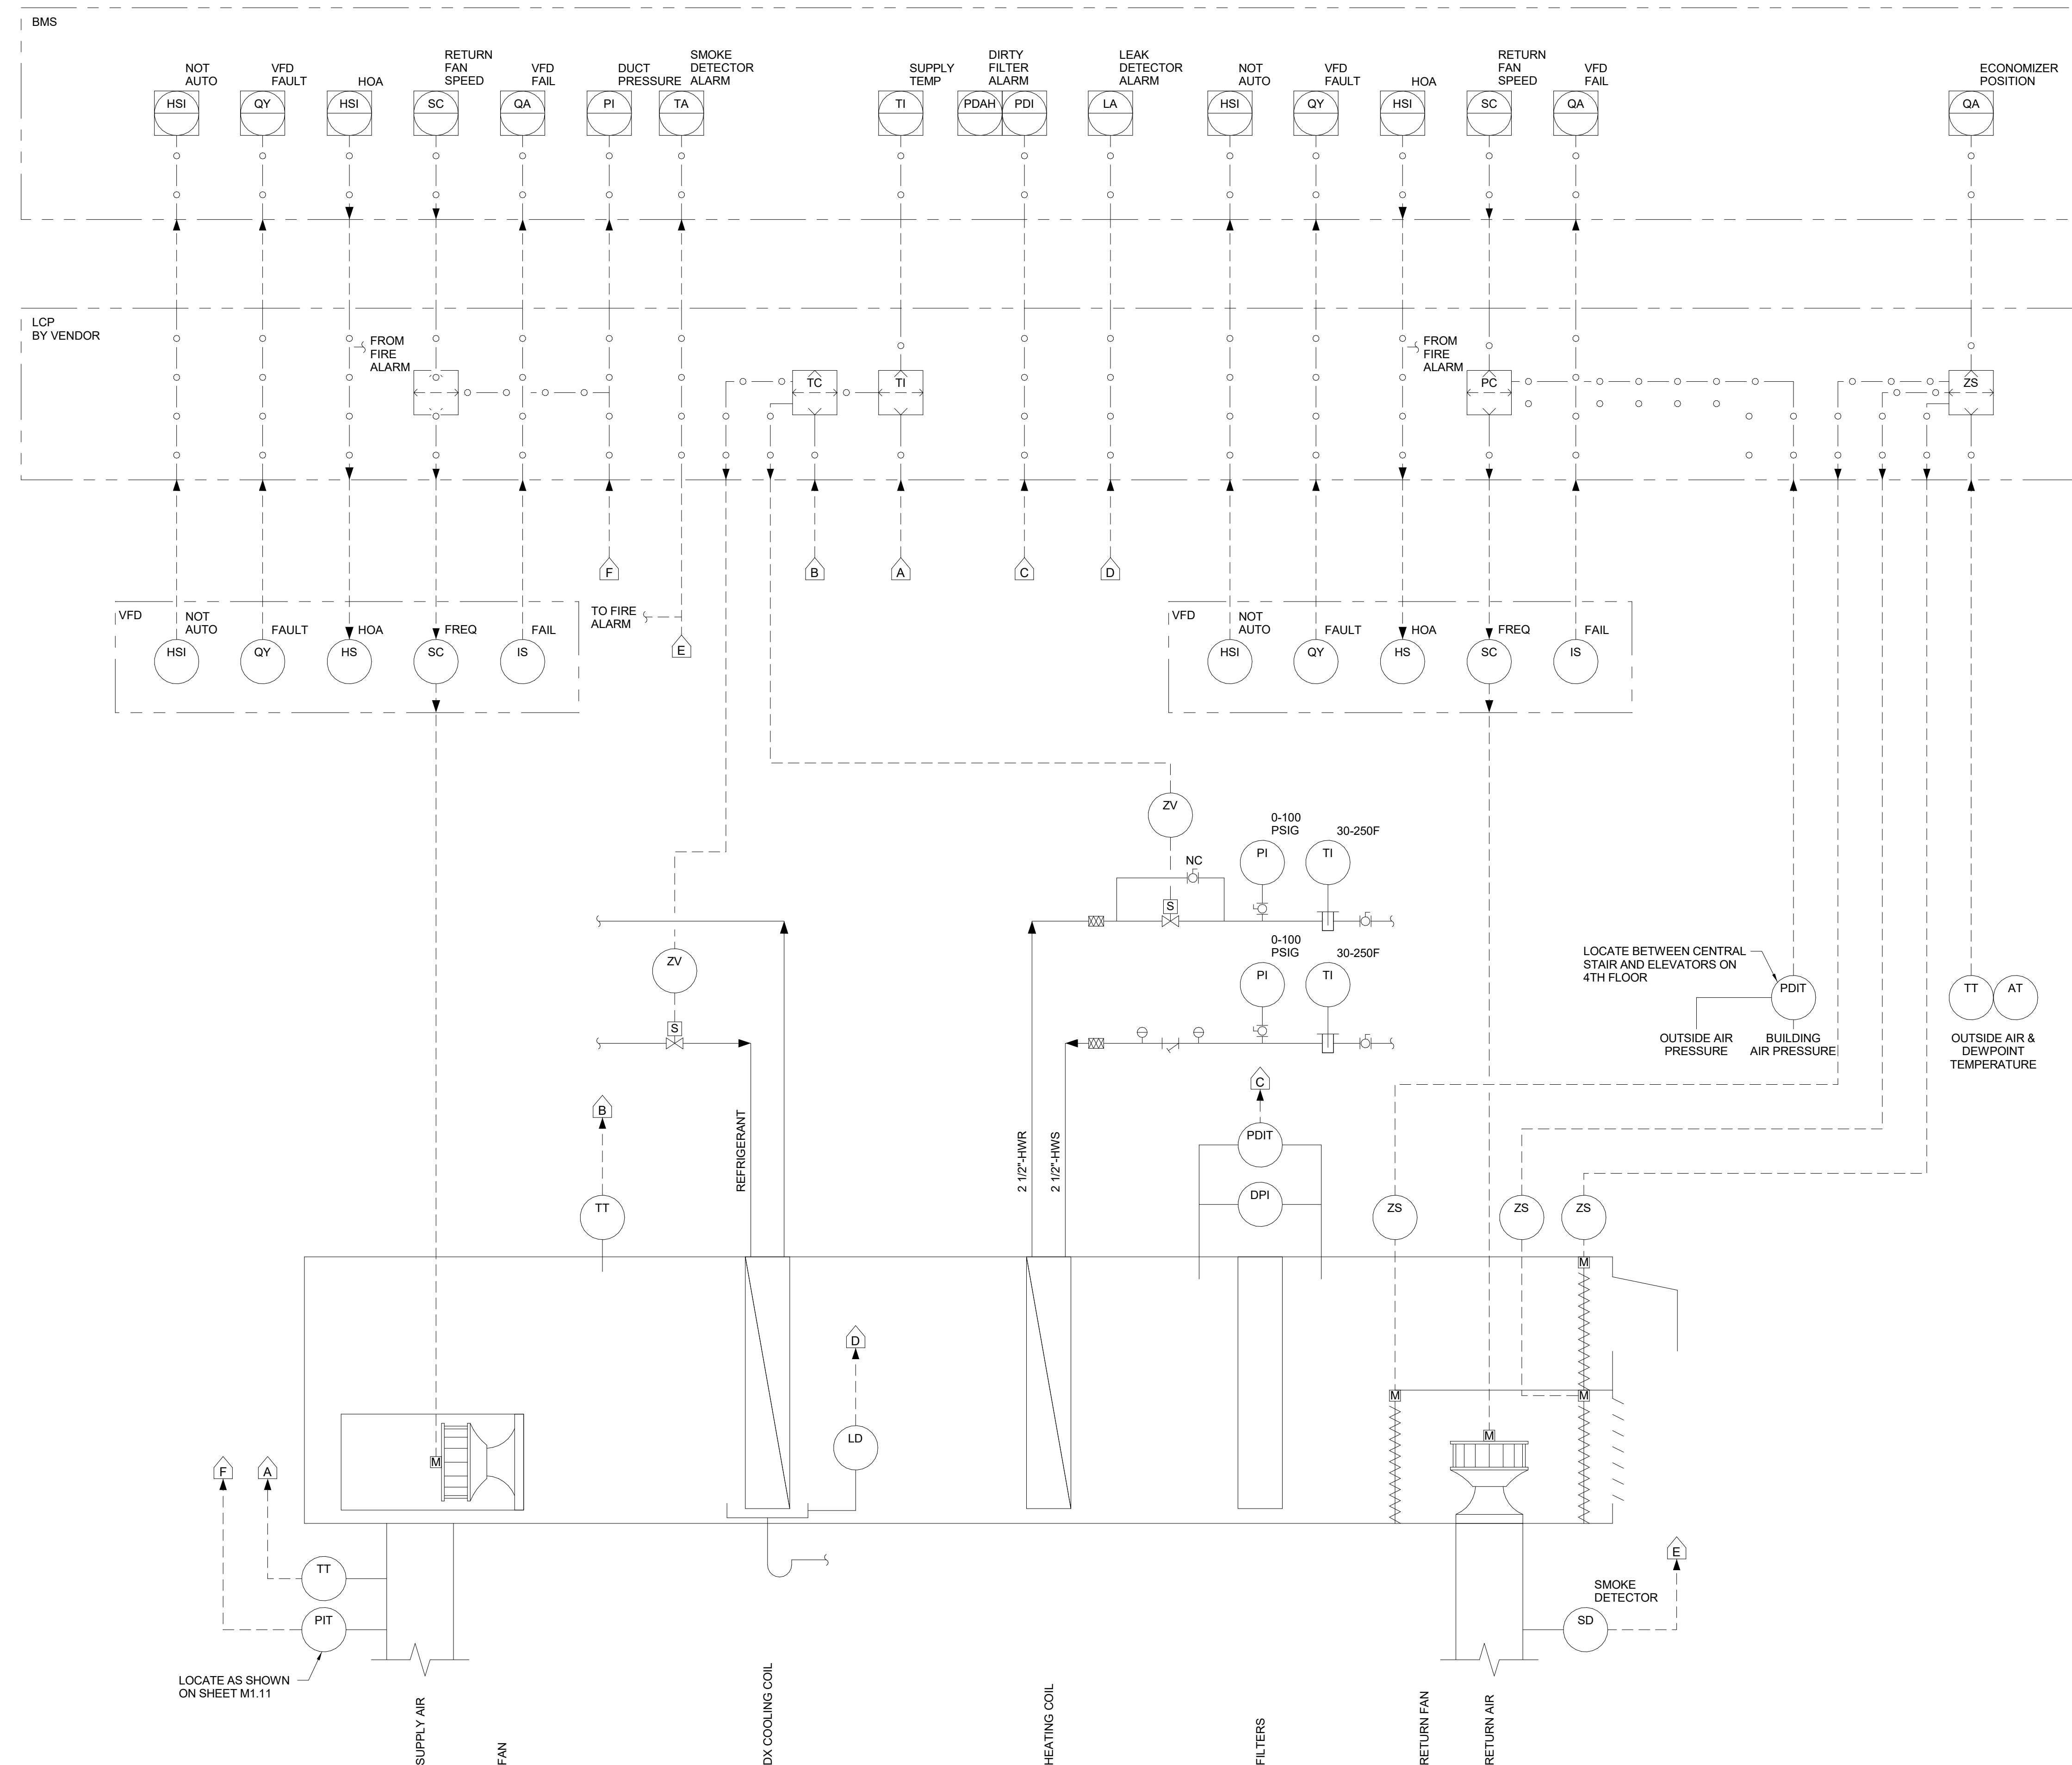

2 HEATING PUMP P&ID  
M6.02


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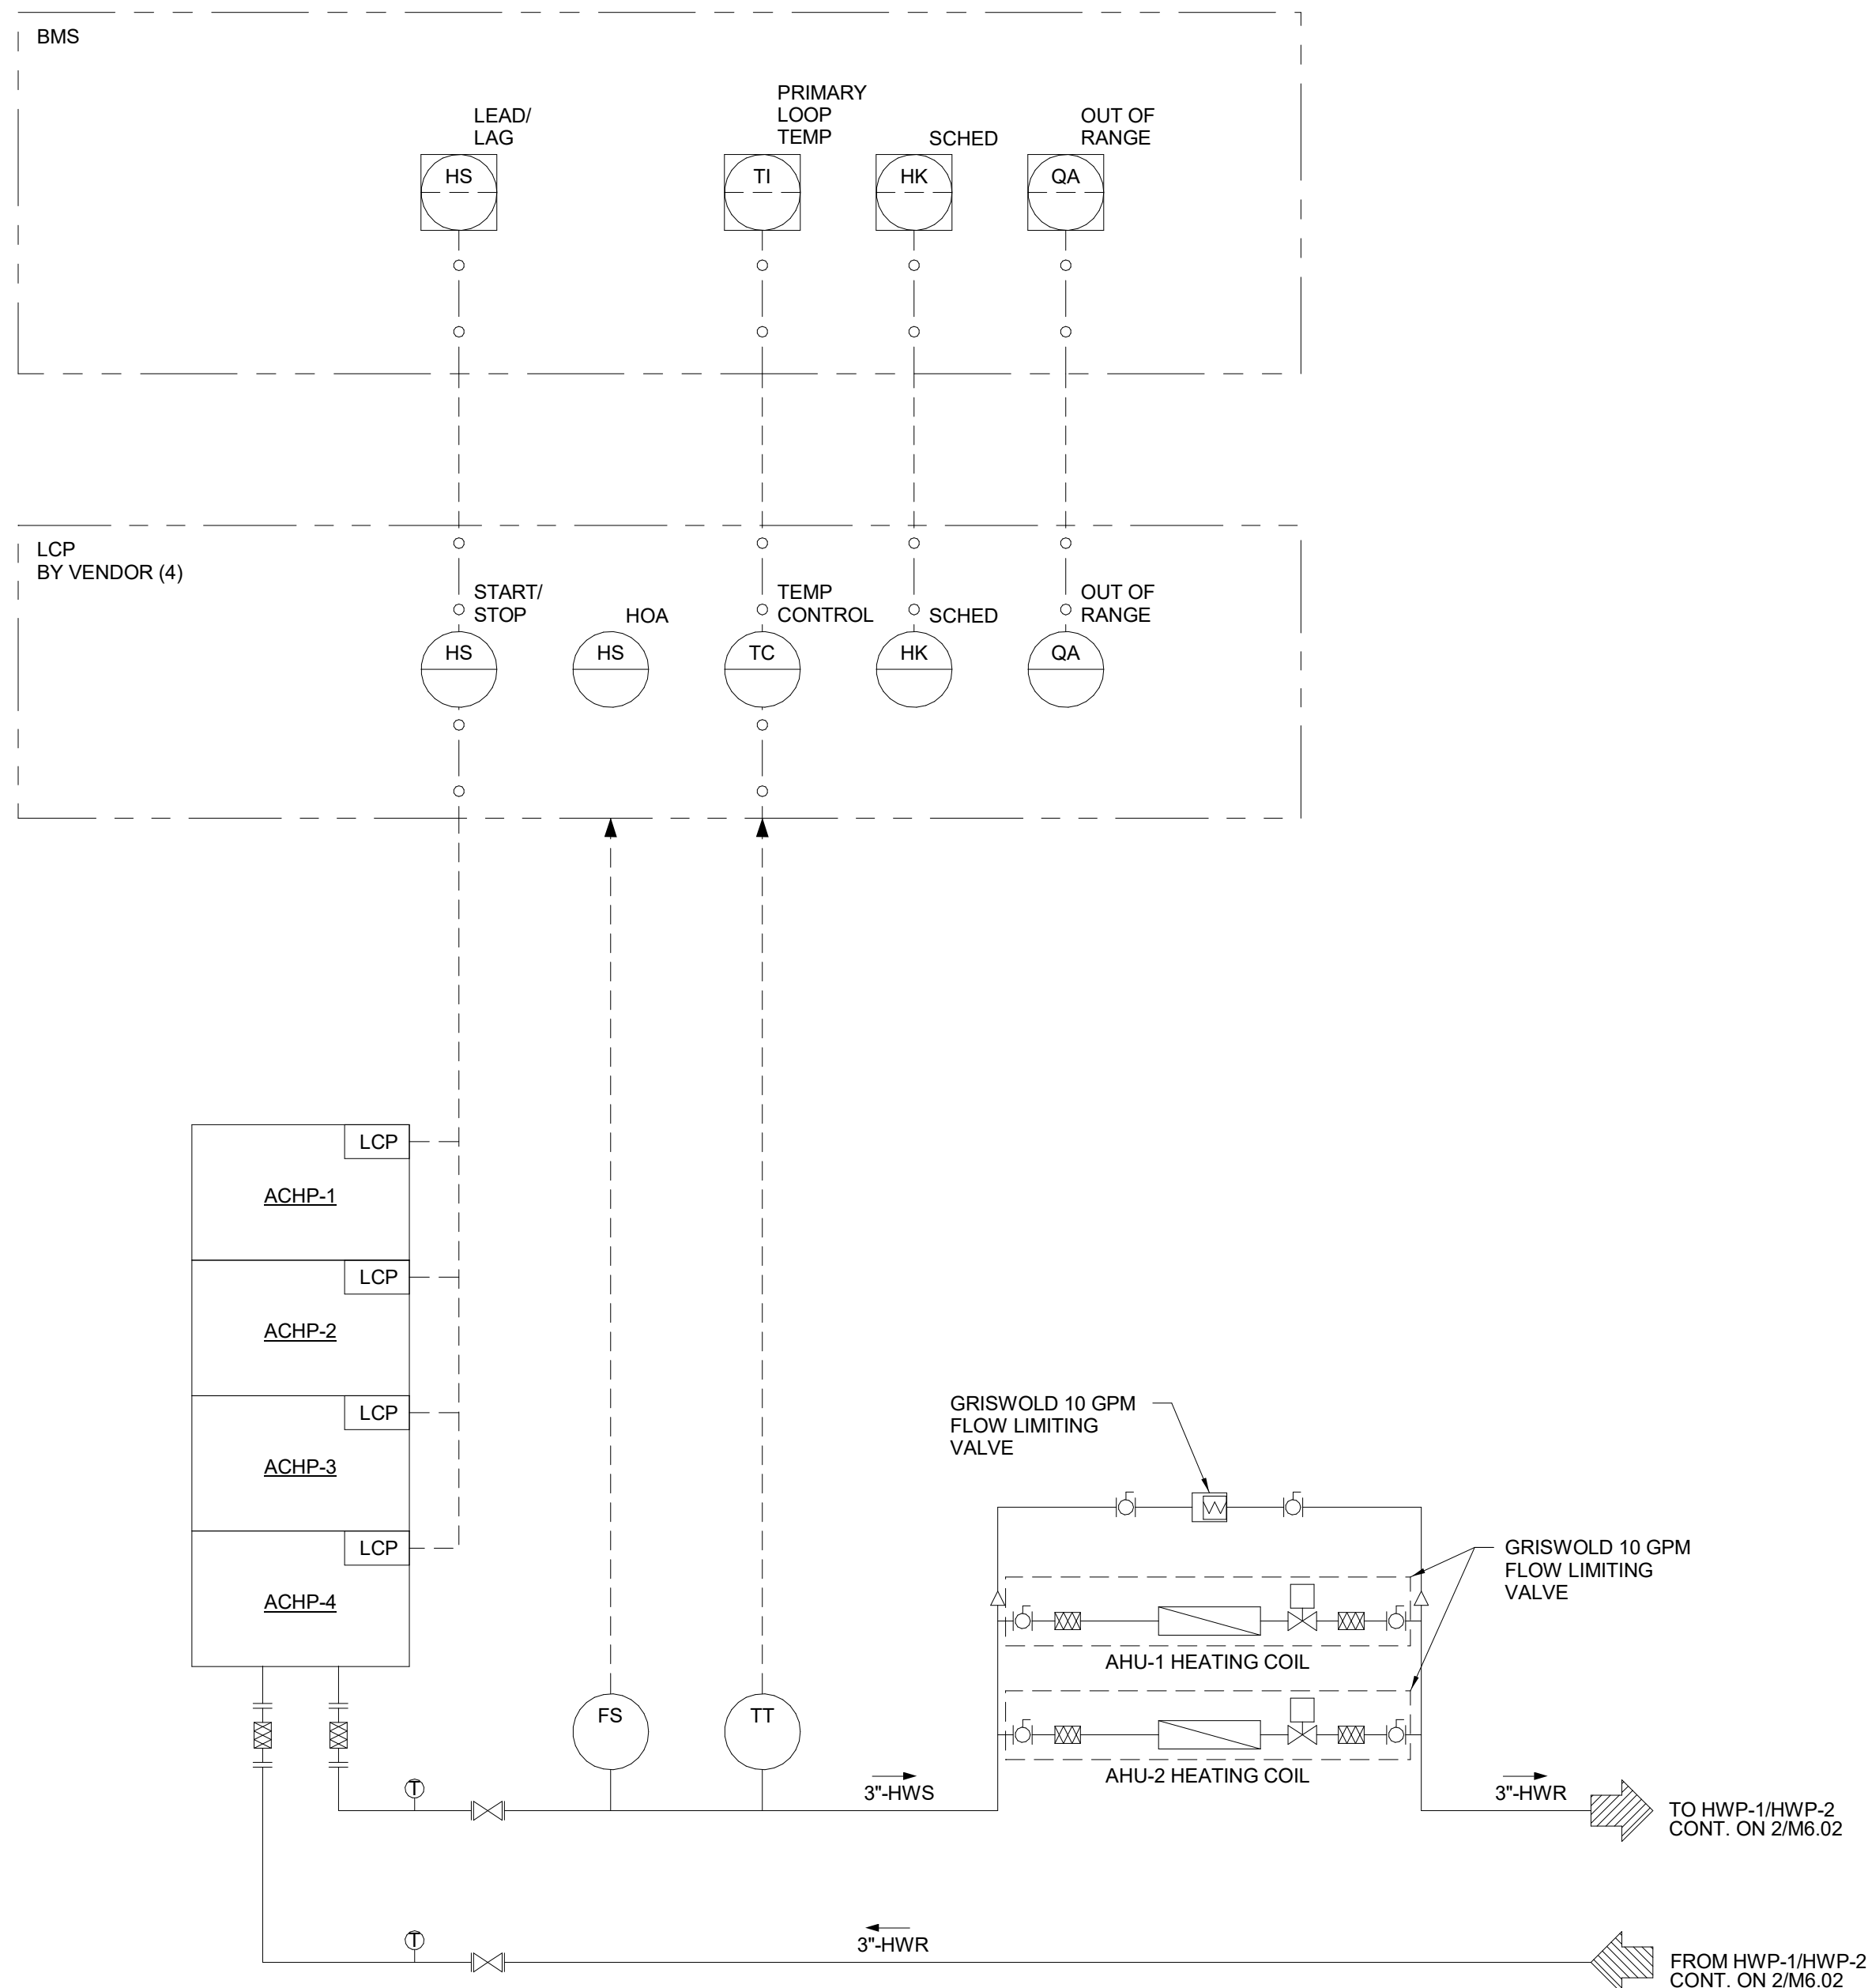
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MECHANICAL P&ID

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M6.02  
Proj No: CC22450B







1 DOAS-1/DOAS-2 P&ID  
M6.03

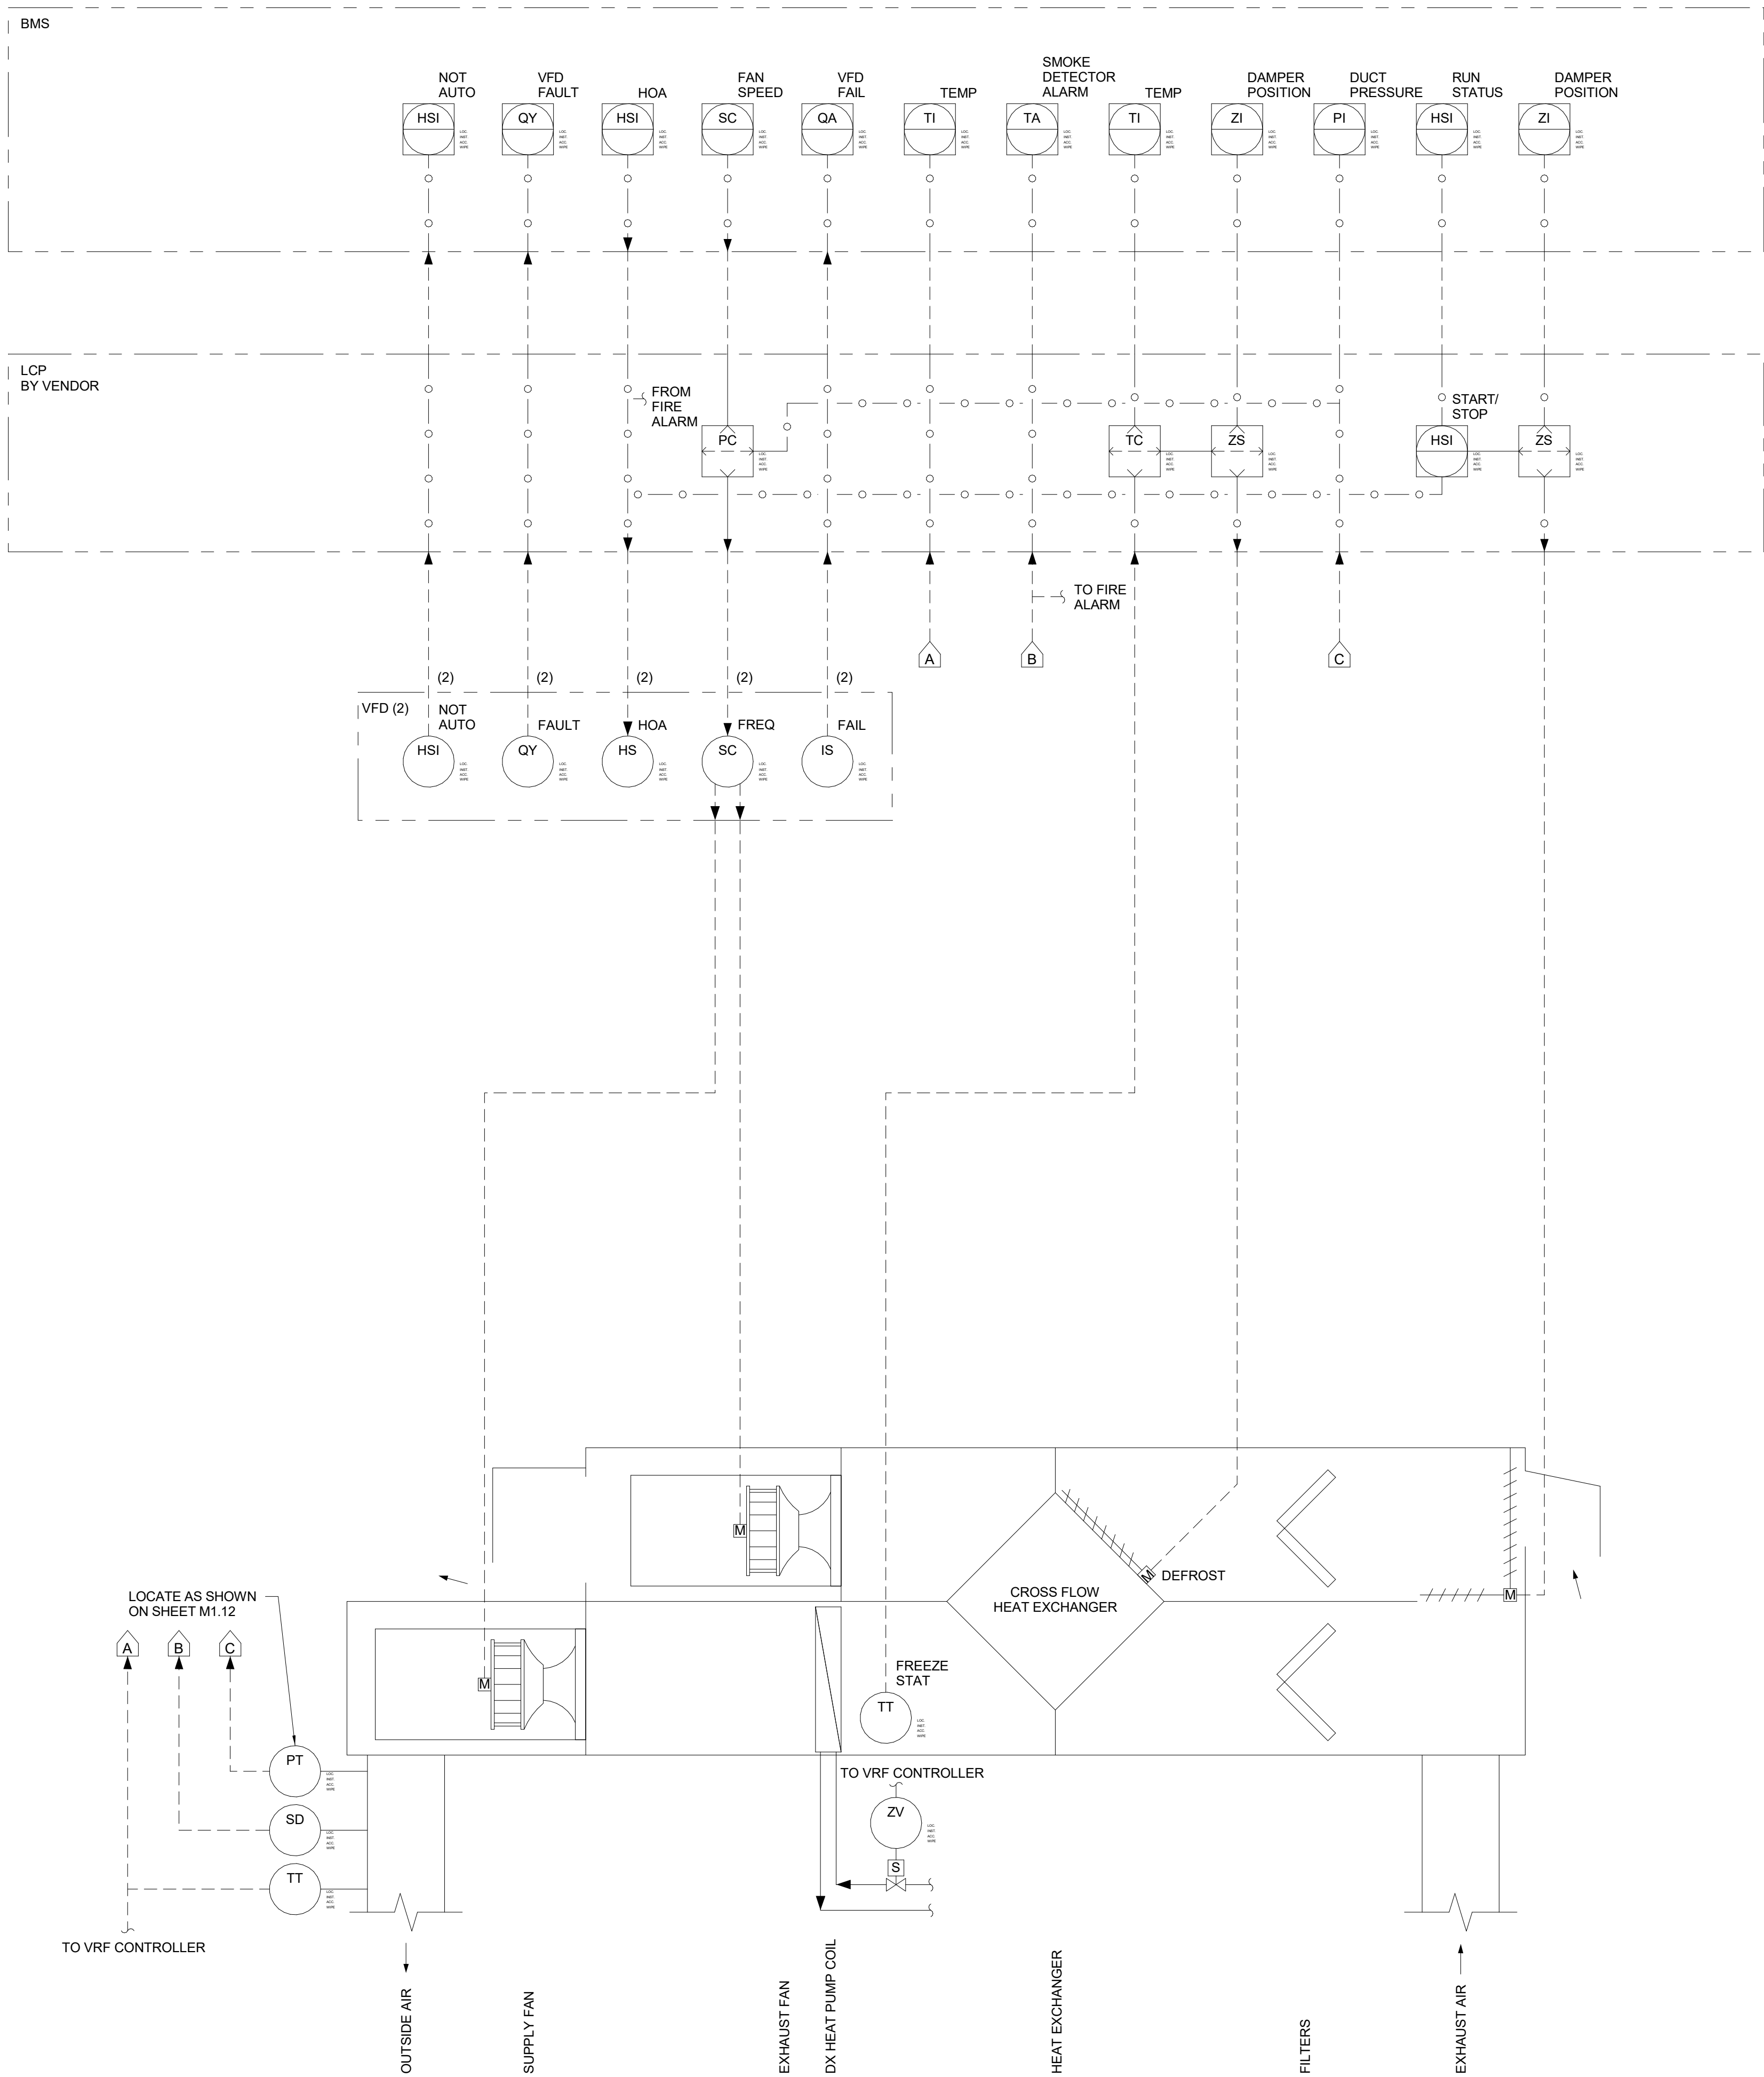

2 ACHP-1 THRU ACHP-4 P&ID  
M6.03

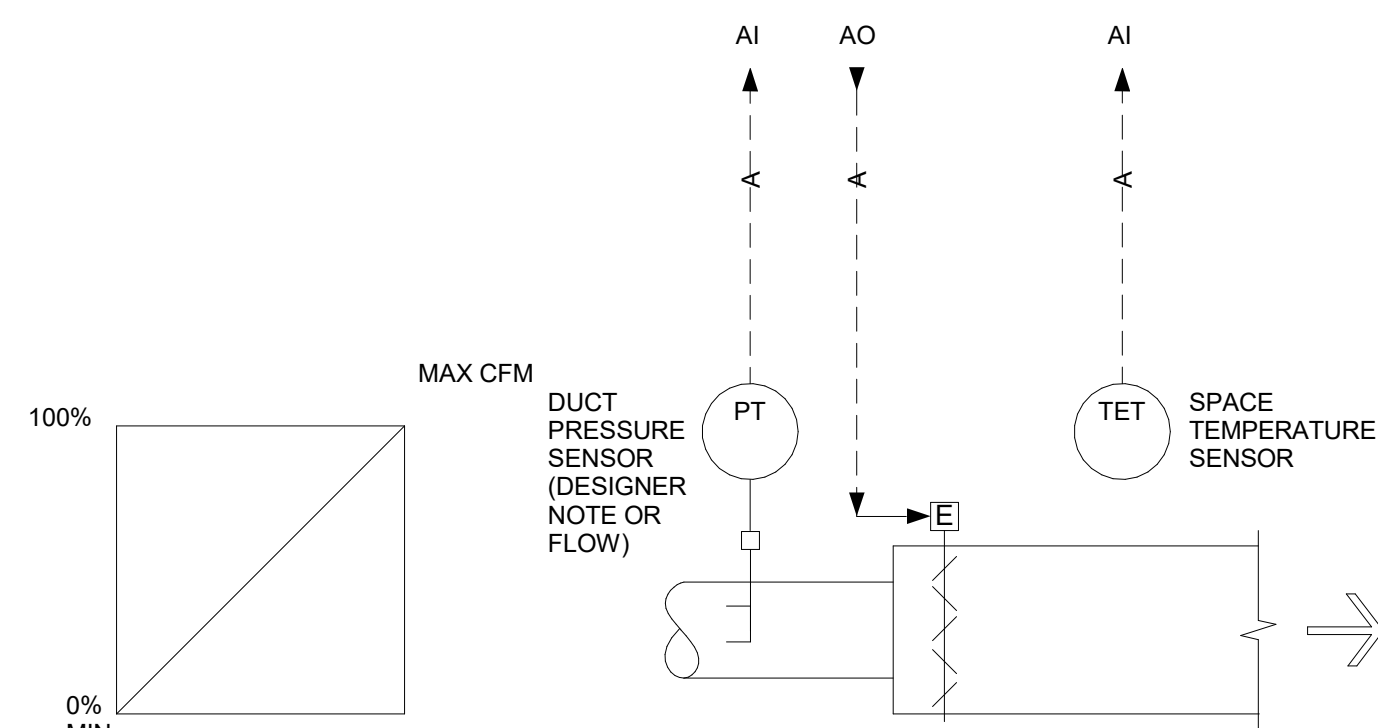

3 TYPICAL VAV TERMINAL CONTROL  
M6.03

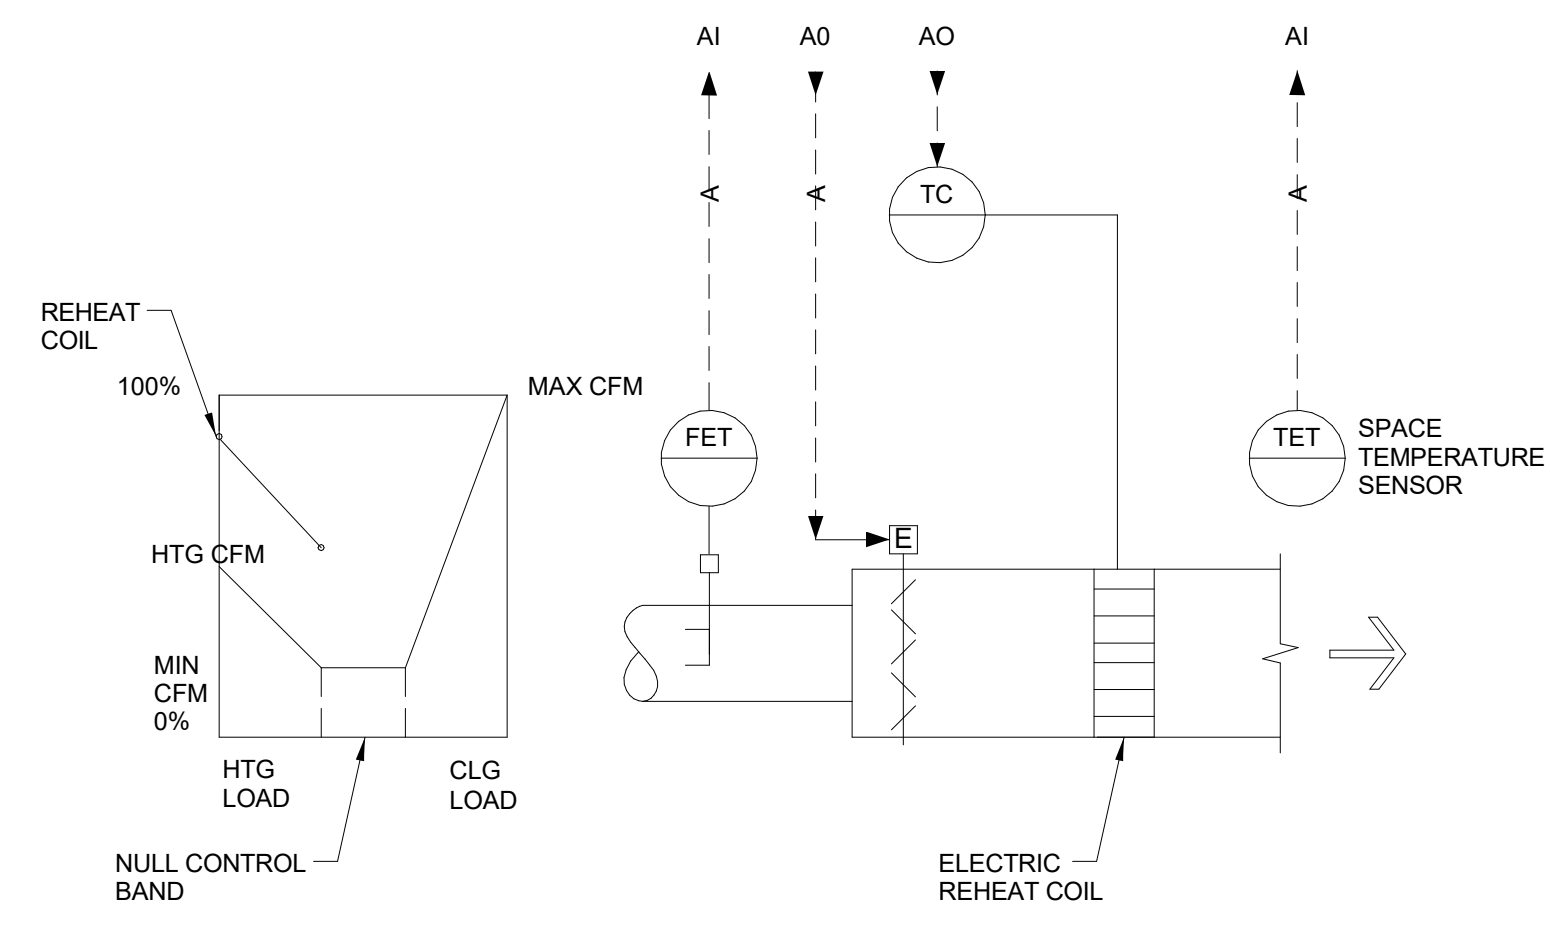

4 TYPICAL VAV TERMINAL REHEAT CONTROL  
M6.03