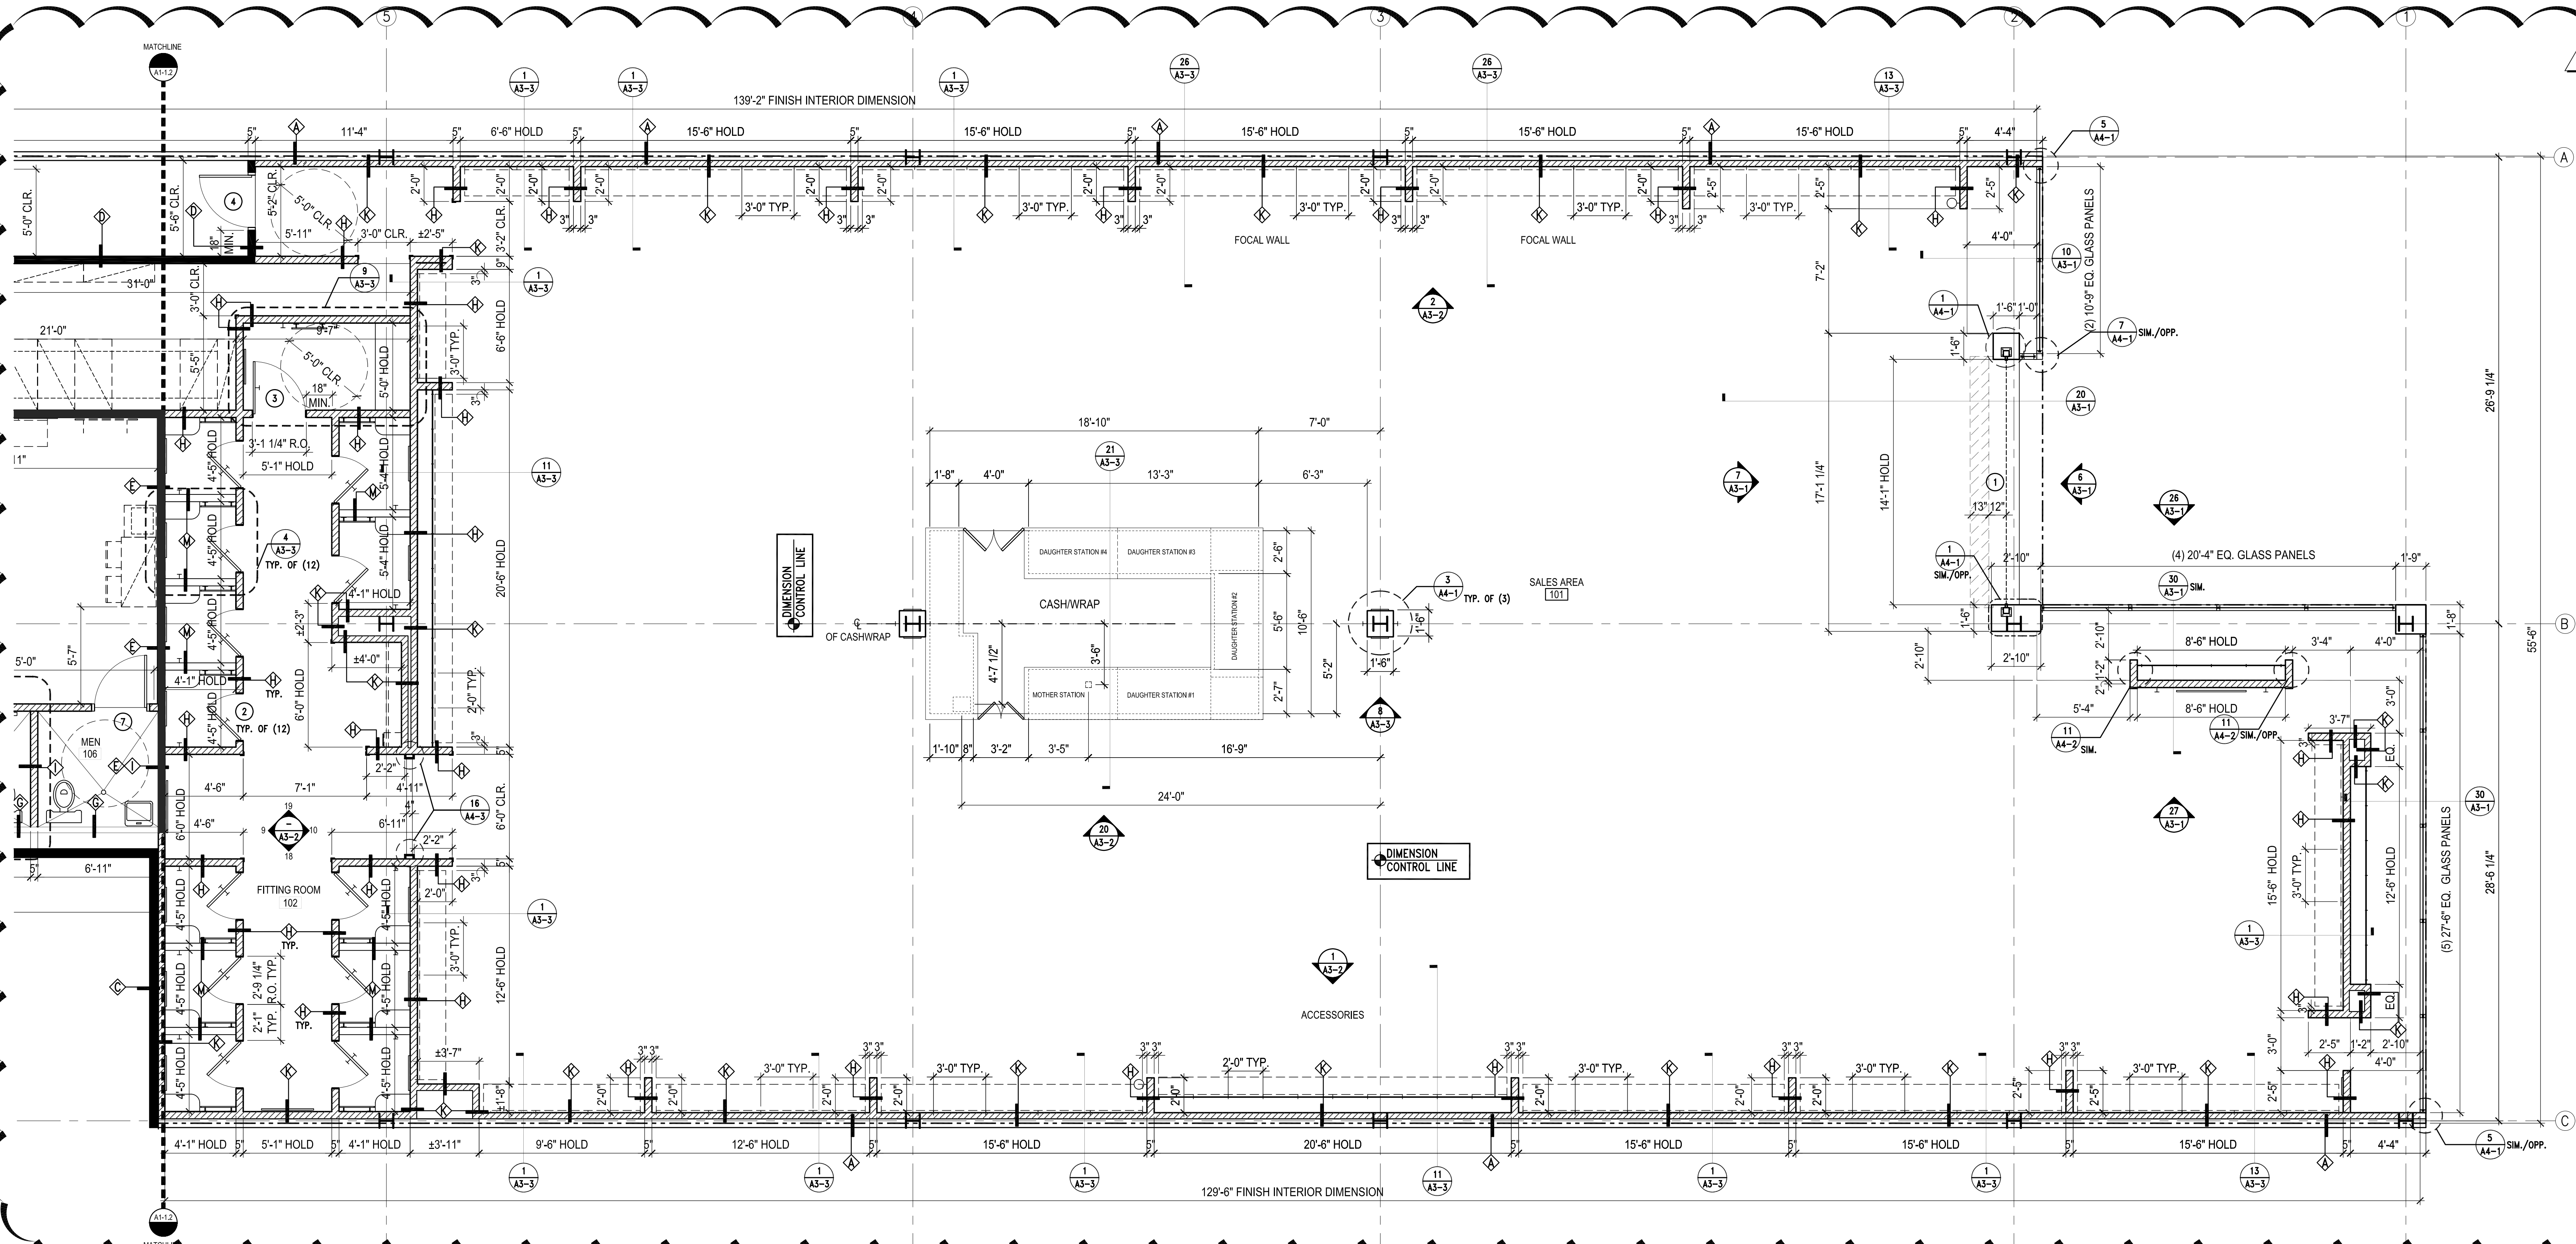


DATE: 042607
JOB NO: 07-1044
DRAWN:
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1 FLOOR CONSTRUCTION PLAN

SCALE: 1/4"=1'-0"

WALL TYPES LEGEND				
SYMBOL	POCHE	RATING	WALL DESCRIPTION	DETAIL
A	[Symbol]	1 HR	EXISTING LANDLORD-PROVIDED DEMISING WALL. GC SHALL MAINTAIN FIRE-RATING. GC SHALL PATCH AND REPAIR DEMISING WALL PROVIDING 5/8" FIRE CODE GYP. BD. AS REQUIRED.	1A4-2 SM. 9A4-2 SM. 18A4-2 SM. 25A4-2 SM. 30A4-2
B	[Symbol]	1 HR	EXISTING LANDLORD-PROVIDED EXTERIOR MASONRY DEMISING WALL. (GC SHALL PATCH AND REPAIR EXISTING WALL AS NECESSARY.) G.C. TO CONFIRM WITH WALL IF INSULATION IS REQUIRED.	5
C	[Symbol]	1 HR	NEW DEMISING WALL STUDS BY LANDLORD. NEW FIRE-CODE GYPSUM BOARD BY TENANTS. GC. NEW METAL STUDS FULL HEIGHT AT 16" O.C. (VERIFY) WITH 5/8" FIRECODE GYPSUM BOARD ON CHARLOTTE RUSSE SIDE. FIRE SEAL AT TOP PER DETAILS.	2A4-2, 9A4-2, 11A4-2, 18A4-2, 25A4-2, 30A4-2
D	[Symbol]	1 HR	NEW 1-HOUR RATED TUNNEL CONSTRUCTION BY GC. GC SHALL PROVIDE 3 5/8" x 20 GA METAL STUDS AT 16" ON-CENTER WITH 5/8" FIRE CODE GYPSUM WALL BOARD ON EACH SIDE AND AT CEILING. 6" x 16 GA METAL CEILING JOISTS AT 16" o.c.	13A4-2, 15A4-2, 27A4-2, 30A4-2
E	[Symbol]	1 HR	NEW FULL HEIGHT WALL. GC SHALL PROVIDE (1) LAYER 5/8" FIRE CODE GYP. BD. ON BOTH SIDES OF 3 5/8" x 20 GA. METAL STUD FRAMING AT 16" O.C. GYP. BD. INSTALLED PER UL DESIGN NO. U465 FOR FULL HEIGHT FLOOR TO STRUCTURAL DECK. RETAIL SALES AREA AND STORAGE/ STOCK ROOM. DRYWALL FULL HEIGHT ON ROOM SIDE PER DETAIL 3A42	3A4-2, 4A4-2, 5A4-2, 9A4-2, 11A4-2, 13A4-2, 18A4-2, 27A4-2

WALL TYPES LEGEND				
SYMBOL	POCHE	RATING	WALL DESCRIPTION	DETAIL
H	[Symbol]	N/A	NEW NON-LOAD BEARING PARTITION. GC SHALL PROVIDE 5/8" FIRE CODE GYP. BD. ON EA. SIDE, OF 3 5/8" x 25 GA. METAL STUD FRAMING TO 6" ABOVE HIGHEST ADJACENT CEILING. BRACE PARTITION AT DOUBLE CEILING CONDITION PER DETAIL. FOR WALL THICKNESS, REFER TO DIMENSION FLOOR PLAN. FOR WALL STANDARD CONDITION, REFER TO DETAIL.	4A4-2, 5A4-2, 8A4-2, 12A4-2, 13A4-2, 16A4-2, 18A4-2, 20A4-2, 27A4-2
I	[Symbol]	N/A	NEW LOAD BEARING PARTITION (STORAGE ABOVE ON CEILING JOISTS). GC SHALL PROVIDE 5/8" FIRE CODE GYP. BD. ON EACH SIDE OF 3 5/8" x 20 GA METAL STUDS FINISH FLOOR. FOR CEILING JOISTS AND FRAMING CONNECTIONS, REFER TO DETAILS REFERENCED.	8A4-2, 13A4-2, 15A4-2, 22A4-2, 26A4-2, 27A4-2
J	[Symbol]	N/A	NEW PLUMBING PARTITION. GC SHALL PROVIDE 5/8" GREENBOARD. BD. ON ROOM SIDE. METAL STUD FRAMING (6" x 20 GA.) AT 16" o.c. PROVIDE NECESSARY BLOCKING AS INDICATED OR REQUIRED.	8A4-2, 13A4-2, 15A4-2, 22A4-2, 26A4-2, 27A4-2
K	[Symbol]	N/A	NEW NON-LOAD BEARING FURRED-OUT PARTITION. GC SHALL PROVIDE 5/8" FIRE CODE GYP. BD. AT ROOM SIDE OF 3 5/8" x 25 GA. METAL STUD FRAMING AT 16" o.c. (FOR WALL STANDARD CONDITION, REFER TO WALL STANDARD DETAIL).	8A4-2, 12A4-2, 13A4-2, 27A4-2
L	[Symbol]	N/A	NEW PARTIAL HEIGHT PARTITION. GC SHALL PROVIDE 5/8" FIRE CODE GYP. BD. ON EACH SIDE AND ON TOP OF 3 5/8" x 25 GA. METAL STUD FRAMING AT 16" o.c. HEIGHT IS 7'-6" AFF. UNLESS OTHERWISE INDICATED ON FLOOR AND CEILING PLANS OR ELEVATIONS.	6A4-2, 13A4-2
M	[Symbol]	N/A	NEW PARTIAL HEIGHT PARTITION. GC TO PROVIDE 6'-6" AFF TO TOP AND BOTTOM AT 1'-0" AFF. PROVIDE ONE LAYER 5/8" FIRE CODE GYP. BD. ON EACH SIDE, TOP AND BOTTOM OF 3 5/8" x 25 GA. METAL STUD FRAMING AT 16" o.c. PROVIDE BACKING AS INDICATED.	7A4-2, 13A4-2

GENERAL NOTES - FLOOR CONSTRUCTION PLAN
A. IT IS NOT ANTICIPATED THAT MORE THAN FOUR EMPLOYEES WILL BE WORKING AT ANY ONE TIME.
B. FOR FLOORING/ FINISHES AND KEYNOTES, REFER TO SHEETS A1-2.1/A1-2.2
C. FOR FURNISHINGS, FIXITURING, AND EQUIPMENT, REFER TO SHEETS A1-3.1/A1-3.2
D. FOR WALL TYPES, LEGENDS AND DOORS SCHEDULE, REFER TO SHEETS A1-1.1/A1-1.2

- NOTES:**
- HOLD DIMENSION TO BE EXACT FINISH DIMENSION AS NOTED ON PLANS. (NO EXCEPTIONS).
 - THE GENERAL CONTRACTOR SHALL NOTIFY THE PROJECT COORDINATOR/ARCHITECT OF ANY AND ALL DISCREPANCIES PRIOR TO BEGINNING THE CONSTRUCTION PROCESS (FOLLOWING DEMOLITION OF SPACE). OVERALL DIMENSIONS AND HEIGHT CLEARANCES SHALL BE VERIFIED PRIOR TO BEGINNING THE CONSTRUCTION PROCESS.
 - G.C. TO VERIFY, PRIOR TO BID SUBMITTAL, WITH LANDLORD WHAT DEMISING FINISHES G.C. WILL BE FURNISHING AND INSTALLING.
 - G.C. TO VERIFY WITH LANDLORD LEASE LINES PRIOR TO CONSTRUCTION.

DOOR SCHEDULE									
DOOR NO.	DOOR TYPE	DOOR SIZE (WIDTHxHEIGHTxDPTH)	DOOR MATERIAL	FRAME MATERIAL	DETAILS	RATING (MIN.)	HARDWARE GROUP	REMARKS	
1	A	14'-1"x 10'-4" (VERIFY OPENING SIZE)	ALUM	ALUM	27A4-1	1A4-1	23A4-3	N/A	HW-2
2	C	2'-8" x 6'-0" x 1 3/4"	HCHB	HM	N/A	27A6-1	N/A	N/A	HW-9
3	C	3'-0" x 6'-0" x 1 3/4"	HCHB	HM	N/A	27A6-1	N/A	N/A	HW-9
4	B	3'-0" x 7'-0" x 1 3/4"	SCHB	HM	17A4-1 SIM.	17A4-1	27A4-3	60 MIN.	HW-4
5	B	3'-0" x 7'-0" x 1 3/4"	SCHB	HM	16A4-1 SIM.	16A4-1	27A4-3	60 MIN.	HW-6
6	B	3'-0" x 7'-0" x 1 3/4"	SCHB	HM	16A4-1 SIM.	16A4-1	27A4-3	N/A	HW-8
7	B	3'-0" x 7'-0" x 1 3/4"	SCHB	HM	16A4-1 SIM.	16A4-1	27A4-3	N/A	HW-8
8	B	3'-0" x 7'-0" x 1 3/4" (E)	(E)	(E)	(E)	18A4-1	60 MIN.	HW-3	1,3,4,5,6,13

SYMBOLS: T.G.= TEMPERED GLAZING SCHB= SOLID CORE/HARDBOARD FACES W.D.=WOOD GL= GLASS ALUM= ALUMINUM H.M.= HOLLOW METAL HCHB= HOLLOW CORE/HARDBOARD FACES (EXIST. OR (E) = EXISTING)

DOOR NOTES:

A. FOR DOOR HARDWARE, REFER TO DOOR SPECIFICATION AND HARDWARE GROUPS ON SHEET SP-1.
B. FOR ADA DOOR CLEARANCE REQUIREMENTS REFER TO DETAIL 18A3-3

DOOR TYPES

A. ROLL-UP GRILLE 1/8" (NATURAL ANODIZED ALUM.)
B. PAINT OIL-BASED 1/4" SEMI-GLOSS
C. PLASTIC LAMINATE 1/4"

FOR PUCK SEE 22A6-1.

DOOR JAMB, SEE 27A6-1.

REVISIONS
FINAL ISSUE: 042607
DELTA 5: 031008

FLOOR CONSTRUCTION PLAN
SHEET NUMBER


A1-11

REVISIONS	
FINAL 05/01	04.26.07
DELTA 1:	09.18.07
DELTA 4:	01.02.08
DELTA 5:	03.10.08

REFLECTED
CEILING PLAN
(RCP)

SHEET NUMBER

A2-1.2

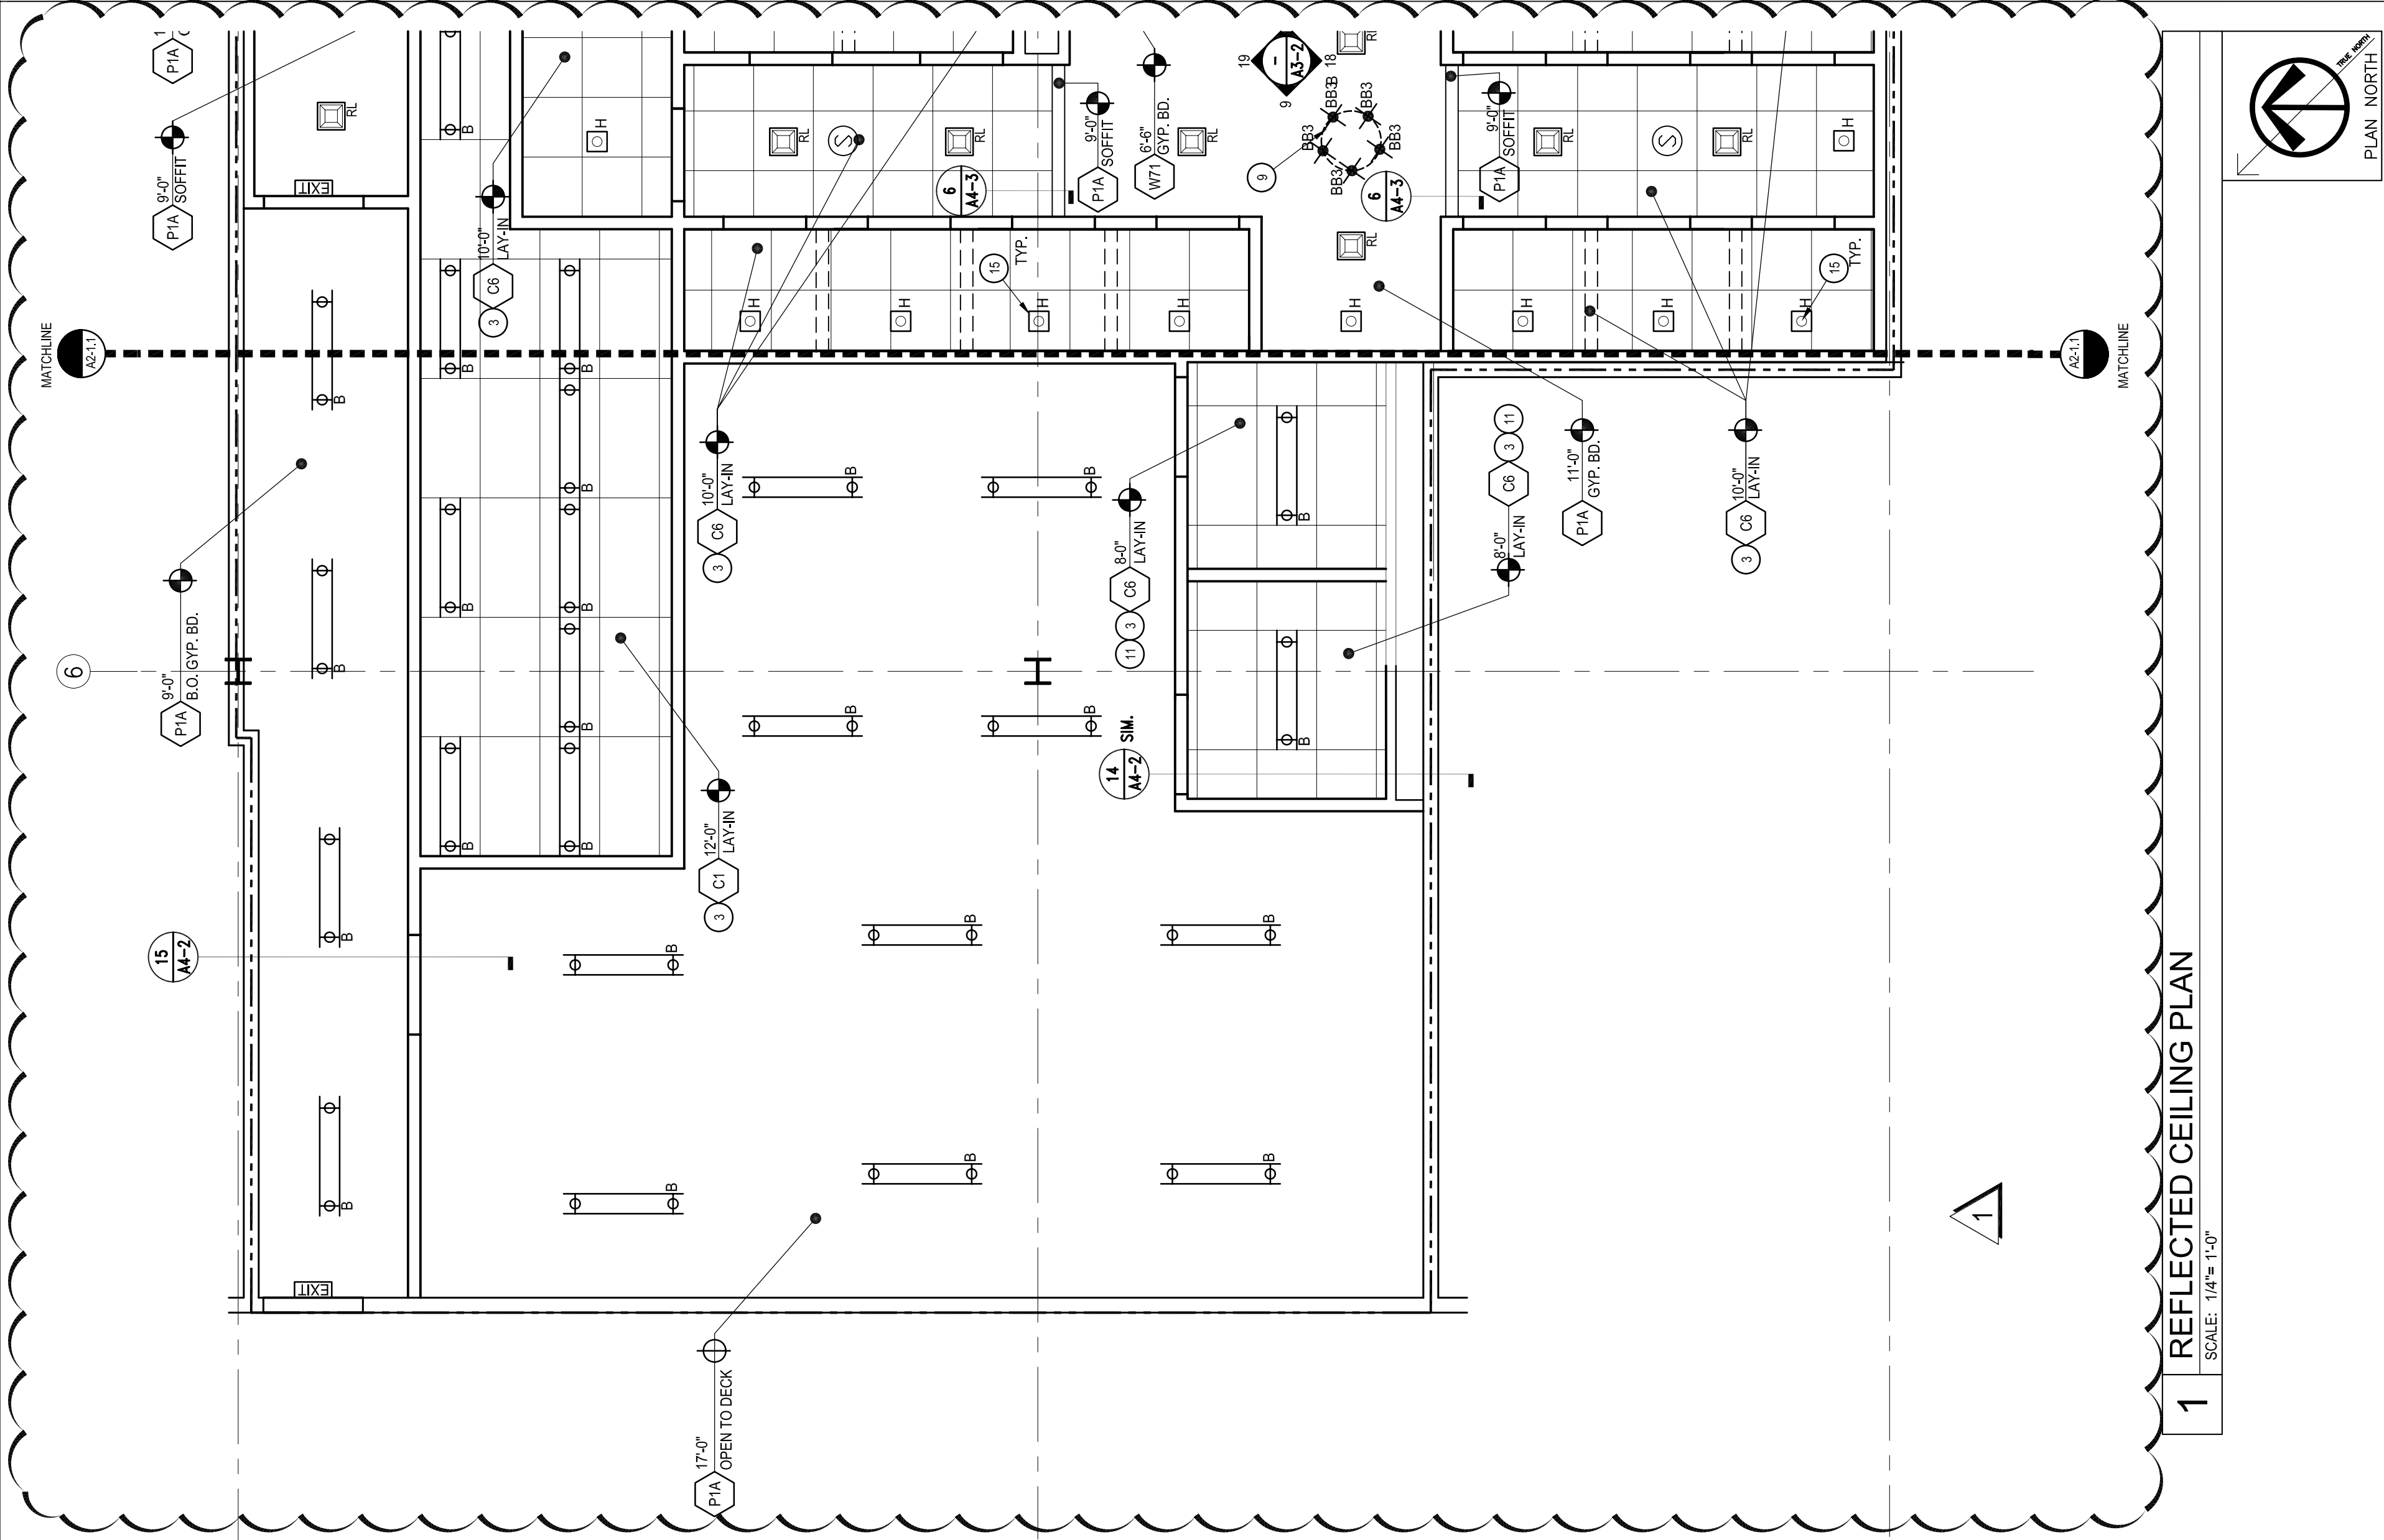

FOR LIGHT FIXTURE LEGEND
SCHEDULE, CEILING FIXTURE
SCHEDULE, REFLECTED CEILING
GENERAL NOTES, AND CEILING
PLAN KEY NOTES.
SEE SHEET A2-1.1.