## **LUCAS**

# RESIDENTIAL DEVELOPMENT - STAGE E2 CITY OF BALLARAT

#### CONSTRUCTION NOTES (CITY OF BALLARAT)

#### SITE MANAGEMENT

Prior to commencement of works on site, the contractor must ensure that all matters relating to the Occupational Health and Safety Act 2004, including all relevant regulations, have been addressed. In particular, the required notifications must be conveyed to the Victorian Workcover Authority - Health & Safety division with respect to trenching operations. Details of the contractors occupational health & safety procedures must be lodged with the Superintendent prior to commencement of works.

- All native trees and shrubs to be retained unless road construction necessitates their removal or removal is directed by the
  engineer. A town planning permit is required for the removal of native trees and/or vegetation. The removal or retention of
  any existing trees must be in accordance with the approved landscape plan, or else approval will be required from the City
  of Pullars Indexense approvals office.
- Existing dams or watercourses to be excavated to a firm base and backfilled as specified. Consulting engineer to be notified when the dam or watercourses are excavated to a firm base. No filling is to be placed prior to date being inspected and levels taken. Backfilling is to be carried out to the satisfaction of the Superintendent and Council Works Supervisor.
- 4. Prior to commencement of works, the contractor must submit a Construction Management Plan (CMP) to the Superinlendent for approval. The contractor must comply with the recommendations of the Environment Protection Authority publication No.275 "Construction techniques for sediment pollution control". Appropriate sitlation control is to be maintained throughout the construction and maintenance period of the works.

#### GENERAL

- All levels are in metres to Australian Height datum and taken from Level Plan by Beveridge Williams & Co. Ptv Ltd.
- 6. All works to be carried out in accordance with AS2124-1992 General Conditions of Contract, City of Ballarat and Infrastructure Design Manual (IDM) current specification and standard drawings and to the satisfaction of the Superintendent and City of Ballarat works supervisor. The contractor shall ensure that they are conversant with all current revisions, amendments and updates that have been made that have been made to these standards.
- 7. The Superintendent, Council and all service authorities should be notified by the contractor, in writing, seven days prior to
- All existing services shall be confirmed to have been located prior to commencement of works. Where services have not been previously proven or located the Contractor shall make allowance or be satisfied that construction in accordance with the design can be achieved.
- Where works are in the vicinity of existing services these services are to be located and the various authorities notified prior
  to the commencement of works.
- The contractor shall erect and maintain all shoring, planking and strutting, dewatering devices, barricades, signs, lights, etc., necessary to keep works in a safe and stable condition and for the protection of the public.
- 11. Before commencement of works on trenches in excess of 1.5m deep, the civil contractors construction supervisor must give notice in writing of such proposals to Worksafe Victoria in accordance with Part 5.1, Division 4 of the Occupational Health & Safety regulations (2007) and undertake safety precautions in trenching operations in accordance with Workcover's Code of Practice (1988)
- 12. Lots to be graded (1 in 200 min slope) & left clean to the satisfaction of the engineer. Finished levels to be compatible with
- 13. On completion the contractor is responsible for the removal of all rubbish and spoil from site. No surplus trees, vegetation or
- 14. Reserves to be free draining and to be left in a condition satisfactory to the Superintendent and City of Ballarat works
- 15. All TBM's and control points are to be maintained and protected at all times during construction. Should any marks be disturbed, the contractor will immediately notify the consultant to arrange re-instalement at the contractors expense.

#### EARTHWORKS

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- All areas shown on the drawings to be cut or filled are to be stripped of topsoil and all topsoil must be stockpiled on site.
- 17. Upon completion of the bulk earthworks topsoil is to be spread to a depth of 100mm over the nominated area and graded to finished levels shown on the drawings with a minimum slope of 1 in 200.
- 18. Batters to be 1 in 5 for fill and 1 in 5 for cut unless noted otherwise.
- 19. All nature strips and batters shall be covered with 100mm min. depth topsoil and seeded with an approved seed.
- Filling in all properties and road reserves is to be carried out using approved clay fill. Top soil and all vegetable matter to be stripped from site prior to filling. All filling to be carried out in 150mm layers and compacted to 95% of max dry density.
- 21. Importing Fill: All imported fill must be tested by a NATA approved laboratory to ensure it is suitable for use on site, and any contaminates are within accepted levels. Under No circumstances should fill material enter or leave the site without the permission of the Superintendent or prior to it being appropriately tested.
- 22. All fill material shall be clean, uniform and free of organic matter and meet requirements of AS 3798-2007 "Guidelines on
- 23. Fill material should be placed in layers of uniform thickness, deposited systematically across the fill area. The contractor must excavate or "box" into the existing surface at the edge of fill to provide a suitable junction with the existing surface and to avoid feathered edors.
- Prior to disposal of excess spoil the truck route and disposal location is to be approved by the Superintendent prior to commencing to dispose of spoil.
- All vehicles transporting fill material to and from the site must have appropriate measures in place to ensure that material
  does not get onto roads and into stormwater systems and natural waterways.
- 26. Cut batters behind vehicular accesses must not exceed maximum grade of 1 in 8.

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- Before any loose layer of fill is compacted, the material and its moisture condition should be as uniform as is practicable throughout its depth
- 28. If there is a delay in the placement of subsequent fill layers, previously accepted layers should conform with the specification before further fill its placed. If these layers have wetted up or dried out, they may inhibit compaction or cause heaving of subsequent layers. In these instances, drying or wetting of the fill by the contractor will be required to achieve optimum compaction.
- All lots are to be brought to a finished surface level and top soiled to ensure that front boundaries are a minimum of 130mm above the top of kerb.

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- The maximum particle size of any rocks or other lumps within the fill layer, after compaction, should not exceed 100mm of two-thirds of the compacted layer thickness.
- 2. Fill batter faces are to be overfilled and cut back, the trimmed and compacted face should have a roughened surface to 67.

31. Fill is to be tested in increments of depth not greater than 500mm.

- The surface of all fill layers must be shaped to provide drainage and to prevent ponding.
- All fill to be compacted to that shown or 95% standard density or better. Moisture content must be in the range of -10% to
- Where fill placement is less than 200mm stripping of topsoil may be deleted,in which case the contractor shall remove all
  organic matter from existing surface prior to placing topsoil.
- Filling to be completed prior to sewer and drainage construction, unless approved by the Superintendent and relevant Authority.

#### ROADWORKS

- 7. 100mm dia. agricultural pipe drains (Refer BCC SD-D2-1) to be placed behind kerb and channel or as directed by Superintendent and at minimum grade of 1 in 250.
- 38. The water conduit offset from the lot boundary is given on the water reticulation plan. The contractor must construct conduits to accord with the given offset and ensure that the concreter marks the kerb and footpath exactly above the conduit.
- All footpaths and shared pedestrian/bicycle paths are to be 125mm thick concrete as per IDM Standard Drawings SD205, 210, 215, 220 and 225.
- Telcommunication contractor to be notified seven (7) days prior to concrete works being placed.
- Electrical distribution pits within footpaths are to be a minimum of 300mm from the edge of the path. Concrete is to be placed around distribution pits to a minimum depth of 200mm.
- All street signs to be constructed and erected to current City of Ballarat standards including logo. Sign to be placed in 300Ø hole 500mm deep 15MPa concrete to 100mm below FSL of nature strip.
- 43. Traffic control signs, markings & delineators to be installed in accordance with AS1742.2. All line marking is to be long life road marking, with longitudinal lines in thermoplastic and transverse markings in cold applied.
- 44. Kerb transition to take place in the minor street over a 1.0m length from either the tangent point or TP pit.
- Existing road works to be reconstructed as required to provide, without discontinuity, a connection in accordance with design levels and grades.
- Tactile ground surface indicators (TGSI) are to be installed at all pram crossings and pedestrian cross points in accordance
  with AS1428.4: 2002 and BCC Standard Drawings SD-C4.

#### PAVEMEN

- Pavement shall be constructed in accordance with construction plans, IDM and City of Ballarat Specifications and Standard Drawings
- 48. Modification of the pavement requires approval by the City of Ballarat and Superintendent.
- 49. Prior to the commencement of the works, the contractor shall provide to Superintendent and
- Council the following information Source of quarry material.
- Optimum Moisture Content and Maximum Modified Dry Density of the F.C.R to be used (from NATA approved laboratory).
   If the source of the quarry material is changed during the course of the works, new test results shall be provided.
- Subgrade, sub base and base compaction densities shall be in accordance with that shown in Table 1 and Clause 304.07 of Vicronads Standard Specification for Roadworks and Bridgeworks.
- 52. Compaction testing must be undertaken by NATA approved laborator
- 53. Compaction testing and proof rolling shall be undertaken on same day.

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- 54. Superindendent and Council must be given minimum 24 hours notice of proof roll.
- 55. All pavement areas shall be proof rolled in the presence of Superintendent and Council Inspection Engineer, at the expense of contractor and in accordance with AS 3798 and Clause 173 and 204.12 of Vicroads Standard Specification for Roadworks and Bridgeworks.
- If more than 20 percent of pavement area fails proof roll then total area must be reworked.
- 57. The next layer of pavement shall not be placed until previous layer has been approved. Following approval the contractor shall ensure that the next layer is placed within a reasonable period of time. If this is not possible it is the contractors responsibility to protect the pavement already approved. Failure to do so shall render contractor responsible for any pavement damage and rectification.
- 58. All geotechnical and compaction results are to be submitted to Superintendent and Council

#### DRAINAGE

- 59. Drainage and pits to be set out from offsets shown rather than from centreline pipe chainages
- 60. Stormwater pits shall be reinforced concrete and constructed in accordance with IDM and City of Ballarat Specifications and Standard Drawings. Minimum drop through pit shall be 20mm unless shown otherwise. For specific details refer Pit Schedule and IDM Standard Drawings SD 400 to SD 495. Minimum Concrete Strength Fc 25MPa at 28 Days.
- Precast pits are permitted where manufacturer can demonstrate compliance with requirements of IDM and City of Ballarat Specifications and Standard Drawings.
- Pit Covers and surrounds in trafficable areas shall be Class D Gatic or similar, other areas shall be Class B precast reinforced concrete unless otherwise shown.
- 33. All pipes under pavement to be RCP(RRJ) Class 3. All 150mm diameter pipes to be UPVC SN4. Pipes other than under pavement or trafficable area may be approved ribbed stormwater pipe such as Blackmax or Stormpro®. Where ribbed stormwater pipe is used embediment shall be to manufacturers specification.
- 64. Pipe trenches beneath the road pavement and footpath to be backfilled with 20mm Class 3 F.C.R. At all other locations backfill with an approved material to a minimum 300mm above top of pipe. Backfill material shall be in maximum 150mm layers and in accordance with BCC Standard Drawing SD-D8-1.
- 65. Pipe trenches behind kerb and in easements or nature strips to be backfilled with Red Dredge or other approved material in

150mm layers to 300mm above top of pipe and in accordance with BCC Standard Drawing SD-D8

- Easement Property Inlets at rear of property shall be 100mm PVC SN4 constructed in accordance with BCC Standard Drawing SD-D9 located 1.0m, from the low corner of the lot unless otherwise shown.
- 67. House Drain Property Inlets at front of property shall be 100mm PVC SN4 constructed in accordance with BCC Standard Drawing SD-D9 and located 1.0m from the low corner of the lot unless otherwise shown. Lots denoted H shall be connected to kerb. Lots denoted 19 shall be connected to pipe to pit.
- Property Inlets for allotments shall be at a sufficient depth to control drainage at minimum of 1 in 200 fall from all points within the building area.
- 69. All proposed drainage stubs to be blanked off at end of pipe with timber planks to the satisfaction of the Superintendent and
- 70. All drainage backfill under pavement shall be tested and results provided to the Superintendent


#### SERVICES

- All service trenches under footpath, vehicular crossings and kerb & channel shall be backfilled with 20mm Class 3 crushed rock. All service conduit trenches under road pavement shall be backfilled with compacted crushed rock.
- 72. Gas and water conduits and mains must be laid in trenches excavated and backfilled by the contractor. Conduits are to be 50mm diameter Class 12 PVC service conduits laid at a minimum depth of 600mm below finished surface level. Contractor shall supply all sand embedment. The contractor shall give the gas contractor? days notice prior to commencing work.
- 73. Telecommunications conduits and cable ducts must be laid in trenches excavated and backfilled by the contractor. Conduits are to be type and size as shown on approved telecommunications plans and laid at a minimum depth of 600mm below finished surface level. Contractor shall supply all sand embedment. The contractor shall give the Telecommunications contractor? daws notice prior to commencing work.
- 74. Electrical conduits and cables must be laid in trenches excavated and backfilled by an VEDN approved contractor. Conduits are to be type and size as shown on approved electrical plans and laid at a minimum depth of 600mm below finished surface level. Contractor shall supply all sand embedment. The contractor shall give the Electrical contractor 7 days notice prior to commencing work.
- All conduit ends immediately upon placement of the conduit must be plugged.
- Conduits under footpaths to be 450mm deep extending a minimum of 250mm either side of the path. The footpath above
  the conduits is to be marked with two contraction joints over the conduits 400mm apart.
- 77. The reinstatement and compaction of public authority service trenches shall be the contractor's responsibility.
- 78. The contractor must note the existence of telecom, gas, power, water and any other services in the area prior to tendering. Any disturbance to existing services, footpaths etc. shall be rectified at the contractor's expense to the satisfaction of the superintedent and relevant service authority as appropriate.

#### ATTENTION TO CONTRACTOR

In accordance with Clause 15 of AS2124 Australian Standard Conditions of Contract, the contractor must ensure the safety of the contractor's employees and all other people who are on or adjacent to the site. The contractor must comply with the Victorian Commissional Machine and Service and a site of the Contractor must comply with the Victorian Commissional Machine and Service and Servic

- 79. The contractor must ensure that all people employed on the site wear approved safety apparel. This includes safety helmets,
- The contractor shall reinstate any affected footpath, vehicle crossing and nature strip to the satisfaction of the City of Ballarat
- 81. Beveridge Williams & Co Pty Ltd is responsible for design of the works. Any proposed alterations to the design shall be
- 82. The contractor is directly responsible for the setout. Should actual site conditions conflict in any way with that document the contractor must contact the office of Reveridge Williams & Co. Phy Ltd. for clarification before proceeding.

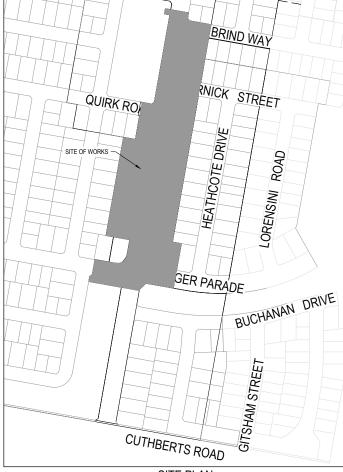

SITE PLAN

NOT TO SCALE

DRAWING No.	TITLE
1800971-E2-001	COVER SHEET
1800971-E2-002	TYPICAL ROAD CROSS SECTIONS
1800971-E2-003	PAVEMENT MAKEUP & GENERAL DETAILS
1800971-E2-010	LAYOUT PLAN
1800971-E2-011	FINISHED SURFACE & OVERLAND FLOW PLAN
1800971-E2-100	MESSENGER PARADE (EAST) LONGITUDINAL SECTIONS (SHEET 1 OF 7)
1800971-E2-101	MESSENGER PARADE (WEST) LONGITUDINAL SECTIONS (SHEET 2 OF 7)
1800971-E2-102	SHORTRIDGE DRIVE LONGITUDINAL SECTIONS (SHEET 3 OF 7)
1800971-E2-103	SHORTRIDGE DRIVE LONGITUDINAL SECTIONS (SHEET 4 OF 7)
1800971-E2-104	KERNICK STREET LONGITUDINAL SECTIONS (SHEET 5 OF 7)
1800971-E2-105	QUIRK ROAD LONGITUDINAL SECTIONS (SHEET 6 OF 7)
1800971-E2-106	BRIND ROAD LONGITUDINAL SECTIONS (SHEET 7 OF 7)
1800971-E2-200	MESSENGER PARADE CROSS SECTIONS (SHEET 1 OF 7)
1800971-E2-201	SHORTRIDGE DRIVE CROSS SECTIONS (SHEET 2 OF 7)
1800971-E2-202	SHORTRIDGE DRIVE CROSS SECTIONS (SHEET 3 OF 7)
1800971-E2-203	SHORTRIDGE DRIVE CROSS SECTIONS (SHEET 4 OF 7)
1800971-E2-204	KERNICK STREET CROSS SECTIONS (SHEET 5 OF 7)
1800971-E2-205	QUIRK ROAD CROSS SECTIONS (SHEET 6 OF 7)
1800971-E2-206	BRIND WAY CROSS SECTIONS (SHEET 7 OF 7)
1800971-E2-300	INTERSECTION DETAILS (SHEET 1 OF 4)
1800971-E2-301	INTERSECTION DETAILS (SHEET 2 OF 4)
1800971-E2-302	INTERSECTION DETAILS (SHEET 3 OF 4)
1800971-E2-303	INTERSECTION DETAILS (SHEET 4 OF 4)
1800971-E2-350	SIGNAGE & LINE MARKING PLANS (SHEET 1 OF 2)
1800971-E2-351	SIGNAGE & LINE MARKING PLANS (SHEET 2 OF 2)
1800971-E2-400	DRAINAGE LONGITUDINAL SECTIONS (SHEET 1 OF 3)
1800971-E2-401	DRAINAGE LONGITUDINAL SECTIONS (SHEET 2 OF 3)

APPROVED

By JeffColb at 12:30 pm, Oct 02, 2019

APPROVED PLANS AS-CONSTRUCTED PLANS

J.SPARK
19.10.2018

J.SPARK

J.ZAAL
25.07.2018

Beveridge Williams

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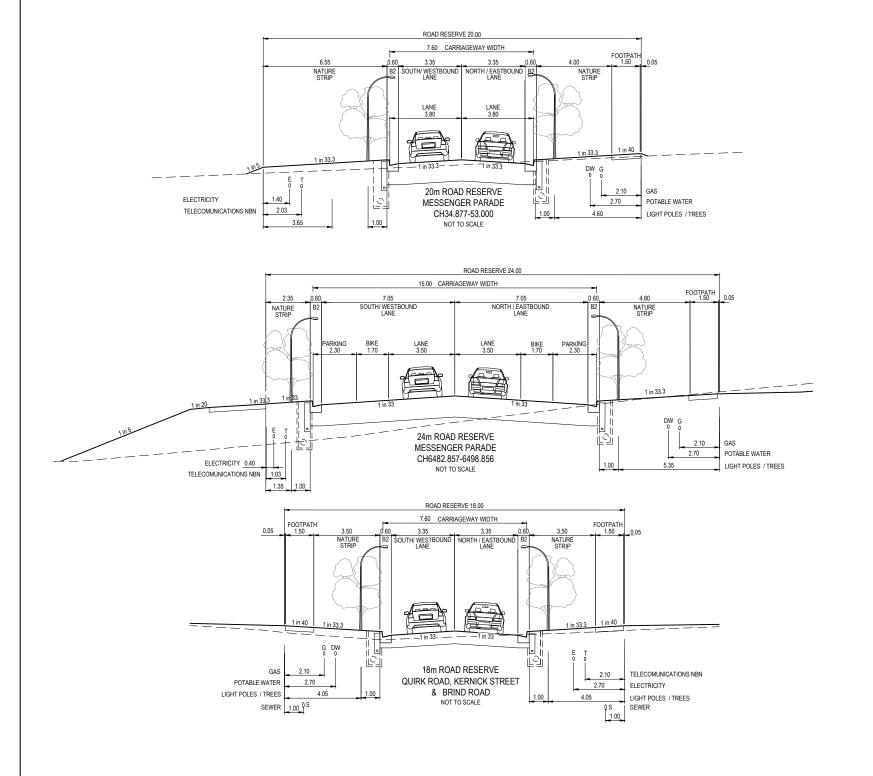
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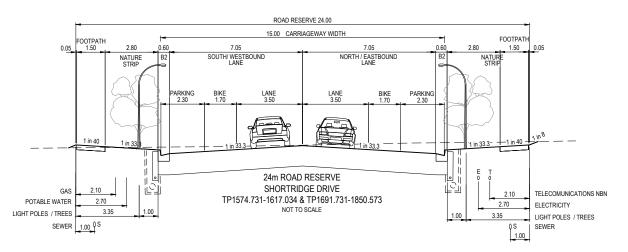
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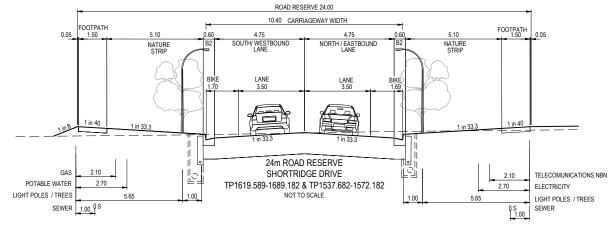
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### WARNING

BEWARE OF UNDERGROUND SERVICES

The locations of underground services are approximate only and their exact position should be proven on site. No guarantee is given that all existing services are shown. Locate all underground services before commencement of works


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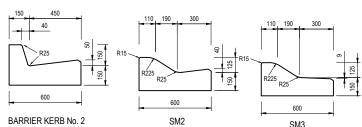


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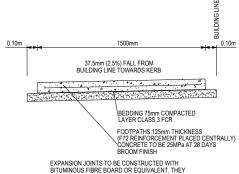
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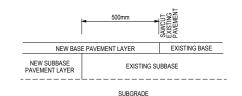


#### KERB DETAILS




EXPANSION JOINTS TO BE CONSTRUCTED WITH BITUMINOUS FIBRE BOARD OR EQUIVALENT. THEY SHALL BE PLACED EVERY JU RETRES, AT BOTH SIDES OF DRIVEWAYS AND WHERE PEDESTRIAN LAYBACKS ARE CONSTRUCTED. TRAVERSE JOINTS AT 1.5 METRES SPACINGS. WHERE REQUIRED STARTER BARS TO BE USED TO TIE INTO EXISTING
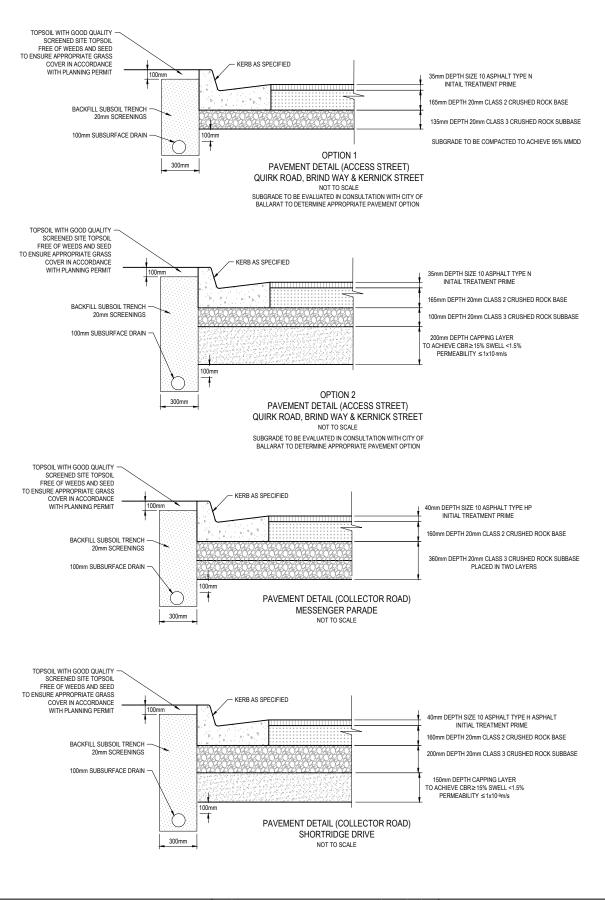
#### FOOTPATH DETAIL NOT TO SCALE




JOINTING FOR NEW PAVEMENTS TO EXISTING PAVEMENT. (TO BE APPLIED TO LONGITUDINAL JOINTS FOR WIDENING LANES)


## PAVEMENT JOINT LAPPING BASE LAYER

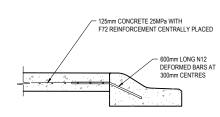

#### **CONCRETE INFILL** SPITTER ISLAND & ROUNDABOUT DETAIL

NOT TO SCALE FOR PEDESTRIAN REFUGE THROUGH TRAFFIC ISLAND REFER BCC SD-C4-4

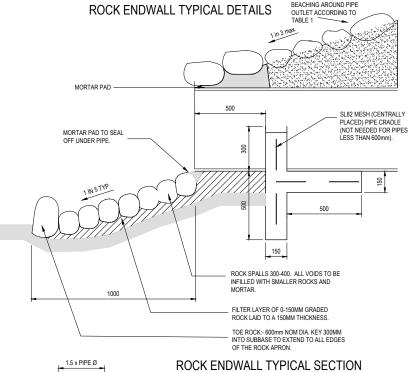

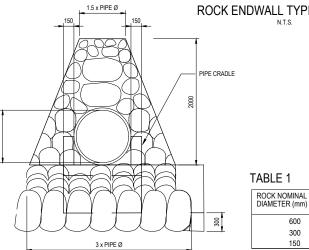

**ROCK HEADWALL END ELEVATION** 

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WARNING BEWARE OF UNDERGROUND SERVICES

The locations of underground services are approximate only and their exact position should be proven on site. No guarantee is given that all existing services are shown. ocate all underground services before commencement of works. **DIAL 1100 BEFORE YOU DIG** 



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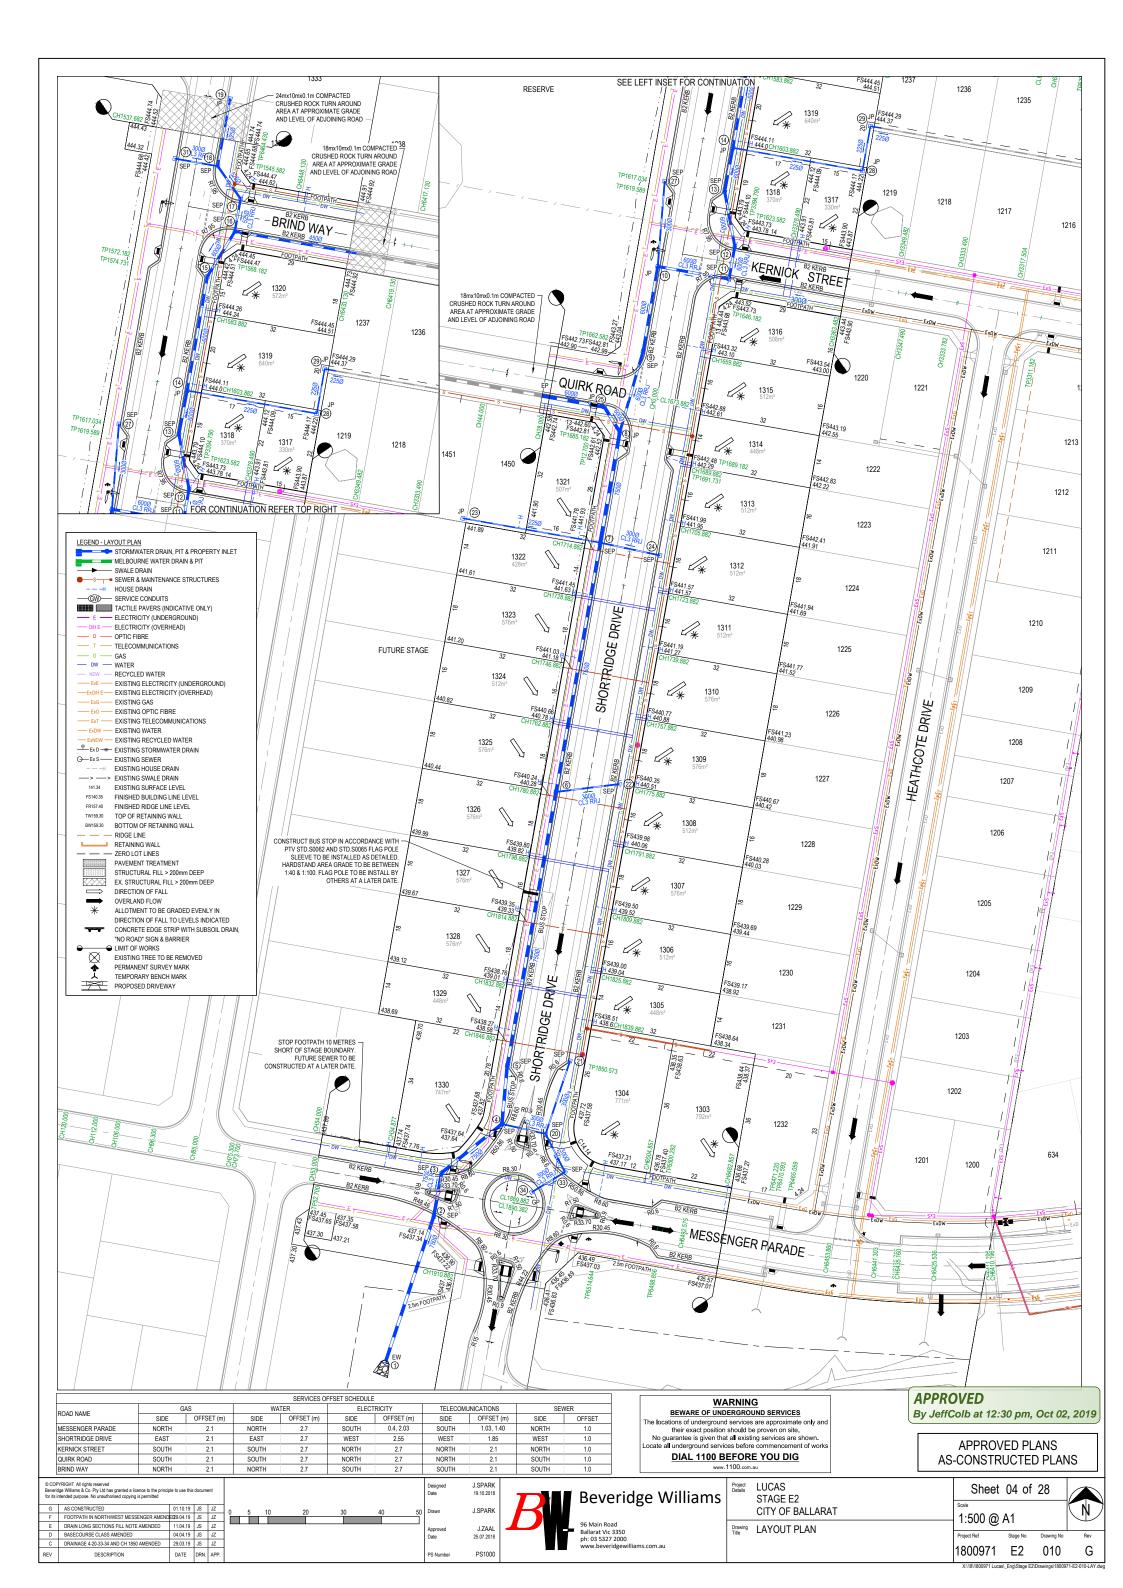



Project LUCAS Sheet 03 of 28 STAGE E2 CITY OF BALLARAT NOT TO SCALE Drawing PAVEMENT MAKEUP & GENERAL DETAILS Stage No Drawing No


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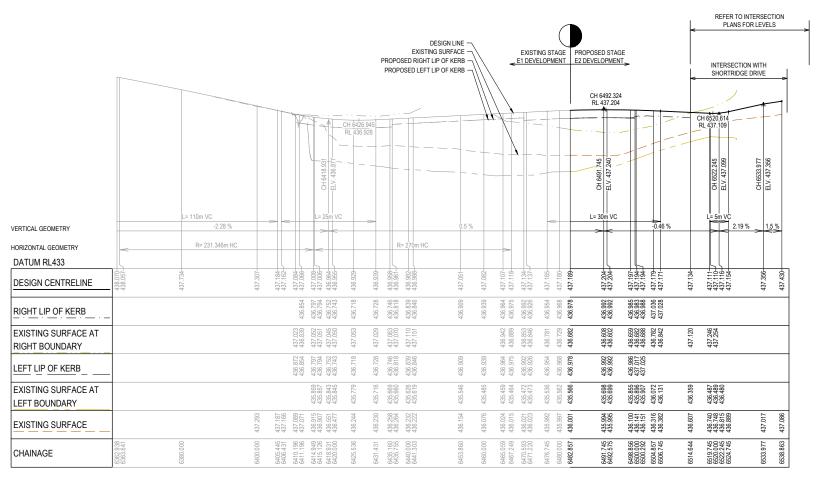
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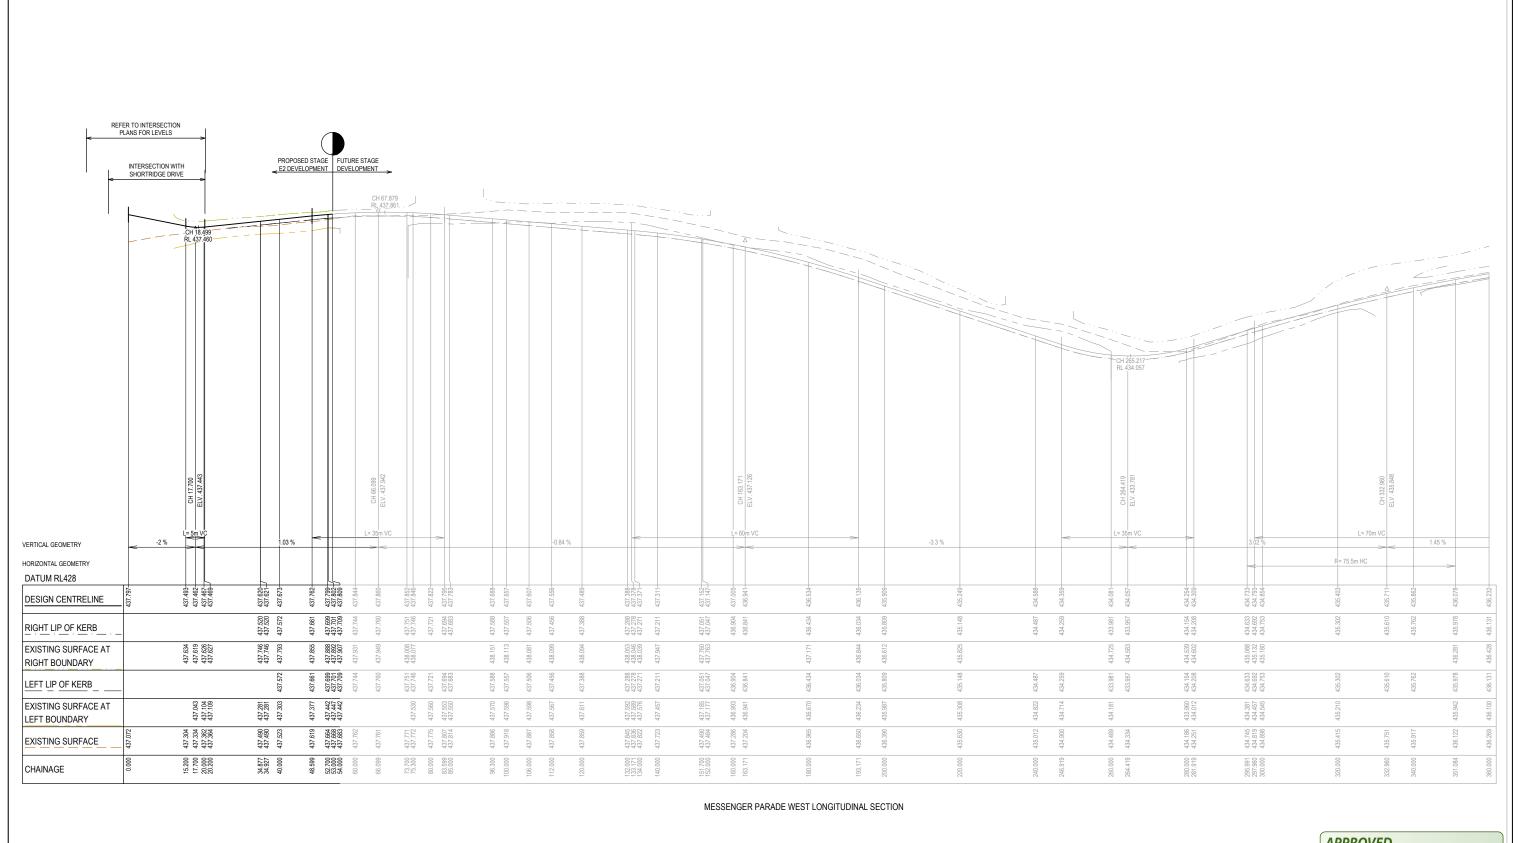


MESSENGER PARADE EAST LONGITUDINAL SECTION

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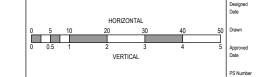
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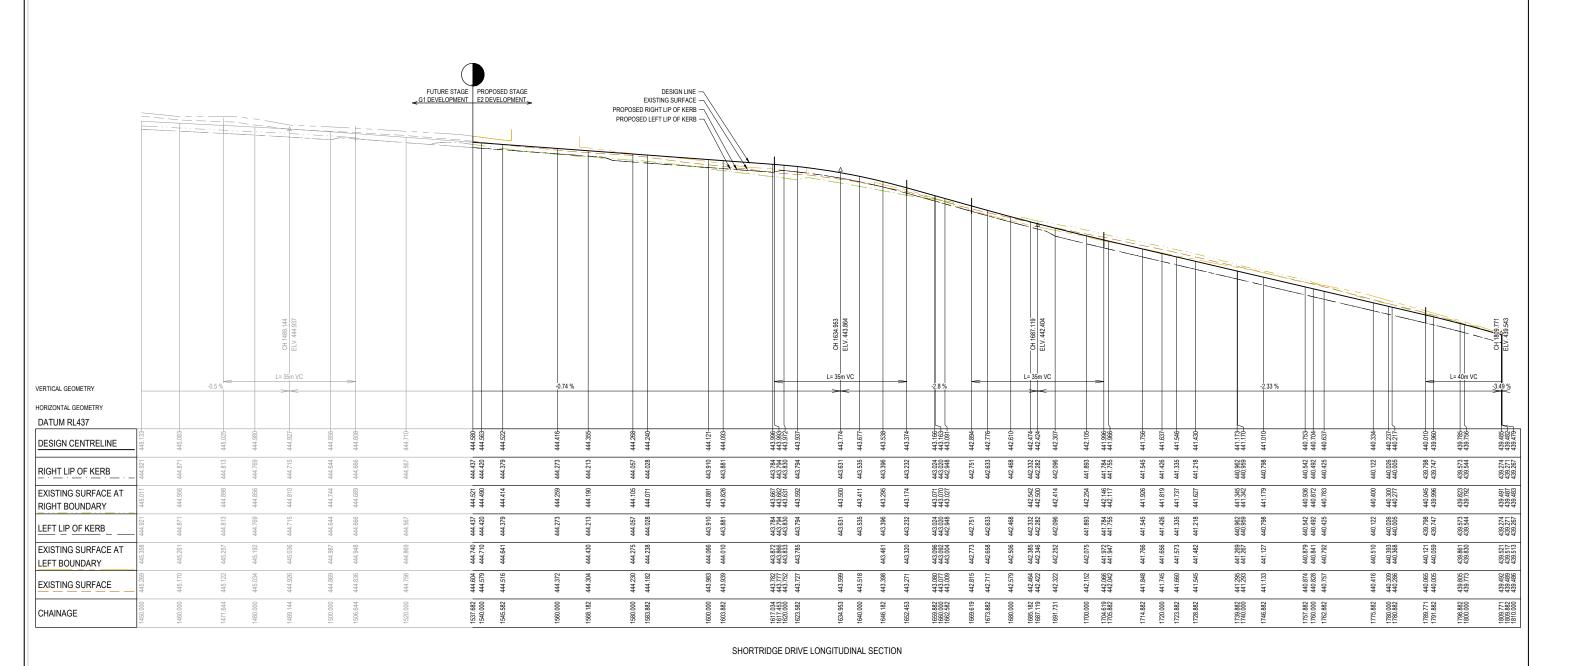
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Project Details

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ject ails	LUCAS STAGE E2	Sheet	07 of	28	
	CITY OF BALLARAT	Scale			
	CITT OF BALLARAT	1:500 H	1:50 V	@ A1	
wing	MESSENGER PARADE (WEST)				
3	LONGITUDINAL SECTIONS (SHEET 2 OF 7)	Project Ref	Stage No	Drawing No	Rev
	EGITOTION (GITEET 2 GT 1)	1800971	E2	101	G

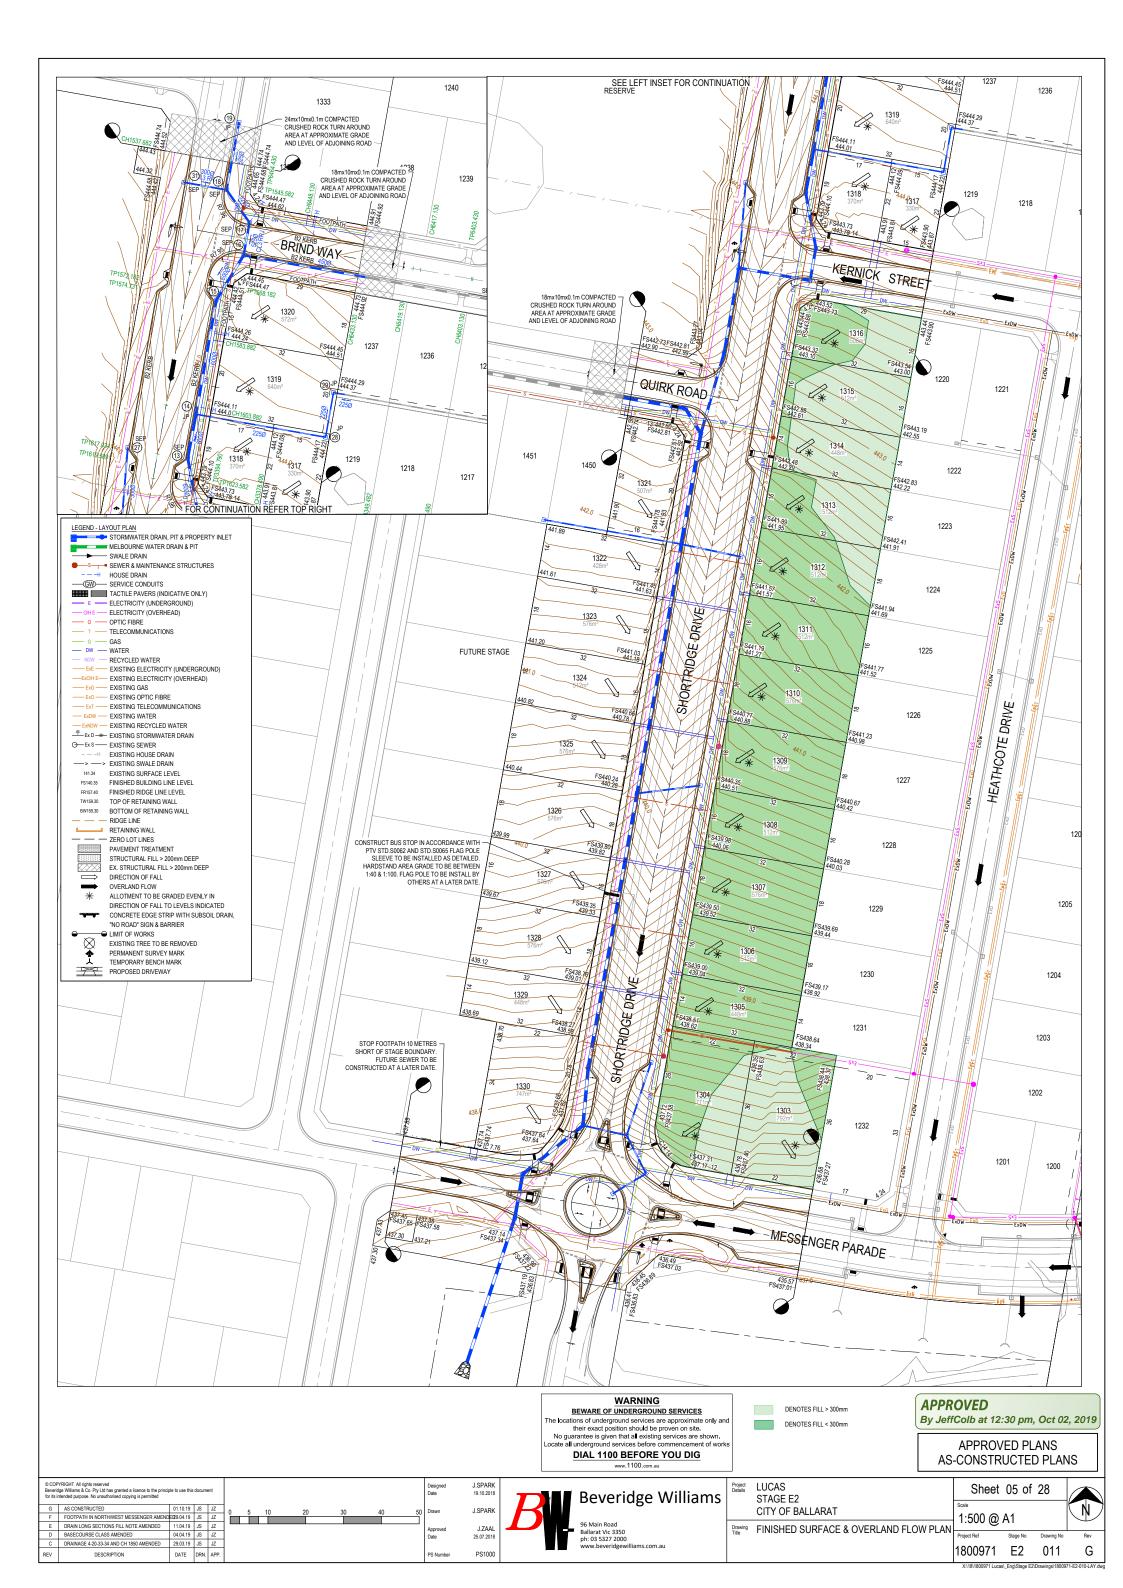
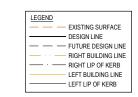
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06.02.19 JS JZ E DRAIN LONG SECTIONS FILL NOTE AMENDED

19.10.18 JS JZ B ISSUED FOR CONSTRUCTION

DATE DRN. APP. REV

11.04.19 JS JZ

18.03.19 JS JZ

DATE DRN. APP.

A ISSUED FOR APPROVAL

P3 FOR COUNCIL APPROVAL
P2 MINOR AMENDMENTS
P1 MINOR AMENDMENTS

P0 ISSUED FOR INFORMATION

**APPROVED** 

Project LUCAS

STAGE E2

CITY OF BALLARAT

LONGITUDINAL SECTIONS (SHEET 3 OF 7)

Drawing SHORTRIDGE DRIVE

Beveridge Williams

96 Main Road Ballarat Vic 3350 ph: 03 5327 2000 www.beveridgewilliar

J.SPARK


J.ZAAL 25.07.2018 APPROVED PLANS
AS-CONSTRUCTED PLANS

Sheet 08 of 28

1:500 H 1:50 V @ A1

1800971 E2 102

Stage No Drawing No

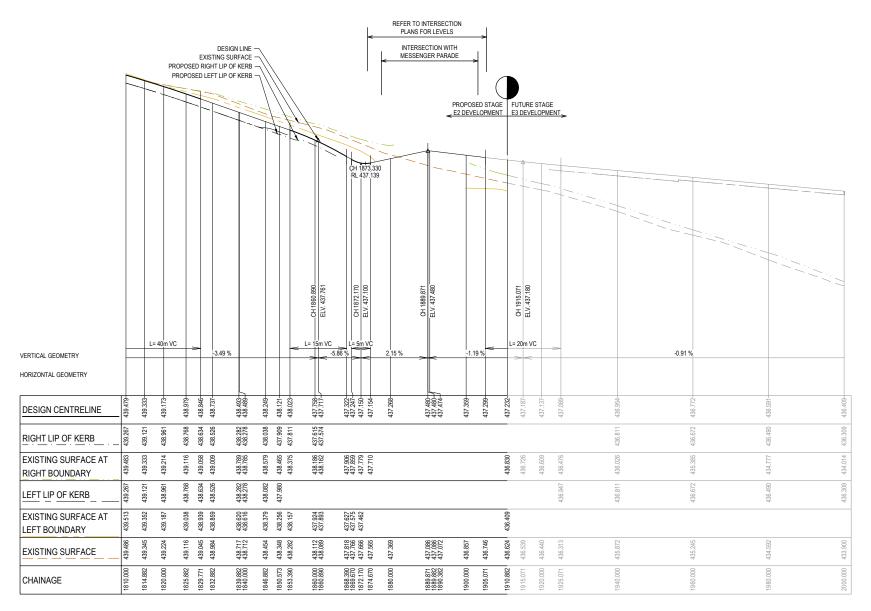


Shortridge LONGITUDINAL SECTION

APPROVED
By JeffColb at 12:31 pm, Oct 02, 2019


APPROVED PLANS AS-CONSTRUCTED PLANS

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					G	AS CONSTRUCTED	01.10.19	JS	JZ
Α	ISSUED FOR APPROVAL	04.03.19	JS	JZ	F	FOOTPATH IN NORTH/WEST MESSENGER AMENDED	29.04.19	JS	JZ
P3	FOR COUNCIL APPROVAL	06.02.19	JS	JZ	Е	DRAIN LONG SECTIONS FILL NOTE AMENDED	11.04.19	JS	JZ
P2	MINOR AMENDMENTS 29.11.18 JS JZ		JZ	D	BASECOURSE CLASS AMENDED	04.04.19	JS	JZ	
P1	MINOR AMENDMENTS	13.11.18	JS	JZ	С	DRAINAGE 4-20-33-34 AND CH 1850 AMENDED	29.03.19	JS	JZ
P0	ISSUED FOR INFORMATION	19.10.18	JS	JZ	В	ISSUED FOR CONSTRUCTION	18.03.19	JS	JZ
REV	DESCRIPTION	DATE	DRN.	APP.	REV	DESCRIPTION	DATE	DRN.	APP.

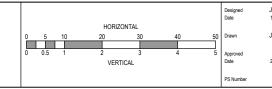



ct Is	LUCAS STAGE E2	Sheet	09 of	28
	CITY OF BALLARAT	Scale	. =0 \ /	<u> </u>
ing	SHORTRIDGE DRIVE	1:500 H <sup>2</sup>	1:50 V	@ A1
	LONGITUDINAL SECTIONS (SHEET 4 OF 7)	Project Ref	Stage No	Drawing No
	EONGITUDINAL SECTIONS (SHEET 4 OF 1)	1800971	E2	103

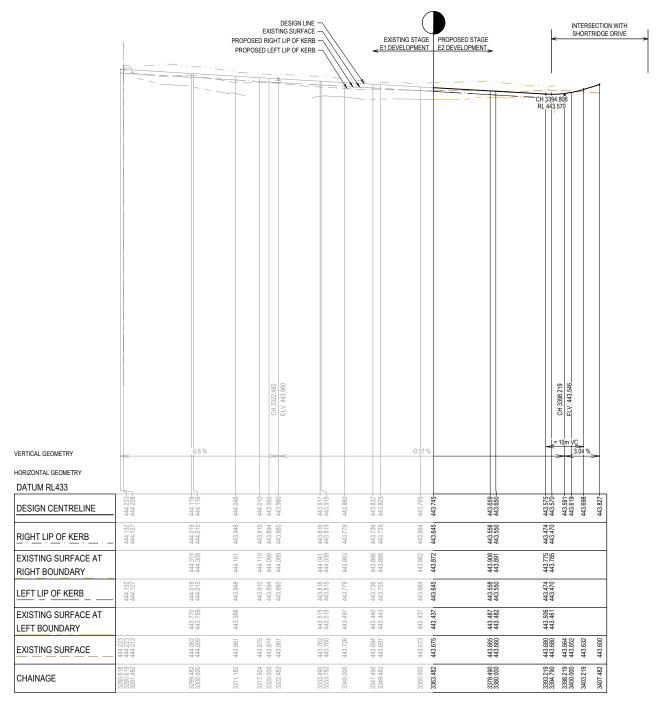

KERNICK STREET LONGITUDINAL SECTION

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					G	AS CONSTRUCTED	01.10.19	JS	JZ
Α	ISSUED FOR APPROVAL	04.03.19	JS	JZ	F	FOOTPATH IN NORTH/WEST MESSENGER AMENDED	29.04.19	JS	JZ
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P1	MINOR AMENDMENTS	13.11.18	JS	JZ	С	DRAINAGE 4-20-33-34 AND CH 1850 AMENDED	29.03.19	JS	JZ
P0	ISSUED FOR INFORMATION	19.10.18	JS	JZ	В	ISSUED FOR CONSTRUCTION	18.03.19	JS	JZ
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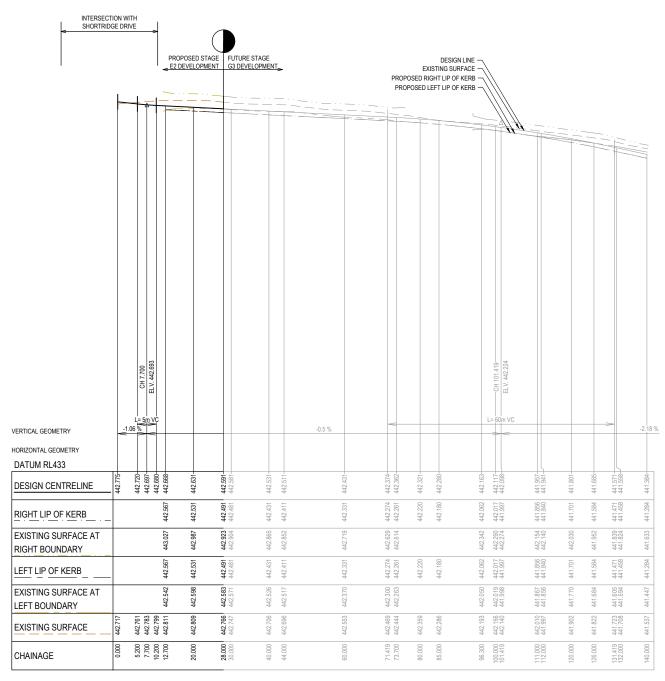
J.SPARK
19.10.2018

J.SPARK
J.ZAAL
25.07.2018

Beveridge Williams

96 Main Road
Ballarat Vic 3350
ph: 03 5327 2000
www.beverideewilliams.com.au

Project Details	LUCAS STAGE F2	Shee
	017.02 22	Scale
	CITY OF BALLARAT	1:500 H
Drawing	KERNICK STREET LONGITUDINAL SECTIONS	1.00011
Title	(SHEET 5 OF 7)	Project Ref
	(SHEET JOINT)	1800071



QUIRK ROAD LONGITUDINAL SECTION


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By JeffColb at 12:31 pm, Oct 02, 2019

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	CITY OF BALLARAT	Scale	4.50.1	O 44	
ing	QUIRK ROAD LONGITUDINAL SECTIONS	1:500 H	1:50 V	@ A1	
J	(SHEET 6 OF 7)	Project Ref	Stage No	Drawing No	Rev
	(STILL FOOT 1)	1800971	E2	105	G



BRIND WAY LONGITUDINAL SECTION

**APPROVED** By JeffColb at 12:32 pm, Oct 02, 2019

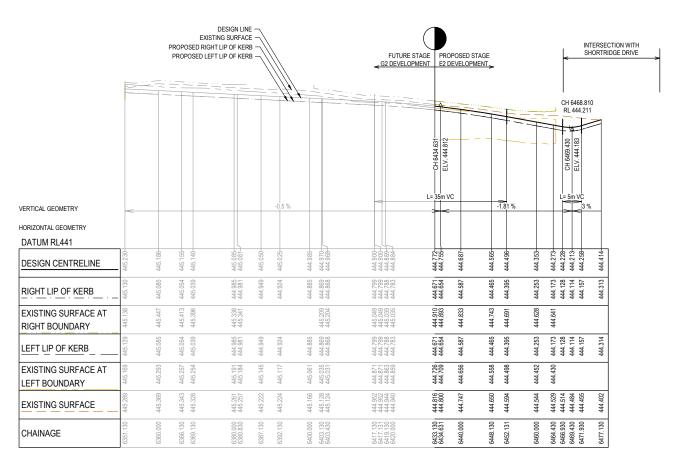
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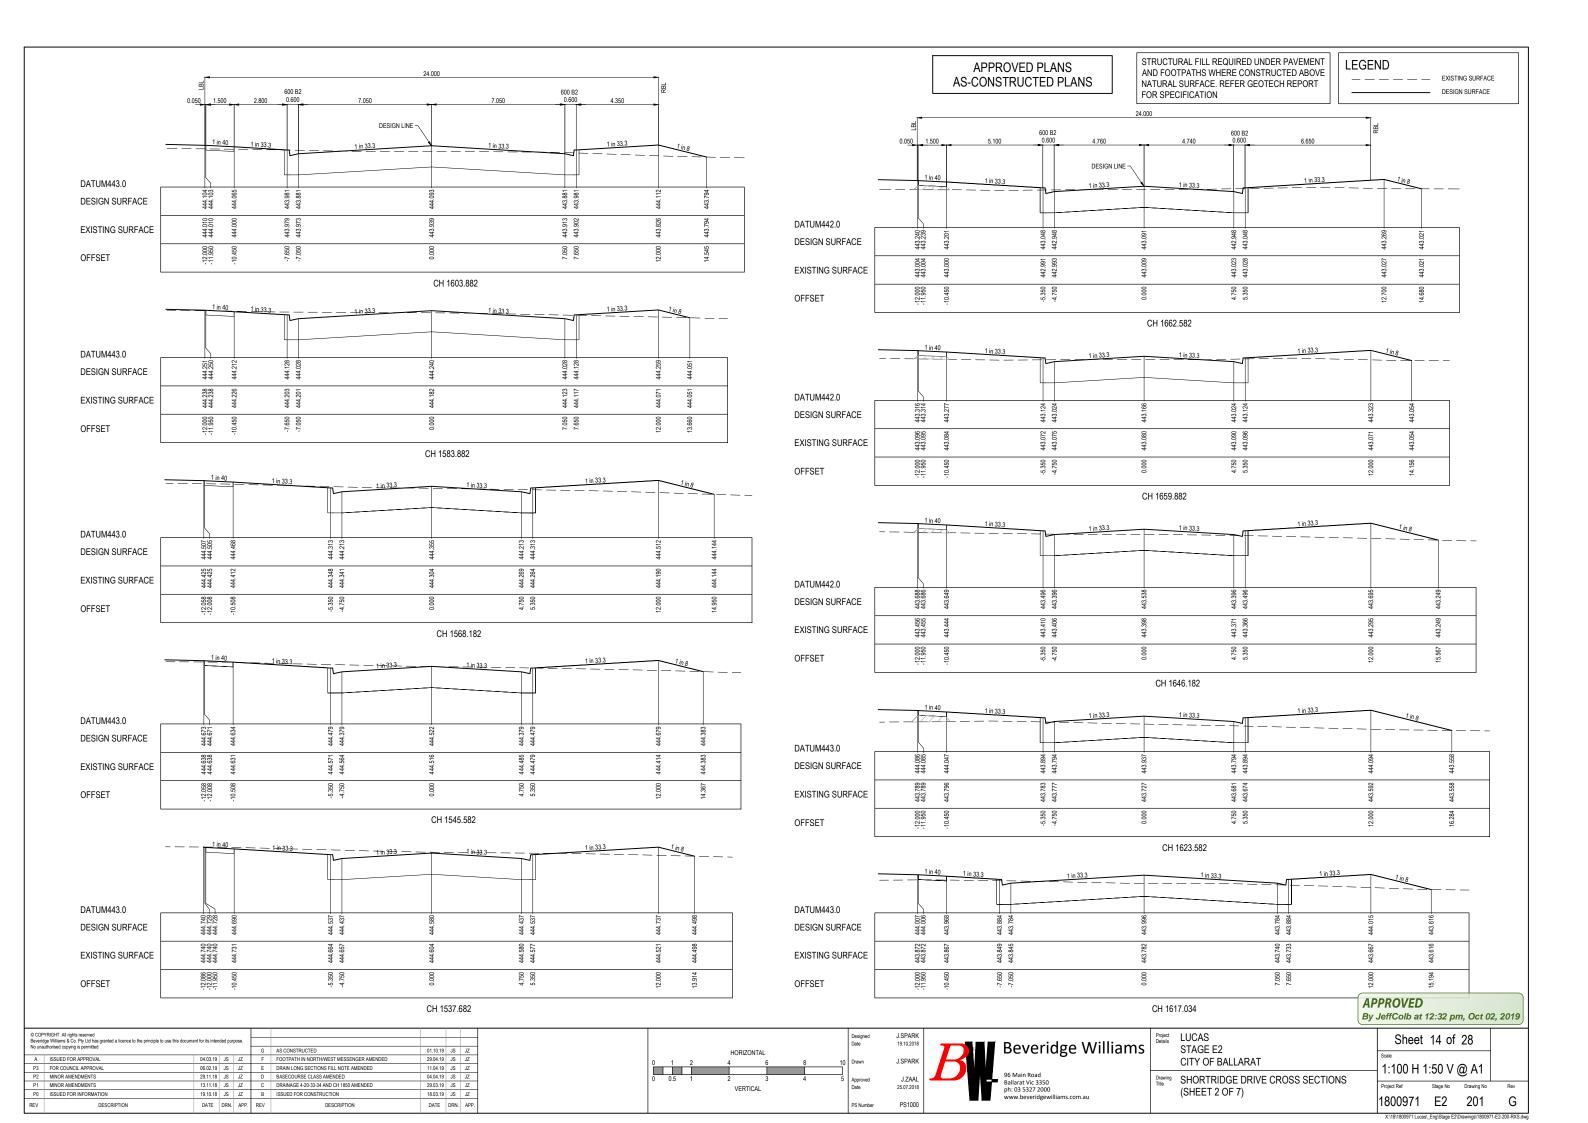
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P2	P2 MINOR AMENDMENTS 29.11.18 JS JZ				D	BASECOURSE CLASS AMENDED	04.04.19	JS	JZ
P1	MINOR AMENDMENTS	13.11.18	JS	JZ	С	DRAINAGE 4-20-33-34 AND CH 1850 AMENDED	29.03.19	JS	JZ
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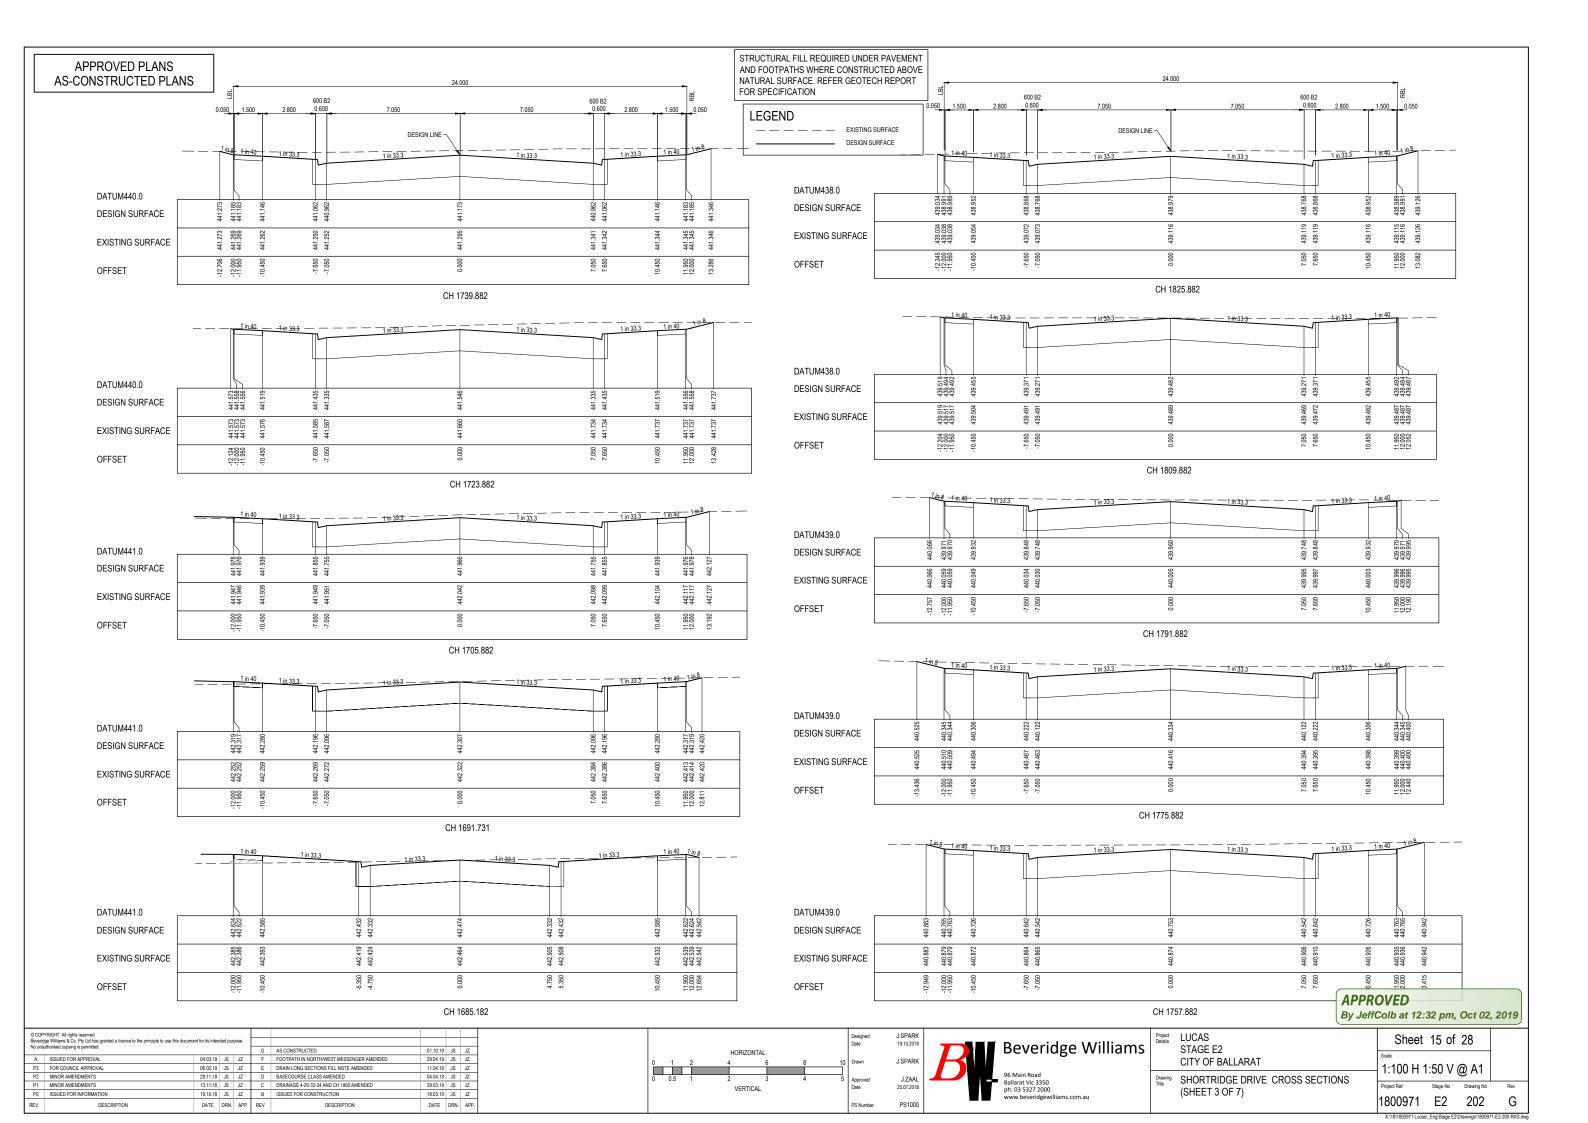
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_	CITY OF BALLARAT		1:500 H			
_	BRIND ROAD LONGITUDINAL SECTIONS	3	Project Ref	Stage No	Drawing No	Rev
(	SHEET 7 OF 7)		1800971	E2	106	G
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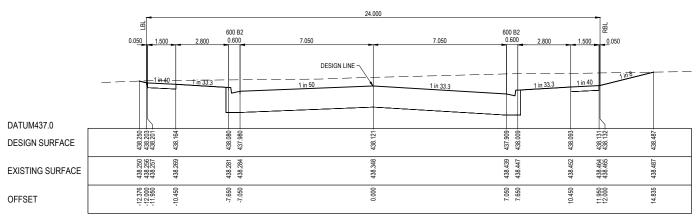







STRUCTURAL FILL REQUIRED UNDER PAVEMENT AND FOOTPATHS WHERE CONSTRUCTED ABOVE NATURAL SURFACE. REFER GEOTECH REPORT FOR SPECIFICATION

LEGEND EXISTING SURFACE
DESIGN SURFACE

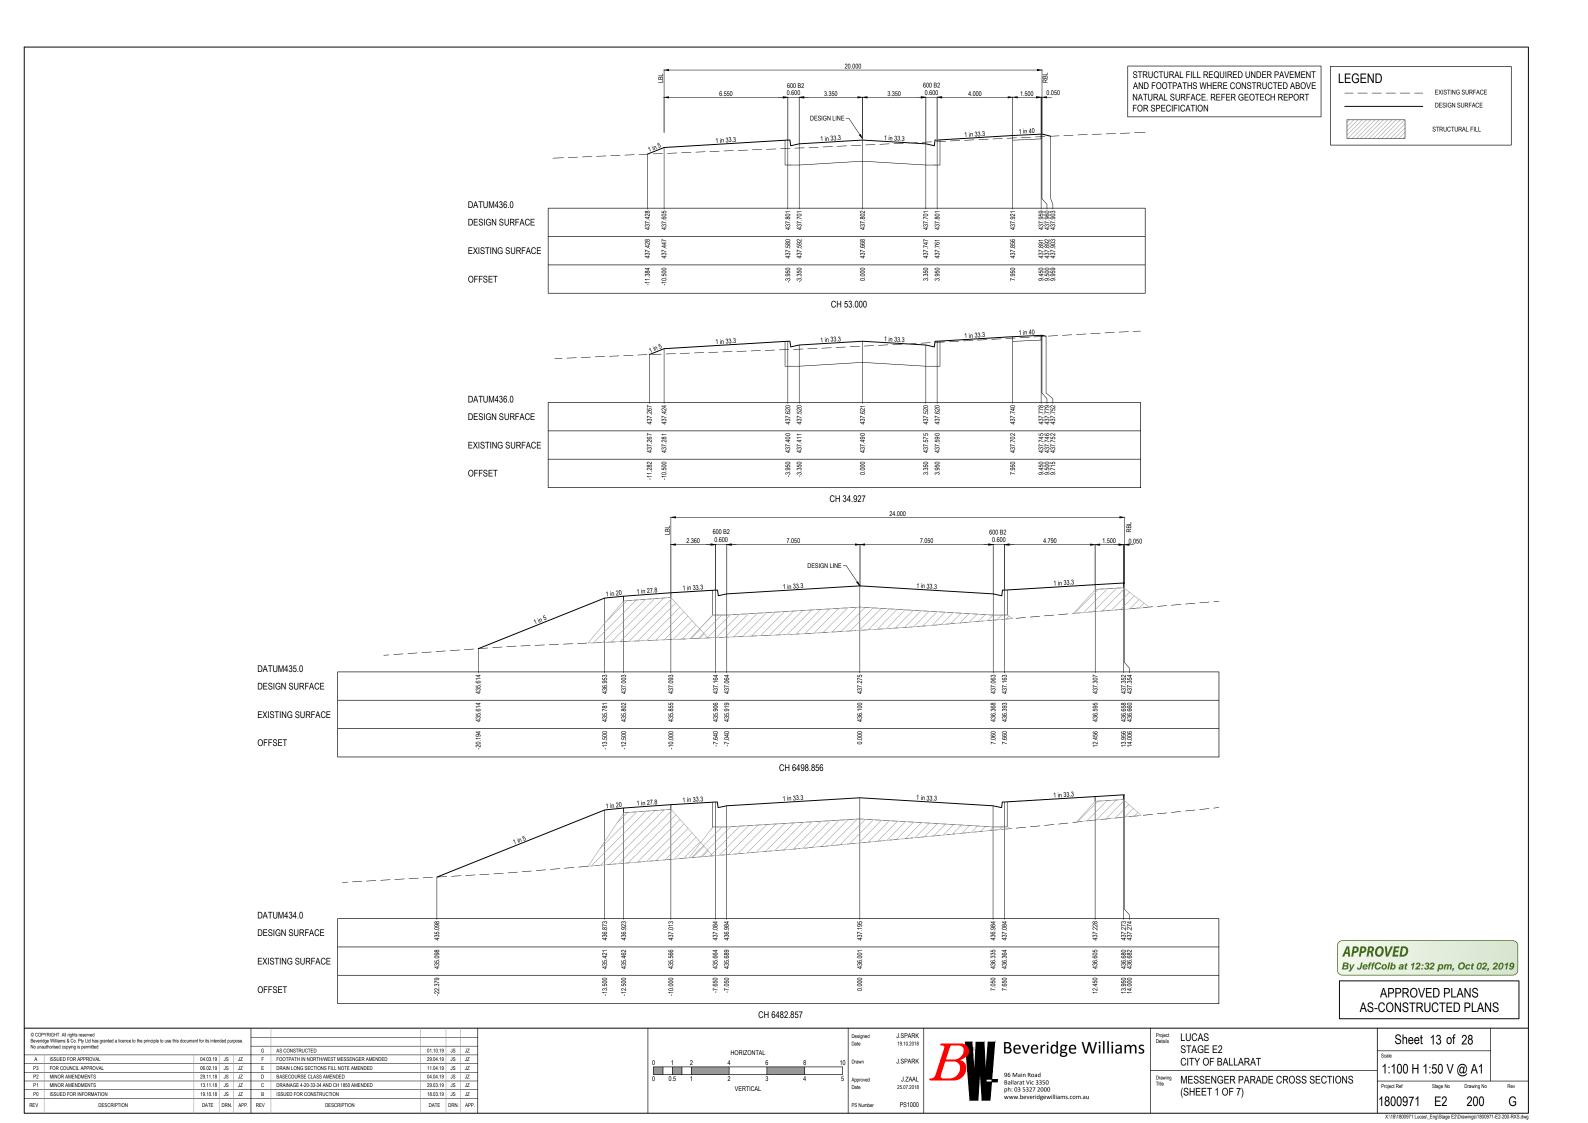

CH 1850.573

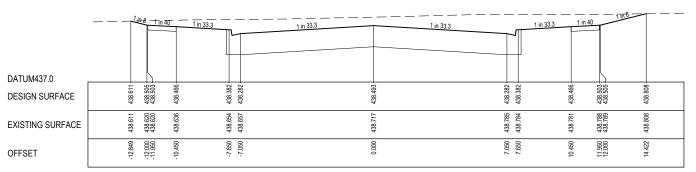

CH 1839.882

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P3	FOR COUNCIL APPROVAL	06.02.19	JS	JZ	Е	DRAIN LONG SECTIONS FILL NOTE AMENDED	11.04.19	JS	JZ
P2	MINOR AMENDMENTS	29.11.18	JS	JZ	D	BASECOURSE CLASS AMENDED	04.04.19	JS	JZ
P1	MINOR AMENDMENTS	13.11.18	JS	JZ	С	DRAINAGE 4-20-33-34 AND CH 1850 AMENDED	29.03.19	JS	JZ
P0	ISSUED FOR INFORMATION	19.10.18	JS	JZ	В	ISSUED FOR CONSTRUCTION	18.03.19	JS	JZ
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ect	LUCAS STAGE E2		Sheet	16 of	28	
	CITY OF BALLARAT		Scale			
wing	CHORTDIDGE DRIVE CROSS SECTION	<u> </u>	1:100 H 1	1:50 V	@ A1	
	SHORTRIDGE DRIVE CROSS SECTION (SHEET 4 OF 7)	0	Project Ref	Stage No	Drawing No	Rev
	(STILLT 4 OF 1)		1800971	E2	203	G

DESIGN LINE -\_\_\_\_\_ DATUM442.0 443.714 443.712 DESIGN SURFACE 443.511 443.511 443.544 443.616 443.725 443.780 443.780 EXISTING SURFACE 7.450 8.950 8.950 -7.450 3.950 3.350 8.950 OFFSET CH 3394.790 DATUM443.0 443.558 443.558 443.802 443.801 DESIGN SURFACE 443.487 443.768 443.908 EXISTING SURFACE -9.000 -3.950 3.350 7.450 8.950 OFFSET CH 3378.490 DATUM443.0 443.644 443.888 443.887 DESIGN SURFACE 443.437 443.572 443.761 443.872 443.872 EXISTING SURFACE -9.000 -8.950 -7.450 3.350 8.950 3.350 7.450 0.000 OFFSET CH 3363.490

\_\_\_ \_\_ \_ \_ \_ EXISTING SURFACE

LEGEND

STRUCTURAL FILL REQUIRED UNDER PAVEMENT AND FOOTPATHS WHERE CONSTRUCTED ABOVE

NATURAL SURFACE. REFER GEOTECH REPORT

FOR SPECIFICATION

DESIGN SURFACE

APPROVED


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 06.02.19
 JS
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 DRAIN LONG SECTIONS FILL NOTE AMENDED

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 P3 FOR COUNCIL APPROVAL
P2 MINOR AMENDMENTS
P1 MINOR AMENDMENTS 11.04.19 JS JZ P0 ISSUED FOR INFORMATION 19.10.18 JS JZ B ISSUED FOR CONSTRUCTION 18.03.19 JS JZ DESCRIPTION DATE DRN. APP. REV DATE DRN. APP.






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	CITY OF BALLADAT	1:100 H 1:50 V @ A1				
wing	KERNICK STREET CROSS SECTIONS	1.10011	1.50 V	W 71		
B	(SHEET 5 OF 7)	Project Ref	Stage No	Drawing No	Rev	
	(STEET 3 OF T)	1800971	E2	204	G	

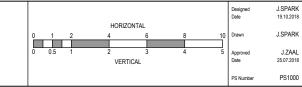STRUCTURAL FILL REQUIRED UNDER PAVEMENT AND FOOTPATHS WHERE CONSTRUCTED ABOVE NATURAL SURFACE. REFER GEOTECH REPORT FOR SPECIFICATION

LEGEND

— — — EXISTING SURFACE

— DESIGN SURFACE

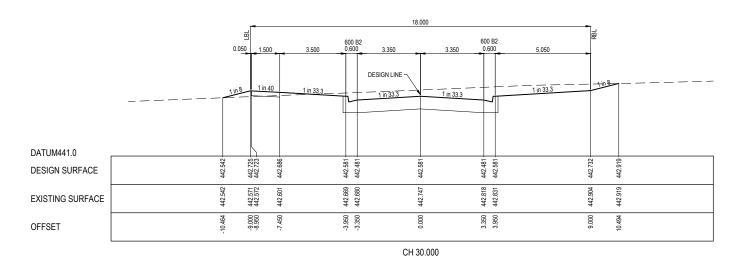


CH 28.000

CH 12.700

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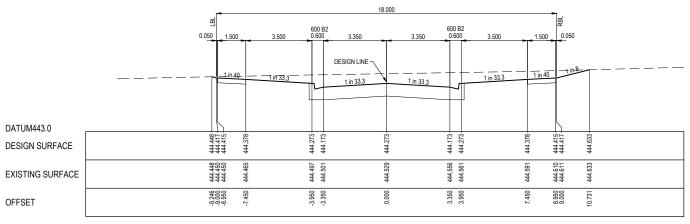
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Project Details	LUCAS STAGE E2	Sheet	18 of	28	
	CITY OF BALLARAT	1:100 H 1	1:50 V	@ A1	
Orawing Title	QUIRK ROAD CROSS SECTIONS	Project Ref	Stage No	Drawing No	Rev
	(SHEET 6 OF 7)	1800971	E2	205	G
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STRUCTURAL FILL REQUIRED UNDER PAVEMENT AND FOOTPATHS WHERE CONSTRUCTED ABOVE NATURAL SURFACE. REFER GEOTECH REPORT FOR SPECIFICATION


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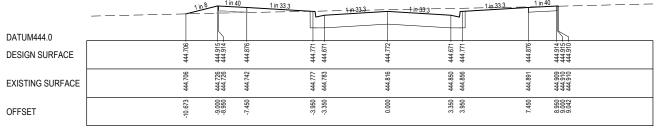
— DESIGN SURFACE

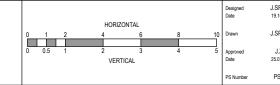

CH 6464.430



CH 6448.130

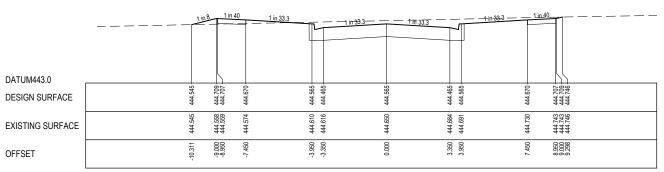

CH 6433.130

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By JeffColb at 12:33 pm, Oct 02, 2019


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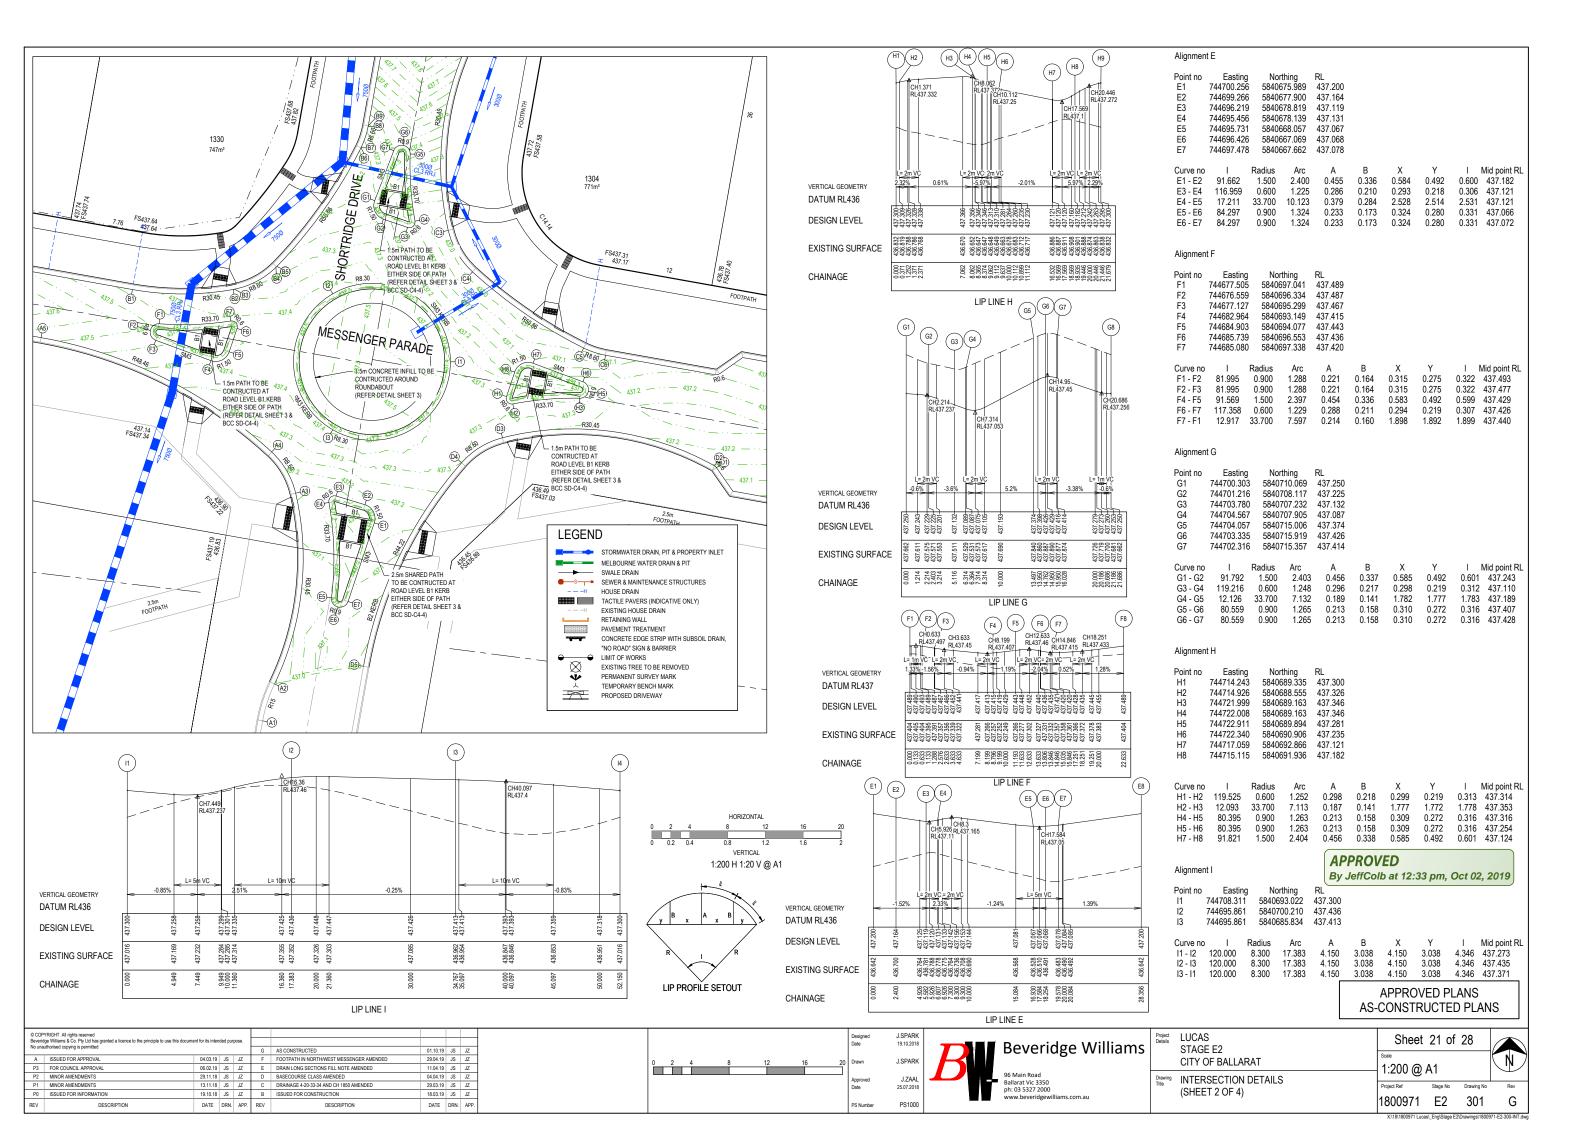
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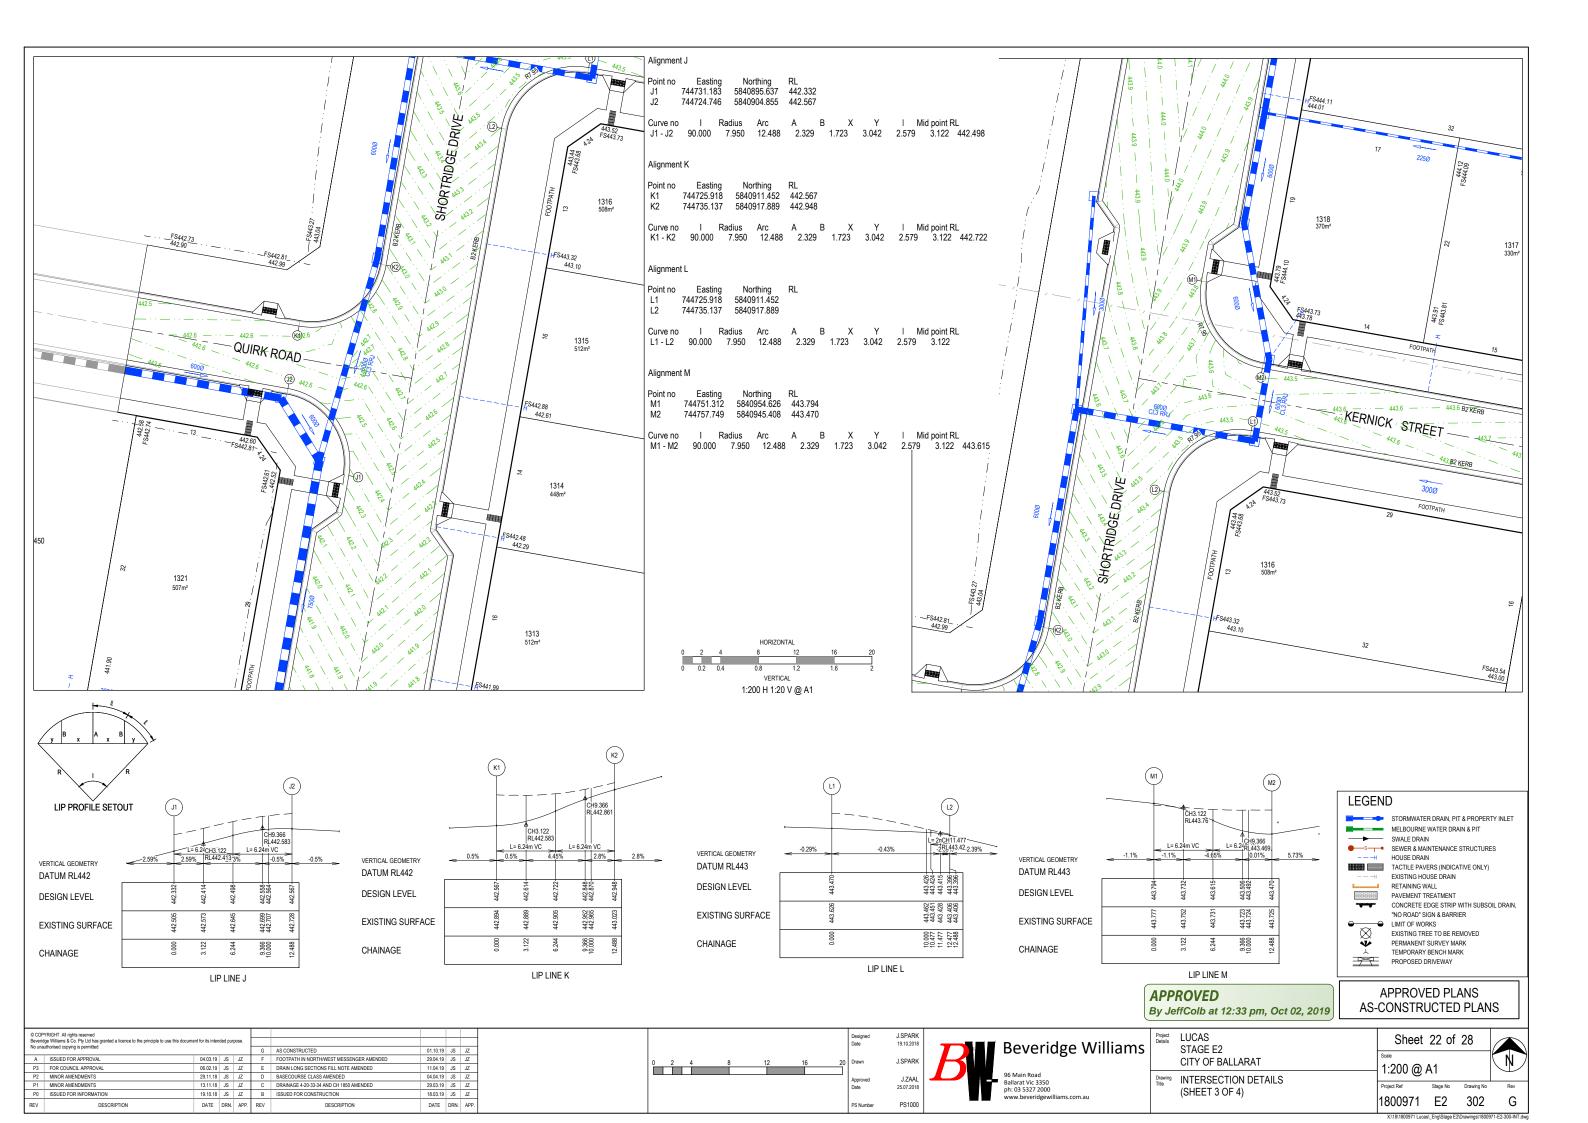
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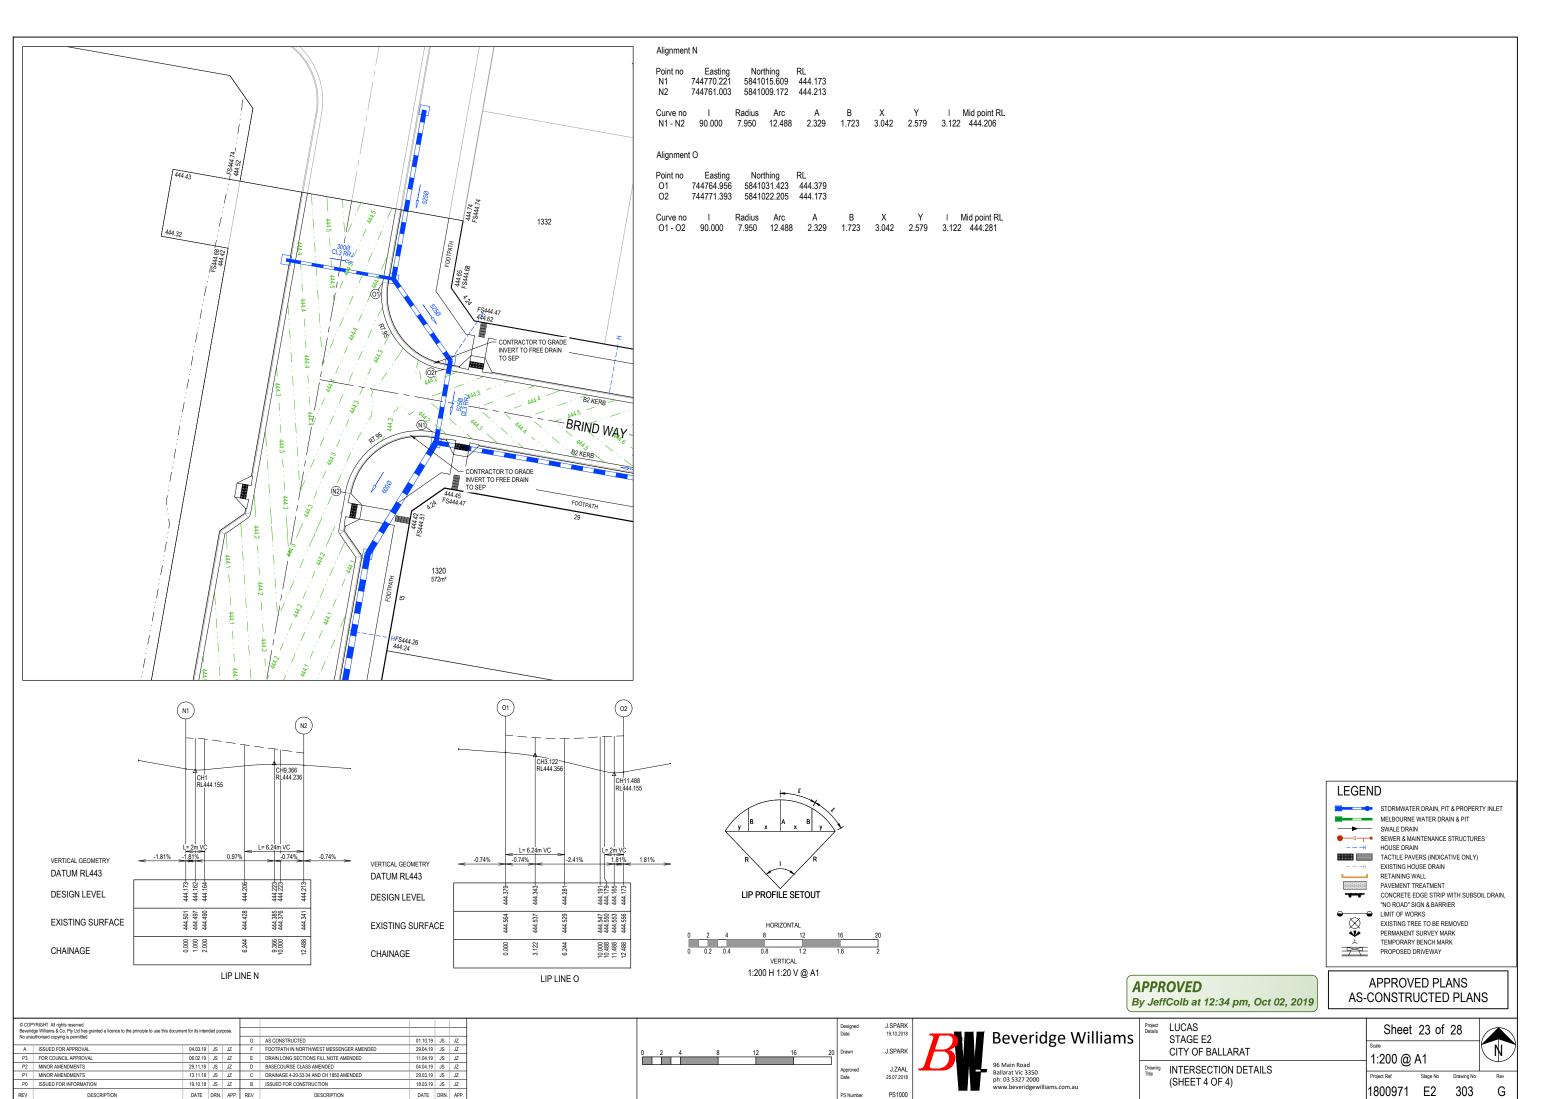


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LUCAS STAGE E2			Sheet	19 of	28		1
CITY OF BA	LLARAT	- 1	1:100 H 1	1·50 V	@ Δ1		
	CROSS SECTIONS		Project Ref	Stage No	Drawing No	Rev	$\frac{1}{2}$
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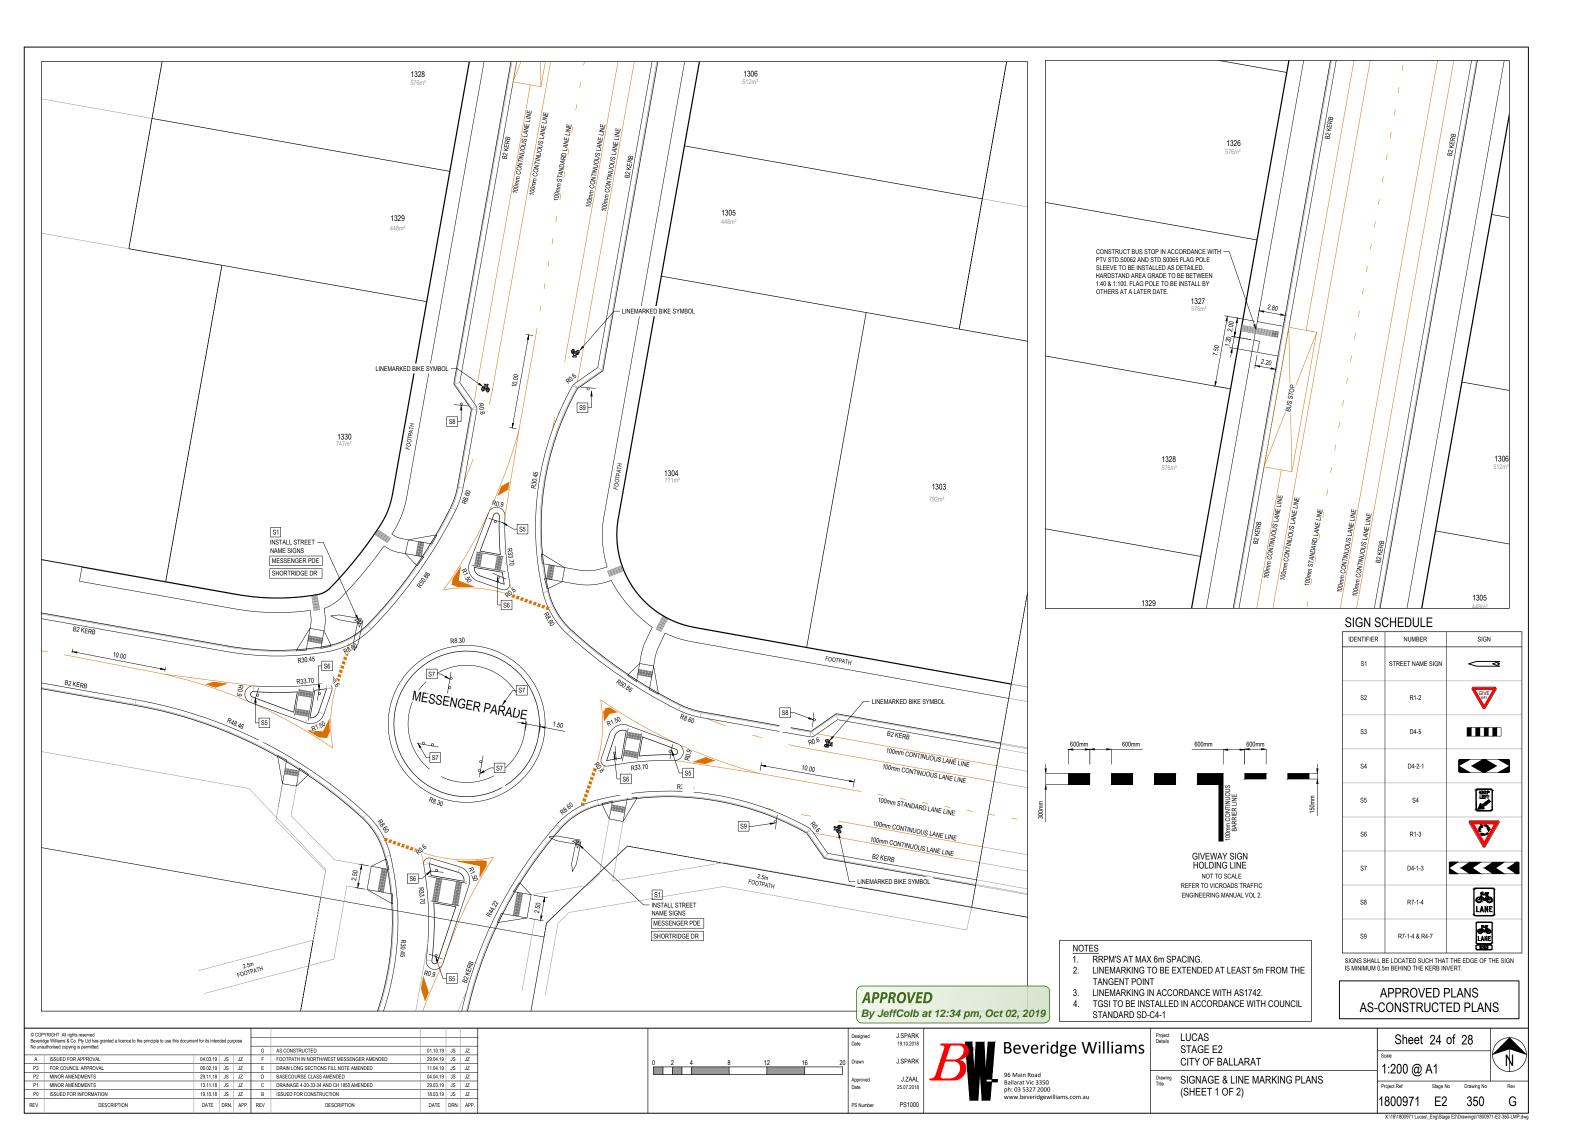







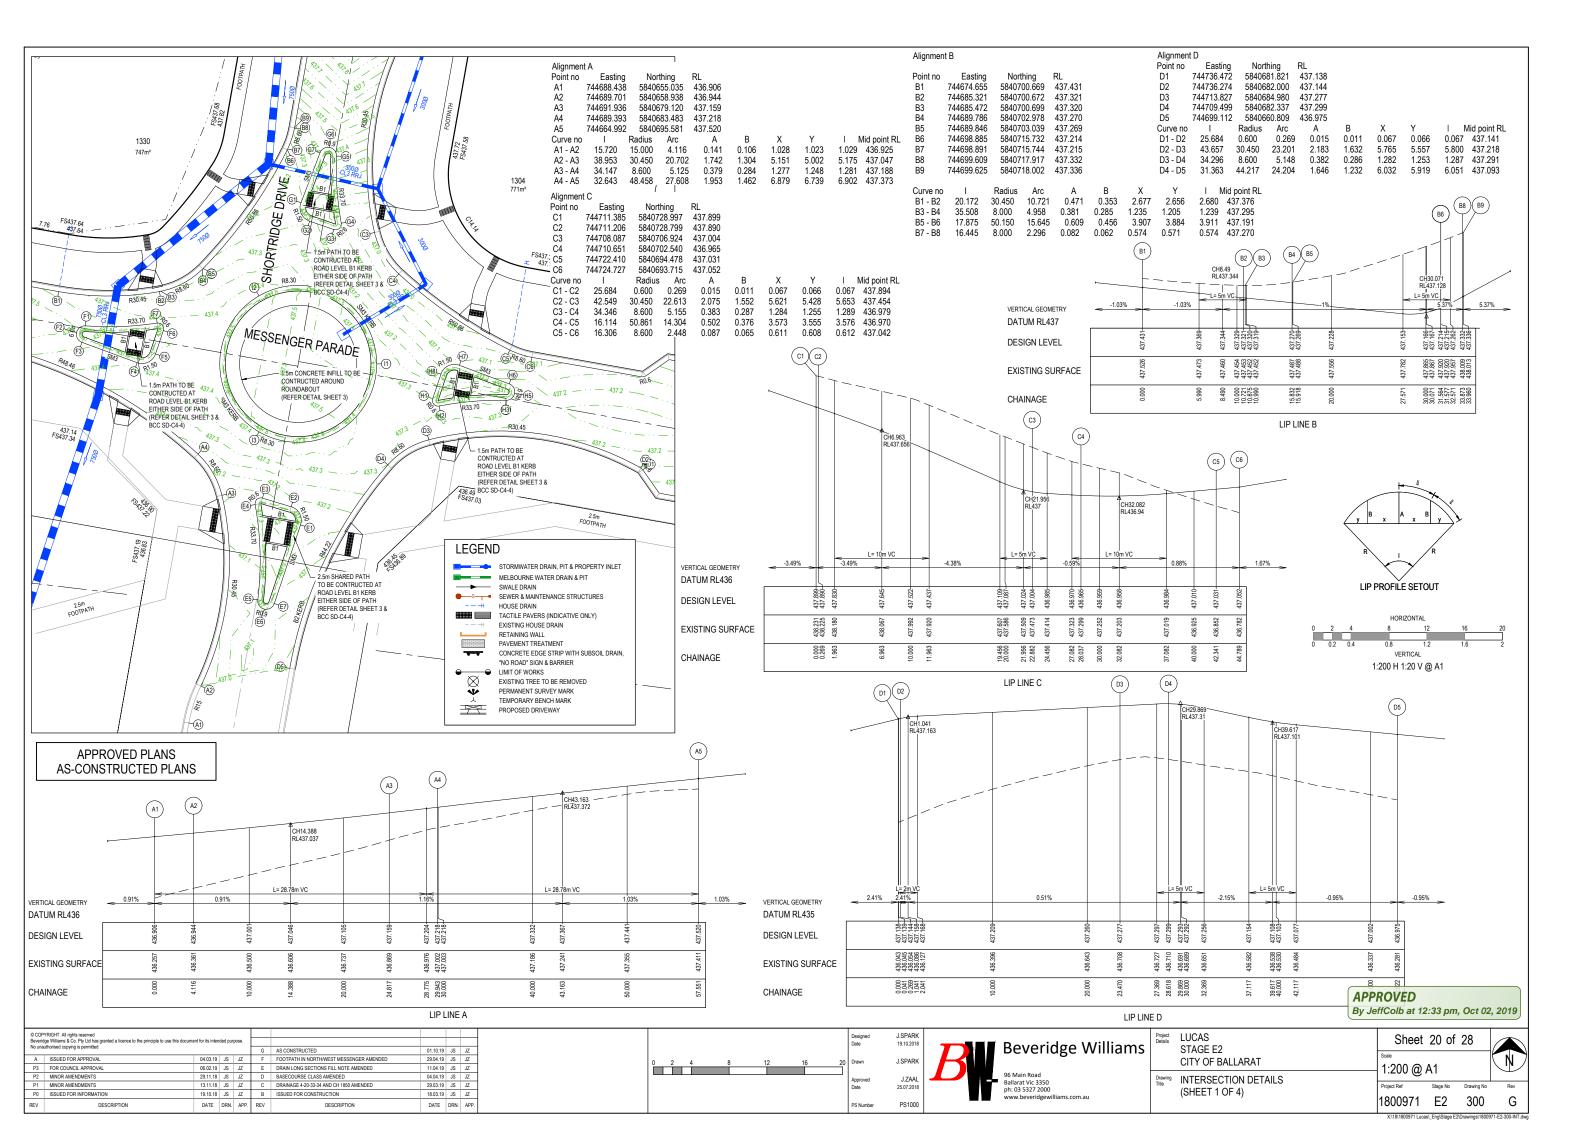


0971 Lucas\\_Eng\Stage E2\Drawings\1800971-E2-300-INT.c



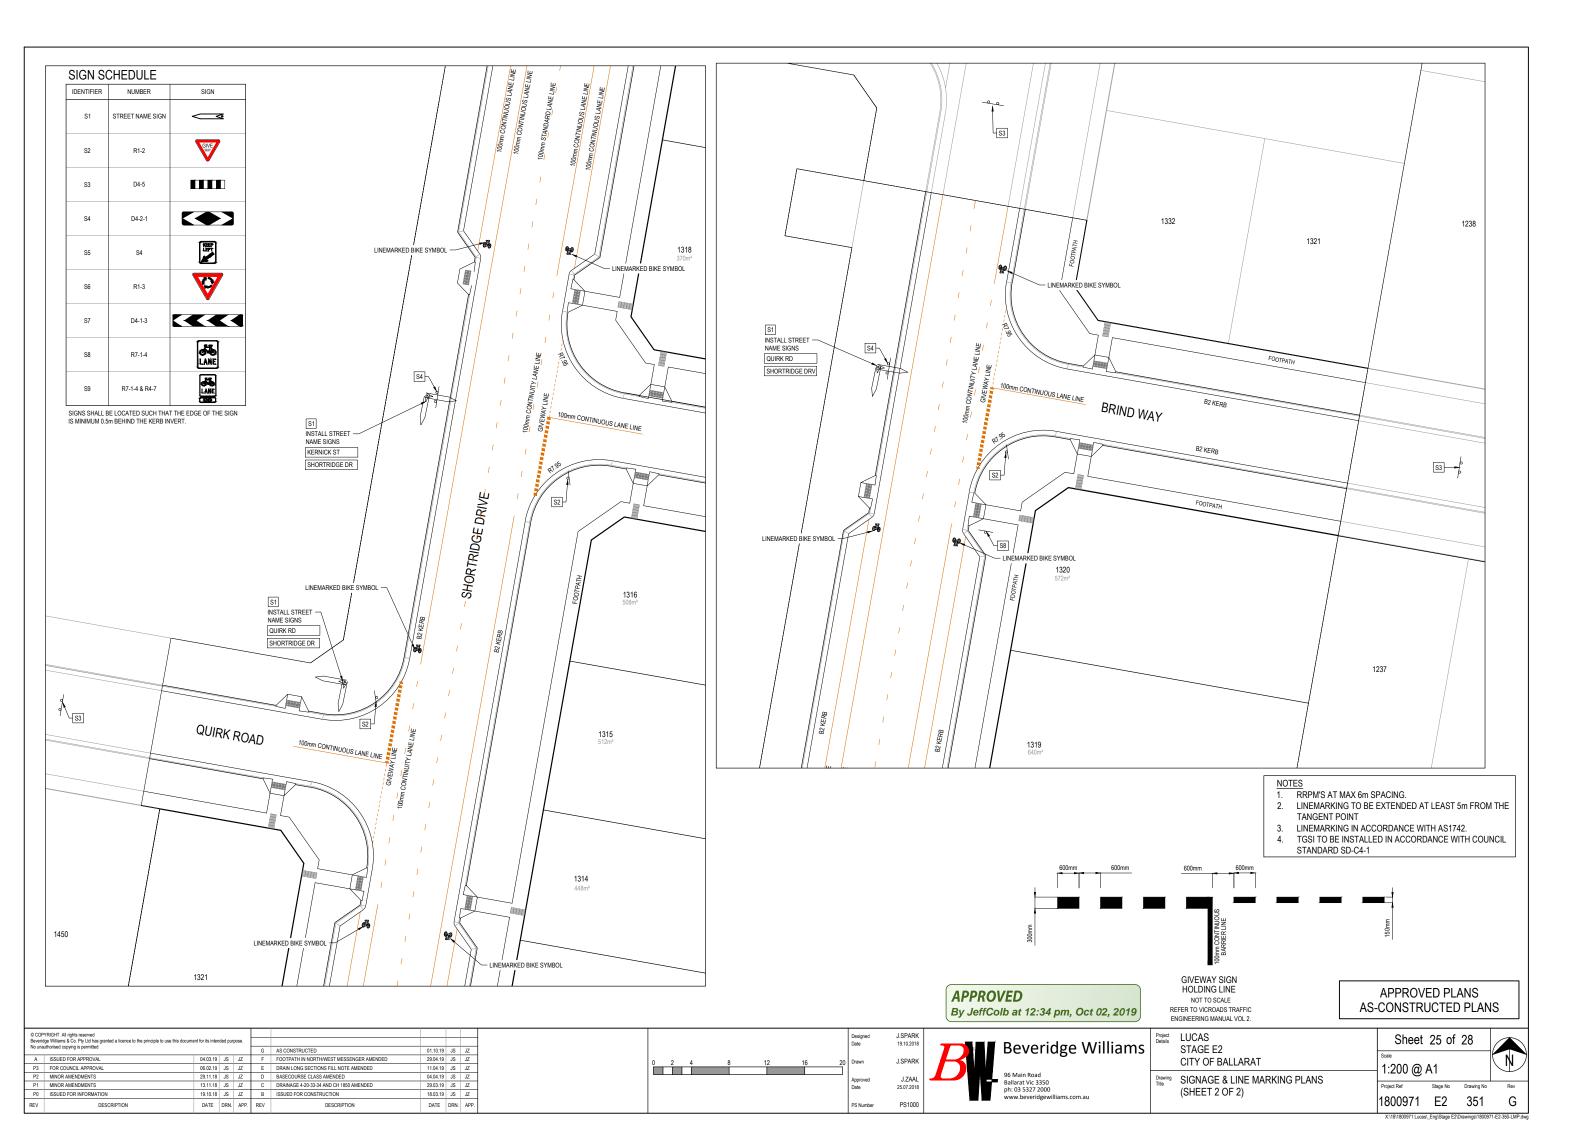

NOTES: ALL STORMWATER DRAINS UP TO AND INCLUDING 750mm DIA. ARE TO BE CLASS 2 R.R.J. PIPES UNLESS NOTED OTHERWISE. LEGEND EXISTING SURFACE
- DESIGN SURFACE DRAINAGE PIPE/PIT — — — EXISTING DRAINAGE PIPE/PIT HYDRAULIC GRADE LINE DENOTES 20mm CLASS 3 FCR BACKFILL. DENOTES RED DREDGE OR OTHER APPROVED QUARRIED PRODUCT. EW SEP SEP SEP SEP SEP SEP SEP SEP SEP (6) (7)(14) (2) (3) 5 (8) 9 (12) (13) SHORTRIDGE DRIVE MESSENGER PARADE

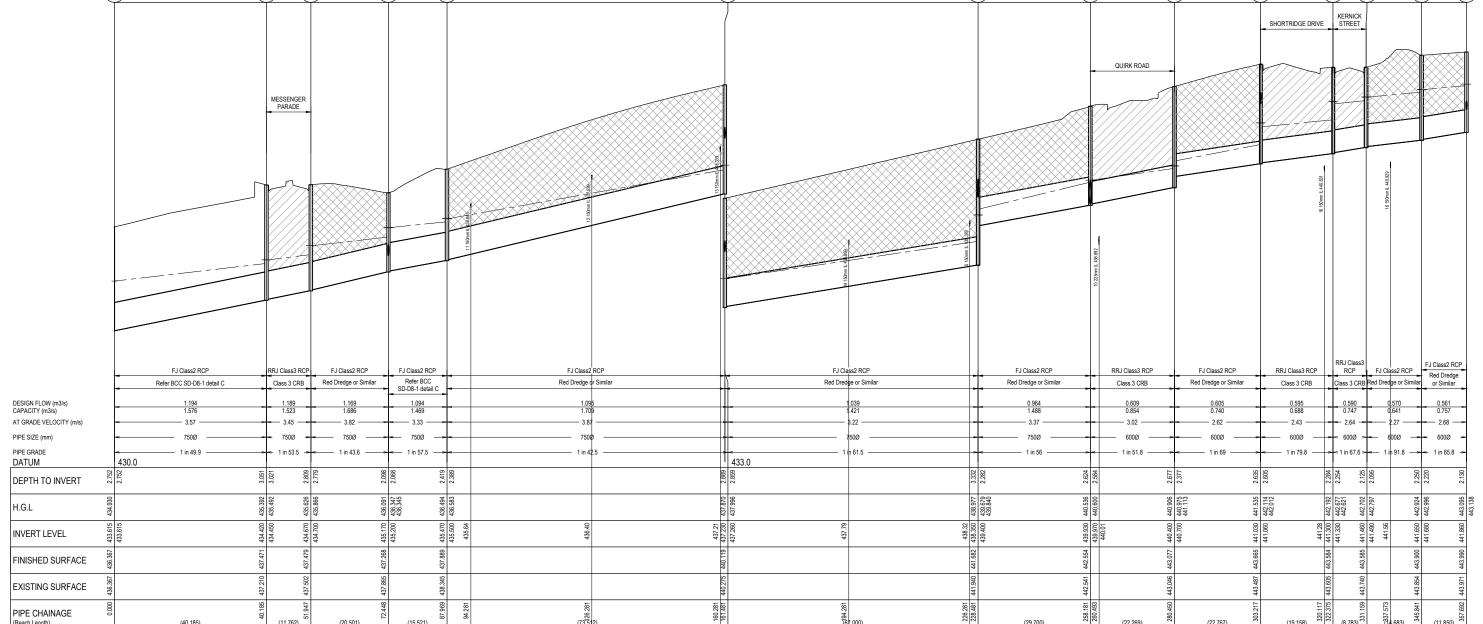


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REV	DESCRIPTION	DATE	DRN.	APP.	REV	DESCRIPTION	DATE	DRN.	APP.







Project LUCAS STAGE E2 CITY OF BALLARAT

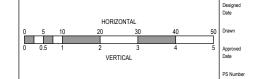Drawing Title DRAINAGE LONGITUDINAL SECTIONS (SHEET 1 OF 3)

Sheet 26 of 28
Scale 1:500 H 1:50 V @ A1
Project Ref Slage No Drawing No 1800971 E2 400

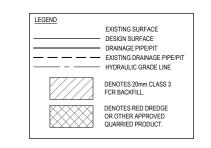

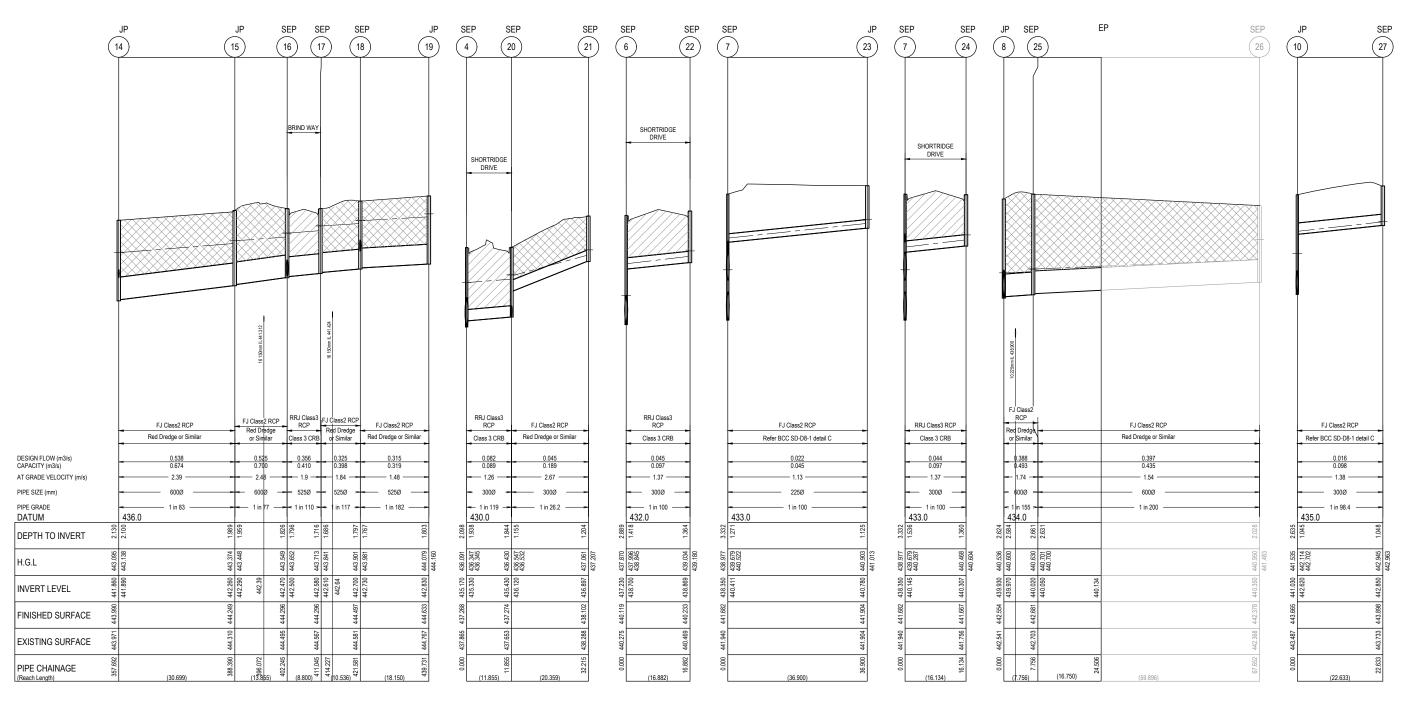


APPROVED

By JeffColb at 12:34 pm, Oct 02, 2019


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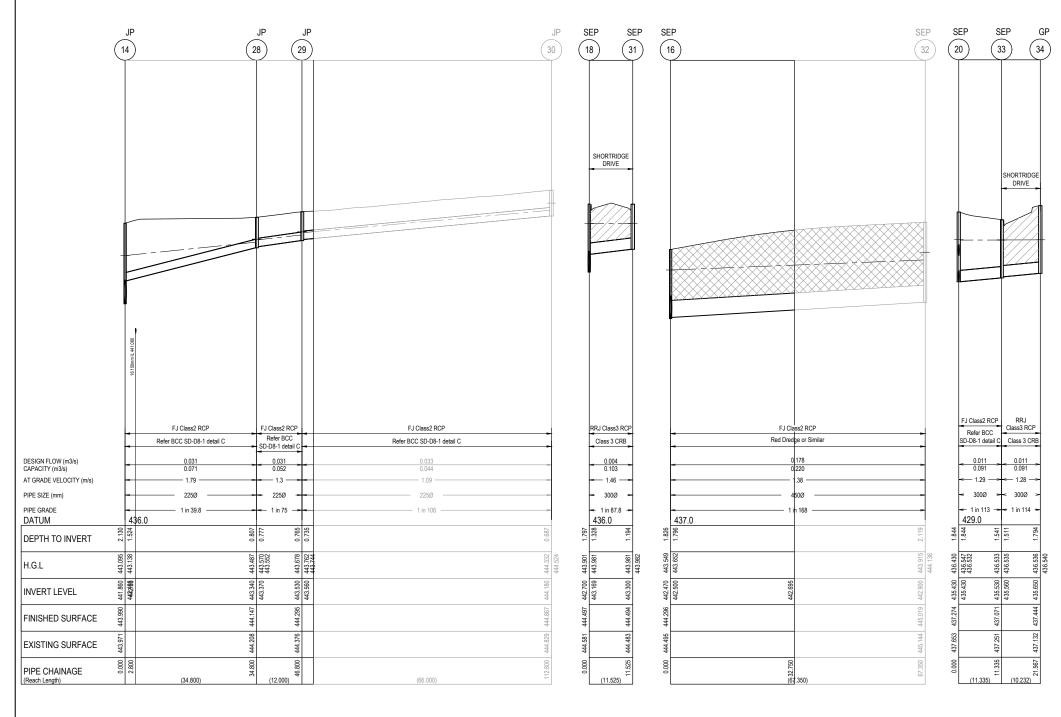
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						AS CONSTRUCTED	01.10.19	JS	JZ
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P2	MINOR AMENDMENTS	29.11.18	JS	JZ	D	BASECOURSE CLASS AMENDED	04.04.19	JS	JZ
P1	MINOR AMENDMENTS	13.11.18	JS	JZ	С	DRAINAGE 4-20-33-34 AND CH 1850 AMENDED	29.03.19	JS	JZ
P0	ISSUED FOR INFORMATION	19.10.18	JS	JZ	В	ISSUED FOR CONSTRUCTION	18.03.19	JS	JZ
REV	DESCRIPTION	DATE	DRN.	APP.	REV	DESCRIPTION	DATE	DRN.	APP.



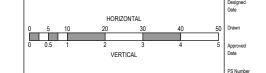

LUCAS STAGE E2	Sheet			
· · · · · · · · · · · · · · · · · · ·	Scale			
CITT OF BALLARAT	1.500 H	1.50 V		
DRAINAGE LONGITUDINAL SECTIONS	1.00011	1.00 V	@ /\i	
	Project Ref	Stage No	Drawing No	Rev
(SPEEL 2 OF 3)	1800971	E2	401	G
STAGE E2 CITY OF BALLARAT DRAINAGE LONGITUDINAL SECTIONS (SHEET 2 OF 3)	1:500 H	Stage No	Drawing No	Rev G



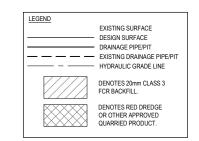

#### PIT SCHEDULE

PIT				INTERNAL		INLET		OUTLET		PIT		
NAME	TYPE	EASTING	NORTHING	WD	LEN	DIA	INV LEV	DIA	INV LEV	SETOUT RL	DEPTH	REMARKS
1	ENDWALL	744666.207	5840651.575	0	0	750	433.615			437.131	2.961	ENDWALL & GRILL
2	SIDE ENTRY PIT	744678.842	5840689.695	1.0	0.9	750	434.450	750	434.420	437.471	3.051	PROVIDE STEP IRON
3	SIDE ENTRY PIT	744680.930	5840701.270	1.0	0.9	750	434.700	750	434.670	437.479	2.809	PROVIDE STEP IRON
4	SIDE ENTRY PIT	744696.869	5840714.164	1.0	0.9	750	435.200	750	435.170	437.314	2.144	PROVIDE STEP IRON
						300	435.330					
5	SIDE ENTRY PIT	744698.286	5840729.620	1.0	0.9	750	435.500	750	435.470	437.889	2.419	PROVIDE STEP IRON
6	SIDE ENTRY PIT	744711.145	5840801.999	1.0	0.9	750	437.260	750	437.230	440.119	2.889	PROVIDE STEP IROI
						300	438.700					
7	SIDE ENTRY PIT	744722.865	5840867.966	1.0	0.9	750	439.400	750	438.350	441.682	3.332	PROVIDE STEP IRO
						225	440.411					
						300	440.145					
8	JUNCTION PIT	744728.060	5840897.208	1.0	0.9	600	439.970	750	439.930	442.554	2.624	PROVIDE STEP IRO
						750	439.970					
9	SIDE ENTRY PIT	744734.199	5840918.614	0.9	0.9	600	440.700	600	440.400	443.077	2.677	PROVIDE STEP IRO
10	JUNCTION PIT	744738.083	5840941.048	0.9	0.9	600	441.060	600	441.030	443.665	2.635	PROVIDE STEP IRO
						300	442.620					
11	SIDE ENTRY PIT	744756.946	5840937.696	0.9	0.9	600	441.330	600	441.300	443.584	2.284	PROVIDE STEP IRO
12	SIDE ENTRY PIT	744758.474	5840946.346	0.9	0.9	600	441.490	600	441.460	443.585	2.125	PROVIDE STEP IRO
13	SIDE ENTRY PIT	744755.809	5840960.784	0.9	0.9	600	441.680	600	441.650	443.900	2.250	PROVIDE STEP IRO
14	JUNCTION PIT	744757.980	5840972.434	0.9	0.9	600	441.890	600	441.860	443.990	2.130	PROVIDE STEP IRO
						225	442.466					
15	JUNCTION PIT	744763.350	5841002.659	0.9	0.9	600	442.290	600	442.260	444.249	1.989	PROVIDE STEP IRO
16	SIDE ENTRY PIT	744770.578	5841014.479	0.9	0.9	525	442.500	600	442.470	444.296	1.826	PROVIDE STEP IRO
						450	442.500					
17	SIDE ENTRY PIT	744772.118	5841023.143	0.9	0.9	525	442.610	525	442.580	444.296	1.716	PROVIDE STEP IRO
18	SIDE ENTRY PIT	744766.086	5841031.781	0.9	0.9	525	442.730	525	442.700	444.497	1.797	PROVIDE STEP IRO
						300	443.169					
19	JUNCTION PIT	744769.359	5841049.634	0.9	0.9			525	442.830	444.633	1.803	PROVIDE STEP IRO
20	SIDE ENTRY PIT	744708.433	5840711.549	0.9	0.9	300	436.120	300	435.430	437.274	1.844	PROVIDE STEP IRO
						300	435.430					
21	JUNCTION PIT	744714.884	5840730.859	0.6	0.9			300	436.897	438.031	1.134	PROVIDE STEP IRO
22	SIDE ENTRY PIT	744727.896	5840804.101	0.9	0.9			300	438.869	440.233	1.364	PROVIDE STEP IRO
23	JUNCTION PIT	744686.534	5840874.420	0.6	0.9			225	440.780	441.904	1.125	PROVIDE STEP IRO
24	SIDE ENTRY PIT	744738.645	5840864.604	0.9	0.9			300	440.307	441.667	1.360	PROVIDE STEP IRO
25	JUNCTION PIT	744724.004	5840903.819	1.0	0.9	750	440.050	750	440.020	442.681	2.661	PROVIDE STEP IRO
26	SIDE ENTRY PIT	744665.049	5840914.395	0.9	0.9			750	440.350	442.378	2.028	PROVIDE STEP IRO
27	SIDE ENTRY PIT	744739.932	5840963.605	0.75	0.9			300	442.850	443.898	1.048	PROVIDE STEP IRO
28	JUNCTION PIT	744792.243	5840966.347	0.9	0.9	225	443.370	225	443.340	444.147	0.807	
29	JUNCTION PIT	744794.342	5840978.162	0.9	0.9	225	443.560	225	443.530	444.295	0.765	
30	JUNCTION PIT	744859.325	5840966.617	0.6	0.9			225	444.180	444.867	0.687	
31	SIDE ENTRY PIT	744754.738	5841033.797	0.75	0.9			300	443.300	444.494	1.194	PROVIDE STEP IRO
32	SIDE ENTRY PIT	744836.873	5841002.599	0.9	0.9			450	442.900	445.019	2.119	PROVIDE STEP IRO
33	SIDE ENTRY PIT	744715.886	5840699.448	0.9	0.9	300	435.560	300	435.530	437.071	1.541	PROVIDE STEP IRO
34	GRATED PIT	744704.783	5840696,140	0.6	0.9			300	435,650	437,444	1.794	PROVIDE STEP IROI

- SETOUT CO-ORDINATES TO PIT CENTRE OF A 900X900 PIT
   SETOUT LEVEL TO PIT COVER LEVEL
   SETOUT LEVEL TO PIT COVER LEVEL
   SETOUT LEVEL TO BE PROVIDED IN PITS DEEPER THAN 1m
   COVER LEVELS AND PIT CO-ORDINATES ARE APPROX ONLY AND SHOULD BE CONSTRUCTED
   TO SUIT FINISHED SURFACE
   PITS IN NON TRAFFICABLE AREAS TO BE CONSTRUCTED WITH CONCRETE LIDS AND
   SURROUNDS AS PER BALLARAT CITY STANDARD DRAWING SD-P1-1 / SD-P10-1
   PITS IN TRAFFICABLE AREAS TO BE CONSTRUCTED WITH HEAVY DUTY LIDS AND SURROUNDS.

APPROVED By JeffColb at 12:34 pm, Oct 02, 2019

> PLANS FOR APPROVAL AS-CONSTRUCTED PLANS

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						AS CONSTRUCTED	01.10.19	JS	JZ
Α	ISSUED FOR APPROVAL	04.03.19	JS	JZ	F	FOOTPATH IN NORTH/WEST MESSENGER AMENDED	29.04.19	JS	JZ
P3	FOR COUNCIL APPROVAL	06.02.19	JS	JZ	E	DRAIN LONG SECTIONS FILL NOTE AMENDED	11.04.19	JS	JZ
P2	MINOR AMENDMENTS 29.11.18 JS		JS	JZ	D	BASECOURSE CLASS AMENDED	04.04.19	JS	JZ
P1	MINOR AMENDMENTS	13.11.18	JS	JZ	С	DRAINAGE 4-20-33-34 AND CH 1850 AMENDED	29.03.19	JS	JZ
P0	ISSUED FOR INFORMATION	19.10.18	JS	JZ	В	ISSUED FOR CONSTRUCTION	18.03.19	JS	JZ
REV	DESCRIPTION	DATE	DRN.	APP.	REV	DESCRIPTION	DATE	DRN.	APP.

Beveridge Williams J.SPARK

Project LUCAS STAGE E2 CITY OF BALLARAT

DRAINAGE LONGITUDINAL SECTIONS & PIT SCHEDULE (SHEET 3 OF 3)

Sheet 28 of 28 1:500 H 1:50 V @ A1 Stage No Drawing No

> 1800971 E2 402 G