GENERAL:

THE BUILDER & SUBCONTRACTORS SHALL VERIFY ALL DIMENSIONS, LEVELS, SETBACKS AND SPECIFICATIONS PRIOR TO COMMENCING ANY WORKS OR ORDERING MATERIALS . - REPORT ALL DISCREPANCIES TO OFFICE FOR CLARIFICATION.

USE WRITTEN DIMENSIONS ONLY, DO NOT SCALE PLANS

ALL BUILDING WORKS CONFORM WITH BUILDING ACT 1993, BUILDING REGULATIONS 2020, BUILDING CODE OF AUSTRALIA 2020 (BCA) & ADOPTED AUSTRALIA STANDARDS

BUILDING/S ON ALLOTMENTS IN DESIGNATED BUSHFIRE AREA CONSTRUCTED IN ACCORDANCE WITH AS 3959 FOR APPROPRIATE BAL LEVEL CALCULATED FOR SITE

THE FFL TO AHD OF DWELLING TO BE CONFIRMED BY LICENSED LAND SURVEYOR PRIOR TO FRAME INSPECTION FOR ANY ALLOTMENT/S DESIGNATED LAND LIABLE TO FLOOD AND/OR DESIGNATED LAND -OVERLAND FLOW

BUILDINGS MUST COMPLY WITH CLAUSE 3.10.3 BCA AND ABCB FLOOD HAZARD MANAGEMENT STANDARD WHEN A SITE IS DESIGNATED AS LAND LIABLE TO FLOOD

PERFORMANCE SOLUTIONS PURSUANT TO PART 2 BCA APPLY WITH CONSTRUCTION OF THIS BUILDING AS AN ALTERNATIVE TO THE DEEMED TO SATISFY REQUIREMENTS OF THE BCA

DOORS TO SANITARY COMPARTMENT WHERE TOILET PAN IS WITHIN 1200mm FITTED WITH REMOVABLE/LIFT-OFF HINGES

ANTI-PONDING DEVICE/BOARDS TO BE INSTALLED PURSUANT TO CLAUSE 3.5.2.5, BCA

SITE WORKS/SITING:

FOOTINGS, BUILDING & SITE WORKS TO BE CONSTRUCTED AND REMAIN WITHIN TITLE BOUNDARIES. (UNLESS CONSENT OBTAINED)

EARTHWORKS (UN-RETAINED) SHALL NOT EXCEED 2000M MAX.

SLOPE RATIOS FOR EARTHWORKS:

SOIL CLASS	SITE CUT	SITE FILL
	MAX. RATIO	MAX. RATIO
STABLE ROCK - CLASS A	8:1	2:3
SAND -CLASS A	1:2	1:2
FIRM CLAY -CLASS M-E	1:1	1:2
SOFT CLAY -CLASS M-E	2:3	NOT SUITABLE

SLOPE RATIOS FOR FILLED SOFT CLAY (CLASS M-E) AND ALL EARTHWORKS FOR CLASS-P SITES MUST BE SPECIFIED BY THE DESIGNING ENGINEER & NOMINATED ON SITE PLAN

TERMITE TREATMENT:

DWELLING TO BE PROTECTED AGAINST SUBTERRANEAN TERMITES IN ACCORDANCE WITH AS 3660 & PART 3.1.4 BCA WHERE NOMINATED BY MUNICIPALITY AS AN AFFECTED AREA

DRAINAGE:

SITE DRAINAGE TO COMPLY WITH CLAUSE 3.1.3.3 BCA (DRAIN AWAY FROM BUILDING FOUNDATIONS TO AVOID PONDING)

STORMWATER DRAINAGE TO COMPLY WITH CLAUSE 3.1.3.5 BCA AND CONNECTED TO LEGAL POINT OF DISCHARGE (LPOD) AS NOMINATED BY LOCAL MUNICIPALITY'S AUTHORITY

STEP DOWNS/FREEBOARDS:

- STEP DOWNS ABOVE EXTERNAL CONC. OR BALCONIES SLOPED AWAY FROM DWELLING = 50mm MIN / 1m - STEP-DOWNS ABOVE ALL OTHER SURFACES = 150mm

FOUNDATIONS:

ALL FOUNDATIONS CONSTRUCTED IN ACCORDANCE WITH ENGINEERS CERTIFIED DESIGN, PART 2.3 BCA AND AS-2870

CONCRETE TO BE MANUFACTURED TO AS-3600

PROVIDE CLEARANCE FROM UNDERSIDE OF BEARER TO FINISHED GROUND LEVEL OF 200mm OR AS NOMINATED BY ENGINEER

SOIL CLASSIFICATION AS PER SOIL REPORT. FOUNDATIONS/FOOTINGS FOUNDED AT THE MINIMUM DEPTHS INDICATED IN THE SOIL REPORT.

GUTTERS & DOWNPIPES:

ALL GUTTERS & DOWNPIPES MUST BE PROVIDED WITH CERTIFICATE OF COMPLIANCE ISSUED BY PLUMBER THAT CLEARLY STATES COMPLIANCE WITH AS-3500.3

CONDENSATION/EXHAUST MANAGEMENT:

WALL SISALATION TO BE VAPOUR PERMEABLE MEMBRANE & COMPLY WITH AS-4200.1 AND INSTALLED PURSUANT TO AS-4200.2

ALL EXHAUST FANS TO ACHIEVE A MIN. 40-LITRE/s FLOW RATE

ALL EXHAUST FANS & RANGEHOODS MUST DISCHARGE TO EXTERNAL AIR VIA WALL OR ROOF VENT & NOT INTO ANY ROOF SPACE

WALLS / CLADDING:

BRICKWORK TO COMPLY WITH PART 3.3 BCA, AS-3700 & AS-4773

PROVIDE 10mm MIN. ARTICULATION JOINTS TO ENGINEER'S DESIGN AND CLAUSE 3.3.5.13 BCA (5m MAX. SPACING)

HEBEL/LOXO PANELS PROVIDED & INSTALLED TO COMPLY WITH MATA TESTING AUTHORITY APPROVED MANUFACTURER'S SPECIFICATIONS

FOAM BOARD CLADDING PROVIDED & INSTALLED TO COMPLY WITH NATA TESTING AUTHORITY APPROVED MANUFACTURER'S SPECIFICATIONS

FOR BUILDINGS IN CLOSE PROXIMITY TO THE SEA ENSURE THAT ALL STEEL WORK, BRICK CAVITY TIES AND STEEL LINTELS ETC. THAT ARE EMBEDDED OR FIXED INTO MASONRY BE PROTECTED IN ACCORDANCE WITH A.S.1650 OR A.S. 3700 - TABLE 2.2, HOT DIPPED GALVANISED, STAINLESS STEEL OR CADMIUM COATED.

SUB-FLOOR VENTS TO PROVIDE A RATE OF 7500mm SQ. CLEAR VENTILATION PER 1000mm RUN OF EXTERNAL MASONRY WALL (VENTS AT 1000mm MAX. CTS)

ISSUE WALL/TRUSS SPECIFICATIONS & COMPUTATIONS TO BUILDING SURVEYOR PRIOR TO FRAME INSPECTION

GLAZING / WINDOWS:

GLASS TYPE & INSTALLATION OF ALL GLAZING TO WINDOWS, DOORS, SHOWER SCREENS, BALUSTRADES AND ROOF LIGHTS TO COMPLY WITH PART 3.6 BCA & AS-1288 & AS-2047

WINDOWS/DOORS TO BE FLASHED & SEALED ALL AROUND PROVIDE WEATHER-STRIP TO ALL EXTERNAL DOORS

WINDOW & EXTERNAL DOOR SIZES ARE NOMINAL ONLY. ACTUAL SIZE MAY VARY ACCORDING TO MANUFACTURER.

RESTRICT ALL 1st FLOOR BEDROOM WINDOWS TO 125mm MAX. OPENING

ENSURE GAS COOKTOP BURNERS ARE KEPT 200mm CLEAR OF GLASS SPLASHBACK OR ALT. NON-COMBUSTIBLE MATERIAL USED

REFER TO ENGINEERS SOIL REPORT FOR WIND GUST SPEED APPLICABLE TO THIS ALLOTMENT.

WATERPROOFING:

ALL WET AREAS TO COMPLY WITH CLAUSE 3.8.1.2 BCA AND AS-3740.

BALCONIES TO COMPLY WITH CLAUSE 3.8.1.3 BCA AND AS-4654 PARTS 1 & 2

WALL FINISHES SHALL BE IMPERVIOUS TO MIN HEIGHT OF:
- 1800mm ABOVE FLOOR LEVEL TO SHOWER ENCLOSURES
- 150MM ABOVE BATHS, BASINS, SINKS AND TROUGHS IF

WITHIN 75mm OF THE WALL. CONTRACTORS (FLEXITRAY OR EQ.) TO ISSUE CERTIFICATE

SMOKE ALARMS:

INTERCONNECTED SMOKE ALARMS IN ACCORDANCE WITH PART 3.7.5 BCA & AS- 3886 (INC. BATTERY BACKUP)

STAIRS & STEPS:

STAIR REQUIREMENTS: (WHERE APPLICABLE)

- * RISERS 190mm MAXIMUM, 115mm MINIMUM
- * GOING 355mm MAXIMUM, 240mm MINIMUM (PRIVATE STAIRS);
- * RISERS AND TREADS TO BE CONSTANT IN SIZE THROUGHOUT FLIGHT.
 MAXIMUM GAP BETWEEN OPEN RISERS NOT TO EXCEED 125mm
- * PROVIDE BALUSTRADE AT 1000mm MINIMUM HEIGHT TO BALCONIES, LANDINGS & DECKS MORE THAN 1000mm ABOVE GROUND LEVEL
- PROVIDE HANDRAIL 865mm MINIMUM HEIGHT ABOVE STAIR NOSING
- * MAXIMUM GAP/OPENINGS TO BALUSTRADE 125mm MAX.
- * HANDRAIL TO AT LEAST 1-SIDE OF STAIRWAY, MUST BE CONTINUOUS & HAVE NO OBSTRUCTIONS OR BREAK HANDHOLD -EXCEPT NEWEL POST
- * MINIMUM LANDING DEPTH TO BE NO LESS THAN 750mm
- * MINIMUM HEAD CLEARANCE UNDER STAIR IS 2000mm
- * SLIP RESISTANT TREATMENT OR NOSING TO STAIR STEPS PROVIDED IN ACCORDANCE WITH CLAUSE 3.9.1.4 BCA

ENERGY EFFICIENCY:

AMENDMENTS/NOTES:

23.8.21 :BATH & ENSUITE WINDOWS, KITCHEN BULKHEAD

DWELLING AND GARAGE TO COMPLY WITH PART 3.12 BCA & JOB SPECIFIC 6-STAR ENERGY REPORT

DWELLING TO BE PROVIDED WITH 2000-LITRE WATER TANK CONNECTED TO SANITARY FLASHING SYSTEMS OR SOLAR WATER HEATER INSTALLED IN ACCORDANCE WITH PLUMBING REGULATIONS PER CLAUSE 3.12.0 (a), BCA

PROVIDE THERMAL INSULATION AS PER BCA -VICTORIAN APPENDIX

1. RFL TO COMPLY WITH A.S./NZS 4200.2 AND HAVE A
FLAMMABILITY INDEX OF NOT LESS THAN 5.

LEGAL:

THESE PLANS HAVE BEEN PREPARED BY NEIL MARTINS FOR EXCLUSIVE USE OF BUILDER AND FOR THE PURPOSE EXPRESSLY NOTIFIED TO AUTHOR. NO OTHER PERSON MAY USE THESE PLANS WITHOUT WRITTEN CONSENT OR LEGAL PROCEEDINGS WILL BE TAKEN.





MARTINS & ASSOCIATES
CAD DESIGN / DRAFTING M:0406 716746. DP-AD147

REPRODUCTION WITH OR WITHOUT MODIFICATIONS FORBIDDEN

ENGINEERING & PLANNING:

COMPLY WITH ANY LOCAL BY-LAWS, MCP'S, DEVELOPER GUIDELINES OR TOWN PLANNING REQUIREMENTS
-NO MATTER HOW CONTRADICTORY OR STUPID

PLANS TO BE READ IN CONJUNCTION WITH ANY ENGINEERS DRAWINGS, COMPUTATIONS & LAYOUTS (STRUCTURAL AND CIVIL

WORKING DRAWING COVER / FACADE

W.HOUSE-OFFICE

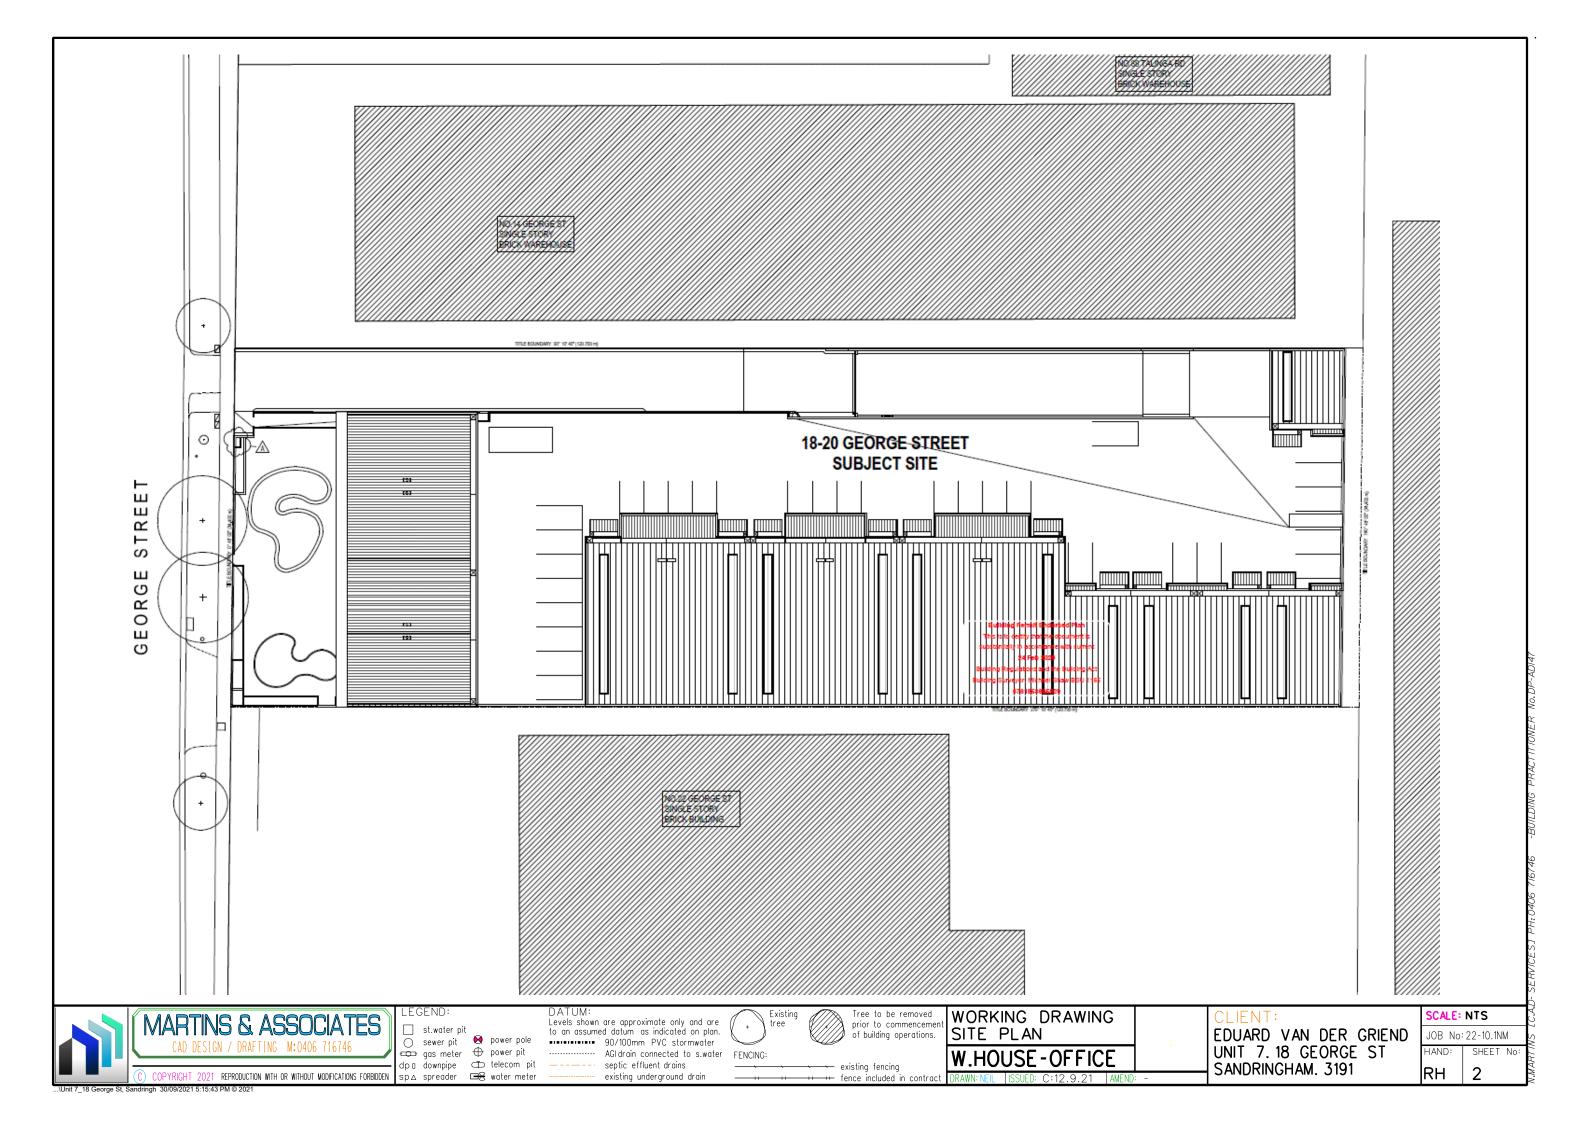
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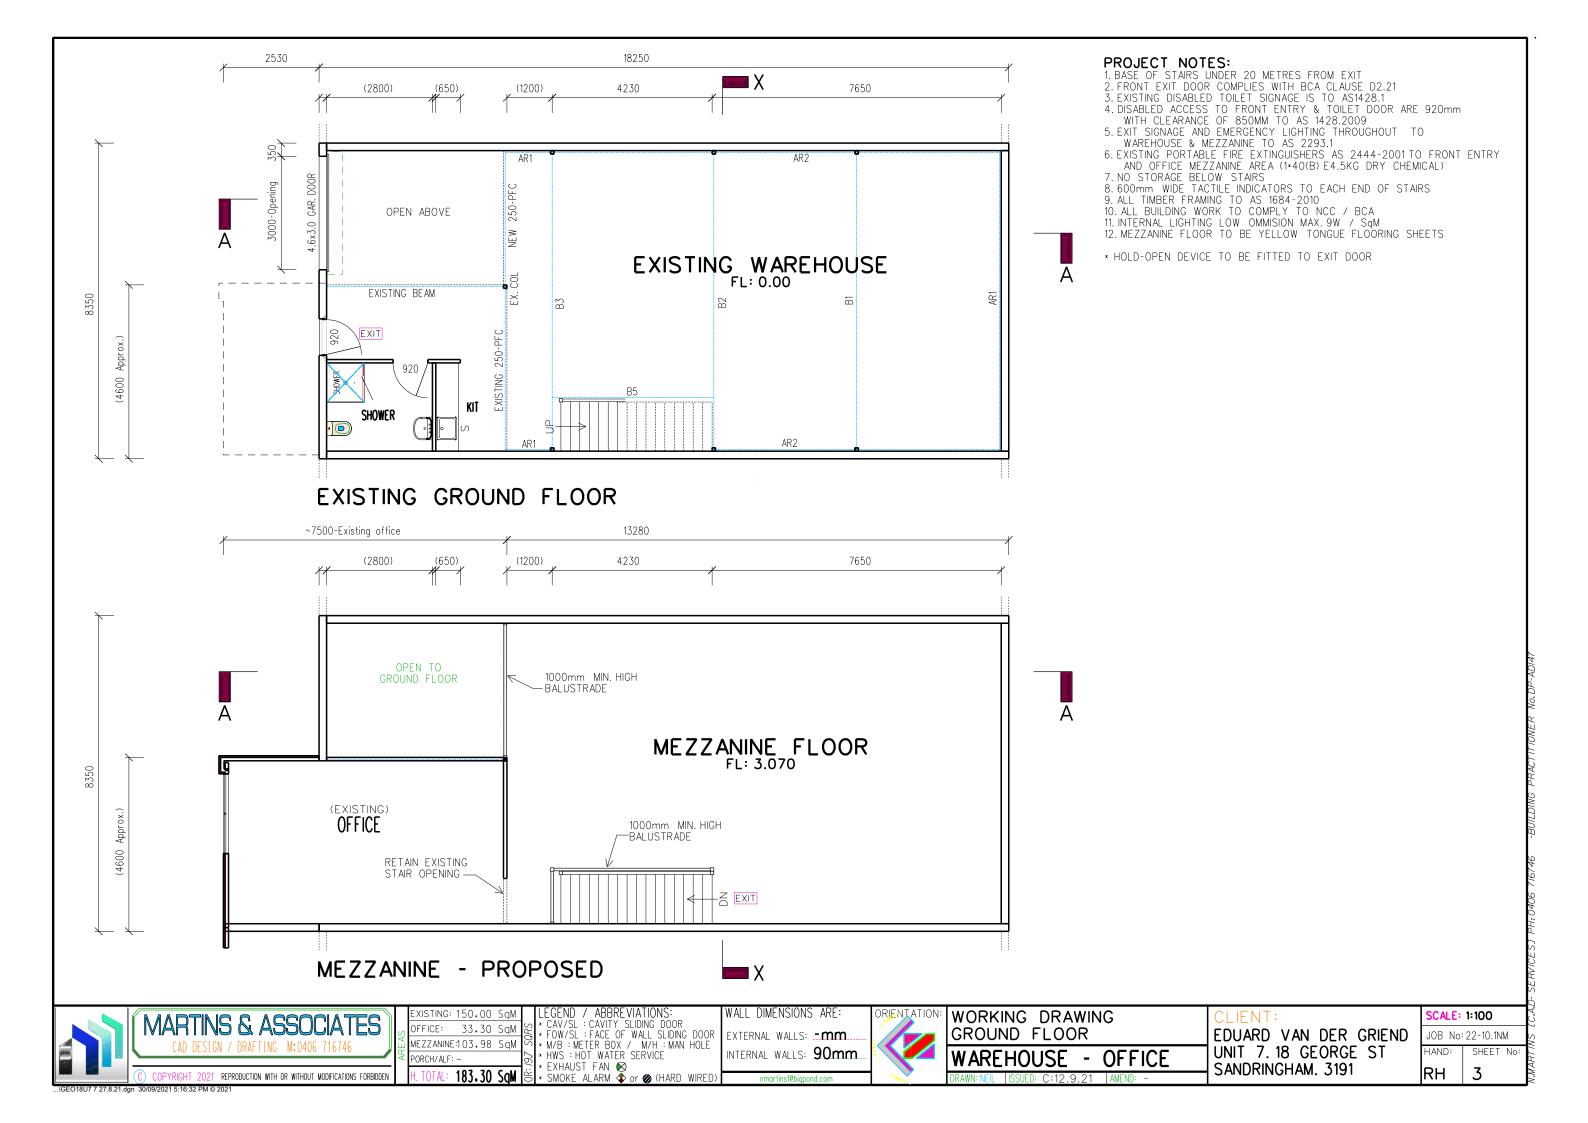
EDUARD VAN DER GRIEND UNIT 7.18 GEORGE ST SANDRINGHAM. 3191 SCALE: AS SHOWN

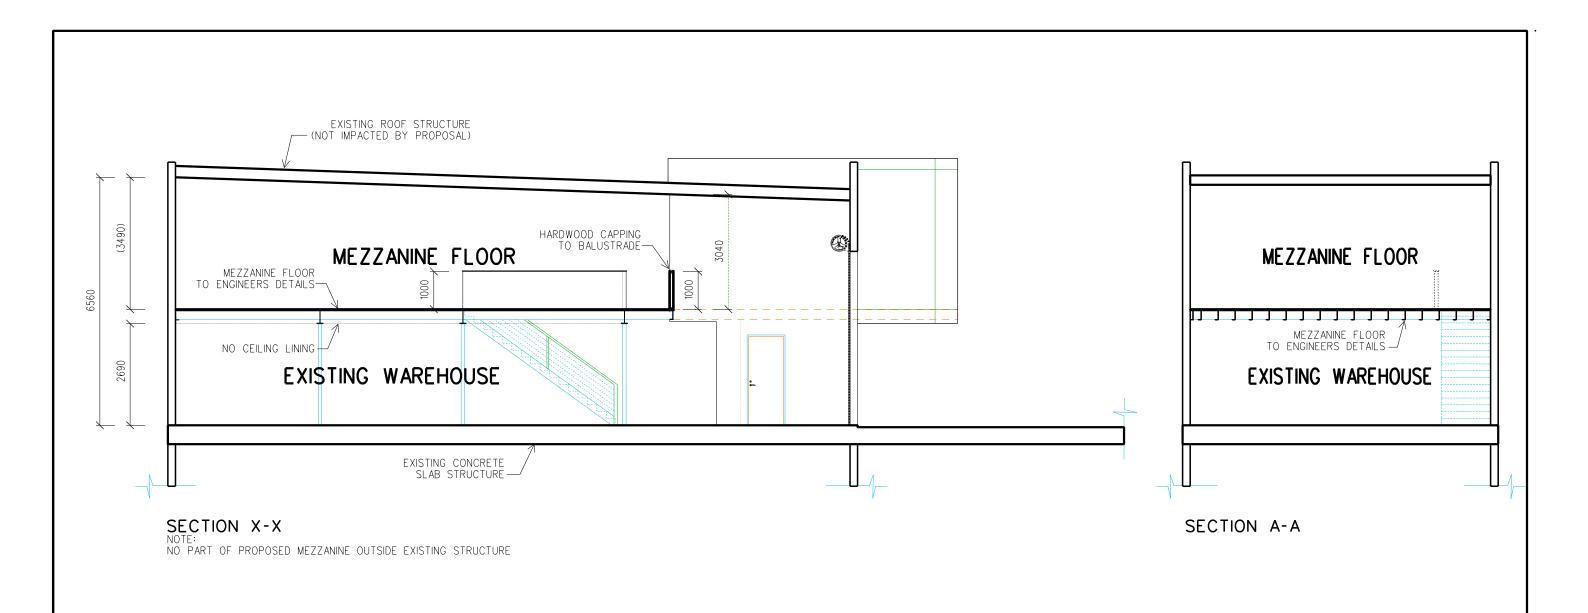
JOB No: 22-10.1NM

HAND: SHEET No:

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MARTINS & ASSOCIATES REPRODUCTION WITH OR WITHOUT MODIFICATIONS FORBIDDEN

BB : BAGGED BRICKWORK

FC : FIBRE-CEMENT CLADDING (PAINTED) RC : RENDERED F.CEMENT CLADDING

RB : RENDERED BRICKWORK/BLOCKWORK FP: FLUSH PANEL WP: WEATHER PROOF CJ : DENOTES CONTROL JOINT LOCATED ON LONG WALLS AT 5m MAX. CENTRES

RENDERED FINISH TO BRICKWORK

WEATHERBOARD CLADDING (F.C) STACK-STONE WALL CLADDING

WORKING DRAWING **ELEVATIONS** WAREHOUSE - OFFICE

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SCALE: 1:100 JOB No: 22-10.1NM HAND: SHEET No: RH 4