

	Electrical Fixture Schedule					
Mark	Family and Type	Circuit Numbe				
1	Twin Switched Socket Outlet: Standard	CRT-5				
2	Twin Switched Socket Outlet: Standard Twin Switched Socket Outlet: Standard	CRT-5				
	Twin Switched Socket Outlet: Standard	CRT-5				
4	Twin Switched Socket Outlet: Standard	CRT-5				
5	CRT-5					
6	Twin Switched Socket Outlet: Standard	CRT-5				
7	Twin Switched Socket Outlet: Standard	CRT-7				
8	Twin Switched Socket Outlet: Standard	CRT-7				
9	Twin Switched Socket Outlet: Standard	CRT-7				
10	Twin Switched Socket Outlet: Standard	CRT-7				
11	Twin Switched Socket Outlet: Standard	CRT-4				
12	Twin Switched Socket Outlet: Standard	CRT-4				

Mark	Family and Type	Circuit Numbe		
13	Twin Switched Socket Outlet: Standard	CRT-4		
14	Twin Switched Socket Outlet: Standard	CRT-4		
15	Twin Switched Socket Outlet: Standard	CRT-6		
16	Twin Switched Socket Outlet: Standard	CRT-6		
Twin Switched Socket Outlet: Standard CRT-6				
18	Twin Switched Socket Outlet: Standard	CRT-6		
19	Twin Switched Socket Outlet: Standard	CRT-5		
20	Twin Switched Socket Outlet: Standard	CRT-6		
21	Twin Switched Socket Outlet: Standard	CRT-6		
22	Twin Switched Socket Outlet: Standard	CRT-2		
23	Twin Switched Socket Outlet: Standard	CRT-2		

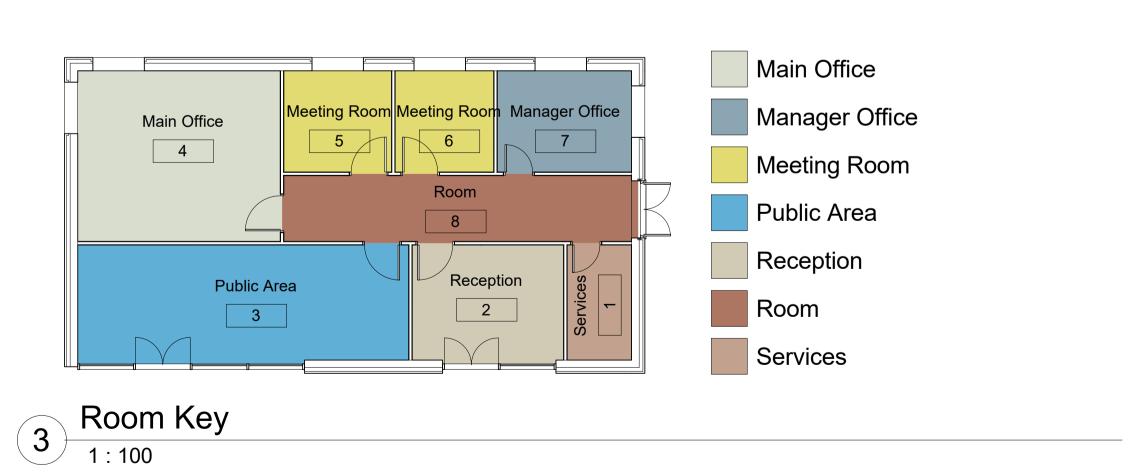
LIT BUILT ENVIRONMENT
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	Lighting Device Schedule						
Mark	Family and Type	Switch ID	Panel	Circuit Number			
1	Lighting Switches: One Way Switch	MO-LS	Main Panel	CRT-1			
2	Lighting Switches: One Way Switch	MR-1-LS	Main Panel	CRT-1			
3	Lighting Switches: One Way Switch	MR-2-LS	Main Panel	CRT-1			
4	Lighting Switches: One Way Switch	MGR-LS	Main Panel	CRT-1			
5	Lighting Switches: One Way Switch	SERV-LS	Main Panel	CRT-3			
6	Lighting Switches: One Way Switch	RA-LS	Main Panel	CRT-3			
7	Lighting Switches: One Way Switch	PA-LS	Main Panel	CRT-3			
8	Lighting Switches: Two Way Switch	COR-LS-A	Main Panel	CRT-3			
9	Lighting Switches: Two Way Switch	COR-LS-B	Main Panel	CRT-3			

	Lighting Fixture Schedule		
Mark	Switch ID	Circuit Number	
3	Plain Recessed Lighting Fixture: 300x1200 - 230	MO-LS	CRT-1
4	Plain Recessed Lighting Fixture: 300x1200 - 230	MO-LS	CRT-1
5	Plain Recessed Lighting Fixture: 300x1200 - 230	MR-1-LS	CRT-1
6	Plain Recessed Lighting Fixture: 300x1200 - 230	MR-2-LS	CRT-1
7	Plain Recessed Lighting Fixture: 300x1200 - 230	MGR-LS	CRT-1
8	Plain Recessed Lighting Fixture: 300x1200 - 230	COR-LS-B	CRT-3
9	Plain Recessed Lighting Fixture: 300x1200 - 230	COR-LS-B	CRT-3
10	Plain Recessed Lighting Fixture: 300x1200 - 230	PA-LS	CRT-3
11	Plain Recessed Lighting Fixture: 300x1200 - 230	PA-LS	CRT-3
12	Plain Recessed Lighting Fixture: 300x1200 - 230	RA-LS	CRT-3
13	Plain Recessed Lighting Fixture: 300x1200 - 230	SERV-LS	CRT-3

1 0 - Lighting 1 : 100



	DB Schedule: Main Panel						7	Your Company			Yo	Your Logo here			
	Location of DB: DB supplied from: Mounting Type: Recessed Enclosure: Type 1		Voltage: 230/400 Wye No. of Phases: 3				A.I.C. Rating: Mains Type: Mains Rating: 100 A MCB Rating: 100 A								
lotes:															
Circuit Iumber	Circuit Designation	Type of Wiring	Circuit Conductors (cs Neutral, CPC	a) Live,	Max Disconnectio n Time allowed by	Protective Device BS(EN)	PD Type	PD Rating	Short Circuit Capacity (kA)	RCD Operating current (mA)	Maximun Permitted BS 767	l by	L2	L3	
CRT-1	J	6491B A (2)	1-#2.5mm, 1-#2.5mm, 1-	#1.5mm				20 A	, ,			1.4 /	4		
CRT-2	Socket	6491B A (2)	1-#2.5mm, 1-#2.5mm, 1-					20 A					1.6 A		
CRT-3		6491B A (2)	1-#2.5mm, 1-#2.5mm, 1-					20 A				0.4		1.7 A	
RT-4	Socket	6491B A (2)	1-#2.5mm, 1-#2.5mm, 1-					20 A				3.1 A			
RT-5 RT-6	Socket Socket	6491B A (2)	1-#2.5mm, 1-#2.5mm, 1- 1-#2.5mm, 1-#2.5mm, 1-					20 A 20 A					5.5 A	4.7 A	
CRT-7	Socket	6491B A (2) 6491B A (2)	1-#2.5mm, 1-#2.5mm, 1-					20 A 20 A				3.1 A	Δ	4.7 A	
CRT-8	Jocket	049 IB A (2)	1-#2.511111, 1-#2.5111111, 1-	# 1.5HHH				20 A				3.17	`		
CRT-9															
RT-10															
RT-11															
CRT-12	-							Tota	al Amps:			1747 \ 8 A	/A 1620 VA 7 A	1450 V 6 A	
oad Cla	ssification		Connected Load	Den	mand Factor	Feti	mated De	emand			Panel	Totals			
	Dwelling Unit		704 VA		66.00%		465 VA								
ther			0 VA		0.00%		0 VA	•		Total Con	n. Load:	4814 VA			
			3 7/1		3.0070		· · · ·			Total Est. I					
										Total Conn.					
										st. Demand					
									i Otal Es	ot. Demand	Surrent.	<i>'</i> ^			
Notes:															
Notes:															

Educational
Exercise
Not for
Construction

Owner

Revit MEP 01

Electrical Details

Project number	RMEP01
Date	Oct 2020
Drawn by	Author
Checked by	Checker
	4.00.4

E-1001

Scale 1:100