



ELEVATION @ GRID A
SCALE: N.T.S.

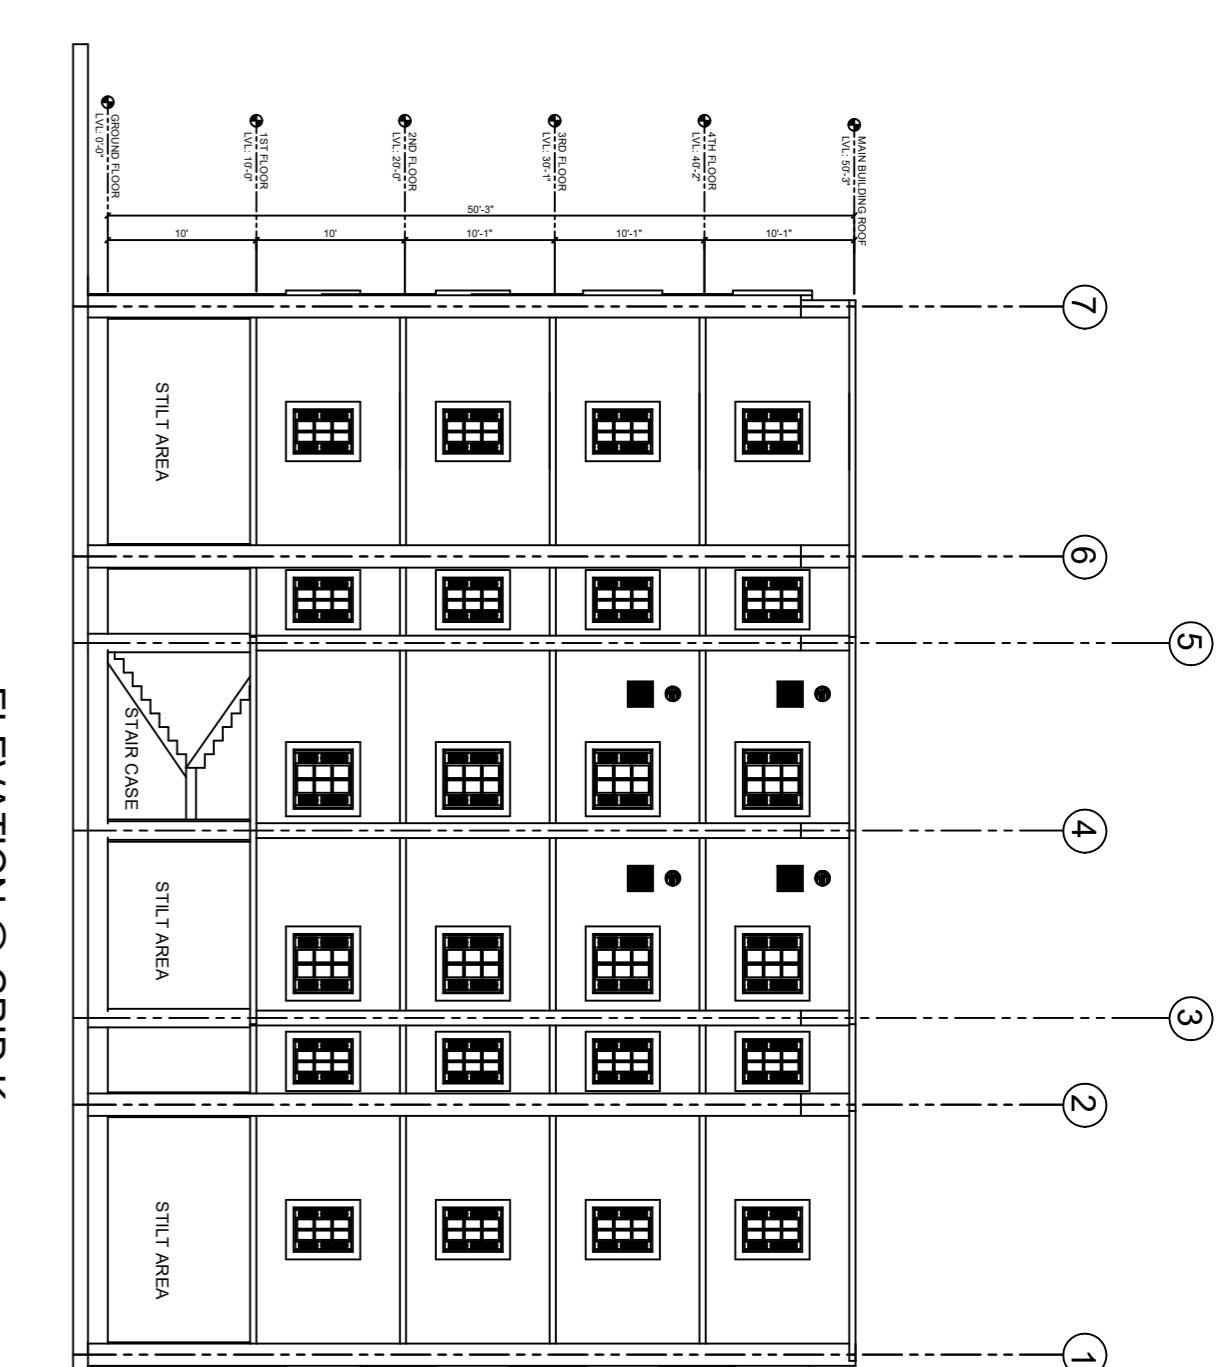


ELEVATION @ GRID K
SCALE: N.T.S.

STAIR ELEVATION
SCALE: N.T.S.

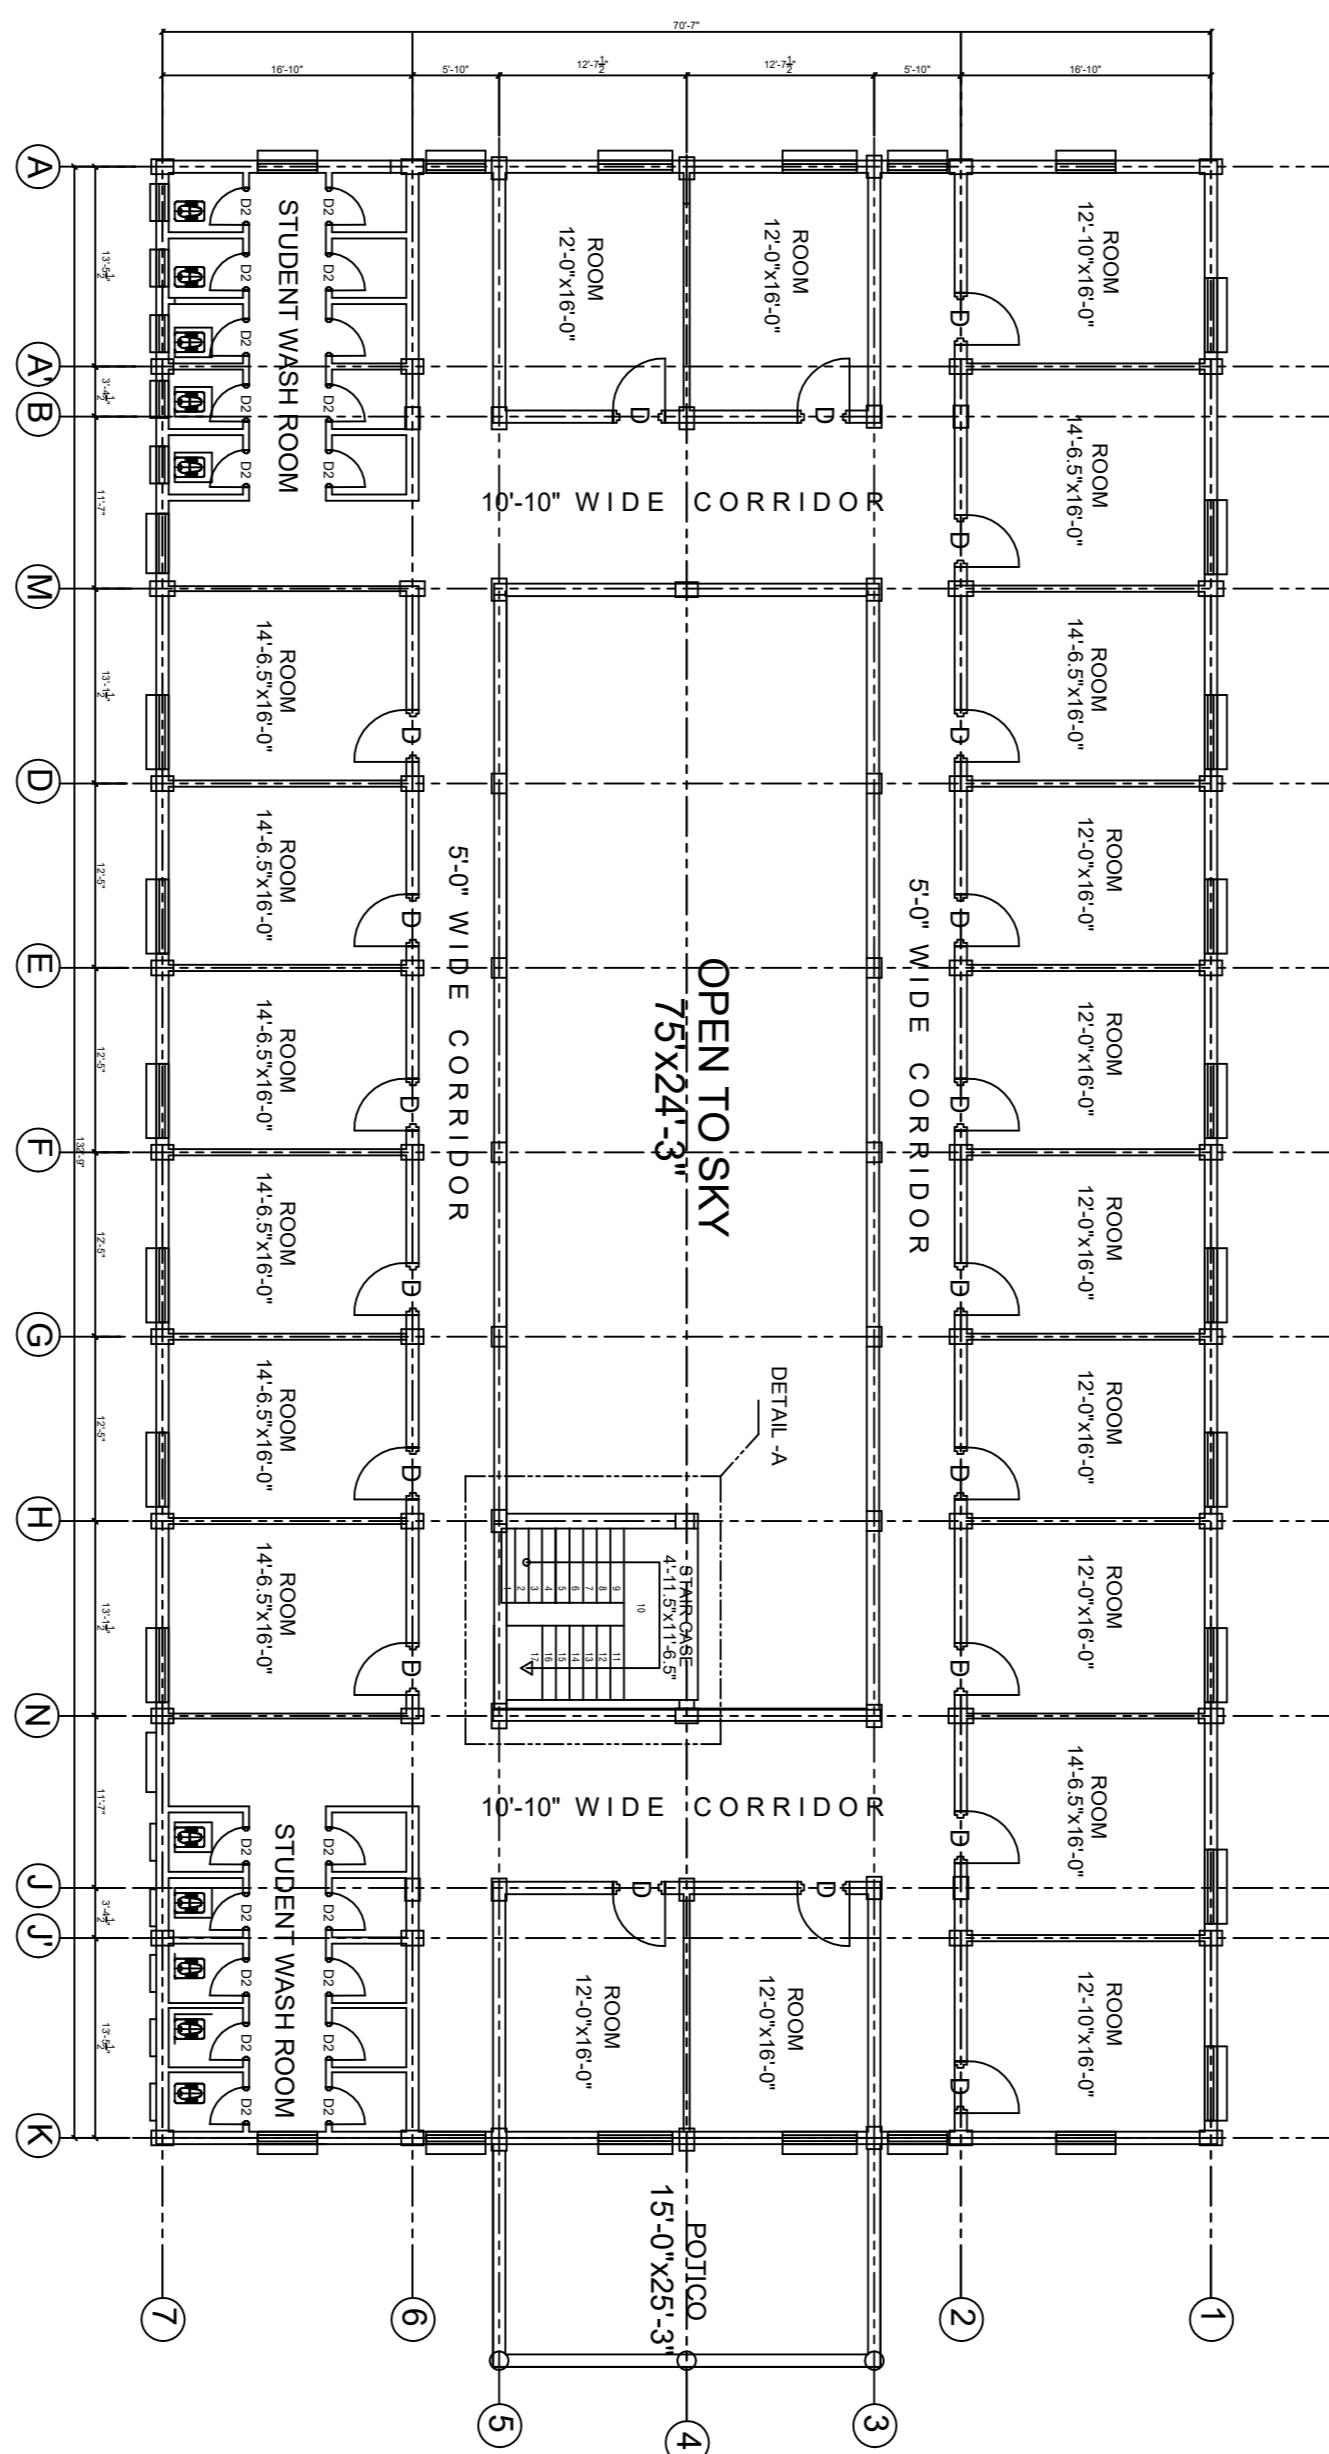

FLOOR FRAMING PLAN
SCALE: N.T.S.

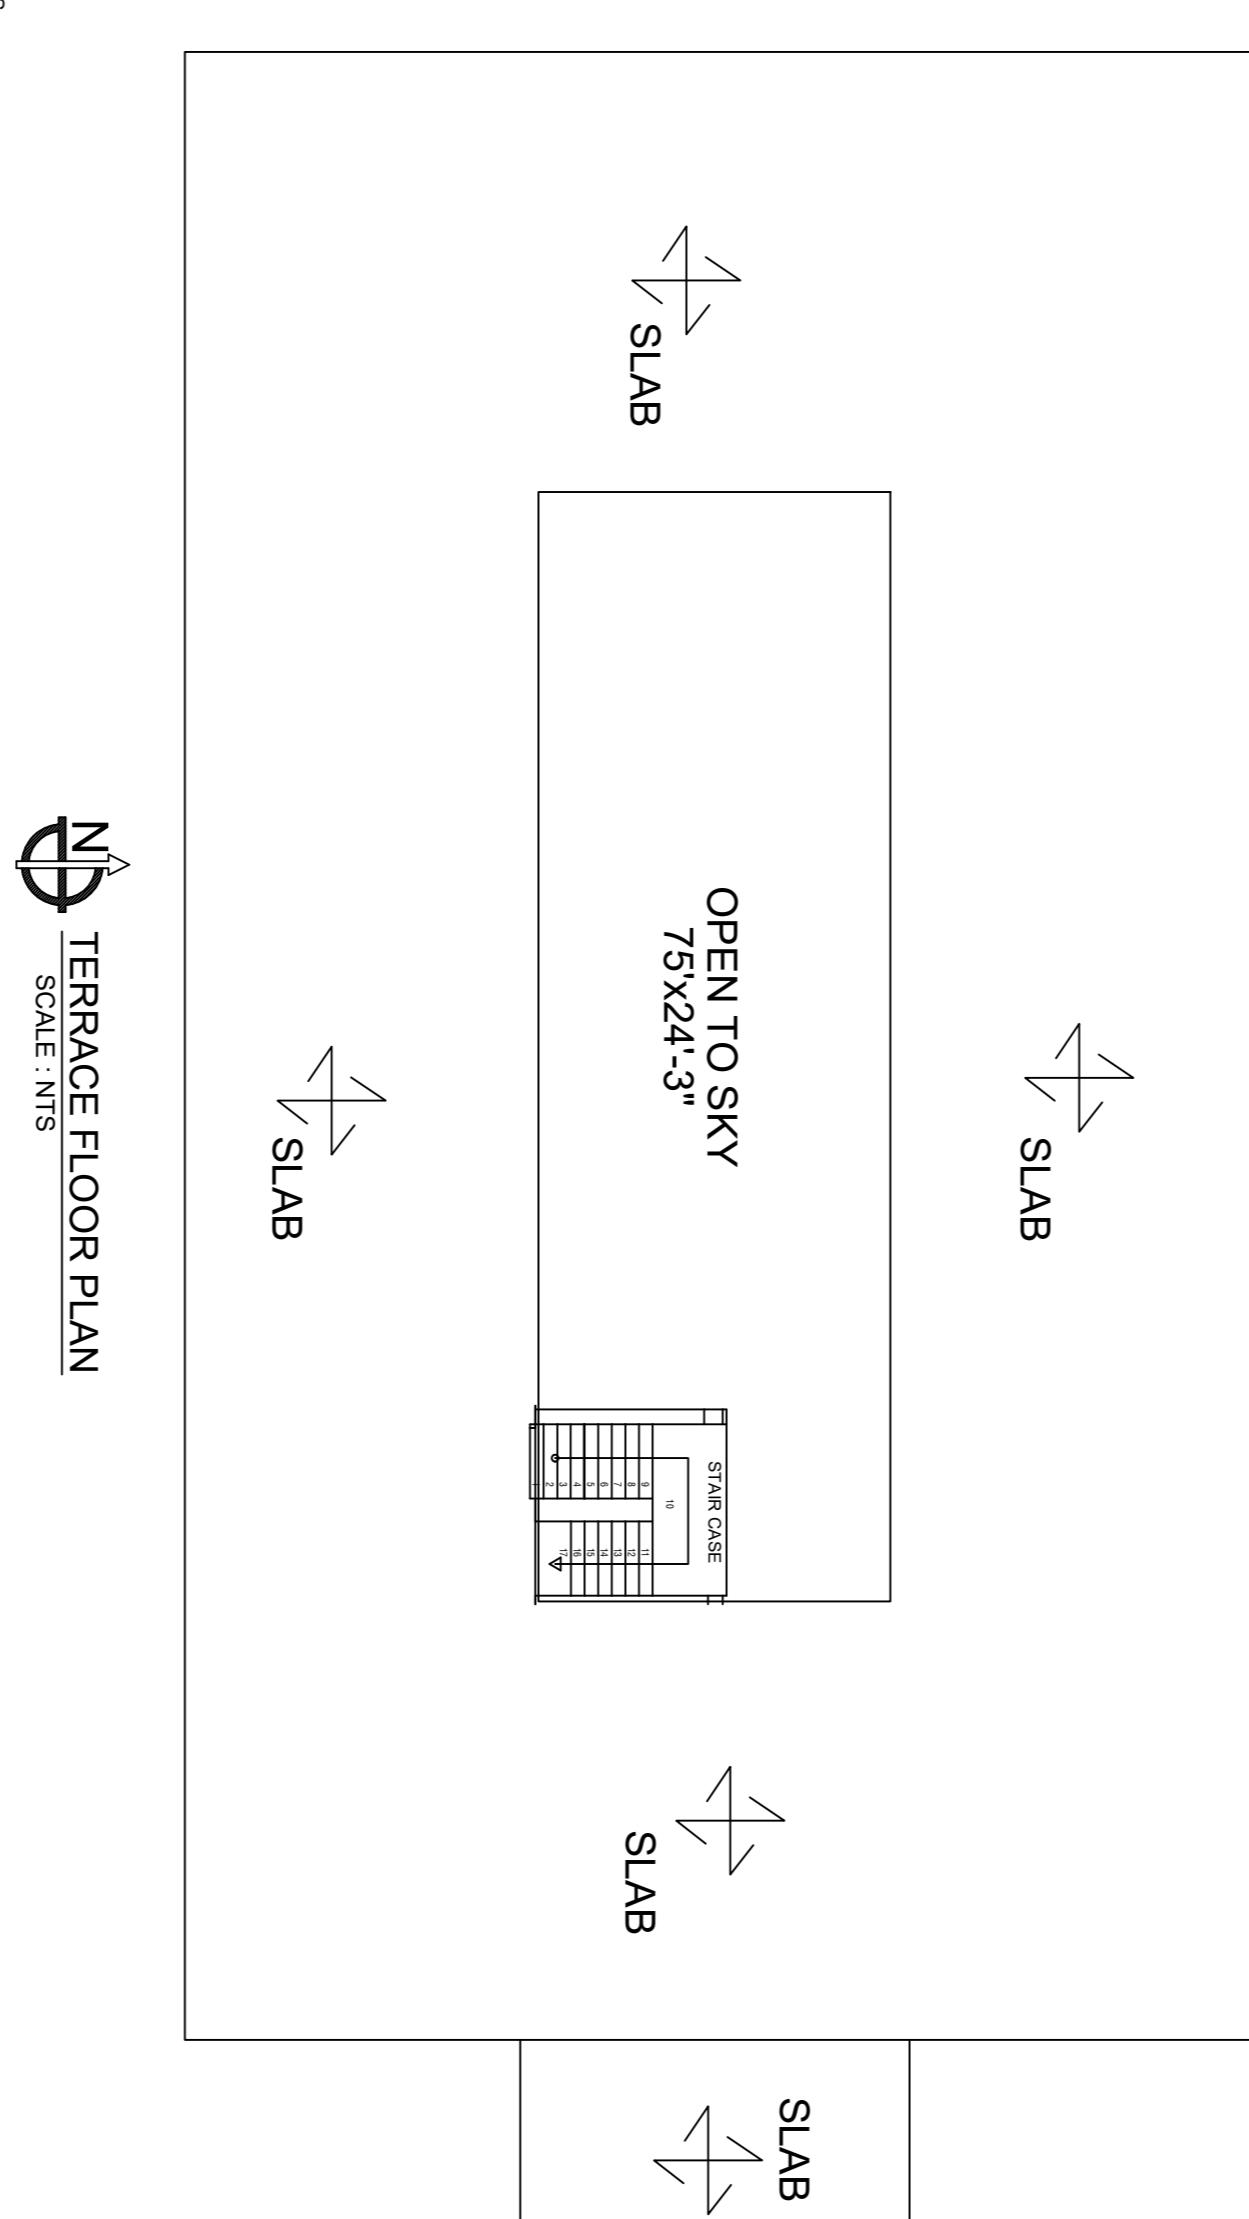


TERRACE FLOOR PLAN
SCALE: N.T.S.


LEGEND	
	Concrete
	COLUMN
D	DOOR [3'-6"x7']
D2	DOOR [2'-6"x6']
W	WINDOW [4'-0"x4'-0"]
V	VENT [1'-8"x1'-8"]

CODE USE:-	
IS 875 PART -1	IS 875 PART -1
IS 875 PART -3	IS 875 PART -3
IS 875 PART -5	IS 875 PART -5
IS 1893 PART -1 - 2002	IS 1786 IS 2911

NOTES:
 1. ALL DIMENSIONS ARE TO BE CHECKED AND
 VERIFIED BEFORE EXECUTION OF THE WORK.
 2. ALL DIMENSIONS ARE IN MILLIMETRES UNLESS
 OTHERWISE SPECIFIED.
 3. DIMENSIONS SHALL BE FOLLOWED AS INDICATED.
 4. NOT TO BE SCALED.
 5. CLEAR COVER TO MAIN STEEL IN
 GRADE BEAMS/PUNTH BEAMS ----- 30mm
 COLUMNS ----- 40 mm
 6. THIS DRG. SHOULD BE READ ALONG WITH THE
 ARCHITECTURAL DRGS.
 7. LAP LENGTH FOR ALL BARS SHALL BE
 50 TIMES THE DIA OF THE BAR.
 8. SEC OF SOIL IS 90KN/M².
 9. CONCRETE GRADE M25.
 10. REINFORCEMENT GRADE Fe 500 – TMT.
 11. BLENDED CEMENT SHALE BE USED IN FOUNDATION
 FOOTINGS
 12. FOUNDRY
 13. 70 mm
 14. ARCHITECTURAL DRGS.

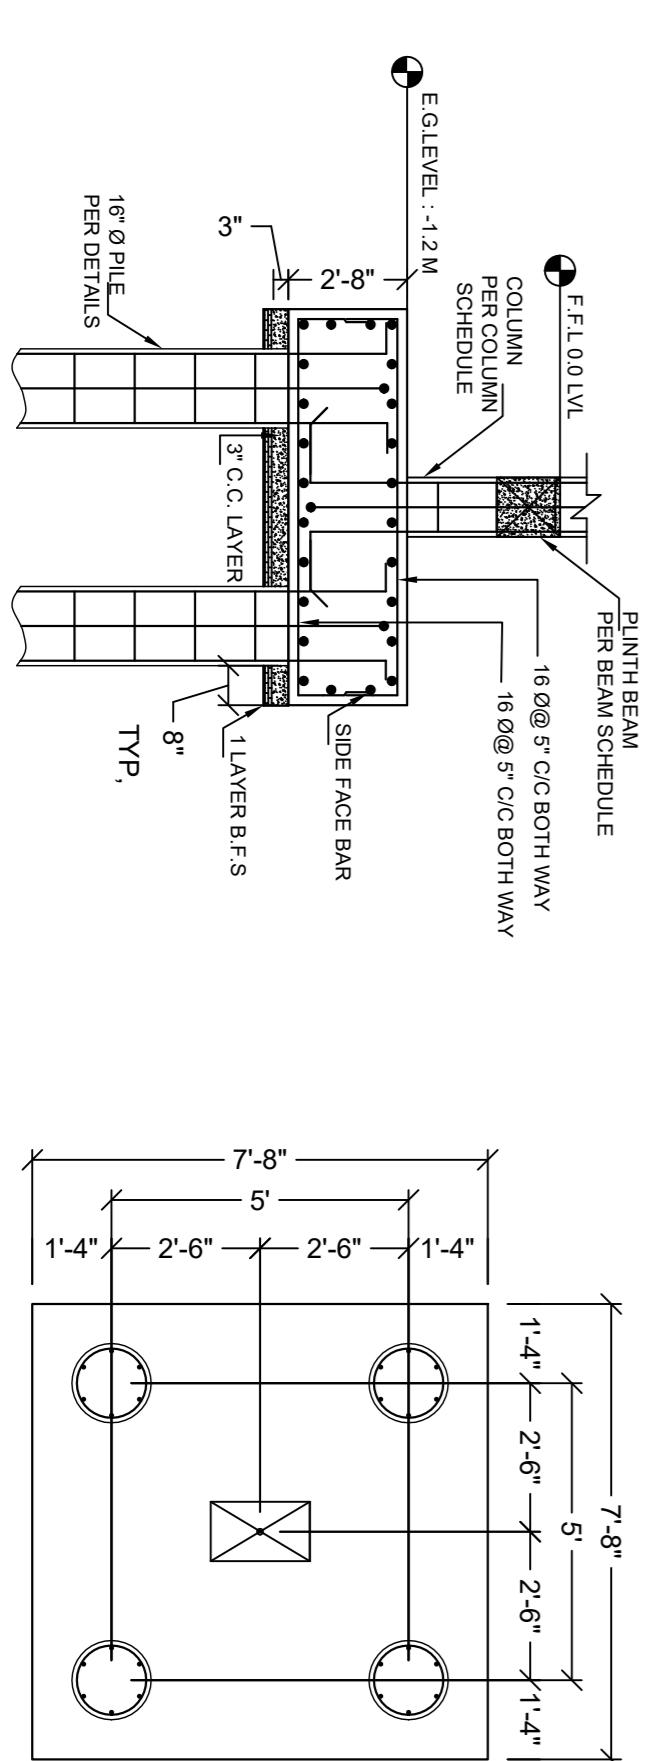

TYPICAL FOUNDATION
TYPE [F1]

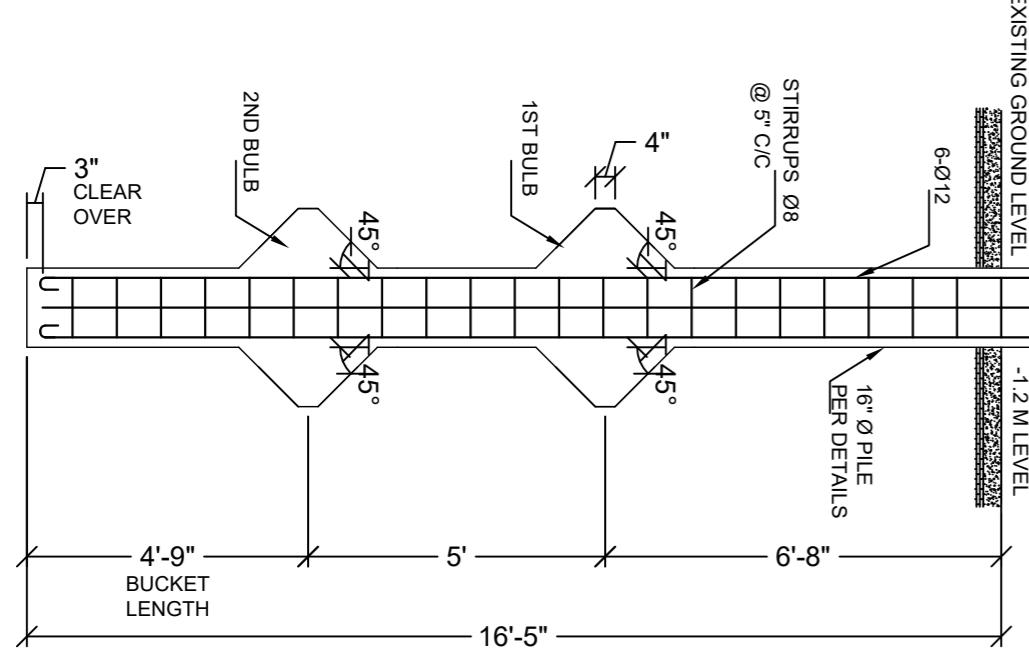

TYPICAL PILE DETAILS
DOUBLE UNDER REAMED PILE
EACH PILE COMPRESSIVE LOAD
CARRYING CAPACITY 420KN*

Plot No. 4231,4251,4289,4235,4222,4221
 Khilyan No. 895/279 in Mouza Mugapala,
 Tahsil Rasulpur & District Jalpur

AREA STATEMENT

FLOORS	BUILT UP AREA(Sq.Ft)
STAIR CASE AREA	165
PORTICO	380
STILT FLOOR	7525
1st FLOOR	7525
2nd FLOOR	7525
3rd FLOOR	7525
4th FLOOR	7525
TERRACE FLOOR	7525
TOTAL AREA	45695

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PROJECT:
 HI-TECH +2 SCIENCE COLLEGE

OWNER:
 SARASWATI CHARITABLE TRUST

DRAWING TITLE
 ARCHITECTURAL PLAN

DESIGNED BY
 E.I.T.K.D
 CHECKED BY
 Dr.R.R.P
 DRAWN BY
 E.Sanghamitra
 DATE
 21/04/2019

SCALE: N.T.S.