

$$\begin{aligned} ⑥ & 10.5 \times 9 = 94.5 \text{ sf} \\ ⑦ & 8.75 \times 10.5 = 91.87 \text{ sf} \\ ⑧ & 10 \times 6.5 = 65 \text{ sf} \\ ⑨ & 5.91 \times 9.66 = 57.09 \text{ sf} \\ ⑩ & 9 \times 9.66 = 86.94 \text{ sf} \\ ⑪ & 8.75 + 6.5 \times \frac{1}{2} = 7.62 \times 10 = 76.25 \text{ sf} \\ ⑫ & 8.75 + 14 \times \frac{1}{2} = 11.37 \times 14.83 = 168.69 \text{ sf} \\ ⑬ & 14.83 + 14 \times \frac{1}{2} = 14.41 \times 11 = 158.51 \text{ sf} \end{aligned}$$


TOTAL 1553.59 sf


$$\begin{aligned} ⑭ & 16 \times 8.08 = 129.28 \\ ⑮ & 6 \times 16 = 96 \times \frac{1}{2} = 48 \end{aligned}$$

TOTAL 177.28 sf

GRAND TOTAL  
177.28  
+ 1553.59  
1730.87 sf

$$\begin{aligned} ① & 9.5 \times 3 \times \frac{1}{2} = 14.25 \text{ sf} \\ ② & 2.66 + 10.5 \times \frac{1}{2} = 6.58 \times 47.5 = 312.5 \text{ sf} \\ ③ & 13.75 \times 8.33 = 114.53 \text{ sf} \\ ④ & 14.83 \times 10.5 = 155.71 \text{ sf} \\ ⑤ & 15 \times 10.5 = 157.50 \text{ sf} \end{aligned}$$

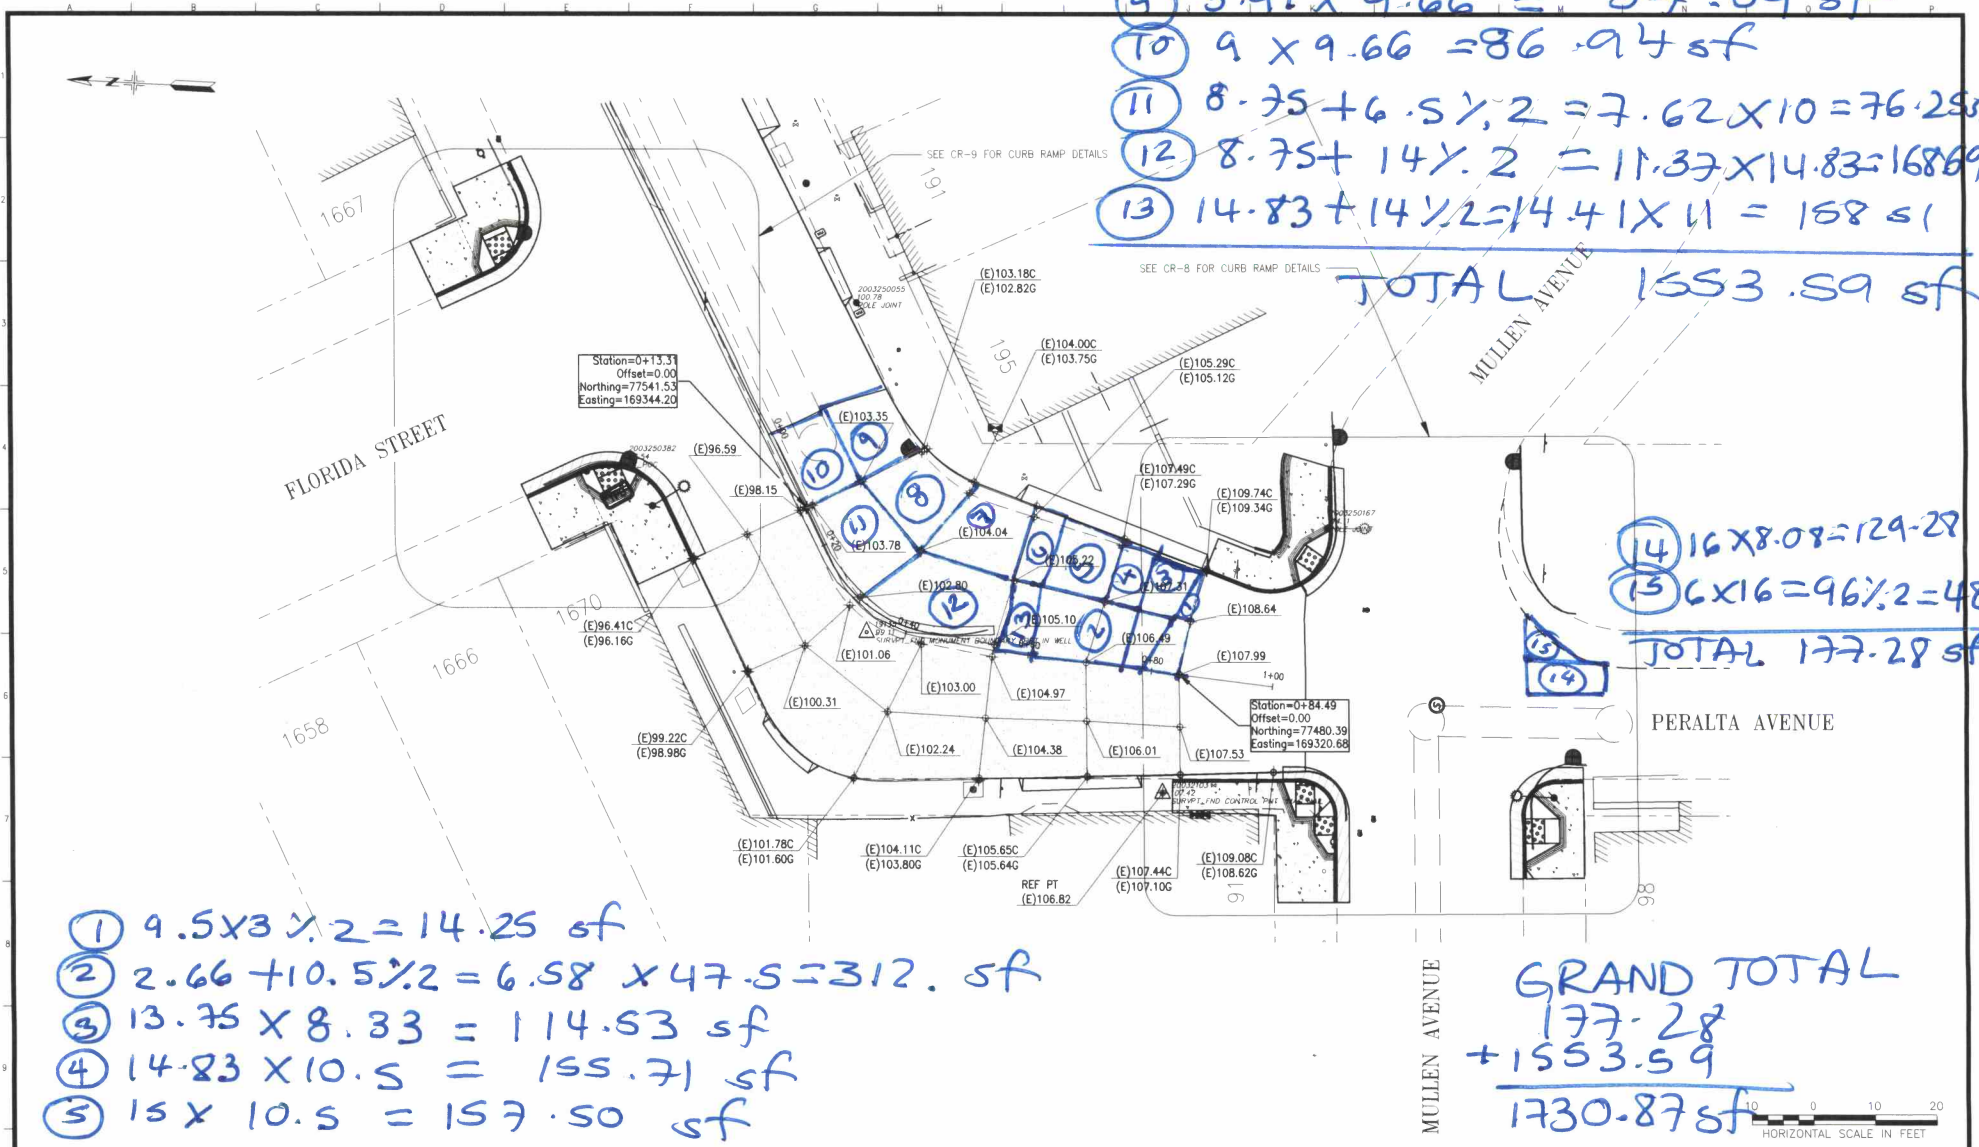

					REFERENCE INFORMATION & FILE NO. OF SURVEYS						BUREAU OF ENGINEERING CITY & COUNTY OF SAN FRANCISCO SAN FRANCISCO PUBLIC WORKS 30 VAN NESS AVENUE, 5TH FLOOR SAN FRANCISCO, CA 94102-0028		Acting Section Mgr: <i>[Signature]</i> Date: 03/08/2022		DESIGNED: DATE: O.BARRADAS 12/21				SCALE: 1" = 10' SHEET OF SHEETS 24 OF 70		VARIOUS LOCATIONS PAVEMENT RENOVATION NO. 38 AND SEWER REPLACEMENT  PERALTA AVENUE FLORIDA STREET TO MULLEN AVENUE ALIGNMENT AND GRADING PLAN		CONTRACT NO. 2928J DRAWING NO. R-18 FILE NO. 118,936 REV. NO.	
NO. DATE DESCRIPTION BY APP					BSM SURVEY NO. 20-032								Acting Bureau Mgr: <i>[Signature]</i> Date: 03/09/2022		DRAWN: DATE: O.BARRADAS 12/21									
TABLE OF REVISIONS																								
THIS DRAWING WAS LAST MODIFIED: 02/04/22 16:19 BY: obarradas																								