MECHANICAL SPECIFICATION

QUALITY ASSURANCE

ALL EQUIPMENT USED ON THIS PROJECT MUST CARRY THE STANDARDS "MARK" FROM THE QUALITY ASSURANCE SERVICES OF AUSTRALIA - SAA. IMPORTED EQUIPMENT MUST CARRY A EQUAL "MARK" RECOGNISED BY STANDARDS AUSTRALIA.

DEFINITION OF "APPROVAL"

THE WORDS "OR OTHER APPROVED" OR "TO BE APPROVED" ARE IMPLIED ALWAYS WHETHER FOLLOWING THE DESCRIPTION OF APPARATUS, MATERIAL MAKER, OR NOT.

THE CONTRACTOR MAY, IF HE SO DESIRES, TENDER ON ALTERNATIVE MAKES, PROVIDED THAT SUCH ALTERNATIVES ARE PROVEN TO BE OF EQUAL QUALITY TO THOSE SPECIFIED AND THAT THEY ARE SUBMITTED FOR THE APPROVAL OF THE CONSULTING ENGINEER BEFORE ORDERING. NO PRICE INCREASE WILL BE CONSIDERED FOR ALTERNATE EQUIPMENT. THE ENGINEER SHALL BE THE SOLE JUDGE AS TO THE RELATIVE MERITS OF THE ALTERNATIVES OFFERED. HIS DECISION

IT SHOULD BE NOTED THAT EQUIPMENT CAPACITIES SIZES AND WORKING PRESSURES, AMPS, PHASES ARE CALCULATED AND INTERWOVEN AROUND THE COMPLEMENTARY EQUIPMENT HEREIN SPECIFIED AND TO FIT INTO ARCHITECTURAL ENVELOPE.

ANY DEVIATION FROM ANY EQUIPMENT SPECIFIED MAY CHANGE CAPACITIES OF COMPLEMENTARY EQUIPMENT AND/OR REDUCE OR NEGATE ITS ABILITY TO ACCOMMODATE THE SIZE WITHIN SPACE ALLOWED. THE CONTRACTOR WILL BE RESPONSIBLE FOR ANY RESULTING COMPLIMENTARY EQUIPMENT REQUIRED CHANGE OF BOTH PERFORMANCE AND PRICE

THE CONTRACTOR IS ADVISED TO CONSIDER CAREFULLY THE IMPLICATIONS ASSOCIATED WITH TENDERING ON ANY EQUIPMENT NOT NAMED OUTRIGHT WITHIN THIS SPECIFICATION.

SCOPE OF WORKS

THE WORK MUST INCLUDE THE DESIGN. DOCUMENTATION. SUPPLY. INSTALLATION. TESTING. COMMISSIONING, WARRANTY, MAINTENANCE, ETC. OF THE MECHANICAL SERVICES AS INDICATED IN THE SPECIFICATION AND ON MECHANICAL SERVICES DRAWINGS. THE WORKS MUST INCLUDE BUT NOT BE LIMITED TO THE FOLLOWING:

- WALL MOUNTED TYPE AIR COOLED REVERSE CYCLE SPLIT AIR CONDITIONING SYSTEMS TO RESPECTIVE APARTMENT AREAS COMPLETE WITH PIPEWORK, POWER & CONTROL WIRING,
- FULLY DUCTED TYPE AIR COOLED REVERSE CYCLE SPLIT AIR CONDITIONING SYSTEMS TO PENTHOUSE APARTMENT AREA COMPLETE WITH PIPEWORK, POWER & CONTROL WIRING,
- NATURAL VENTILATION TO CARPARK AREA DOMESTIC RANGE HOOD DUCTED (BOOSTER AS REQUIRED FAN) DIRECT TO OUTSIDE **ATMOSPHERE**
- TOILET/LAUNDRY VENTILATION TO ALL WET AREAS.
- MAIN SWITCH ROOM VENTILATION.
- REFUSE ROOM VENTILATION SYSTEM.
- GAS FIRE PLACE FLUEING (POWER FLUE) AND INTAKE WARRANTIES & DEFECT LIABILITY.
- ALL REQUIRED CRAINAGE, LIFTING AND OR SAFETY DEVICES.
- PROJECT INSTALLATION ACOUSTIC COMPLIANCE MUST MEET AT MINIMUM AIRAH RECOMMENDED VALUES
- REQUIREMENTS OF THE ACOUSTIC REPORT

THE MECHANICAL CONTRACTOR MUST SUPPLY AND INSTALL TOTAL WORKS OBVIOUSLY REQUIRED TO COMPLETE THE PROJECT, ALL ITEMS, ACTIVITIES, MATERIALS AND LABOR WHETHER OR NOT THESE ARE CLEARLY IDENTIFIED IN SPECIFICATION OR DRAWINGS. THE WORK MUST INCLUDE: DESIGN, DOCUMENTATION, TESTING, COMMISSIONING, WARRANTY, MAINTENANCE, ETC. OF THE MECHANICAL SERVICES. THE FOLLOWING NOTES ARE TO BE READ IN CONNECTION WITH THE CONTROL DESCRIPTIONS WITHIN THE DOCUMENTS. THE WORKS MUST INCLUDE BUT NOT BE LIMITED TO THE FOLLOWING:

RETAIL TENANCY AIR CONDITIONING SYSTEMS:

AIR CONDITIONING SYSTEMS TO BE INSTALLED BY TENANT.

TENANCY VENTILATION:

TENANCY VENTILATION IS TO BE PROVIDED BY FUTURE TENANT TO SUIT PROPOSED TENANCY, PROVISION FOR MAKE UP/ OUTDOOR AIR HAS BEEN PROVIDED AS PART OF BASE BUILDING WORKS.

APARTMENTS AIR CONDITIONING SYSTEMS:

WALL SPLIT INVERTER TYPE AIR COOLED REVERSE CYCLE AIR CONDITIONING SYSTEMS TO RESPECTIVE APARTMENTS, ETC., EACH SYSTEM MUST BE COMPLETE WITH ALL CONTROL WIRING, POWER WIRING, PIPEWORK, VALVES, OIL TRAPS, FILTER/DRIERS, CONTROLS, ETC., IN ENTIRETY, ALL TO MANUFACTURERS RECOMMENDATIONS. ALL EQUIPMENT, PIPEWORK INSULATION, ETC., EXPOSED TO ATMOSPHERE MUST BE WEATHER AND VERMIN PROOFED. UNITS TO BE INSTALLED AND ARRANGED FOR EASY SERVICE, REPAIR, MAINTENANCE, ETC., OF EQUIPMENT, COMPONENTS INSTALLED. RETURN AIR SECTION OF EACH UNIT MUST HAVE MANUFACTURER SUPPLIED DRY MEDIA TYPE FILTER BANK. FILTERS TO BE CLIP-IN TYPE MOUNTED IN HOLDING FRAME/SLIDE RAILS ARRANGED SO THAT NO AIR BY PASSES FILTER MEDIA. EACH AIR CONDITIONING SYSTEM TO BE CONTROLLED VIA 7 DAY FULLY PROGRAMMABLE CONTROLLER WITH TIME CLOCK, TEMPERATURE SETTING, THERMOSTAT, "ON-OFF SWITCH, FAN 3 SPEED SET, DIGITAL DISPLAY, FAULT INDICATOR, ENERGY SAVING, ETC.

APARTMENTS AIR CONDITIONING SYSTEMS:

FULLY DUCTED TYPE SPLIT INVERTER AIR COOLED REVERSE CYCLE AIR CONDITIONING SYSTEMS TO RESPECTIVE APARTMENTS. ALL UNITS TO BE FULLY CONCEALED WITHIN BULKHEADS PROVIDED BY OTHERS ETC... EACH SYSTEM MUST BE COMPLETE WITH ALL INSULATED DUCTWORK, SPIGOTS, DAMPERS, PLENUM BOXES AND GRILLES (SUPPLY & RETURN), CONTROL WIRING, POWER WIRING, PIPEWORK, VALVES OIL TRAPS, FILTER/ DRIERS, CONTROLS, ETC.. IN ENTIRETY.

ALL EQUIPMENT MUST BE INSTALLED TO MANUFACTURERS RECOMMENDATIONS. ALL EQUIPMENT, PIPEWORK INSULATION, EXPOSED TO ATMOSPHERE MUST BE WEATHER AND VERMIN PROOFED. UNITS TO BE INSTALLED AND ARRANGED FOR EASY SERVICE, REPAIR, MAINTENANCE, ETC., OF EQUIPMENT/ COMPONENTS INSTALLED. RETURN AIR SECTION OF EACH DUCTED UNIT MUST HAVE DRY MEDIA TYPE FILTER BANK. FILTERS TO BE CLIP-IN TYPE MOUNTED IN HOLDING FRAME/SLIDE RAILS IN FELT LINED ARRANGED SO AS NO AIR BY PASSES FILTER MEDIA.

EACH AIR CONDITIONING SYSTEM TO BE CONTROLLED VIA 7 DAY FULLY PROGRAMMABLE CONTROLLER WITH TIME CLOCK, TEMPERATURE SETTING, THERMOSTAT, "ON-OFF SWITCH, FAN 3 SPEED SET, DIGITAL DISPLAY, FAULT INDICATOR, ENERGY SAVING, ETC. FINAL LOCATION TO BE DETERMINED ONSITE.

APARTMENT VENTILATION:

APARTMENTS ARE NATURALLY VENTILATED IN ACCORDANCE WITH NCC PART F4 VIA OPENABLE WINDOWS/ DOORS. REFER TO ARCHITECTURAL DRAWINGS.

THE KITCHEN RANGE HOODS ARE DUCTED TYPE. HOODS ARE SUPPLIED AND INSTALLED BY BUILDER. MECHANICAL CONTRACTOR MUST CONNECT TO HOOD & SOLID DUCT TO DISCHARGE DIRECT TO OUTSIDE ATMOSPHERE. SYSTEM TO BE PROVIDED WITH NON RETURN AIR DAMPER. MECHANICAL CONTRACTOR MUST MAKE THEIR OWN ASSESSMENT OF EACH RESPECTIVE SYSTEM TO ENSURE ITS DUTY IS SUFFICIENT FOR THE PRESSURE DROP AND PROVIDE THE AIR QUANTITY REQUIRED. PROVIDE BOOSTER FANS

RESIDENTIAL BATH ROOMS:

WHERE REQUIRED.

TOILET EXHAUST AIR FANS TO BE WIRED TO SEPARATE SWITCH INCORPORATED INTO LIGHTING GANG PLATE WHERE REQUIRED, DOUBLE POLE SWITCH TO BE PROVIDED BY ELECTRICAL CONTRACTOR. FAN TO RUN WHEN SWITCH IS ENERGISED AT EITHER LAUNDRY OR BATHROOM SWITCH, FAN ONLY TO TURN OFF WHEN BOTH SWITCHES ARE OFF. PROVIDE A ADJUSTABLE 6MIN RUN ON TIMER. AIR IS DRAWN IN THROUGH UNDER CUT DOORS ACROSS ROOM AND INTO FAN THEN DUCTED TO DISCHARGE DIRECT TO OUTSIDE ATMOSPHERE. SYSTEM TO BE PROVIDED WITH NON RETURN AIR DAMPER.

CARPARK VENTILATION:

GROUND FLOOR CAR PARK IS A PERFORMANCE BASED NATURAL VENTILATION SYSTEM IN ACCORDANCE WITH AS1668.2 CLAUSE 4.4.

GAS METER CUPBOARD VENTILATION:

GAS METER CUPBOARD TO BE NATURALLY VENTILATED IN ACCORDANCE WITH AUTHORITY REQUIREMENTS AND ASS601 TO ARCHITECTS DETAIL.

REFUSE ROOM VENTILATION:

REFUSE ROOM EXHAUST VENTILATION VIA DUCT MOUNTED FAN SUPPORTED FROM SLAB OVER ON ANTI-VIBRATION ISOLATORS. FAN IS LOCATED IN BASEMENT LEVEL. FAN IS TO BE WIRED TO RUN 24HRS (/W KEYED ON/OFF SWITCH LOCATED APPROX. 1800mm A.F.F.L WITHIN BIN ROOM. PROVIDE RUN STATUS NEON ON SWITCH BOARD. FAN TO BE WIRED FROM MSSB.

MAIN SWITCH ROOM VENTILATION:

SWITCH ROOM IS VENTILATED VIA HIGH LEVEL WALL MOUNTED FAN (EXHAUST ONLY) WITH BELL MOUTH INTAKE AND WIRE GUARD. AIR IS DRAWN IN FROM LOW LEVEL DOOR MOUNTED GRILLE WITH FIRE DAMPER BEHIND. LOCATION OF INTAKE AND DISCHARGE GRILLE IS TO PROMOTE CROSS FLOW VENTILATION. FAN DISCHARGING TO BASEMENT MEZZ STORAGE CAGE. FAN TO BE THERMOSTATICALLY CONTROLLED WITH WALL T'STAT APPROX. 1500mm A.F.F.L. ON OPPOSITE WALL OR AS SHOWN.

CORRIDOR SUPPLY AIR:

CORRIDOR SUPPLY AIR FANS TO BE DUCT MOUNTED FAN LOCATED AT ROOF LEVEL MOUNTED ON GALVANIZED FRAME WITH APPROPRIATE ACOUSTIC ATTENUATION SO NO NOISE IS TRANSFERRED THROUGH STRUCTURE. FAN TO BE PROVIDED WITH G4 RATED FILTER ON INLET SIDE OF FAN AND DUCTED DIRECT TO CORRIDOR SUPPLY AIR FIRE RATED SHAFT EXTEND DOWN BUILDING CORE. EACH LEVEL IS TO BE PROVIDED WITH A APPROPRIATE HALF CHEVRON GRILLE. VOLUME CONTROL DAMPER AND FIRE DAMPER TO DELIVER THE SPECIFIED SUPPLY AIR WITHIN THE COMMON CORRIDOR SPACE. FAN IS TO RUN 24hrs FROM PUBLIC BOARD (/W LOCAL ISOLATING SWITCH AND RUN STATUS NEON WITHIN MSB ROOM. FAN TO BE WIRED FROM PB.

TENDER OPTION- GAS FIRE PLACE POWER FLUE VENTILATION:

PROVIDE TENDER OPTION PRICE (PER APARTMENT) TO MECHANICALLY VENTILATE GAS FIRE PLACES. PROVIDE ALL DUCTING AND FAN COMPATIBLE WITH SPECIFIED GAS FIRE PLACE (CONFIRM FINAL MODEL WITH BUILDER PRIOR TO SUBMITTING TENDER). FAN TO BE IN COMPLIANCE WITH AS 5601, AND MANUFACTURERS RECOMMENDATION. DISCHARGE TO BE IN ACCORDANCE WITH AS5601 AND AUTHORITY/ ENERGY SAFE REQUIREMENTS. PROVIDE WIRING FROM GAS FIRE PLACE TERMINALS TO FAN. FAN OPERATION TO BE INTERLINKED WIT FIRE PLACE. IF FAN IS NOT ACTIVE FIREPLACE MUST NOT TURN ON. ACOUSTIC CONTROL

ALL MECHANICAL SYSTEMS MUST BE FULLY ANALYSED TO VERIFY THAT THE ACOUSTIC PERFORMANCE SATISFACTORILY MEETS THE A.I.R.A.H. RECOMMENDED VALUES AND THE FOLLOWING

APARTMENT LIVING RM. - 35 dBA BED ROOMS - 25 dBA TOILET AREAS - 40 dBA RETAIL AREAS - 45 dBA

EXTERNAL ROOF PLANT - 65 dBA SUPPLY AND INSTALL ATTENUATORS AND ACOUSTIC INSULATION TREATMENT AS REQUIRED TO ACHIEVE SPECIFIED NOISE RATINGS.

WHERE ATTENUATORS / SILENCERS ARE EXPOSED TO ATMOSPHERE OR GREASE. THEY MUST BE LINED WITH IMPERVIOUS FILM TO PREVENT THE INGRESS OF MOISTURE AND OR GREASE

REGULATIONS & STANDARDS

ALL MATERIALS, EQUIPMENT AND WORKMANSHIP MUST COMPLY WITH THE REQUIREMENTS OF LATEST EDITIONS OF ALL APPLICABLE REGULATIONS AND STANDARDS INCLUDING AS/NZS 1668.1, AS 1668.2, AS 1668.3, AS4254, AS 3666, AS 3500, AS 3000, AS 1851, NATSPEC, PLUMBING INDUSTRY COMMISSION GUIDELINES, BUILDING CODE OF AUSTRALIA (BCA/NCC) LATEST EDITION, GOVERNING AUTHORITIES, ETC. AND THIS SPECIFICATION.

HEATING & AIRCONDITIONING PERFORMANCE CONDITIONS:

CAPACITIES FOR EACH AIR CONDITIONING SYSTEM MUST BE SELECTED FOR THE PEAK COOLING/HEATING LOAD. EACH SYSTEM MUST MEET THE PEAK ZONE COOLING/HEATING LOADS AS REQUIRED. THE SYSTEM IS TO MAINTAIN DESIGN CONDITIONS THROUGHOUT THE ENTIRE AIR CONDITIONED COMPARTMENT SPACES.

OUTDOOR DESIGN CONDITIONS: INDOOR DESIGN CONDITIONS: SUMMER 35°C db 21°C wb SUMMER 24°C db 50%C RH WINTER 3.5°C db WINTER 21°C db

CAPACITIES FOR SPECIFIED AIR CONDITIONING SYSTEMS ARE BASED ON THE FOLLOWING MINIMUM THERMAL PERFORMANCE VALUES: THE CONTRACTOR MUST OBTAIN WRITTEN CONFIRMATION FROM THE BUILDER THAT THE MINIMUM THERMAL PERFORMANCE VALUES LISTED BELOW HAVE BEEN PROVIDED.

GLASS: THERMAL CONDUCT. U SHADE CO-EFFICIENT Sc

APART'S

VENTILATION PERFORMANCE

OUTDOOR AIR : OUTDOOR AIR IS VIA NATURAL VENTILATION TO ALL APARTMENT AND COMMON AREAS BY OPENABLE WINDOWS AND DOORS EQUAL TO 5% OF THE FLOOR AREA PROVIDED BY THE ARCHITECT/BUILDER UNO.

WHERE NOTED OTHERWISE, PROVIDE MECHANICAL VENTILATION IN ACCORDANCE WITH AS1668.2 VIA THE A/C SYSTEM

WET AREA EXHAUST AIR SYSTEMS PROVIDE EXHAUST RATES AS SCHEDULED AND AS PER THE VENTILATION REQUIREMENTS TABLE REFER TO AS1668.2

PROVIDE VENTILATION RATES AS NOTES AND IN COMPLIANCE WITH AS 1668.2

GRILLES AND LOUVRES

MISCELLANEOUS EXHAUST SYSTEMS

EXTERNAL LOUVRES, COWLS, ETC., MUST BE WEATHER AND VERMIN PROOFED & POWDER COLOUR COATED TO SUIT ARCHITECTS REQUIREMENTS. ALL AIR OUTLETS. COLLARS, ETC., EXPOSED TO VIEW WITHIN BUILDING TO BE COLOURED/POWDER COATED TO SUIT ARCHITECTS REQUIREMENTS.

ALL CAR PARK LOUVRES & VENTED DOORS TO BE SUPPLIED AND INSTALLED BY THE BUILDER WITH MINIMUM FREE AREA OPENINGS AS NOTED. ALL DOOR RELIEF GRILLES ARE TO BE ACOUSTIC CHEVRON TYPE AS SCHEDULED SUPPLIED BY THE MECHANICAL CONTRACTOR FOR INSTALLATION BY THE BUILDER. ALL GRILLES HAVE BEEN SIZED AND SELECTED BASED ON THE SPECIFIED MANUFACTURER. WHERE ALTERNATIVE MANUFACTURER IS OFFERED THE CONTRACTOR REMAINS RESPONSIBLE TO ENSURE GRILLE / DIFFUSER PERFORMANCES ARE EQUAL TO THE SPECIFIED WITH RESPECT TO THROW, EFFECTIVE DIFFUSION, PRESSURE DROP AND

ALL GRILLES AND LOUVRES ARE TO BE PROVIDED WITH SHEET METAL PLENUMS, CUSHION HEADS AND NECK ADAPTORS AS REQUIRED. WHERE USED FOR HEATING AND OR COOLING CUSHION HEADS AND PLENUMS MUST BE

DAMPERS

VOLUME CONTROL DAMPERS (V.C.D/ O.B.D):

INSULATED IN COMPLIANCE WITH B.C.A. SECTION J.

PROVIDE AND INSTALL MANUAL BALANCING DAMPERS WHERE NOTED AND AS REQUIRED TO PROVIDE A FULL AND ACCURATE BALANCING OF ALL AIR SYSTEM, ETC

FIRE AND SMOKE DAMPERS:

THE CONTRACTOR MUST PROVIDE FIRE DAMPERS AND FIRE SEAL ALL AROUND PENETRATION TO MANUFACTURERS REQUIREMENTS SO AS TO MAINTAIN THE FIRE RATING (FR - STRUCTURAL ADEQUACY /INTEGRITY/ INSULATION) AS REQUIRED TO MATCH THE INTEGRITY OF THE FIRE RATED / SMOKE RATED COMPARTMENT BOUNDARY MATERIAL WHERE INSTALLED.

FIRE DAMPERS MUST HAVE SAME CROSS SECTIONAL FREE AREA OPENING AS THE DUCT WHERE INSTALLED SO AS NOT TO IMPEDE NOR DISRUPT ANY AIR FLOWS. THE CONTRACTOR MUST PROVIDE ROBUST MOTORS AND FAIL SAFE WIRING FOR ALL SMOKE DAMPERS AND FINAL SITE TESTING AS REQUIRED TO BE FULLY OPERATIONAL IN FIRE MODE TO THE SATISFACTION OF THE ENGINEER.

NON RETURN DAMPERS:

ALL WET AREA EXHAUST FANS TO BE PROVIDED WITH NON RETURN DAMPERS ACCESSIBLE FROM AN ACCESS PANEL PROVE FLAP DAMPER ON TOP OF RANGE HOODS PRIOR TO DUCT CONNECTION. BUILDER TO PROVIDE REMOVABLE PANEL IN CUPBOARD OVER RANGE HOOD FOR FLAP DAMPER MAINTENANCE ACCESS

DUCTWORK

DUCTWORK AND FITTINGS TO BE SUPPLIED AND INSTALLED IN ACCORDANCE WITH LATEST EDITION OF S.M.A.C.N.A., NZ/AS4254, AS1668, NCC SECTION J AND GOVERNING AUTHORITIES, ETC. ALL TO PROVIDE A GOOD TRADES PERSON WORKMANSHIP TYPE INSTALLATION.

ALL DUCTWORK MUST BE GALVANISED SHEET IRON UNLESS OTHERWISE NOTED: - FIRST DIMENSION IS CLEAR INTERNAL WIDTH SIZE. SECOND DIMENSION IS CLEAR INTERNAL DEPTH SIZE.

SOLID GALVANISED IRON DUCTWORK MUST BE FLANGE CONNECTED COMPLETE WITH GASKET & SEALANT, ALL AIR TIGHT, GALVANISED IRON DUCTWORK TO BE SUPPORTED ON ALL THREADED RODS WITH NUTS AND WASHERS AND ANGLE IRON SUPPORTS AT RECOMMENDED CENTRES. ALL AS SCHEDULED IN S.M.A.N.C.A. STANDARDS, ETC., TO SUIT LOADS, ETC.

FLEXIBLE DUCTWORK MUST BE CONNECTED WITH JUBILEE CLIPS / RIVETED THEN DUCT TAPED. ALL TO BE MADE AIR TIGHT. FLEXIBLE DUCTWORK TO BE SUPPORTED ON ALL THREADED RODS WITH NUTS AND WASHERS AND PEAR HANGERS, TWO PIECE CLAMP, ETC., AT RECOMMENDED CENTRES SO AS DUCTWORK IS INSTALLED IN A STRAIGHT LINE WITH NO SAGS OR DIPS. ALL AS SCHEDULED IN S.M.A.N.C.A. STANDARDS, ETC., TO SUIT LOADS, ETC

DUCTWORK MUST INCLUDE ALL TRANSITIONS, TEES, BENDS, TURNING VANES. SPLITTERS, VOLUME CONTROL DAMPERS, FIRE DAMPERS, SUPPORTS, OFFSETS, FLEXIBLE CONNECTIONS ANTI-VIBRATION ISOLATORS FITTINGS, ETC., REQUIRED TO PROVIDE A COMPLETE OPERATIONAL AND FULLY BALANCED AIR DUCTED SYSTEM.

ALL DUCTWORK EXPOSED TO WEATHER MUST HAVE TOP SECTION CROSS BROKEN

FOR WATER RUN-OFF. ALL SEAMS AND JOINTS TO BE SEALED WITH SILICONE

COMMERCIAL KITCHEN TYPE DUCTWORK TO BE 1.2mm THICK GALVANISED IRON OR 0.9mm THICK STAINLESS STEEL COMPLETE WITH AIR TIGHT ACCESS PANELS EVERY 3m AND EVERY CHANGE OF DIRECTION. ALL TO COMPLY WITH LATEST EDITION OF S.M.A.C.N.A., NZ/AS4254, AS1668.1 & AS1668.2, NATSPEC, B.C.A. AND GOVERNING AUTHORITIES. DUCTWORK TO BE FIRE RATED WHERE PASSING THROUGH ANOTHER FIRE COMPARTMENT OR FIRE RATED WALL, KITCHEN DUCT TO

BE ENCASED IN FIRE RATED ENCLOSURE. SHAFT, BULKHEAD OR SPRAYED WITH

FIRE RESISTANCE MATERIAL HAVING THE SAME FIRE RATING AS MATERIAL WHERE

DUCTWORK INSULATION

INSTALLED, TO MAINTAIN FIRE RATING INTEGRITY.

ALL TO COMPLY WITH N.C.C SPECIFICATION: J5.2b (LATEST EDITION)

(a) THIS SPECIFICATION CONTAINS THE REQUIREMENTS FOR THE SEALING AND INSULATING OF SUPPLY AND RETURN DUCTWORK AND FITTINGS USED IN AN AIR-CONDITIONING SYSTEM.

(b) FOR THE PURPOSES OF THIS SPECIFICATION, FITTINGS-(i) INCLUDE PASSIVE COMPONENTS OF A DUCTWORK SYSTEM: AND (ii) EXCLUDE ACTIVE COMPONENTS SUCH AS AIR-HANDLING UNIT COMPONENTS.

SEALING OF DUCTWORK

(a) DUCTWORK IN AN AIR-CONDITIONING SYSTEM MUST BE SEALED AGAINST AIR LOSS IN ACCORDANCE WITH THE DUCT SEALING REQUIREMENTS OF AS 4254 PARTS 1 AND 2 FOR THE STATIC PRESSURE IN THE SYSTEM.

- (b) THE REQUIREMENTS OF (A) DO NOT-(i) APPLY TO DUCTWORK LOCATED WITHIN THE ONLY OR LAST ROOM SERVED BY THE SYSTEM; AND
- (ii) INCLUDE THE AIR LEAKAGE TESTING REQUIREMENTS OF CLAUSE 2.2.4 OF AS 4254.2.

INSULATION OF DUCTWORK AND FITTINGS: (a) DUCTWORK AND FITTINGS IN AN AIR-CONDITIONING SYSTEM MUST BE

PROVIDED WITH INSULATION-(i) COMPLYING WITH AS/NZS 4859.1; AND

(ii) HAVING A MATERIAL R-VALUE NOT LESS THAN-(A) THAT SPECIFIED IN TABLE 3: OR (B) 1.0, FOR FLEXIBLE DUCTWORK WITH A LENGTH TO AN OUTLET OR FROM AN INLET OF NOT MORE THAN 3 M.

(b) INSULATION MUST-(i) BE PROTECTED AGAINST THE EFFECTS OF WEATHER AND

SUNLIGHT; AND (ii) BE INSTALLED SO THAT IT-(A) ABUTS ADJOINING INSULATION TO FORM A CONTINUOUS

BARRIER: AND (B) MAINTAINS ITS POSITION AND THICKNESS, OTHER THAN AT FLANGES AND SUPPORTS; AND

(iii) WHEN CONVEYING COOLED AIR-

(A) BE PROTECTED BY A VAPOUR BARRIER ON THE OUTSIDE OF THE INSULATION; AND (B) WHERE THE VAPOUR BARRIER IS A MEMBRANE, BE INSTALLED SO THAT ADJOINING SHEETS OF THE MEMBRANE-(aa) OVERLAP BY 50 MM; AND

(bb) ARE BONDED OR TAPED TOGETHER.

(c) THE REQUIREMENTS OF (A) DO NOT APPLY TO-(i) DUCTWORK AND FITTINGS LOCATED WITHIN THE ONLY OR LAST ROOM SERVED BY THE SYSTEM; OR

(ii) FITTINGS THAT FORM PART OF THE INTERFACE WITH THE CONDITIONED SPACE; OR (iii) RETURN AIR DUCTWORK IN, OR PASSING THROUGH, A

(iv) DUCTWORK FOR OUTSIDE AIR AND EXHAUST AIR ASSOCIATED WITH AN AIR-CONDITIONING SYSTEM; OR (v) THE FLOOR OF AN IN-SITU AIR-HANDLING UNIT: OR

(vi) PACKAGED AIR-CONDITIONING EQUIPMENT COMPLYING WITH MEPS;

(vii) FLEXIBLE FAN CONNECTIONS.

CONDITIONED SPACE: OR

TABLE 3 DUCTWORK & FITTINGS-MINIMUM MATERIAL R-VALUE

LOCATIONS	MIN. TOTAL R-VALUE: FOR DUFITTINGS IN EACH CLIMATE Z								
of DUCTWORK & FITTINGS	1, 2, 3, 4, 5, 6 and 7	8							
Within a conditioned space.	1.2	1.6							
Where exposed to direct sunlight	3 0	3.4							
All other locations	2.0	2.4							

ANTI-VIBRATION ISOLATORS

SUPPLY AND INSTALL ANTI-VIBRATION ISOLATION FOR ALL MECHANICAL EQUIPMENT TO ELIMINATE NOISE AND VIBRATION TRANSITION THROUGH BUILDING STRUCTURE, ETC. ALL TO EQUIPMENT MANUFACTURERS RECOMMENDATIONS UNO. VENTILATION FANS MUST SUPPORTED BY HARMONICALLY BALANCED EMBLETON SPRING MOUNTS WHERE NOTED AS REQUIRING SPRING MOUNTS. PROVIDE ACOUSTIC FLEXIBLE DUCT CONNECTORS ON BOTH THE DISCHARGE AND INTAKE SIDES OF ALL FANS AND EQUIPMENT INCORPORATING A FAN. ALL FLEXIBLE CONNECTIONS EXPOSED TO WEATHER MUST BE PROTECTED BY AN

APPROVED SHEET METAL WEATHER GUARD.

MANUFACTURER'S REQUIREMENTS ALL EQUIPMENT AND SYSTEMS SHALL BE INSTALLED IN ACCORDANCE WITH THE SPECIFIC RECOMMENDATIONS OF THE MANUFACTURER, INCLUDING THE PROVISION OF ANCILLARY OR SAFETY DEVICES DEEMED NECESSARY.

FIRE RATED WALL BRACKET:

WHERE WALL MOUNTED FAN COIL UNIT IS PROVIDED ON FIRE RATED PARTY WALL CONTRACTOR TO PROVIDE FIRE RATED WALL MOUNTED BRACKET SUPPORT EQUAL TO "SPLIT FIRE PRO" INSTALLATION TO BE IN ACCORDANCE WITH MANUFACTURERS RECOMMENDATIONS.

FIRE SEALING OF PENETRATIONS:

PENETRATIONS THROUGH ALL WALL, FLOOR AND SHAFTS TO BE IN ACCORDANCE WITH BCA PART (3 - PROTECTION OF PENETRATIONS THROUGH ELEMENTS REQUIRED TO ACHIEVED FRL CONSTRUCTION. CONTRACTOR MUST PROVIDE ALL REQUIRED DAMPERS, WRAPPING, CLADDING, FIRE PILLOWS, FIRE RATED MASTIC ETC... AS REQUIRED TO THE SATISFACTION OF THE RELEVANT BUILDING SURVEYOR.

PIPEWORK AND FITTINGS

OPERATION

PIPE WORK SYSTEMS MUST BE SUPPLIED AND INSTALLED COMPLETE WITH ALL VALVES, FITTINGS, CONTROLS, ETC., IN ACCORDANCE WITH LATEST EDITIONS OF NCC, AS1074, AS1432, AS1477, AS1530, AS1571, AS1572, AS1585, AS/NZ 1677.1, AS1722, AS2032, AS2129, AS4041, ETC., THIS SPECIFICATION AND ALL OTHER APPLICATION CODES AND STANDARDS EACH PIPE WORK SYSTEMS MUST BE COMPLETE WITH ALL VALVES, FITTINGS, VENTS, DRAINS, SYSTEM EXPANSION COMPONENTS, ANCHORS, SUPPORTS, BRAIDED FLEXIBLE PIPE CONNECTIONS, INSULATION, VAPOUR BARRIERS, SHEATHING, AS REQUIRED FOR A COMPLETE OPERATIONAL

ALL PIPING MUST BE INSTALLED AND ARRANGED TO SUIT THE STRUCTURAL CONSTRAINTS, LIMITED SPACES, ARCHITECTURAL REQUIREMENTS, ETC. ALL ARRANGED TO AVOID INTERFERENCE, CLASHES, ETC., WITH OTHER TRADES.

BALANCED SYSTEM, ALL ARRANGED FOR THE SAFE AND EFFICIENT MODE OF

ALL PIPE LINES MUST BE SIZED IN ACCORDANCE WITH THE EQUIPMENT MANUFACTURERS RECOMMENDATIONS FOR THE INSTALLED RISE AND EQUIVALENT LENGTH OF REFRIGERATION/WATER LINES FULLY INSULATED WITH ARMAFLEX, ETC., AND VAPOUR BARRIER SEALED. ALL AS REQUIRED.

WHERE EXPOSED TO THE WEATHER SERVICES PIPE WORK MUST BE: INSULATED VAPOUR SEALED AND SHEATHED WITH METAL CLADDING. ALL PIPE WORK TO BE MOUNTED AND CLAMPED TO SUPPORTING FRAMES, NEATLY ARRANGED FOR EASY SERVICE, ETC. WHERE LOCATED ON METAL DECK ROOFS PIPES, FRAMES, ETC., MUST BE RUBBER ISOLATED SO AS NO ELECTROLYTIC REACTION OCCURS.

WHERE DISSIMILAR PIPE WORK METALS ARE USED THE MECHANICAL CONTRACTOR MUST ISOLATE WITH VOLUMETRIC OR EQUAL TYPE FITTINGS TO PREVENT ELECTROLYTIC REACTION IN SYSTEM. ALL TO BE INSTALLED TO MANUFACTURERS RECOMMENDATIONS.

THE CONTRACTOR IS TO MAKE PROVISION FOR PIPEWORK EXPANSION WHERE REQUIRED (OR DEEMED NECESSARY BY THE ENGINEER INCLUDING EXPANSION LOOPS, EXPANSION BELLOWS, DYNAMIC MOUNTS AND ANCHOR POINTS, AS REQUIRED TO PREVENT AGE HARDENING & LEAKS OVER THE LIFE OF THE INSTALLATION.

CONDENSATE DRAINS

ALL CONDENSATE DRAINS MUST BE CORRECTLY SIZED, TRAPPED AND INSTALLED IN ACCORDANCE WITH THE EQUIPMENT MANUFACTURERS RECOMMENDATIONS. DRAINS MUST BE INSTALLED ON GRADE AND SUPPORTED AT MINIMUM 1200mm CENTRES. CONDENSATE DRAIN TO DISCHARGE WITH VISIBLE OUTLET TO DRAIN POINTS PROVIDED BY BUILDER, UNO. EACH FAN COIL UNIT AND CONDENSING UNIT MUST BE DRAINED INDEPENDENTLY TO THE NEAREST APPROVED DRAIN POINT.

PAINTING

DUCTWORK MUST BE PAINTED AS FOLLOWS: 1. DUCTWORK WITHIN BUILDING STRUCTURE EXPOSED TO VIEW MUST BE PAINTED TO MATCH SURROUNDING SURFACES. ALL TO ARCHITECTS APPROVAL. (EXCLUDING CAR PARK)

ALL INTERNAL SURFACES OF DUCTWORK BEHIND AIR OUTLETS, GRILLES, DAMPERS, ETC., MUST BE PAINTED MATT BLACK SO AS NO LIGHT REFLECTION OCCURS.

PIPE WORK MUST BE PAINTED AS FOLLOWS:

1. PIPE WORK WITHIN BUILDING STRUCTURE EXPOSED TO VIEW MUST BE PAINTED TO MATCH SURROUNDING SURFACES. ALL TO ARCHITECTS APPROVAL

WHERE PIPE WORK, SHEATHING, FLUE PIPES, ETC., ARE WITHIN BUILDING, PLANT ROOM EXPOSED TO VIEW, PIPE WORK, SHEATHING, FLUE PIPES, ETC., MUST BE PAINTED (COLOUR) TO APPROVAL. WHERE PIPE WORK, SHEATHING, FLUE PIPES, ETC., ARE EXTERNAL TO

BUILDING STRUCTURE ALL MUST BE PAINTED WITH WEATHER, U.V.

EQUIPMENT IRON SUPPORT FRAMES EXPOSED TO WEATHER MUST BE

PROTECTIVE PAINT TO APPROVAL.

EQUIPMENT SUPPORTS MUST BE PAINTED AS FOLLOWS: 1. EQUIPMENT TIMBER SUPPORTS EXPOSED TO WEATHER MUST BE PAINTED WITH WEATHER U.V. PROTECTIVE PAINT, TO APPROVAL.

PAINTED WITH WEATHER U.V. PROTECTIVE PAINT/HOT DIPPED

GALVANISED UNLESS OTHERWISE INDICATED. ALL TO APPROVAL.

ELECTRICAL EACH ITEM OF MECHANICAL EQUIPMENT MUST BE WIRED COMPLETE WITH LOCAL ISOLATING SWITCH LOCATED ADJACENT. COMPLY WITH THE CURRENT AS/NZ1668.1, AS 1668.2, SAA WIRING RULES AS3000, GOVERNING AUTHORITIES REQUIREMENTS, AS CODES, LOCAL

SUPPLY AUTHORITY SPECIAL REQUIREMENTS, ETC. LABEL ALL POWER OUTLETS, POWER SUPPLIES, SWITCHES, RELAYS, CONTACTS, CABLES, ETC., TO CLEARLY INDICATE EQUIPMENT CIRCUITS, SWITCHBOARD NUMBERS, ETC. LABELS ARE TO BE ENGRAVED AND FIXED TO THE FACE PLATES WITH INDUSTRIAL ADHESIVE LABELS MUST BE BLACK LETTERS ON WHITE BACKGROUND. CONTRACTOR TO SUBMIT LABELLING SCHEDULE AND TYPICAL SAMPLE TO CONSULTING ENGINEERS

FOR APPROVAL PRIOR TO ANY INSTALLATION ON THIS PROJECT. THE ELECTRICAL WORKS MUST INCLUDE THE SUPPLY, INSTALLATION, OF ALL ELECTRICAL POWER WIRING, CONTROL WIRING, CONTACTS, RELAYS, LIGHTS, OVER LOAD PROTECTION, RUN ON TIMERS, TESTING, COMMISSIONING, WARRANTY, MAINTENANCE, ETC., FOR THE SAFE AND EFFICIENT MODE OF AUTOMATIC OPERATION OF THE MECHANICAL SERVICES. INSTALLATION OF ALL WORKS MUST BE CARRIED OUT BY AN EXPERIENCED AND QUALIFIED SUBCONTRACTOR FOR ELECTRICAL INSTALLATION OF AIR CONDITIONING

SYSTEMS POWER, CONTROLS, ETC. IT IS THE RESPONSIBILITY OF THE MECHANICAL CONTRACTOR TO NOTIFY THE BUILDERS ELECTRICAL CONTRACTOR WITHIN A SUITABLE TIME PERIOD FOR THE MECHANICAL EQUIPMENT ELECTRICAL LOAD REQUIREMENTS, PROVISIONS, ETC., AS APPLICABLE

WHERE REQUIRED FOR FIRE RATING OF CABLES: i.e.: ESSENTIAL SERVICES, ETC., MECHANICAL CONTRACTOR MUST PROVIDE CABLES OF MIMS, RADOX, X.L.P.E., ETC., WITH THE EQUIVALENT FIRE RATINGS OF THE INSTALLATION REQUIREMENTS AS APPLICABLE.

AIR CONDITIONING UNITS, BOILERS, CHILLER SETS, CONDENSING SETS,

PACKAGED REFRIGERATING/COOLING EQUIPMENT AND ALL OTHER EQUIPMENT

AS APPLICABLE MUST ALLOW TO START UP EQUIPMENT AND PROVIDE THE

START UP: EQUIPMENT MANUFACTURERS OF SWITCHBOARDS, PUMPS, PACKAGED/ SPLIT

CONTRACT.

REQUIRED TWELVE (12) MONTHS SERVICE AND WARRANTY. **VARIATIONS:** REQUIRED, WHETHER OR NOT THESE ARE CLEARLY IDENTIFIED ON PLANS OR

TESTING BALANCING & COMMISSIONING

COMMISSIONING OF ALL EQUIPMENT TO THE EQUIPMENT MANUFACTURERS REQUIREMENTS IN ORDER TO ENSURE PROPER OPERATION OF THE INSTALLED EQUIPMENT AND TO VALIDATE ALL MANUFACTURERS EQUIPMENT WARRANTIES. ALL COMMISSIONING MUST COMPLY WITH SPECIAL ASHRAE, CIBSE & S.M.A.C.N.A. CONDITIONS AS PER COMMISSIONING & MAINTENANCE MANUAL

FULL DETAILS OF ALL COMMISSIONING DATA FOR ALL EQUIPMENT MUST BE PRESENTED TO THE ENGINEER FOR HIS ASSESSMENT. PRACTICAL COMPLETION WILL NOT BE CONSIDERED UNTIL THIS REQUIREMENTS HAS BEEN MET. DATA MUST BE PRESENTED IN COMPARISON WITH CATALOGUE DATA INCLUDING PHASE BALANCING. MAXIMUM ELECTRICAL POWER DEMANDS, AIR/WATER FLOWS, PRESSURES, rev/s SPEED, CAPACITIES, AIR/WATER ON/OFF CONDITIONS ALL AS APPLICABLE. THE ENGINEER MAY REQUEST FURTHER TESTS AND DATA.

WARRANTY

THE MECHANICAL CONTRACTOR MUST PROVIDE TWELVE MONTHS WARRANTY ON ALL MATERIALS, WORKMANSHIP AND EQUIPMENT. PROVIDE TWELVE MONTHS FREE MAINTENANCE INCLUDING A MINIMUM OF FOUR SITE VISITS AND ALLOW TO PERFORM ALL NECESSARY CHECKS AND MAINTENANCE PROCEDURES IN ORDER TO MAINTAIN AN OPTIMAL SAFE AND EFFICIENT OPERATION OF ALL SYSTEMS. PROVIDE AS REQUIRED EQUIPMENT DEFECTS LIST. PROVIDE 7 DAYS NOTICE PRIOR TO ALL SCHEDULED MAINTENANCE VISITS. WHERE REQUIRED BY AS 1851 PROVIDE MONTHLY ESSENTIAL SERVICES MAINTENANCE.

WORKMANSHIP

ENSURE THAT ALL EQUIPMENT, ANCILLARIES AND MATERIALS PROVIDED ARE NEW, HIGH QUALITY AND OF CORRECT TYPE, DESIGN AND CAPACITY TO EFFICIENTLY PROVIDE THE SPECIFIED FUNCTIONS AND PERFORMANCES. ALL WORKMANSHIP SHALL BE OF A HIGH STANDARD THROUGHOUT

WHERE THE ENGINEER CONSIDERS WORKMANSHIP NOT TO BE CONSISTENT WITH GOOD TRADE PRACTICE OR STANDARDS OR THAT ANY PLANT IS INFERIOR IN QUALITY OR DEFICIENT IN QUALITY TO THAT SPECIFIED, THE ENGINEER MAY GIVE WRITTEN NOTICE OF ANY DEFECT OR DEFICIENCY AND SUCH CONDEMNATION SHALL BE CONCLUSIVE. REJECTED WORK OR MATERIALS SHALL BE REMOVED FROM THE SITE AND DEFECTIVE WORK SHALL BE RECONSTRUCTED TO CONFORM TO THE SPECIFIED REQUIREMENTS AT NO ADDITIONAL COST TO THE PROJECT PRIOR TO PRACTICAL COMPLETION.

RESPONSIBILITY OF CONTRACTOR

THE CONTRACTOR REMAINS RESPONSIBLE FOR ALL WORK, EMPLOYEES, AGENTS AND MATERIALS INCLUDED IN THE CONTRACT WORKS. THE CONTRACTOR MUST MAKE GOOD ANY ACCIDENTAL DAMAGE TO SITE SERVICES, FENCING, PIPING, PATHS, ROADS, CURBS, GUTTERING OR ANY ADJOINING PROPERTY WHICH HAS BEEN DISTURBED OR DAMAGED DUE TO THE ACTIONS OF EMPLOYEES, SERVANTS OR AGENTS. ANY DAMAGE MUST BE REPAIRED BY QUALIFIED TRADESMEN TO APPROVAL OF THE SUPERINTENDENT.

THE SITE AND PRECINCTS SHALL BE KEPT CLEAN AND TIDY THROUGHOUT THE COURSE OF THE WORK. PRIOR TO PRACTICAL COMPLETION, ALL DEBRIS AND RUBBISH SHALL BE CLEARED AWAY AND REMOVED FROM THE SITE AND THE COMPLETED INSTALLATION AND EFFECTED SURROUNDING AREAS MUST BE THOROUGHLY CLEAN.

BUILDERS WORKS:

THE MECHANICAL SERVICES SUB-CONTRACTOR MUST INDIVIDUALLY LIST ALL BUILDERS WORKS EXCLUSIONS AS PART OF THEIR TENDER SUBMISSION SO THAT THE CONTRACTOR IS FULLY INFORMED. ANY WORKS 'BY OTHERS' OR 'OTHER TRADES' IN THIS DOCUMENTATION IS ONLY TO ASSIST IN THE DELINEATION OF THE SERVICES SUB-CONTRACTOR'S SCOPE OF WORK. WORKS 'BY OTHERS' OR 'OTHER TRADES' MUST ALWAYS FORM PART OF THE TOTAL CONTRACT AND IS TO BE UNDERTAKEN BY THE CONTRACTOR IN ORDER TO COMPLETE THE WORK AS A WHOI F

THE FOLLOWING WORK IS BY THE BUILDER: - ALL PENETRATIONS IN EXTERNAL WALLS, ROOF, FLOOR SLABS, ETC., FOR LOUVRES DUCTWORK, PIPE WORK, FRAMES, INCLUDING TRIMMER SUPPORTS, PRIMARY FLASHINGS WHERE REQUIRED & ALL REQUIRED CLEARANCES ETC. - EQUIPMENT PLATFORM/PLINTH SUPPLIED AND INSTALLED BY BUILDER. (MECHANICAL CONTRACTOR MUST PROVIDE THE BUILDER WITHIN A REASONABLE TIME FRAME THE REQUIRED SIZE AND EQUIPMENT LOADS FOR

PLATFORM/CONCRETE PLINTHS, ETC.). - FIRE RATED SHAFTS & FIRE RATED CLADDING OF DUCT IF REQUIRED.

REQUIRED. ALL PENETRATIONS TO BE SET OUT, LOCATED AND MARKED BY THE MECHANICAL CONTRACTOR AND APPROVED BY THE BUILDER PRIOR TO ANY WORKS BEING

PENETRATIONS MUST INCLUDE CLEARANCES FOR EQUIPMENT AND SLEEVES WHERE

CARRIED OUT ON SITE. ALL PENETRATIONS MUST BE CAULKED THEN SEALED WITH FLEXIBLE TYPE ACOUSTIC SILICONE. ALL TO COMPLY WITH AS4072, & RELEVANT AUTHORITY REGULATIONS, MAINTAINING FIRE RATINGS, ACOUSTIC PERFORMANCE, ANTI-VIBRATION QUALITIES. WEATHERPROOF ALL EXTERNAL WALL/ROOF PENETRATIONS WITH

PLUMBING INDUSTRY STANDARD OVER FLASHINGS.

CROSSING BEAMS THE CONTRACTOR IS TO PROVIDE SHEET METAL OR APPROVED PLASTIC DUCT TRANSITIONS WHERE DUCTS (ROSSES STRUCTURAL BEAMS AS REQUIRED TO

MINIMISE SYSTEM PRESSURE LOSS. MAINTENANCE

ON COMPLETION OF THE MECHANICAL SERVICES INSTALLATION, THE CONTRACTOR MUST SUPPLY THREE SETS OF OPERATION MAINTENANCE INSTRUCTION MANUALS COMPLETE WITH "AS BUILT" DRAWINGS REFLECTING THE TRUE WORKS AS INSTALLED ON THIS PROJECT

THE INSTRUCTION MANUALS MUST BE BOUND IN HARD COVERS. THEY MUST FULLY DESCRIBE ALL EQUIPMENT INSTALLED. ALL RELEVANT INFORMATION WITH RESPECT TO OPERATING PROCEDURE, MAINTENANCE REQUIREMENTS AND PROGRAM SCHEDULE FOR ITEMS OF EQUIPMENT MAINTENANCE DATES TO BE CARRIED OUT COMPLETE WITH PROCEDURES FOR DISMANTLING AND OVERHAULING ITEMS OF EQUIPMENT

INSTALLED ON THIS PROJECT. 3-OFF COPIES OF MAINTENANCE MANUALS TO INCLUDE THE FOLLOWING: i) COVER SHEET INCLUDING NAMES, ADDRESSES & TELEPHONE NUMBERS OF THE

iv) MANUFACTURERS PERFORMANCE DATA & MAINTENANCE REQUIREMENTS FOR

- MECHANICAL SUB-CONTRACTOR AND THE CONSULTING ENGINEERS. ii) TABLE OF CONTENTS (INDEX) PAGE iii) DESCRIPTION OF EACH INDIVIDUAL SYSTEM.
- ALL EQUIPMENT AND ACCESSORIES. v) OPERATIONAL INSTRUCTIONS FOR ALL SYSTEMS. vi) MAINTENANCE FREQUENCY AND MAINTENANCE PROCEDURES FOR ALL EQUIPMENT AND ACCESSORIES INSTALLED IN THIS PROJECT

vii) EQUIPMENT COMMISSIONING SHEETS & ALL TEST REPORTS

ANY EXCLUSIONS OR CONDITIONS

viii) P.I.C. COMPLIANCE CERTIFICATES & ELECTRICAL SAFETY CERTIFICATES. ix) WARRANTY STATEMENT LISTING START DATE (DATE OF PRACTICAL COMPLETION) & FINISH DATE FOR BOTH EQUIPMENT AND WORKMANSHIP AND

x) FINAL APPROVED AS INSTALLED DRAWINGS DRAWINGS

PRIOR TO ORDERING ANY MATERIALS OR EQUIPMENT THE MECHANICAL CONTRACTOR MUST SUBMIT THREE SETS OF SCALE 1:50 WORK SHOP DRAWINGS FOR APPROVAL. NO VARIATIONS WILL BE AWARDED FOR DEFECTS AS A RESULT OF UN-APPROVED WORKS.

BY SUBMITTING A TENDER FOR THIS WORK, TENDERERS ACKNOWLEDGE THAT THE PRIOR TO PRACTICAL COMPLETION THE MECHANICAL CONTRACTOR MUST SUBMIT 1:50 HAVE FULLY ASSESSED THE NECESSARY EXTENT OF WORK AND HAVE ALLOWED SCALE AS-BUILT DRAWINGS THAT REFLECT THE TRUE EXTENT & LAYOUT OF THE FOR ALL ITEMS, ACTIVITIES, MATERIALS AND LABOUR WHICH ARE OBVIOUSLY SYSTEMS AS INSTALLED FOR APPROVAL AND INCORPORATE AND ADDITIONS DEEMED NECESSARY BY THE ENGINEER FOLLOWING FINAL APPROVAL, AS SPECIFICATION. NO COST ADJUSTMENT WILL BE CONSIDERED FOR FAILURE TO INSTALLED DRAWINGS ARE TO BE INCLUDED IN THE REQUIRED 3-SETS OF RECOGNISE AND IDENTIFY ANY POTENTIAL EXTRA COSTS PRIOR TO SIGNING ANY MAINTENANCE MANUALS

TENDER ISSUE | AV | 07.08.17 issue| rev.| description date

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MECHANICAL, ELECTRICAL, HYDRAULIC AND FIRE SERVICES CONSULTING ENGINEERS AND PROJECT MANAGERS

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maccormack.com.au

Web:



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of the consulting engineers Contractors must verify all dimensions at the job before commencing any work or preparing shop drawings.

Contractors must locate all air registers pipework outlets, light fittings, power outlets, sprinkler heads, etc. from the Architects reflected ceiling plans and other detailed

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\$125 payable by this subcontractor project title

1 VINE STREET HEIDELBERG, VIC 3084

MECHANICAL SERVICES GENERAL NOTES &

drawing title

scale


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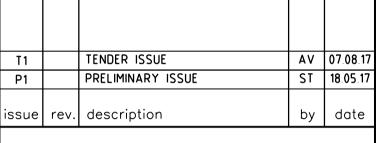
SPECIFICATION

designed ASG	checked ASG
drawn AV/AS	date MAY 2017
job number 1	939
issue	T1

of **8**

drawing number



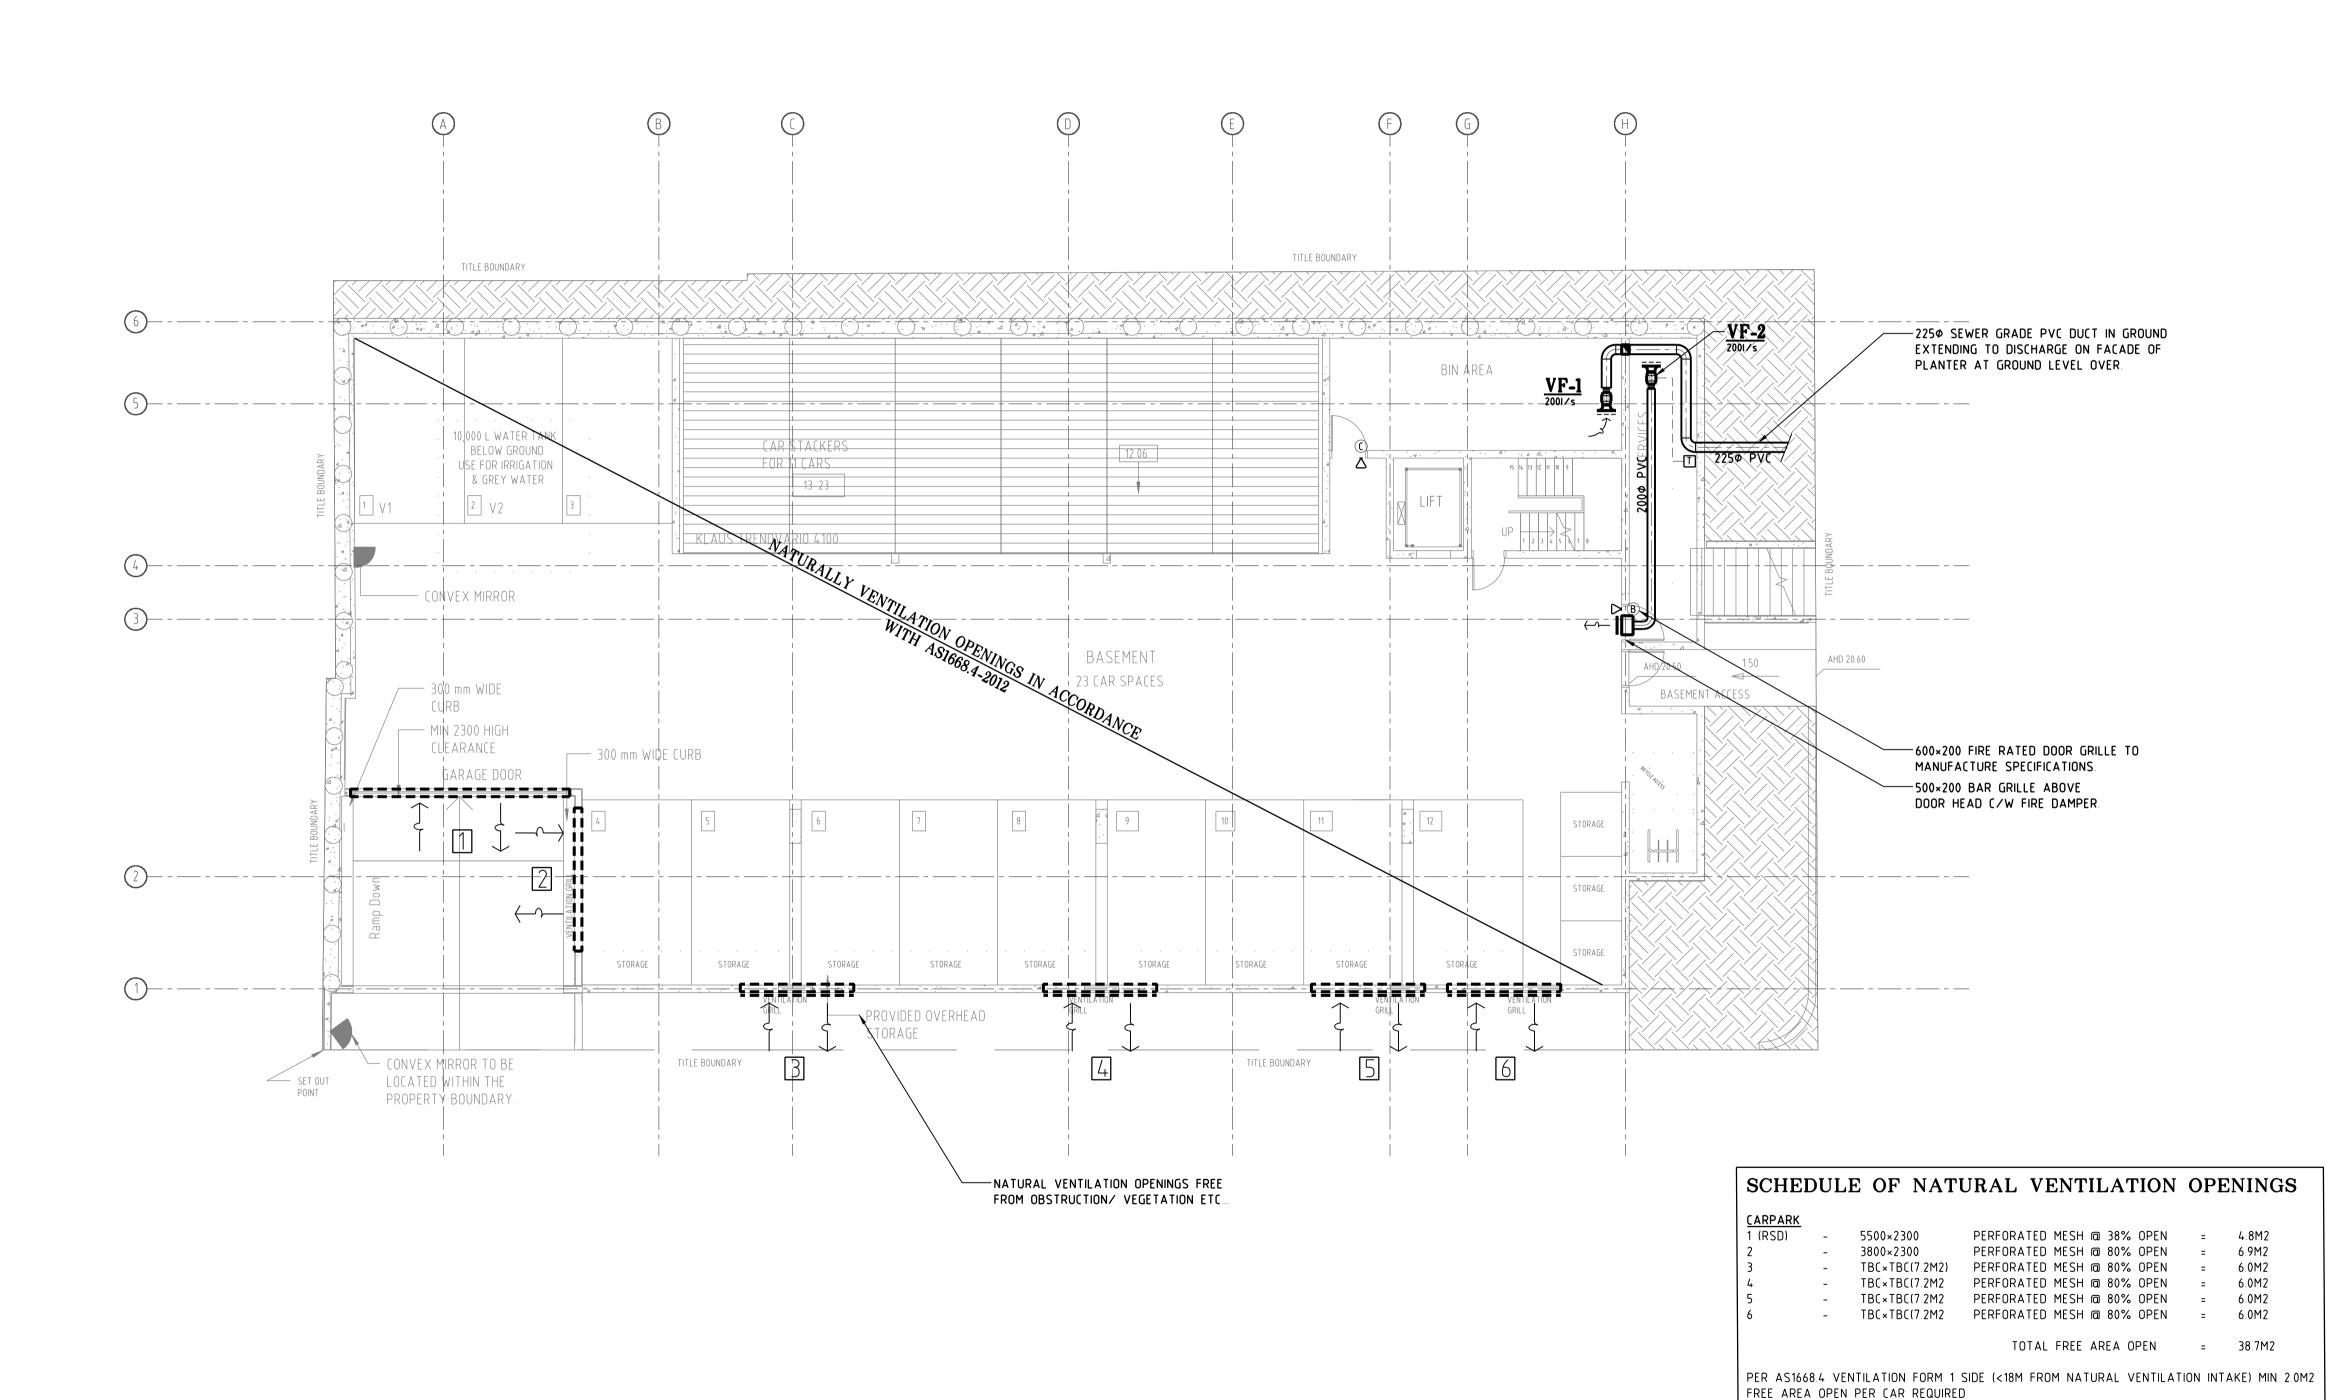



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project title

1 VINE STREET HEIDELBERG, VIC 3084

service

drawing


NO. OF 90PERABLE ENGINES) - 19 × 2.0M2 REQUIRED PER CAR

MECHANICAL SERVICES


BASEMENT LEVEL AIR-CONDITIONING & VENTILATION LAYOUT


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drawn AV/AS	date MAY 2017
job number 19	939
issue	 「1

2 of 8

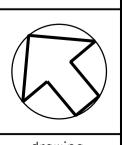

drawing number

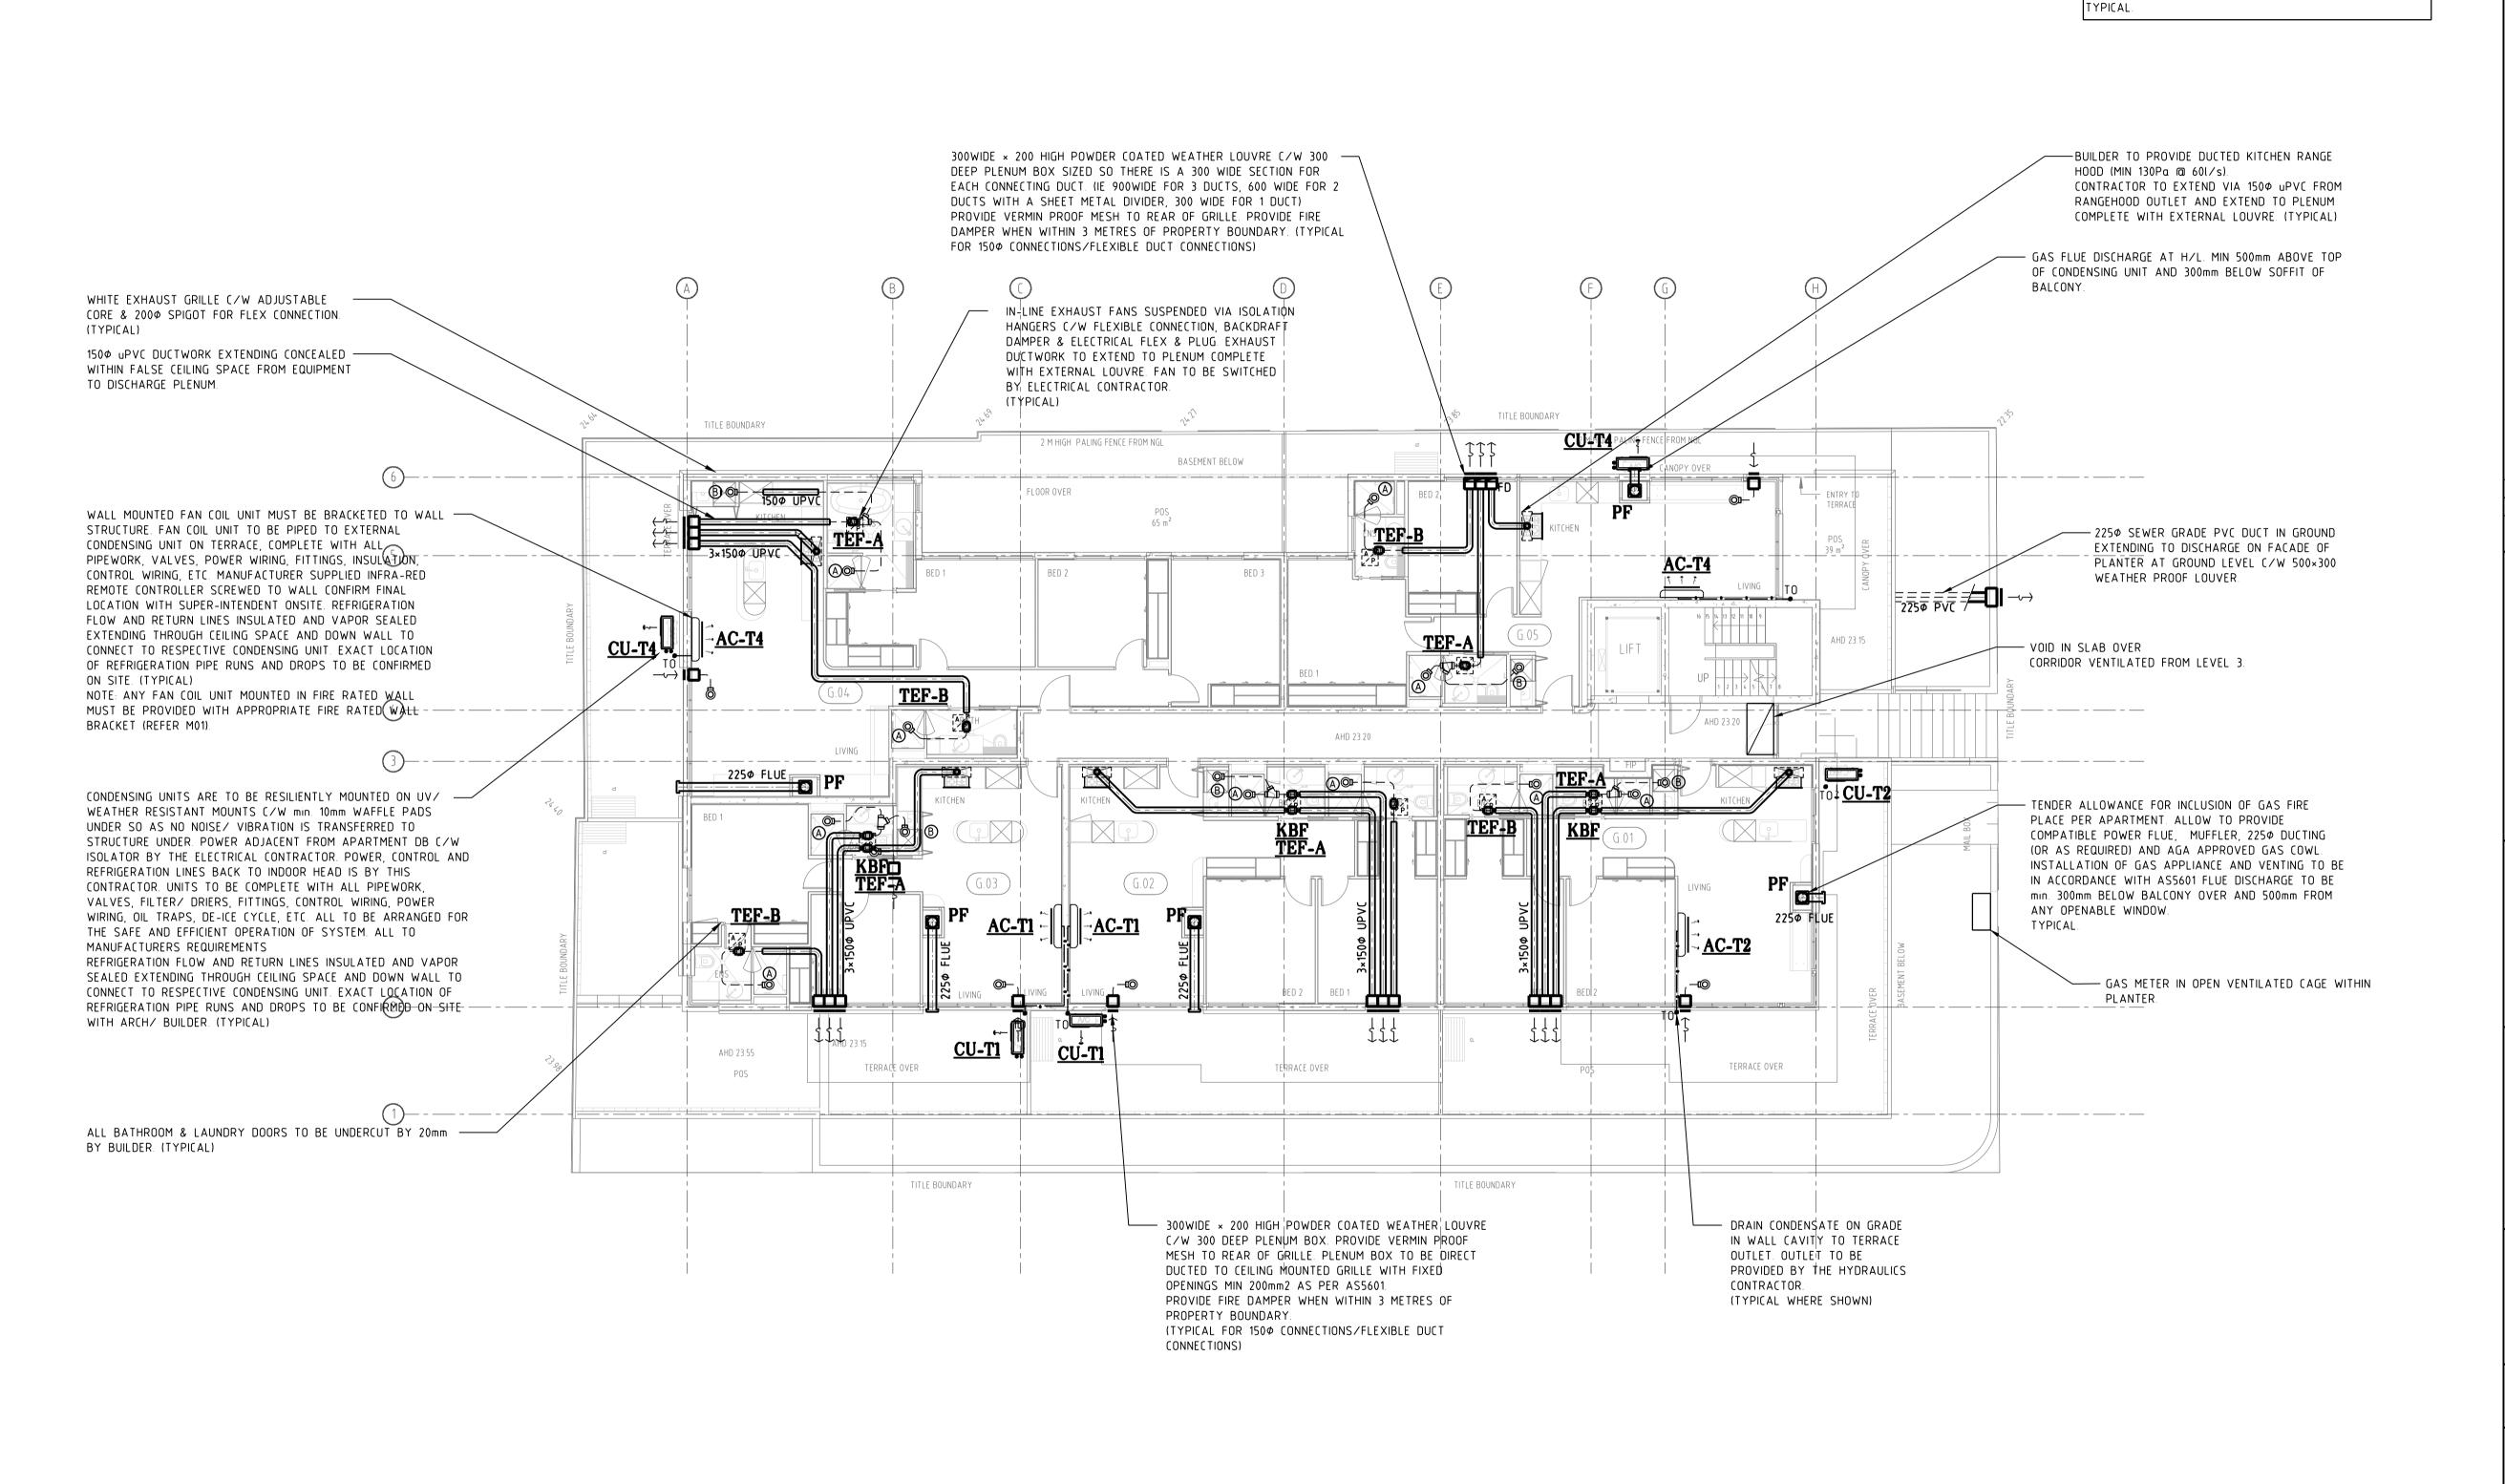

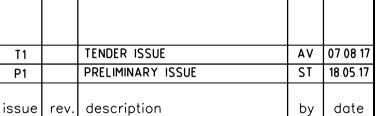



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TENDER NOTE:

FLUE DISCHARGE NOTE -

PROVIDE SEPARATE TENDER PRICE TO ALLOW VENTILATION/DISCHARGE OF GAS FIRE PLACE TO APARTMENT FACADE.
TENDER OPTION PRICE TO INCLUDE ALL POWER FLUE, INLINE

BASED ON JETMASTER -HORIZON MODEL. CONFIRM WITH

FLUE DISCHARGE TO BE min. 300mm BELOW BALCONY OVER

FAN, DUCTING, INSTALLATION DISCHARGE ETC...

BUILDER PRIOR TO TENDER BEING SUBMITTED.

AND 500mm FROM ANY OPENABLE WINDOW.



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1 VINE STREET HEIDELBERG, VIC 3084

\$125 payable by this subcontractor

service

issue

drawing

MECHANICAL SERVICES

GROUND FLOOR AIR-CONDITIONING & VENTILATION LAYOUT


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drawn AV/AS	date MAY 2017
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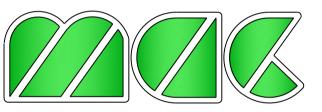
of **8**



number M3



T1 TENDER ISSUE AV 07.08.17
P1 PRELIMINARY ISSUE ST 18.05.17

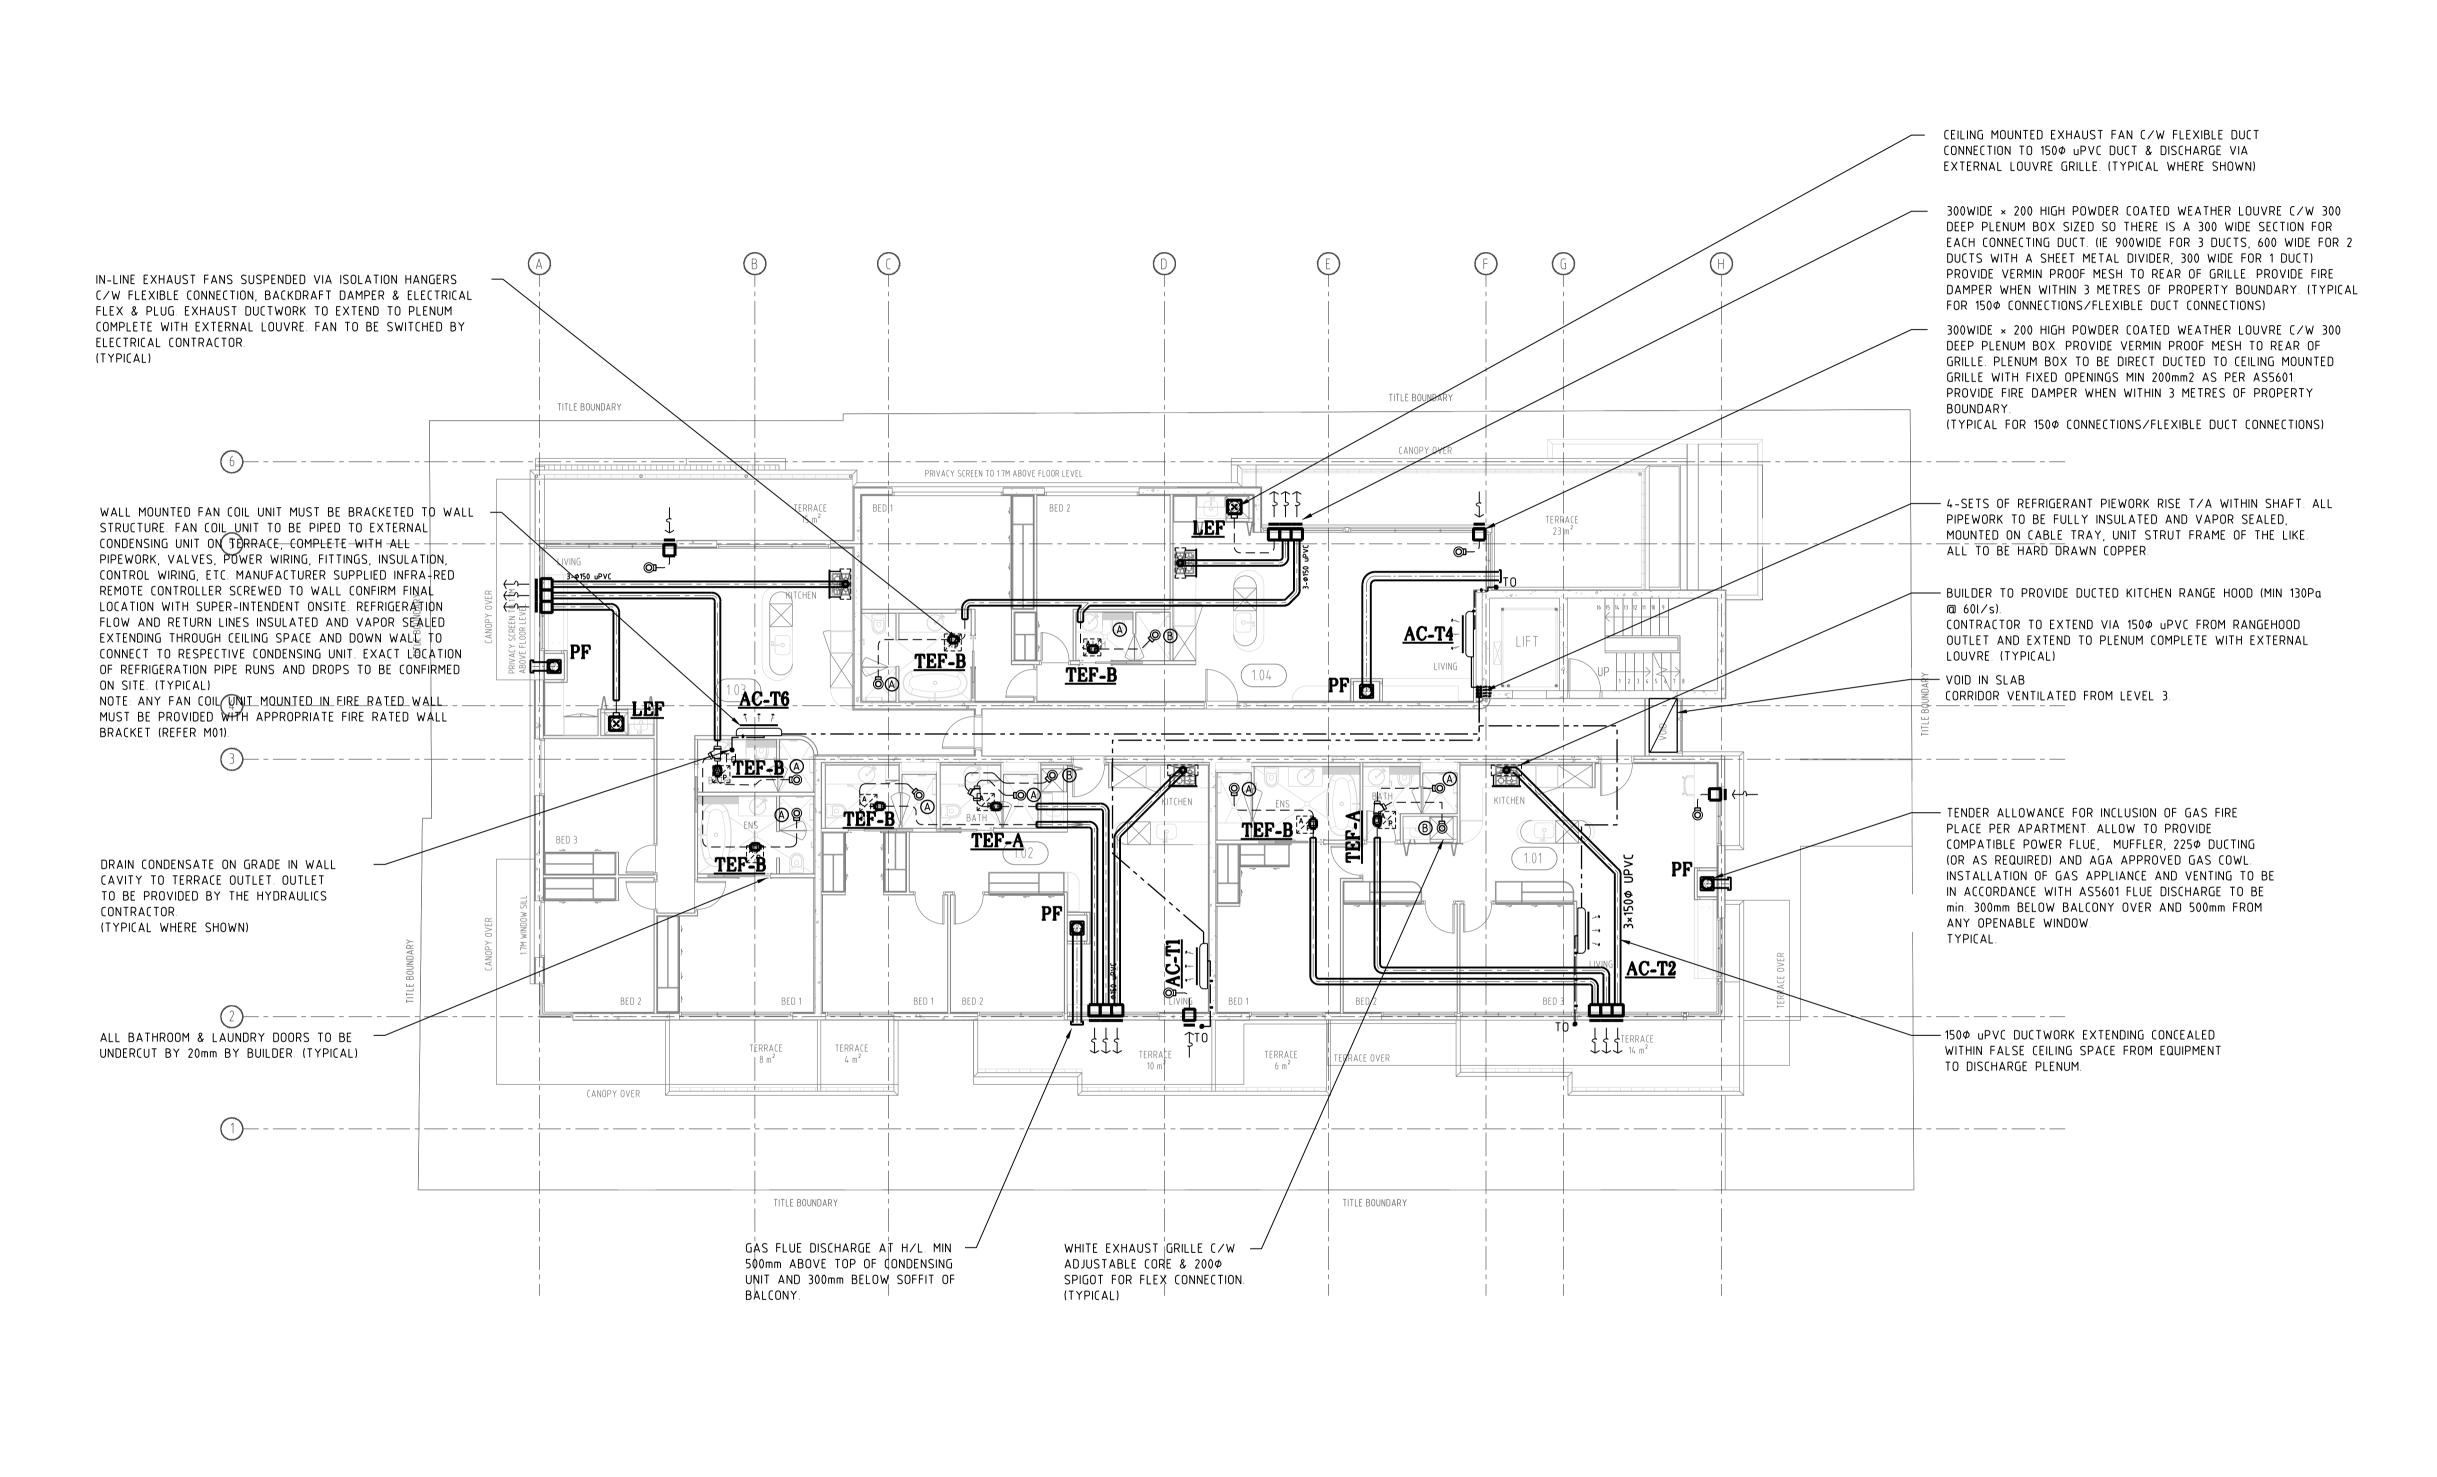

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issue rev. description

TENDER NOTE:

TYPICAL.

FLUE DISCHARGE NOTE -

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TENDER OPTION PRICE TO INCLUDE ALL POWER FLUE, INLINE

BASED ON JETMASTER -HORIZON MODEL. CONFIRM WITH

FLUE DISCHARGE TO BE min. 300mm BELOW BALCONY OVER

FAN, DUCTING, INSTALLATION DISCHARGE ETC...

BUILDER PRIOR TO TENDER BEING SUBMITTED.

AND 500mm FROM ANY OPENABLE WINDOW.



| by | date

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project title

1 VINE STREET HEIDELBERG, VIC 3084

service

issue

drawing


MECHANICAL SERVICES

FIRST FLOOR AIR-CONDITIONING & VENTILATION LAYOUT


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drawn AV/AS	date MAY 2017	
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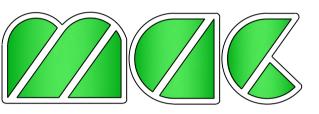
number M4



TENDER NOTE:
PROVIDE SEPARATE TENDER PRICE TO ALLOW VENTILATION/
DISCHARGE OF GAS FIRE PLACE TO APARTMENT FACADE.
TENDER OPTION PRICE TO INCLUDE ALL POWER FLUE, INLINE
FAN, DUCTING, INSTALLATION DISCHARGE ETC...
BASED ON JETMASTER -HORIZON MODEL. CONFIRM WITH
BUILDER PRIOR TO TENDER BEING SUBMITTED.

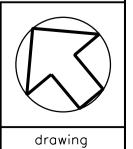FLUE DISCHARGE NOTE FLUE DISCHARGE TO BE min. 300mm BELOW BALCONY OVER
AND 500mm FROM ANY OPENABLE WINDOW.
TYPICAL.

T1		TENDER ISSUE	A۷	07.08.17
P1		PRELIMINARY ISSUE	ST	18.05.17
issue	rev	description	by	date

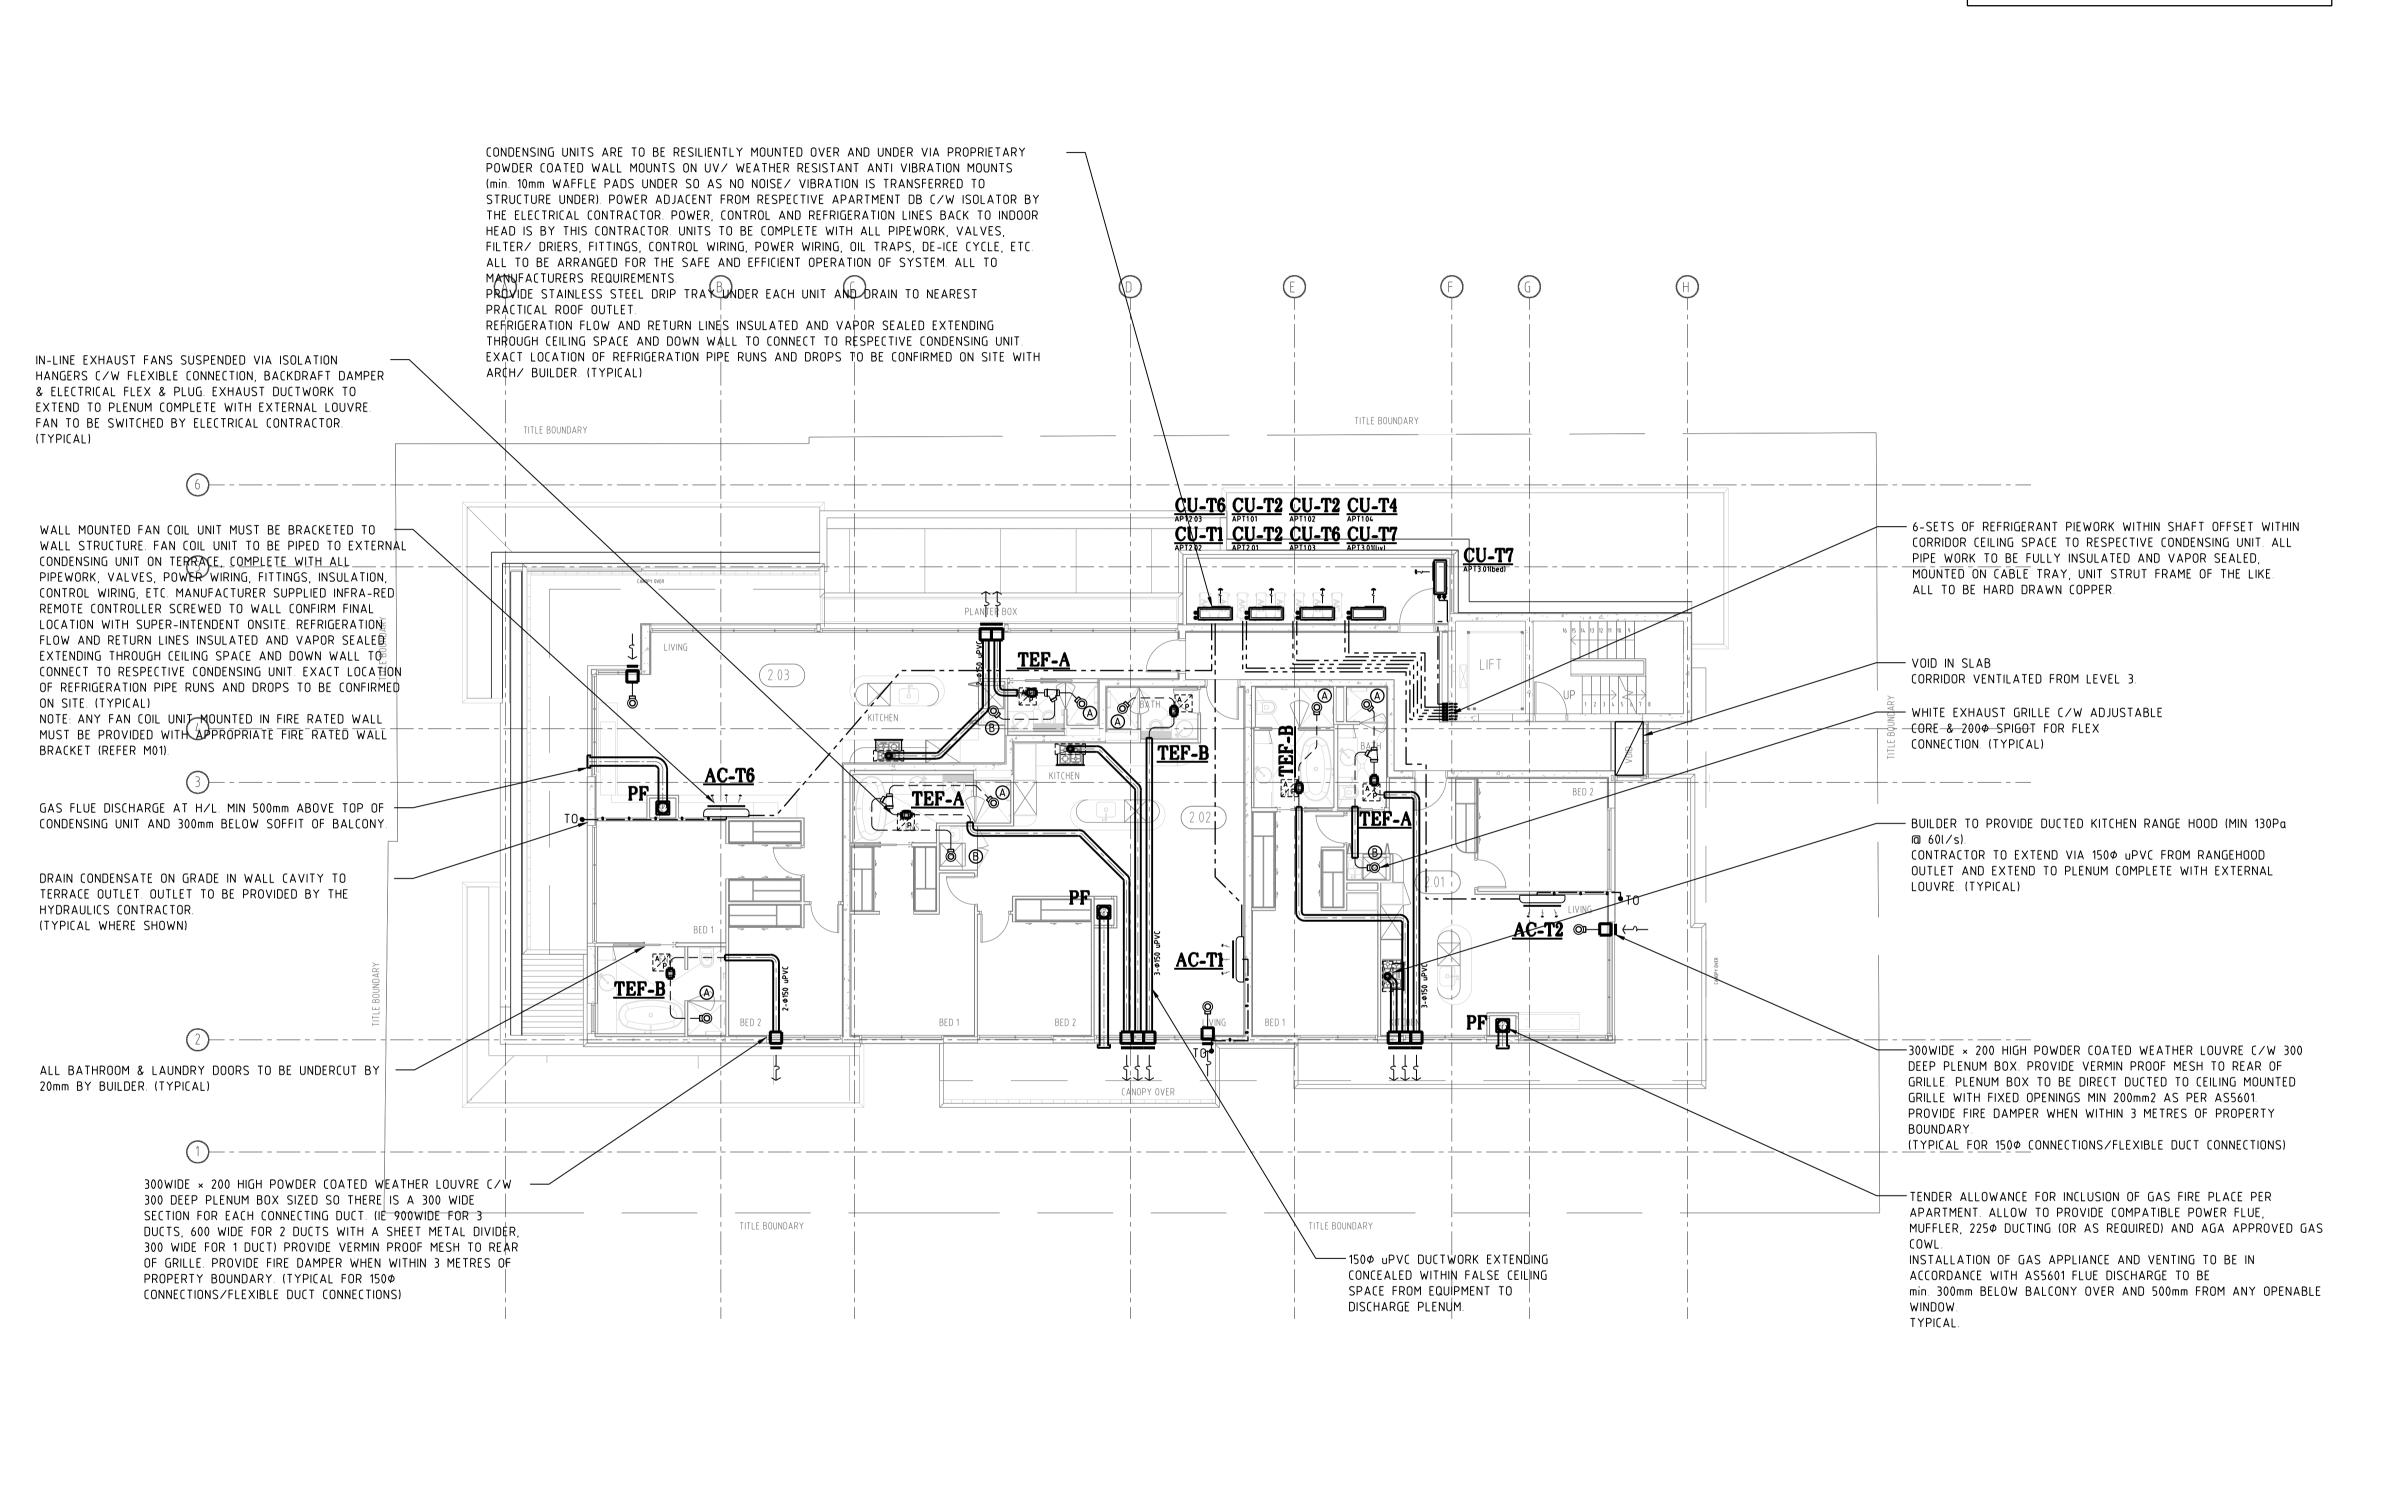

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project title

1 VINE STREET HEIDELBERG, VIC 3084

service

issue

drawing


MECHANICAL SERVICES SECOND FLOOR AIR-CONDITIONING &

VENTILATION LAYOUT drawing title

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designed ASG	checked ASG
drawn	date MAY 2017
job number 1	939

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5 of 8

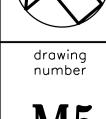


M5

TYPICAL GRILLE LEGEND:

DENOTES CEILING MOUNTED LINEAR SLOT AIR GRILLE COMPLETE
WITH ACOUSTIC CUSHION HEAD BOX, SPIGOT, V.C.D., ETC.

1.5L/2S AIRFLOW (L/s)
PLENUM LENGTH / No. OF SLOTS

- ALL GRILLES TO BE SUPPLIED FROM HOLYOAKE MULTI SLOT CEILING GRILLES (MODEL: CSD-25)
 RETURN AIR LINEAR SLOTS DIFFUSER EQUAL TO OR GREATER THAN THE LENGTH / SLOT NO. OF THE
- ASSOCIATED SUPPLY DIFFUSER.
- 3. ALL FLEXIBLE DUCT SPIGOTS FROM HARD DUCTED S/A TO BE OVALISED.

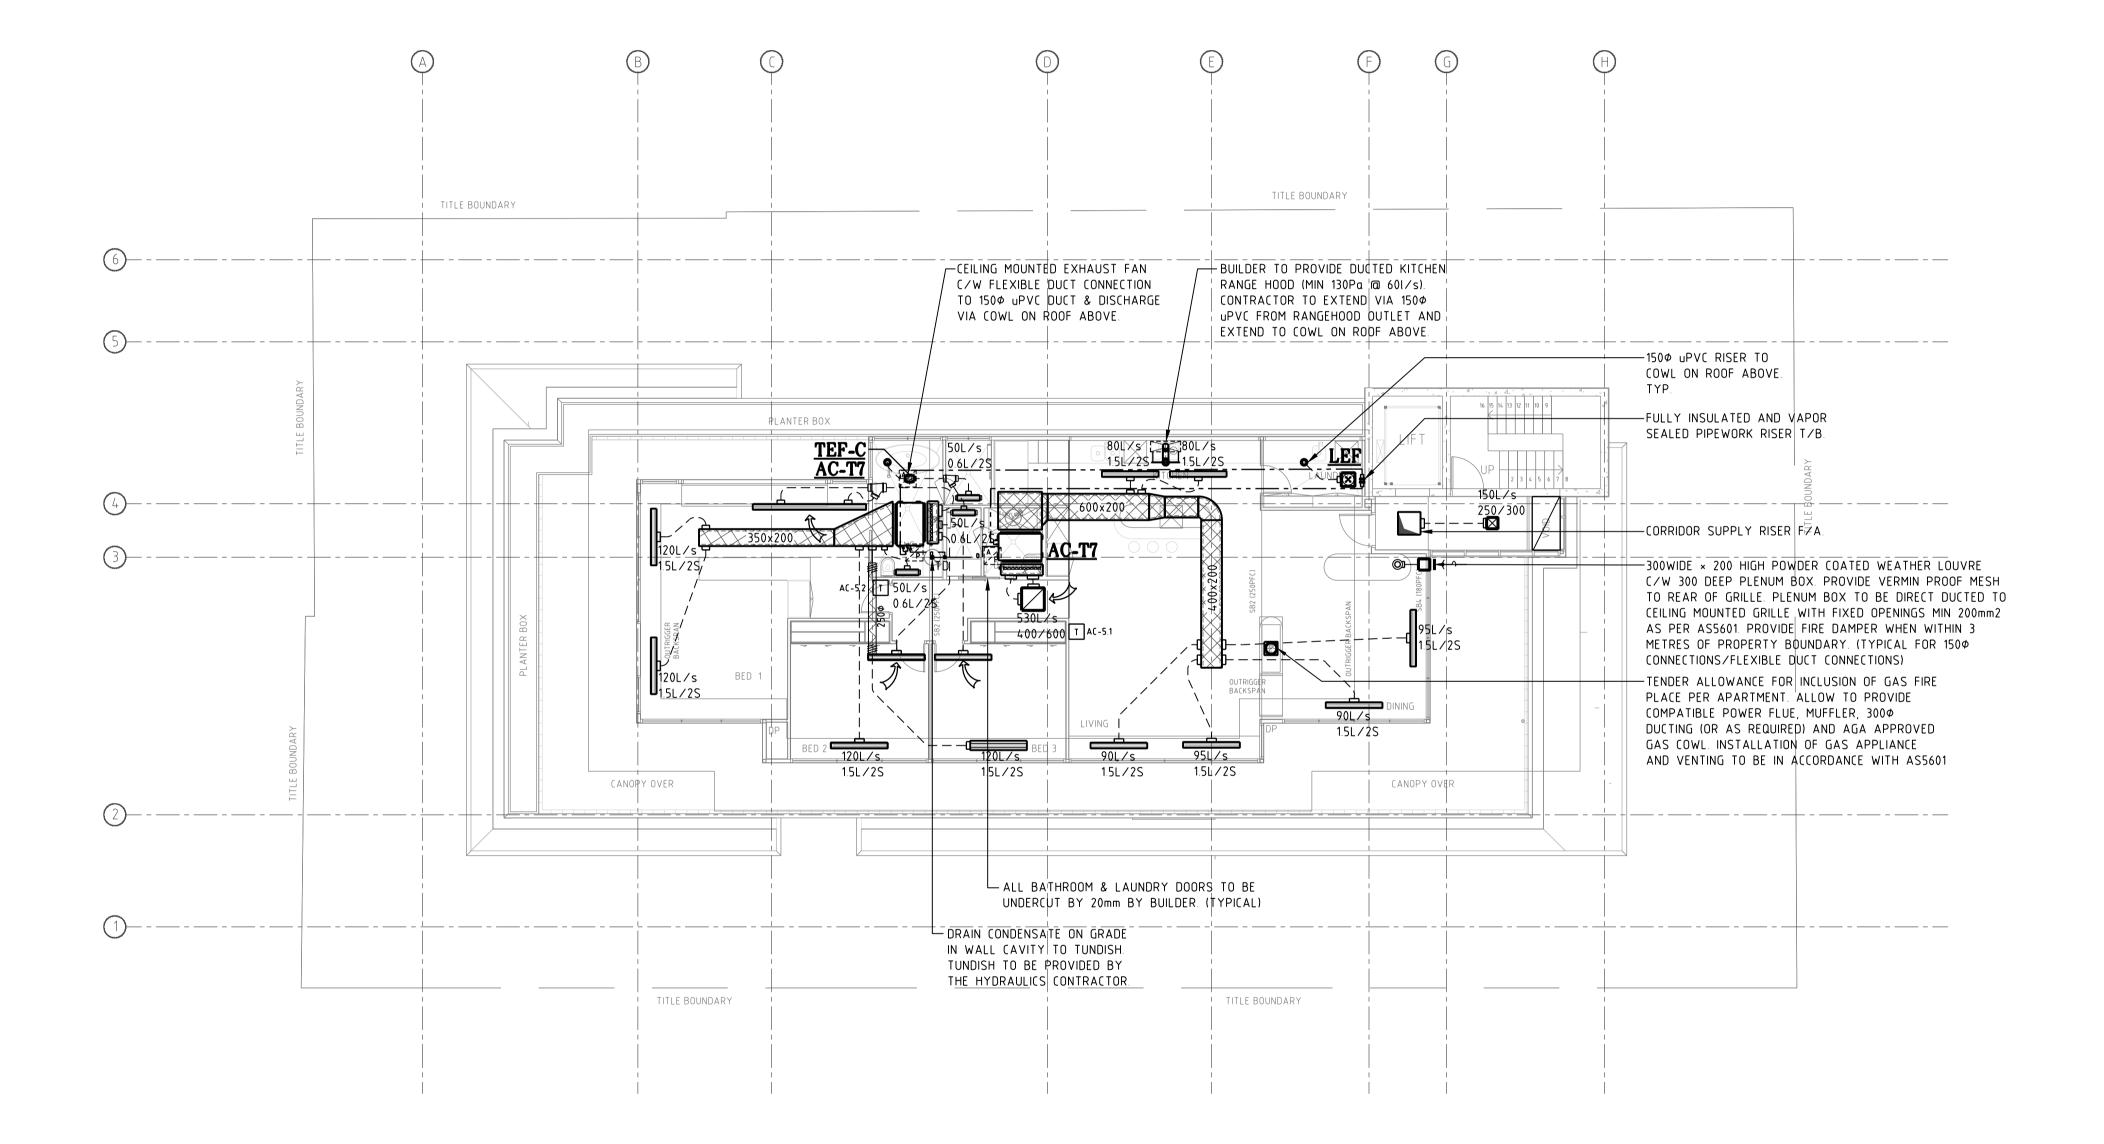

T1		TENDER ISSUE	AS	07.08.17
issue	rev.	description	by	date



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project title

1 VINE STREET HEIDELBERG, VIC 3084

service

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drawing


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MECHANICAL SERVICES

THIRD FLOOR AIR-CONDITIONING & VENTILATION LAYOUT drawing title

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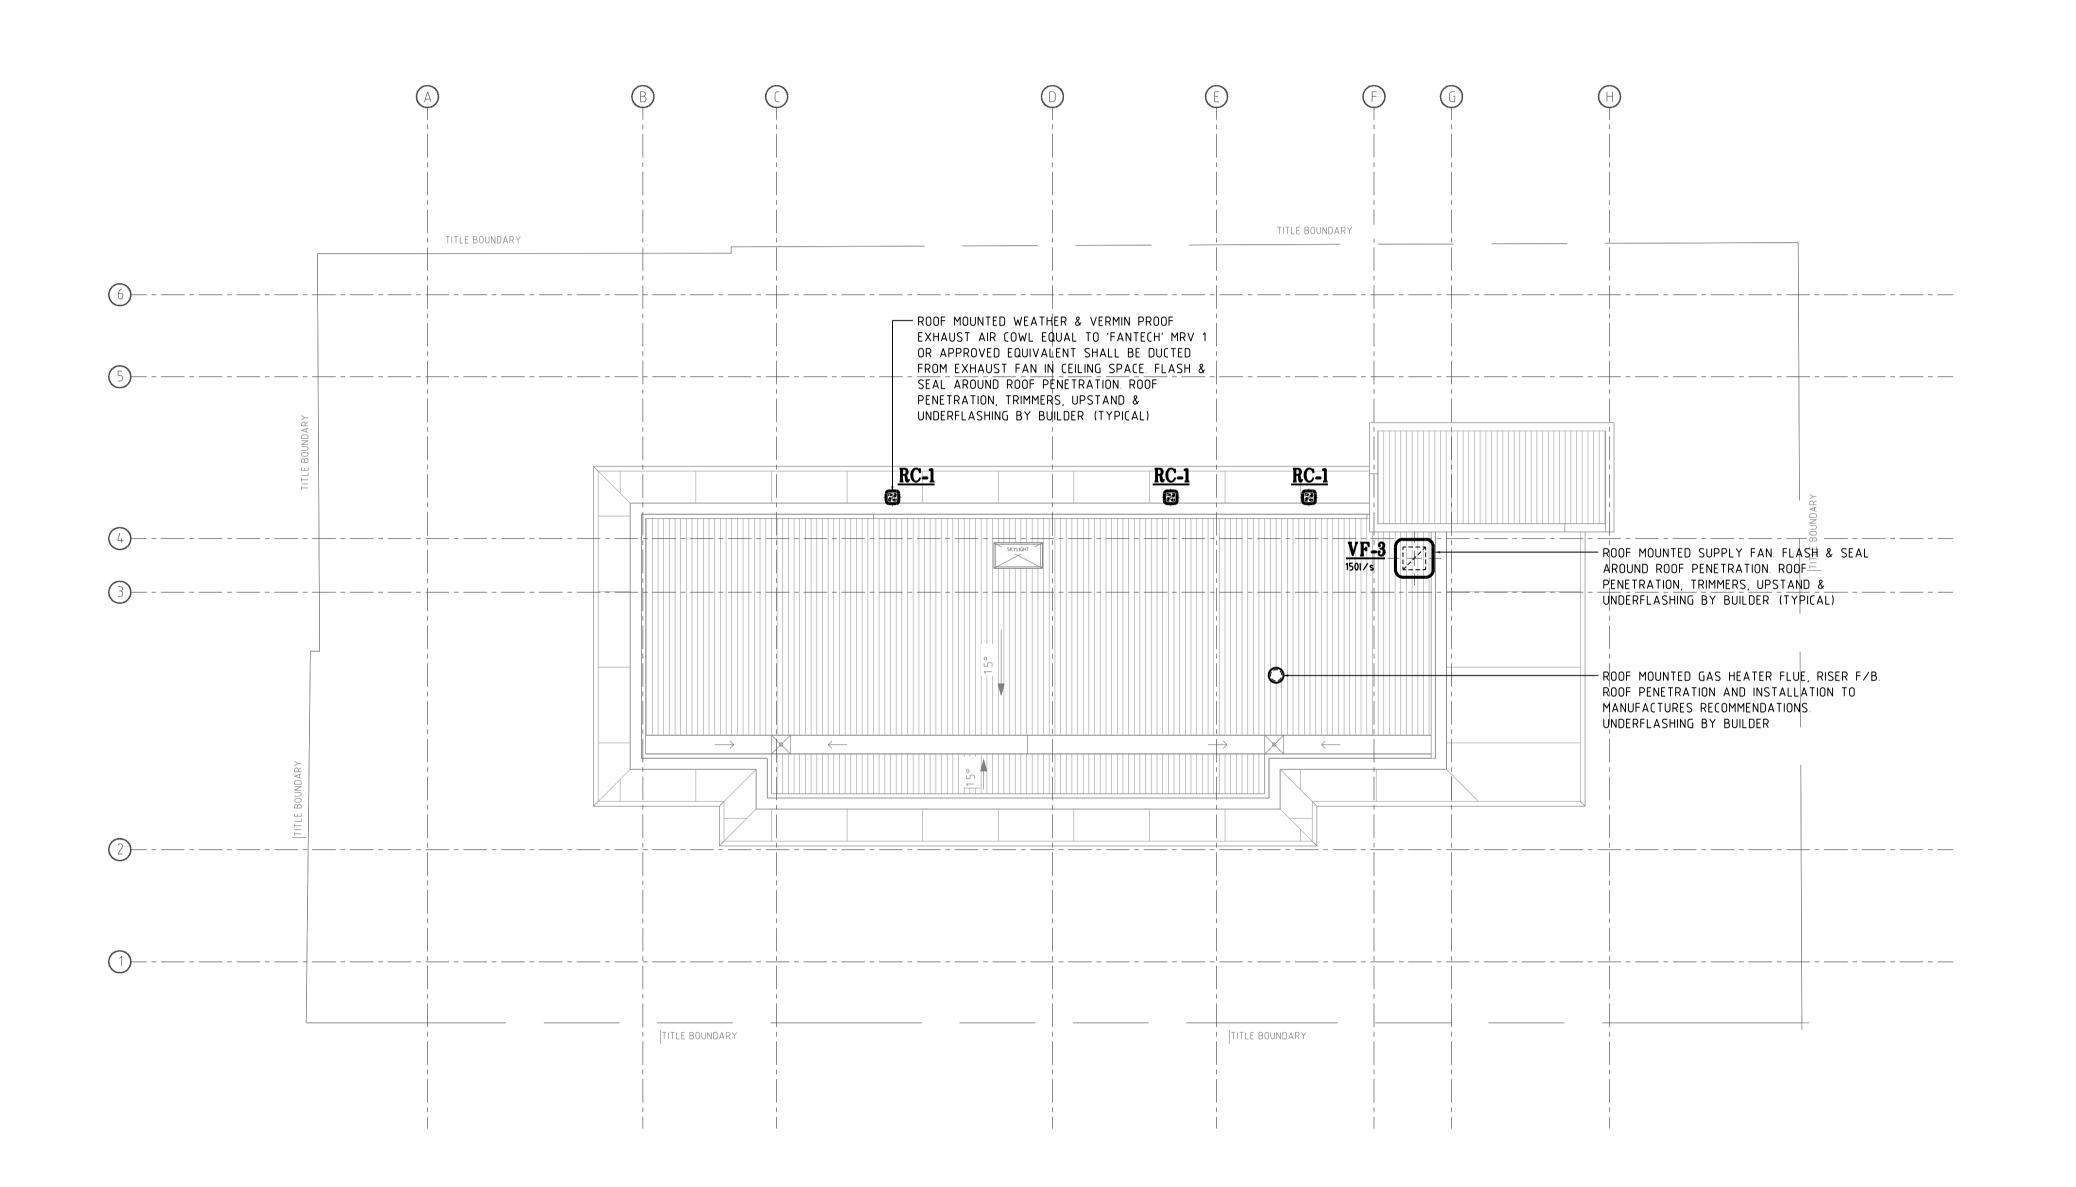
6 of 8



1939 draw num

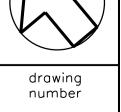T1 M





 T1
 TENDER ISSUE
 AS 07.08.17

 P1
 PRELIMINARY ISSUE
 ST 18.05.17

 issue rev. description
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project title

1 VINE STREET HEIDELBERG, VIC 3084

service

issue

drawing


MECHANICAL SERVICES

ROOF PLAN AIR-CONDITIONING & VENTILATION LAYOUT

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7 of 8



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BUILDER IS RESPONSIBLE TO PROVIDE MAINTENANCE ACCESS TO ALL ROOF MOUNTED EQUIPMENT INCLUDING ALL REQUIRED HAND RAILS, WALKWAYS, HARNESS TIE POINTS, ETC AS REQUIRED IN ACCORDANCE WITH WORK SAFE GUIDELINES, AS 1657, RBS APPROVAL & ALL OTHER RELEVANT STANDARDS/GOVERNING AUTHORITIES.
ALL TO OH&S CONSULTANT ADVICE.

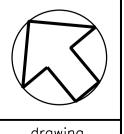AIR CO	ONDITION	NING	&]	FAN	CO	IL U	INIT	SCI	HEDI	ULI	E:					SEL	ECTION: DAIK	IN
CODE	L OC A TION	AIR	ON	CAP:	l/s	Ex.Pa	CAP.	kW	HEAT	F.C	.U. E	lect:	INDOOR/dimens		C.U.	. Elect:	OUTDOOR/dim.	
CODE	LOCATION	°CDB	°CWB	S/A	0/A	Stat.	GTH	GSH	kW	Ph	FUSE	F.L.A	heightxwidth×depth	kg	Ph	FUSE F.L.A.	height×width×depth	kg
AC/CU-T1	LIVING ROOM AS SHOWN	24	17.2	320	-	-	5.86	4.63	6.9	-	-	-	FTXS60LVMA 340 × 1050 × 248	14	1	- 7.9	RXS60LVMA 735 × 825 × 300	46
AC/CU-T2	LIVING ROOM AS SHOWN	24	17.2	351	-	-	6.94	5.27	7.89	-	-	-	FTXS71LVMA 340 × 1050 × 248	14	1	- 10.1	RXS71LVMA 770 × 900 × 320	71
AC/CU-T3	LIVING ROOM AS SHOWN	24	17.2	396	-	-	8.30	6.16	8.88	-	-	-	FTXS85LVMA 340 × 1200 × 240	17	1	- 11.9	RXS85LVMA 990 × 940 × 320	80
AC/CU-T4	LIVING ROOM AS SHOWN	24	17.2	378	-	-	9.18	6.44	10.36	-	-	-	FTXS95LVMA 340 × 1200 × 240	18	1	- 14.8	RXS95LVMA 990 × 940 × 320	82
AC/CU-T5	LIVING ROOM AS SHOWN	24	17.2	267	-	-	6.96	4.62	8	-	-	-	FAQ71CVEA 290 × 1050 × 238	13	1	- 28	RZQS71AV1 990 × 940 × 320	75
AC/CU-T6	LIVING ROOM AS SHOWN	24	17.2	383	-	-	9.79	9.22	11.2	_	-	-	FAQ100CVEA 340 × 1200 × 240	17	1	- 28.6	RZQS100AV1 1430 × 940 × 320	108
AC/CU-T7	AS SHOWN LEVEL 3	24	17.2	532		90	6.95	6.4	7.51	1	-	2.6	FDYQ71LAV1 360 x 1188 x 869	47	1	32 27.5	RZQS71AV1 990 x 940 x 320	75

	EXHAU	ST FAN S	CHEDI	ULE]:							FANTECH OR EQUAL MANUF:
CODE	LOCATION	MODEL: No	SYSTEM	CAPA l/s	CITY: ı Pa	dBA	rps	Ph.	kW	F.L.A	WEIGHT Kg	SYSTEM NOTES:
TEF-A	AS SHOWN	JCE202-3(HI)	Exh. AIR	90	200	49	41	1	0.1	0.45	3.3	EXHAUST AIR FAN TO BE WIRED BY ELEC CONTRACTOR SWITCHING TO BE WIRED TO LIGHTING GANG PLATE. DOUBLE POLE AS REQUIRED
TEF-B	AS SHOWN	JCE202-3(LO)	Exh. AIR	50	140	42	33	1	0.07	0.34	3.3	EXHAUST AIR FAN TO BE WIRED BY ELEC CONTRACTOR SWITCHING TO BE WIRED TO LIGHTING GANG PLATE.
TEF-C	AS SHOWN	JCE202-3(HI)	Exh. AIR	100	200	49	41	1	0.1	0.45	3.3	EXHAUST AIR FAN TO BE WIRED BY ELEC CONTRACTOR SWITCHING TO BE WIRED TO LIGHTING GANG PLATE. DOUBLE POLE AS REQUIRED
LEF	AS SHOWN	ULT29-150SDWT	Exh. AIR	40	100	37	16	1	0.06	0.27	3.3	EXHAUST AIR FAN TO BE WIRED BY ELEC CONTRACTOR SWITCHING TO BE WIRED TO LIGHTING GANG PLATE.
KBF	AS SHOWN	TD-500/150 (LO)	Exh. AIR	60	100	39	31	1	0.045	0.22	2.7	DUCT MOUNTED FAN TO BE PROVIDED WITH FLEXIBLE CONNECTION. ELEC CONTRACTOR TO SWITCH FROM KITCHEN BENCH GPO.
VF-1	BASEMENT	TD-800/200ECO	Exh. AIR	200	100	45	34	1	0.11	0.75	4.9	IN LINE BIN ROOM EXHAUST AIR FAN. FAN TO OPERATE 24Hrs C/W KEYED ON/OFF SWITCH.
VF-2	BASEMENT	TD-800/200ECO	Exh. AIR	200	100	45	34	1	0.11	0.75	4.9	MSB ROOM EXHAUST AIR FAN. THERMOSTATICALLY CONTROLLED FAN IS TO BE INITIALLY SET TO ACTIVATE WHEN ROOM TEMPERATURE EXCEEDS 22°C
VF-3	ROOF	CE356S	Supply AIR	150	100	43.	15	1	0.07	0.32	20	CORRIDOR SUPPLY AIR ROOF MOUNTED FAN. FAN TO OPERATE 24Hrs C/W KEYED ON/OFF SWITCH.
RC-1	ROOF	MRV1	Exh. AIR	<100	50	-	-	-	-	-	1	ROOF MOUNTED EXHAUST COWL

- 1. ALL DUCT MOUNTED FANS TO BE PROVIDED WITH FLEXIBLE CONNECTION ON AIR INTAKE AND AIR DISCHARGE SIDES OF FAN.
- ALL BATHROOM/ LAUNDRY DOORS SERVED BY AN EXHAUST SYSTEM ARE TO BE UNDERCUT BY 20mm BY THE BUILDER. ALL FANS SERVING A CONDITIONED ZONE MUST BE PROVIDED WITH A LOW STATIC LOSS BACK DRAFT DAMPER.
- 4. ALL FANS MUST BE MOUNTED ON ANTI-VIBRATION ISOLATING MOUNTS FROM STRUCTURE DESIGNED FOR LOAD BEARING.
- EACH FAN TO HAVE A LOCAL ISOLATING ON/OFF SWITCH MOUNTED ADJACENT EQUIPMENT.
- 6. ALL BATHROOM FANS TO BE WIRED INTO LIGHTING CIRCUIT SWITCHED VIA SEPARATE 10A SWITCH INTEGRATED WITHIN LIGHTING GANG PLATE. WHERE
- FAN SERVES TWO SPACES ELECTRICAL CONTRACTOR TO DOUBLE POLE LOCAL WALL MOUNTED SWITCH. 7. ALL CARPARK FANS ARE TO BE V.S.D. CONTROLLED & PROVIDED WITH METAL BLADES.
- 8. ALL FANS TO BE INSTALLED TO MANUFACTURERS RECOMMENDATIONS.
- 9. UPON COMPLETION OF FULLY CO-ORDINATED SHOP DRAWINGS AND DISCHARGE ARRANGEMENTS CONTRACTOR TO CONDUCT STATIC PRESSURE
 - CALCULATIONS FOR EACH FAN AND RESELECT FAN TO SUIT AS REQUIRED.

EXHAUST AIR OUTLETS SCHEDULE							
CODE	l/s	PRESS. DROP Pa	SI: Neck	ZE Face	CON FLEX DUCT dia SIZE		NOUF. FANTECH TYPE
А	50	5	200dia	315dia	200	ALG Model 200	CEILING MTD ROUND OUTLET WITH ADJUST CORE, SPIGOT & ACOUSTIC PLENUM BOX.
В	40	5	200dia	315dia	200	ALG Model 200	CEILING MTD ROUND OUTLET WITH ADJUST CORE, SPIGOT & ACOUSTIC PLENUM BOX.

1. ALL EXHAUST AIR GRILLES TO BE ROUND TYPE UNLESS OTHERWISE INDICATED. GRILLES MUST BE INSTALLED COMPLETE WITH CUSHION HEAD BOX, SPIGOT, V.C.D., ETC.


DOOR GRILLE SCHEDULE					
TYPE	L/S	SIZE	NR		
TYPE A	<130	150 × 600	<30		
TYPE B	131-160	210 × 600	<30		
TYPE C	161-180	250 x 600	<30		
TYPE D	181-220	310 × 600	<30		
TYPE E	221-300	450 x 600	<30		
TYPE F	301-370	610 × 600	<30		
ALL GRILLES TO BE CHEVERON BLADE TYPE, COLOUR TO SUIT ARCHITECTURE.					


	0 - 50	150 <i>Φ</i>		
	51 - 100	200 <i>Φ</i>		
	101 - 160	250 <i>Ф</i>		
	161 - 260	300 <i>Ф</i>		
	261 - 400	350 <i>Ф</i>		
	401- 550	400 <i>Ф</i>		
	ALL FLEXIBLE DUCT WORK TO BE FOUR ZERO RATED AND ACOUSTIC TYPE			


AIR FLOW (L/S)


FLEXIBLE DUCT SCHEDULE

MIN DIAMETER

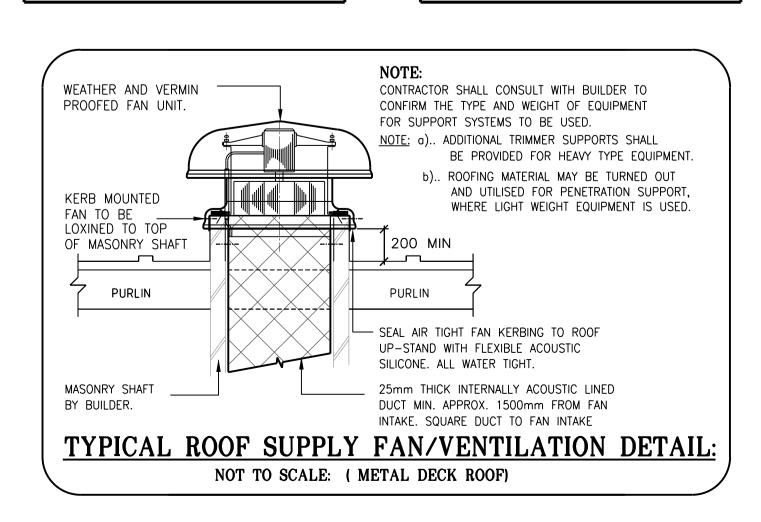

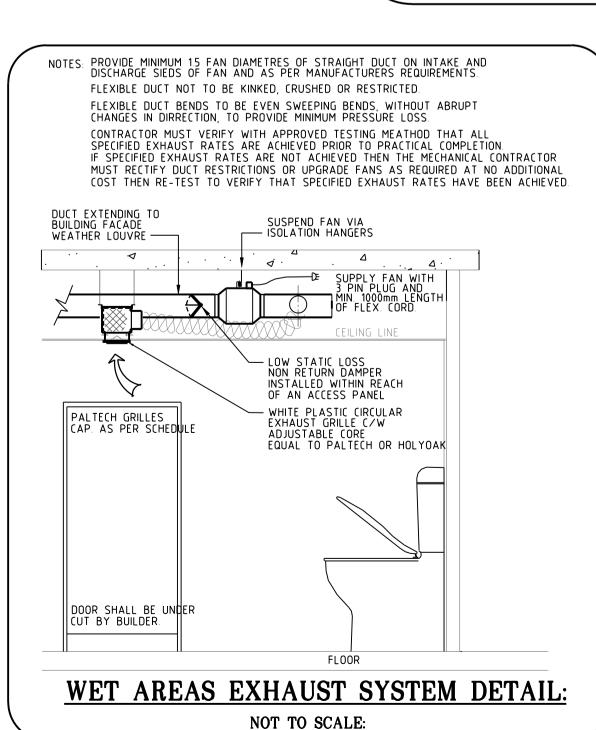

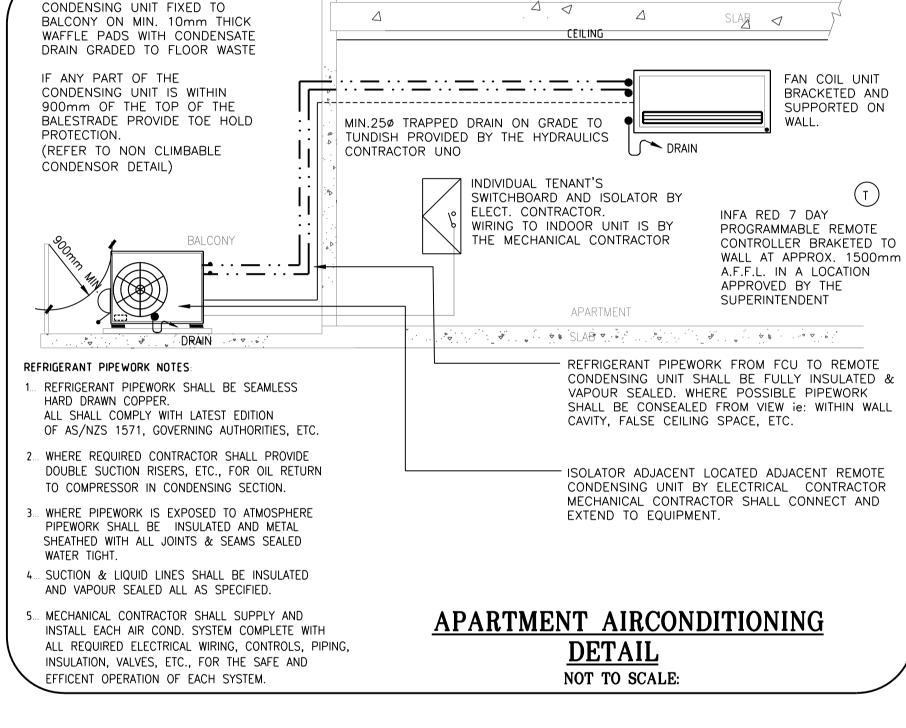

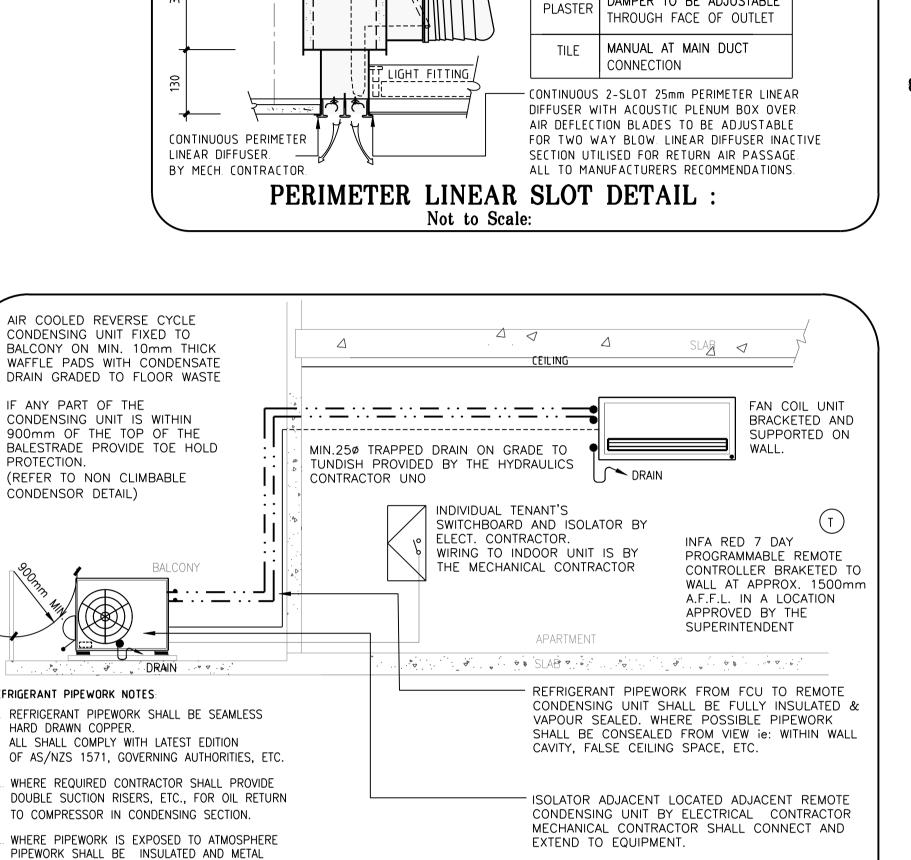

SLAB OVER

- PLENUM BOX 13mm THICK INTERNAL ACOUSTIC

LINED TO BE SUPPORTED FROM STRUCTURE

- CONNECTING FLEXIBLE DUCT WORK TO SPIGOT WITH JUBILEE


CEILING |

CLIP THEN TAPED AIR TIGHT.


OVER. ALL INTERNAL SURFACES ON PLENUM BOXES TO BE PAINTED MATT BLACK.

CONTROL

DAMPER TO BE ADJUSTABLE

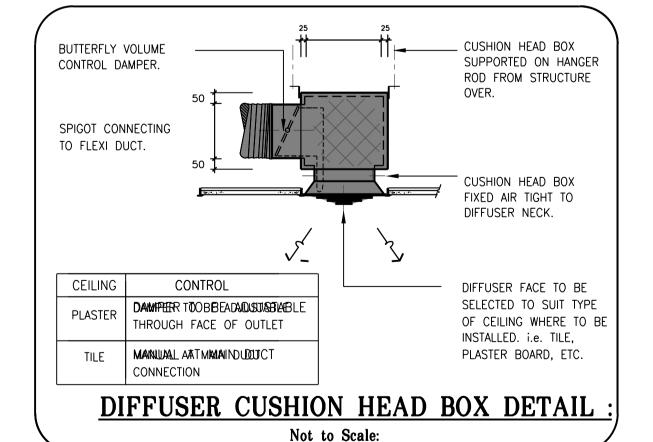

LEGEND:

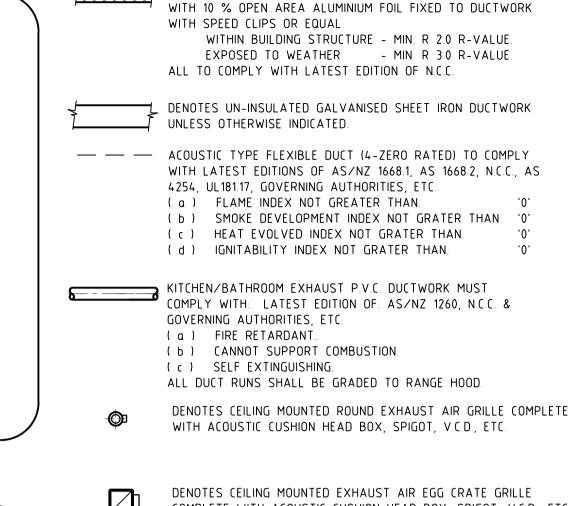

	DENOTES CEILING MOUNTED EXHAUST AIR EGG CRATE GRILLE					
	COMPLETE WITH ACOUSTIC CUSHION HEAD BOX, SPIGOT, V.C.D., ETC.					
FIRST SIZE IS NECK DIMENSION.						
SECOND SIZE IS FACE DIMENSION.						

DENOTES CEILING MOUNTED 4-WAY SUPPLY AIR GRILLE COMPLETE

DENOTES GALVANISED SHEET IRON DUCTWORK INTERNALLY

XXXXX ACOUSTICALLY LINED WITH HIGH DENSITY INSULATION FACED

WITH ACOUSTIC CUSHION HEAD BOX, SPIGOT, V.C.D., ETC. FIRST SIZE IS NECK DIMENSION. SECOND SIZE IS FACE DIMENSION.

CEILING CONCEALED DUCTED TYPE AIR-CONDITIONING UNIT.

WEATHER AND VERMIN PROOFED AIR COOLED REVERSE CYCLE CONDITIONING UNIT. UNIT TO BE BRACKETED TO WALL.

mm WAFFLE PAD LOXINED TO STRUCTURE.

OUTDOOR CONDENSING UNIT SHALL BE MOUNTED ON MIN. 10

DENOTES WALL MOUNTED THERMOSTAT. T'STAT TO BE COMPLETELY FULLY PROGRAMMABLE 365 DAY TIME CLOCK/DAY LIGHT SAVINGS, PUBLIC HOLIDAY, ETC., (PROVIDE TAMPER PROOF COVER) T'STAT TO BE INITIALLY SET @ 22.5°C db.

DENOTES FIRE DAMPER FIRE DAMPER TO HAVE SAME RATING AS INTEGRITY (i.e.: MIN. STRUCTURAL ADEQUACY/INTEGRITY/INSULATION). MATERIAL WHERE INSTALLED. FIRE DAMPER TO MAINTAIN SAME AS WHERE INSTALLED. WHERE CURTAIN TYPE FIRE DAMPERS ARE INSTALLED THE CURTAIN MUST BE KEPT CLEAR OF AIR PATH ONTO FANS/DUCTWORK.

DENOTES CEILING MOUNTED ACCESS PANELS PROVIDED BY BUILDER. THE MECHANICAL CONTRACTOR MUST PROVIDE THE REQUIRED INFORMATION i.e.: SIZE, TYPE, ETC., AND TO CO-ORDINATE WITH THE BUILDER AND ARCHITECT FOR FINAL LOCATIONS.

DENOTES DOOR RELIEF AIR GRILLES SUPPLIED BY MECHANICAL CONTRACTOR AND INSTALLED BY BUILDER.

DENOTES DOMESTIC TYPE KITCHEN RANGE HOOD PROVIDED BY BUILDER. MECHANICAL CONTRACTOR TO DUCT RANGE HOOD EXHAUST AIR TO ATMOSPHERE.

DENOTES WALL MOUNTED EXHAUST AIR FAN CONTROL SWITCH AND "NEON INDICATORS" ON ENGRAVED SWITCH PLATE KITCHEN FAN KEF1

CONTROLS ADJACENT EQUIPMENT TO WIRED TO SUIT

"FAN-ON - V.S.D. - FAN-OFF" NOTE: ALL KITCHEN EXHAUST AIR FANS 1000L/s AND OVER TO BE FURNISHED WITH VARIABLE SPEED DRIVES. ALL ROOM FAN

DENOTES INLINE FAN C/W N.R.D

ROOF MOUNTED EXHAUST COWL

DENOTES CEILING MOUNTED FAN WITH PLENUM BOX


DOORS TO BATHROOM, WATER CLOSET, ENSUITE, LAUNDRY,


ETC., UNDERCUT BY BUILDER. UPVC DRAIN LINE INSTALLED ON GRADE & SIZED TO SUIT

MANUFACTURERS REQUIREMENTS

REFRIGERATION LINES (LIQUID & GAS) INSULATED WITH ARMAFLEX _=:= PROVIDE UV PROTECTION WHERE EXPOSED TO WEATHER

TUNDISH/TERRACE OUTLET DRAIN POINT

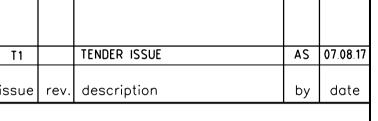

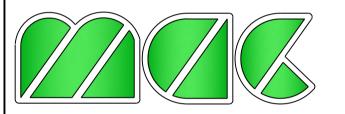

MacCORMACK ASSOCIATES CONSULTANTS Pty. Ltd

MECHANICAL, ELECTRICAL, HYDRAULIC AND FIRE SERVICES CONSULTING ENGINEERS AND PROJECT MANAGERS

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Contractors must verify all dimensions at the job before commencing any work or preparing shop drawings.

Contractors must locate all air registers pipework outlets, light fittings, power outlets, sprinkler heads, etc. from the Architects reflected ceiling plans and other detailed

Do not scale. All dimensions to be checked on site.

\$125 payable by this subcontractor

This drawing is available in electronic format at a cost of

project title

1 VINE STREET HEIDELBERG, VIC 3084

MECHANICAL SERVICES

EQUIPMENT SCHEDULES, LEGEND & DETAILS

drawing title

scale 0 0.5 1:100@A1	5 1 2 3 4m	
designed ASG	checked ASG	(
drawn AS/AV	date MAY 2017	
job number	1939	
issue	T1	
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8 of 8

