General Notes:

- *Do not scale drawings. Any conflicts or missing information should be brought to the attention of the builder and/or designer.
- *This project was designed in accordance with the 2018 IRC, 2017 NEC and the 2018 IECC.

Interior construction

Walls:

All angled walls are 45° U.N.O.

Provide min 1/2" gypsum board at all usable areas beneath stairs.

Doors:

Door connecting garage and house to be self closing

insulated, 20 minute fire rated, gasket and seal per local codes.

SRO (Sheet rock openings)

Refer to dimension sheets for all SRO widths.

All SRO heights to be 12" below specified ceiling.

Cabinets:

Kitchen and utility cabinets: *countertop @ 36"

B30=30" base cabinet

SB36=36" sink base cabinet

W3042=30" wide x 42" tall

Provide crown molding as specified @ Kitchen wall cabinets.

Provide blocking @ 54" O.C. & 96" O.C. @ all Kitchen wall cabinets.

Bathroom cabinets: *countertop @ 36".

VSB30=30" sink base cabinet

W3030=30" wide x 30" tall

Garage:

Provide 5/8" Type "X" gypsum board on ceiling and all common walls with

living areas. Slope floor, full width, rom rear wall to OHD, UNO.

Stairs: IRC311.5

Stair width shall be no less than 36".

All risers to be 7 3/4" max. and may not vary more than 3/8" in height.

All treads to be no less than 10"

Handrail shall be provided on at least one side of each continuous run of treads

or flight with four or more risers at no less than 34" or more than 38" FFF.

Exterior construction:

Siding veneer:

All siding to be fiber cement siding or approved equal. Horizontal lap siding to have maximum 7" exposure.

Gutters & Downspouts:

Provide gutters as specified, where indicated; field locate downspouts as needed, with discharge 2 minimum of 3'-0" from foundation.

Exterior doors & windows:

Install "Z" flashing over all exterior horizontal trim, doors and windows.

Address numbers:

Mount address numbers under & centered on the coach light.

Soffits:

Soffit at all gables to be 12".

Soffit at all hips to be 12".

Floor Areas - Elevation D		
Name Area		
_iving	1965 SF	
Garage	434 SF	
Covered Patio	96 SF	
Covered Porch	52 SF	
Total Covered	2547 SF	

Frame Areas - Elevation D			
Name	Area		
Standard	2547 SF		

Sheet Index - Elevation D					
Sheet Number	Description				
bOA	Cover CONDITION CRAWLSPACE	W			
A1d	Crawis Vace OPPaRETARDER ON GR	Οl			
A2d	Main Leve ONO DEPLANTERIOR VENT				
A3d	Main Leveston Plan				
A4d	Exterior Elevations				
A5d	Exterior Elevations				
A6d	Roof Plan				
A7d	Section				
A8	Interior Elevations				
А9	Interior Elevations				
E1d	Main Level Electrical Plan				
S-01	Foundation Plan				
S-02	Foundation Details				
S-03	Main Level Floor Framing				
S-04d	Roof Framing				
S-05	Roof Truss Details				
S-06	Main Level Shear Wall				
S-07	Shear Wall Notes				
DT1	Standard Details				
DT2	Standard Details				
DT3	Standard Details				
DT4	Standard Details				
DT5	Standard Details				
DT6	Standard Details				
DT7	Standard Details				
DT8	Standard Details				
DT9	Standard Details				

Standard Details

DT10

Revision Schedule

Mailinei	Date	Description
H 1	04-04-2019	Developed new plan for LGI-Colorado per Complete Home Plus criteria
D OR	05-28-2019	Developed D Elevation
ON	07-19-2019	Removed all engineering & specification call outs from the plans; changed call-out @ Porch columns to 6x6 Post; reduced countertop overhang to 10" @ Kitchen island; changed all shelving @ Master WIC to be continuous rod & shelf; replaced address plate w/ address numbers; increased mirror heights to 42"; replaced USB outlet @ Master Bedroom with standard duplex outlet; added GFCI resets for interior & exterior GFI outlets
7	07-22-2019	Added all "hidden" elevations
8	07-29-2019	Replaced existing 2-3050 SH window @ Family w/ 6050 HS



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Elevation D Pike SOR

Sheet Number A0d



7/30/2019

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The Pike · SOR · 1965 D

Sample Callout

Abbreviations A/H

- Air Handler

- Above Carpet

- Ceilina

Clg Conc - Concrete

CR&S - Continuous Rod & Shelf

CW Cold Water - Clothes Drver

Dia Diameter

Dis Disappearing

Disp - Disposal

Dn - Down

DW Dishwashe EQ

- Equal FD - Floor Drain

- From Finished Floor FFF

GWB - Gypsum Wall Board

HB Hose Bib

- Hard Surface HS

HW - Hot Water Max Maximum

ОН

WH

OHD

Min - Minimum MW Microwave Oven

Overhang

- Overhead Doo

Opp Opposite - Powder Pwdr

RAG - Return Air Grille

R&S - Rod and Shelf Ref Sp - Refrigerator Space

SGD - Sliding Glass Door

Shlvs - Shelves Slope

SRA - Sheet Rock Arch

SRO - Sheet Rock Opening

- Tile T&G

- Tongue and Groove

- Typical

- Utility

Typ Util · Clothes Washer

- Water Heater


- Wood - Walk In Closet

- Water Resistant Barrier

CRAWLSPACE GENERAL NOTES: 1. Crawlspace is conditioned space; provide: a. Vapor barrier as specified. b. Wall insulation as specified. c. RE: Mechanical Plans for supply air. 2. Sump basin located per CM. 3. RE: Structural Plans for additional information. Trail Elizabeth Colorado 80107 844.691.7300 70' - 0" 68' - 6" GFI 60' - 6" Sump_ basin 12' - 0" Unexcavated Keyless Pipe column, typ لى Re: Structural Elevation D SOR • 1965 **The Pike** Unexcavated A7d īo Conditioned Crawlspace 40' 9' - 0" 9' - 10" 28' - 0" . لبي 16 - 6" masonry ope **Unexcavated** 10' - 10" 18' - 0" 10' - 10" To switch above Clg [22"x30"] Access ∟Panel_ £ 3' - 0" **Sheet Number** A1d Ufer 39' - 8" 22' - 4" 62' - 0" 7-12-18 70' - 0" Date 7/30/2019 **Crawlspace Plan** 8:28:27 PM 3/16" = 1'-0"

Window Schedule - Elevation D				
Mark	Width	Height	Description	Head Height
A	36"	60"	Single Hung	7' - 0"
В	48"	60"	Single Hung	7' - 0"
С	72"	60"	Horizontal Slider	7' - 0"
D	60"	80"	Exterior Entry, 2-Panel SGD	6' - 8"

Morte Width Unight Boorinties Com					
Mark Width Height			Description	Swing	
1	24"	80"	Interior Flush	Left	
2	24"	80"	Interior Flush	Right	
3	28"	80"	Interior Flush	Right	
4	30"	80"	Interior Flush	Left	
5	30"	80"	Interior Flush	Right	
6	32"	80"	Interior Flush	Right	
7	32"	80"	Solid Core Flush, Self-closing	Left	
8	36"	80"	Exterior Entry, 3/4 Lt, Temp	Left	
9	60"	80"	Interior Bypass	N/A	
10	60"	80"	Interior Double Flush	N/A	
11	192"	84"	Sectional OHD	N/A	

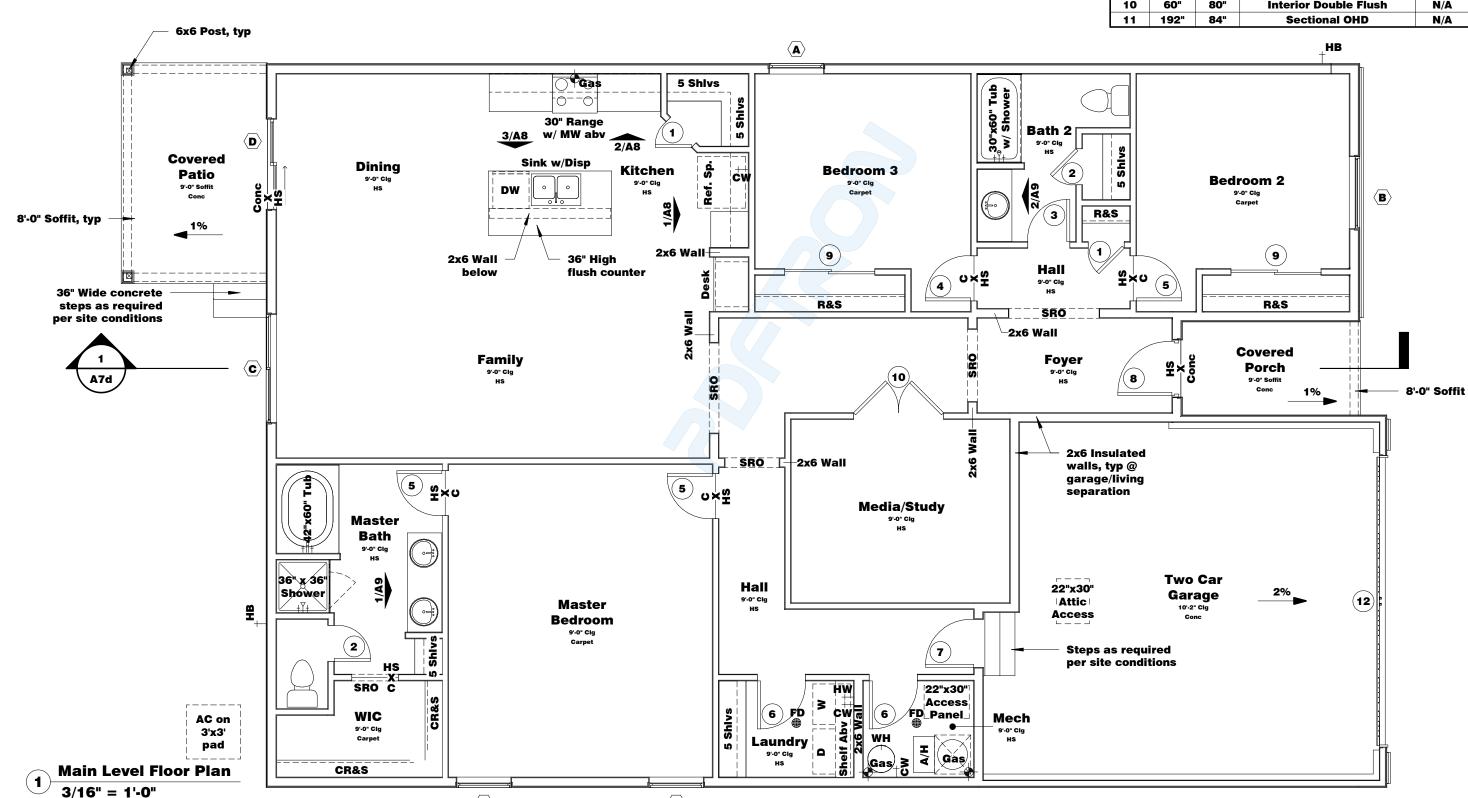



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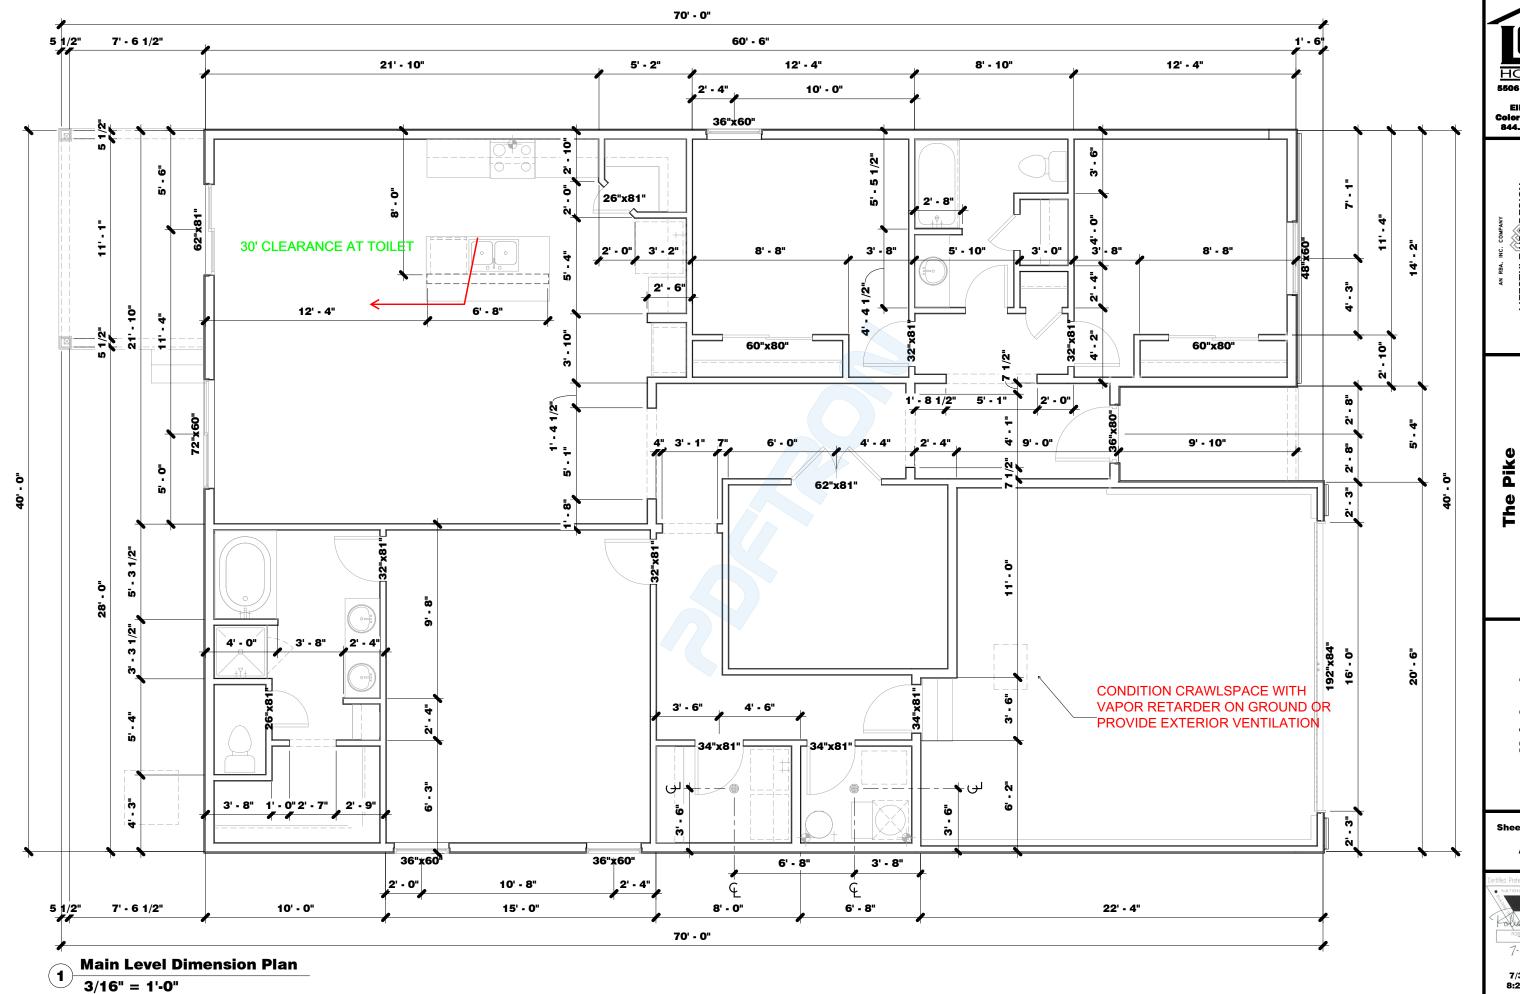
The Pike Elevation D SOR • 1965

Main Level Floor Plan

Sheet Number



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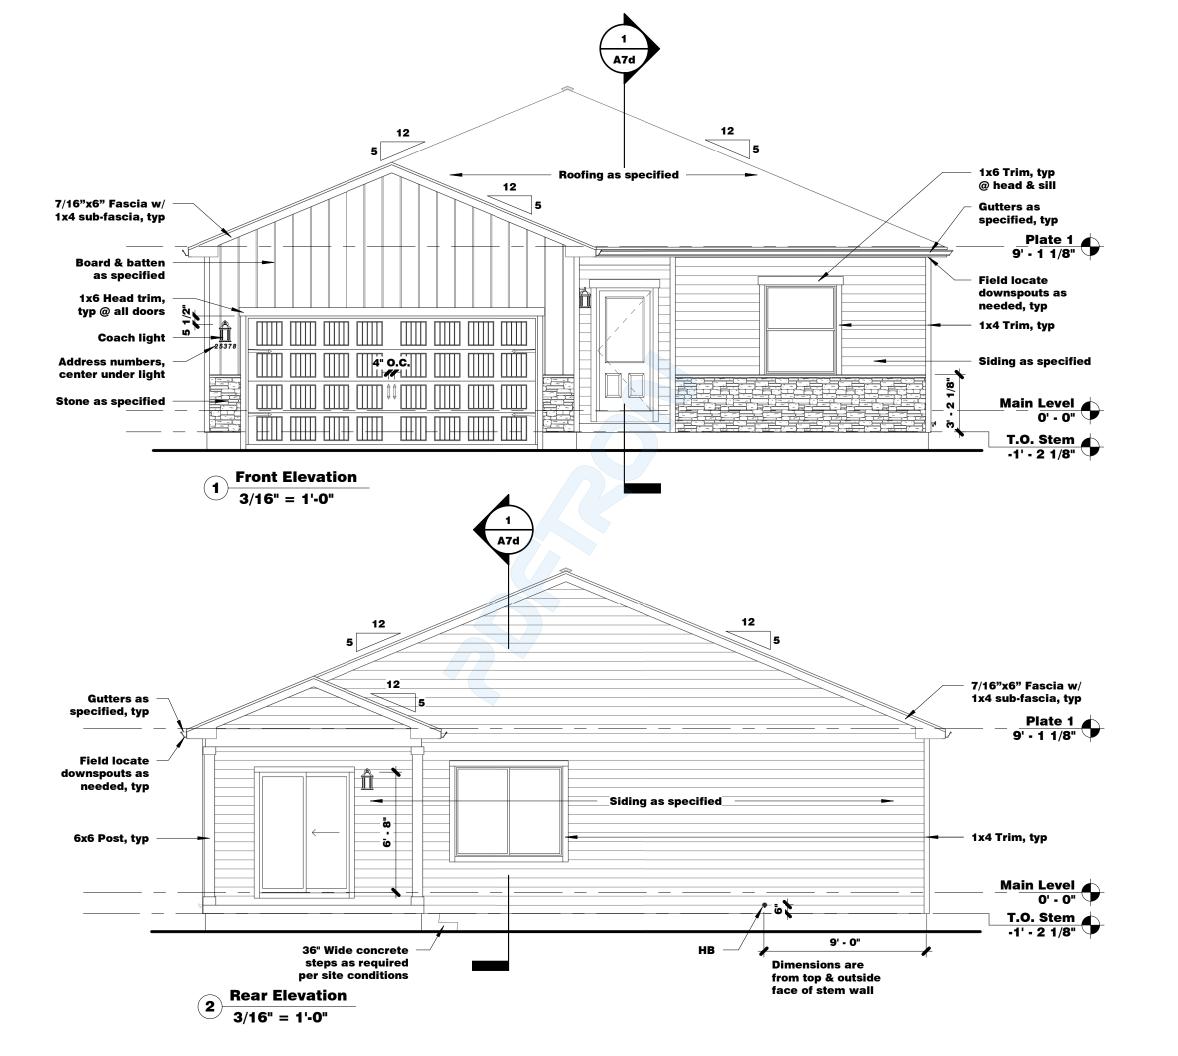
Elevation D SOR • 1965

Main Level Dimension Plan

Sheet Number A3d



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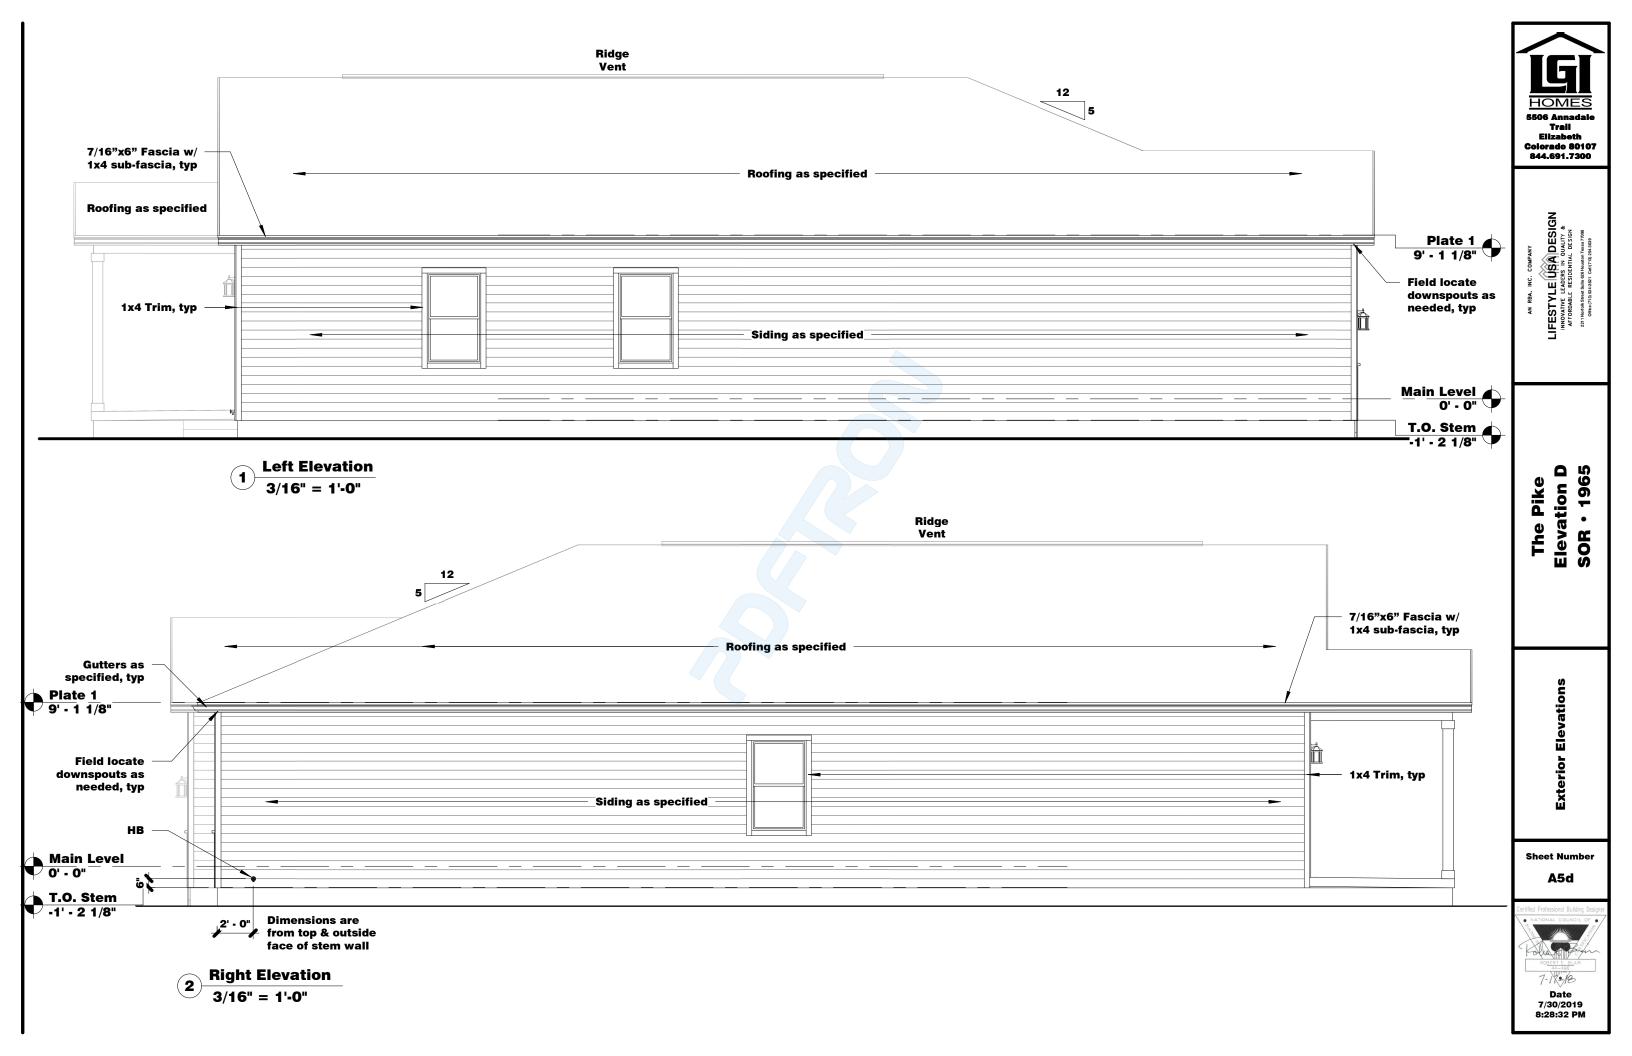
The Pike Elevation D SOR • 1965

Exterior Elevations

Sheet Number




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Roof Ventilation Calculations - Elevation D				
Named Attic Spaces	Attic Area	Ratio Used	Required Net Free Ventilation Area	
Attic 1	2546.750 SF	1/300	8.49 SF	

Ventilation Type by Named Attic Space	Count	Net Free Ventilation Provided	Percent of Required Net Free Ventilation
Attic 1	40		
Lamanco Vents-C816	13	5.86 SF	69.06%
Total Intake Provided		5.86 SF	69.06%
	1	3.75 SF	44.17%
Ridge Vent			
Ridge Vent Total Exhaust Provided	i	3.75 SF	44.17%



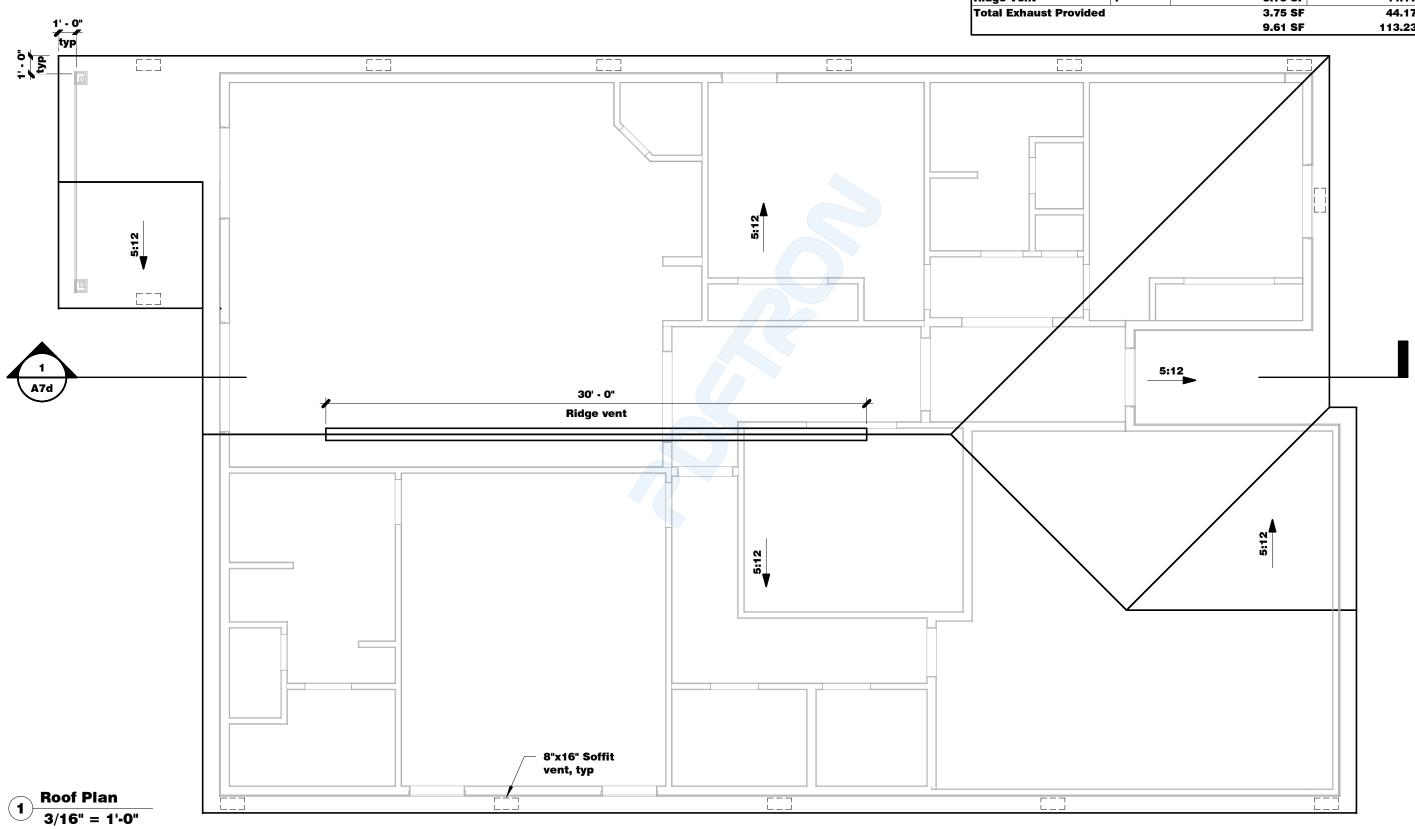


The Pike Elevation D SOR • 1965

Roof Plan


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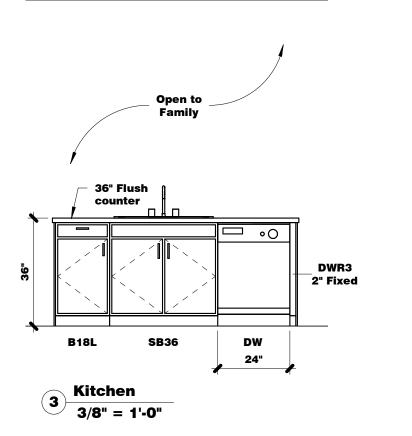



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The Pike


Interior Elevations

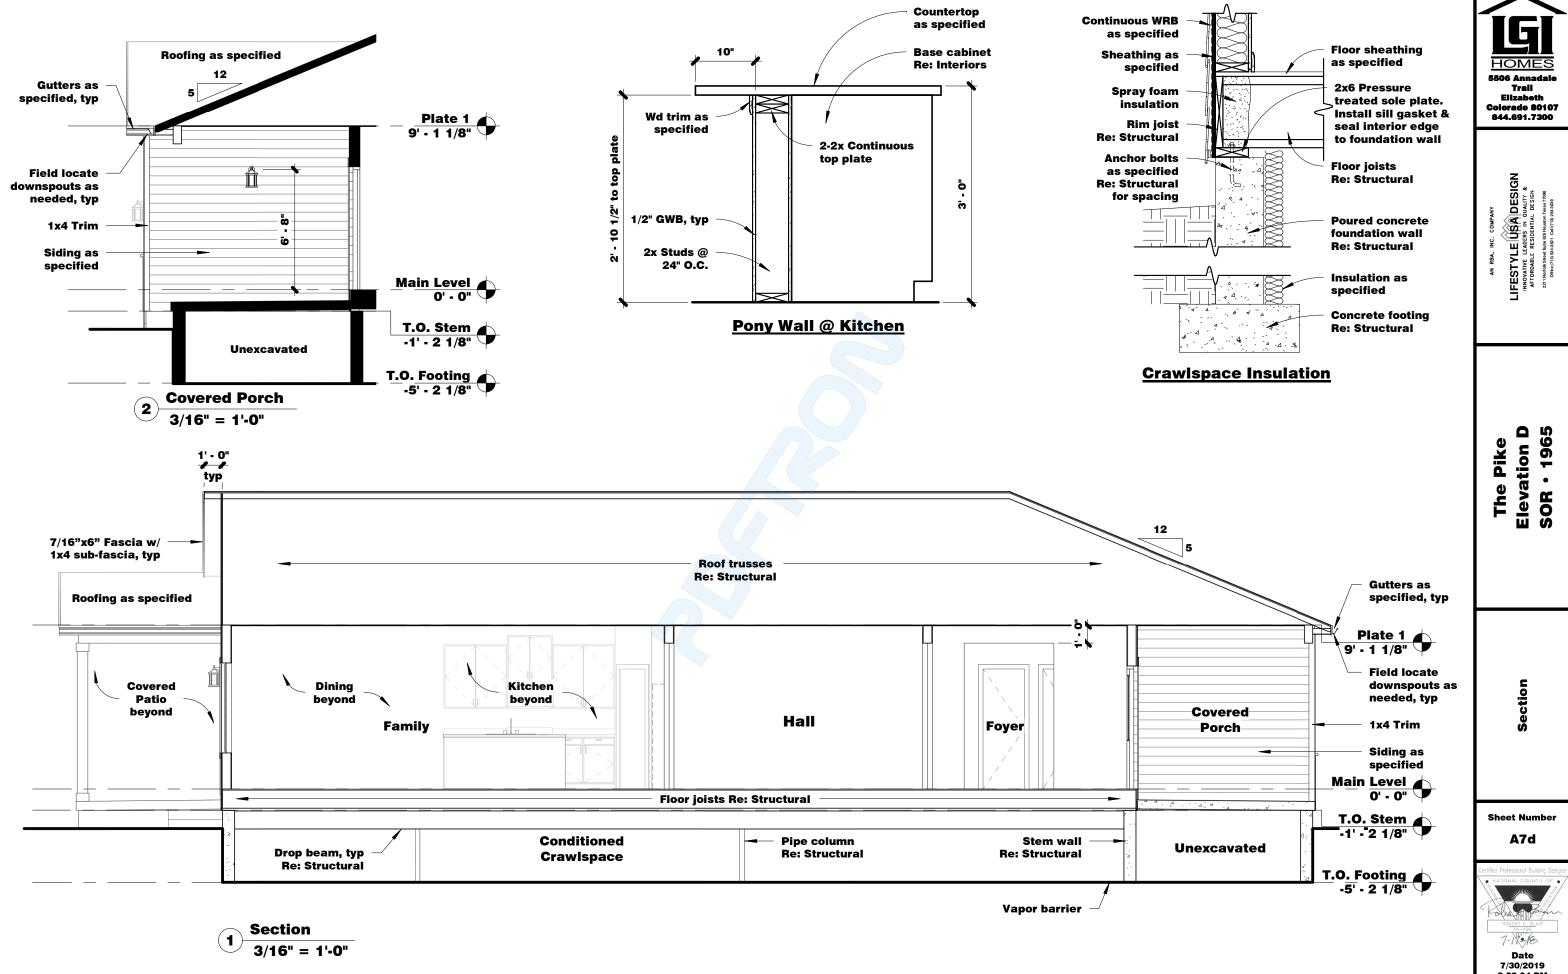
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A8

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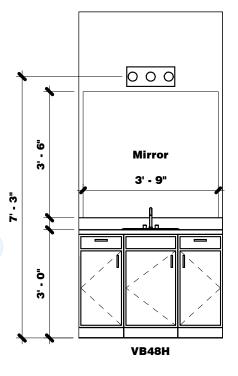
Provide blocking @ 54" O.C. & 96" O.C. @ all Kitchen wall cabinets.

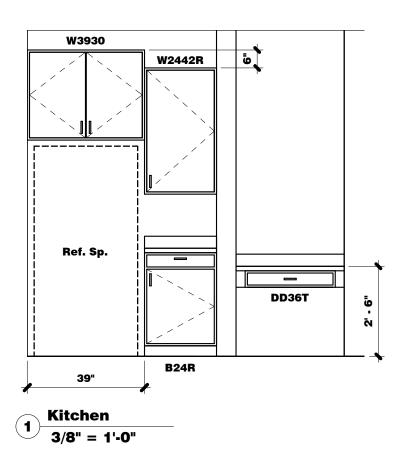


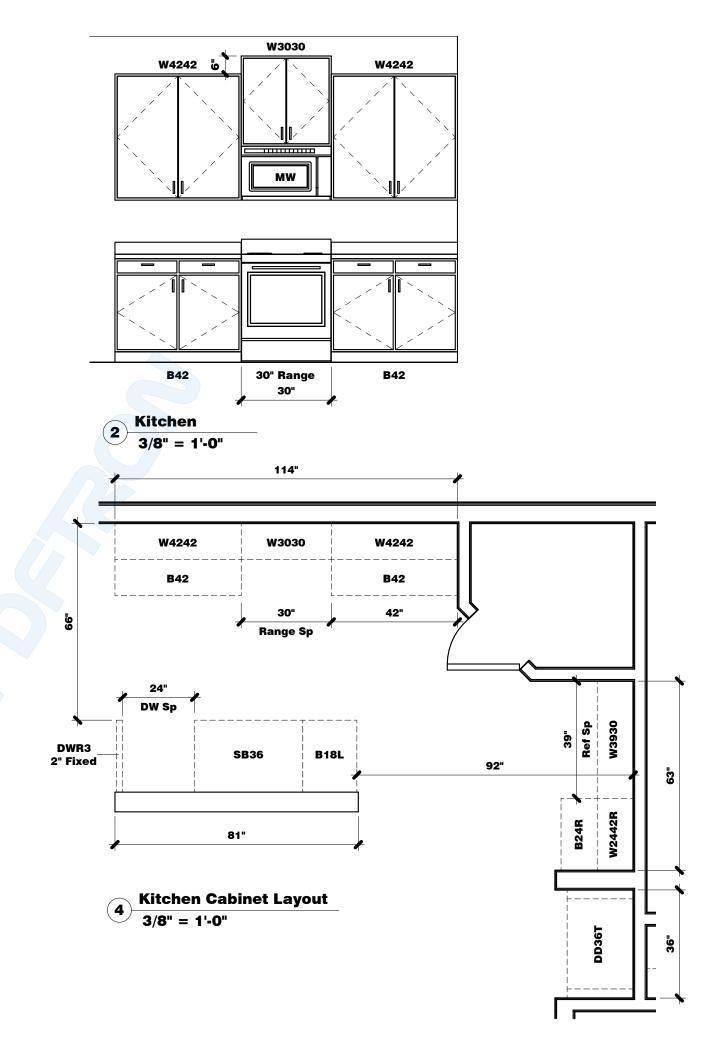

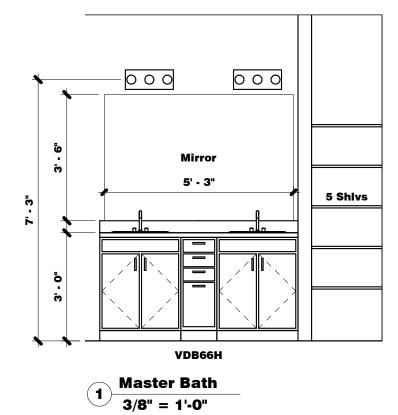Master Bath Cabinet Layout

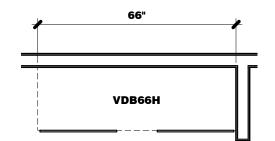3/8" = 1'-0"



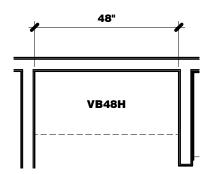


Bath 2 Cabinet Layout3/8" = 1'-0"

Α9



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Wall Mount Stair Light

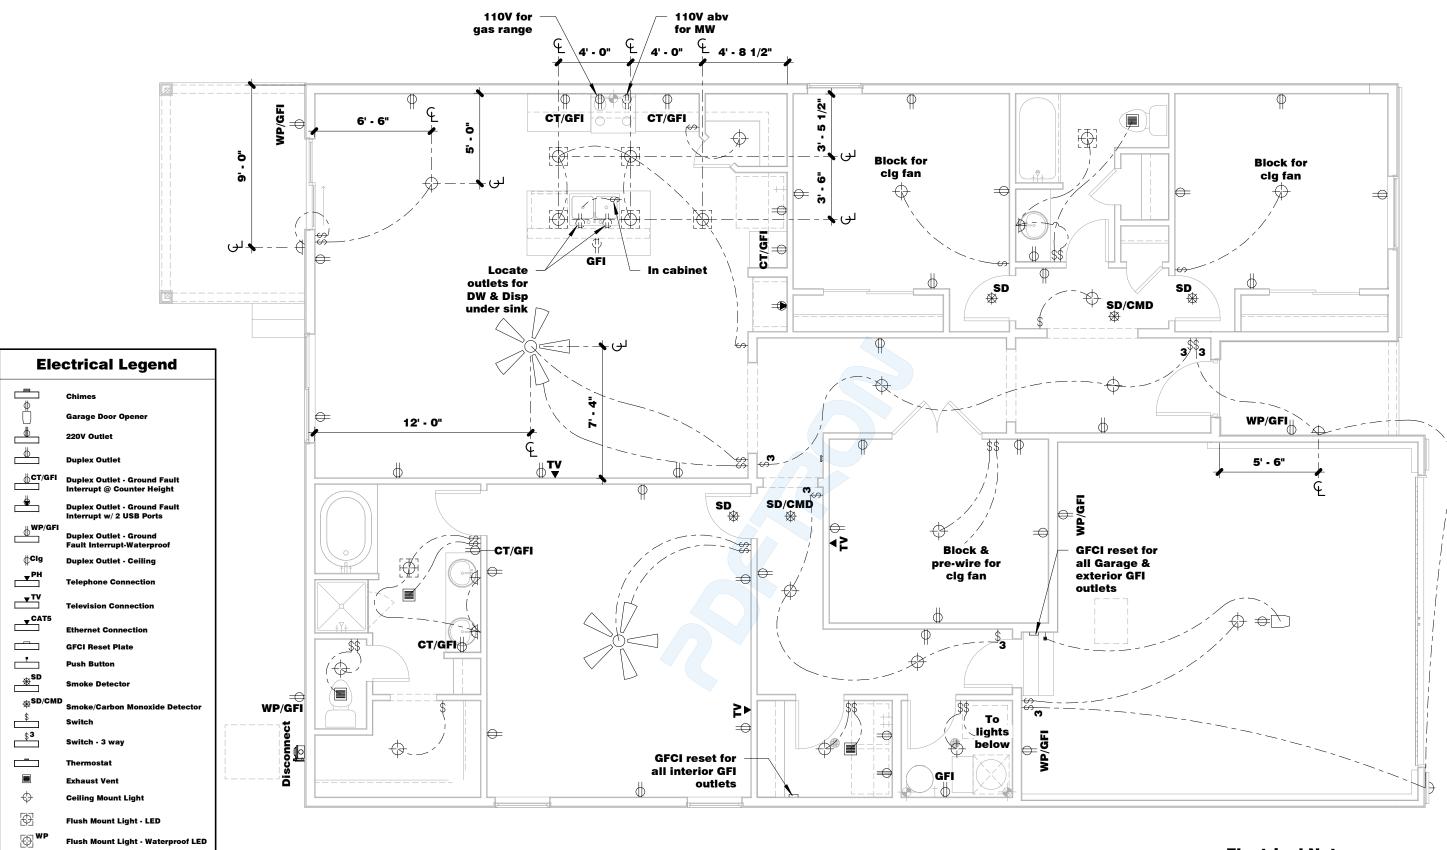Fluor Light - Wall Mount

Fluor Light - Ceiling Mount Fixture

Main Level Electrical Plan

3/16" = 1'-0"

Wall Mount Light

4

Electrical Notes:

- Exterior plugs to be 24" from bottom of siding.
 All closet lights to be 30" from wall with shelf.
 Center all light strips 87" FFF UNO.

- 4. Center all receptacles 14" FFF UNO.
- 5. Center all switches 54" FFF UNO.6. All dimensions from stud face to center of fixture.
- 7. Provide AFCI protection on all branch circuits as required per all applicable codes.

 8. Mount T-Stat @ 60" FFF.
- 9. Provide disconnect within 4' of A/C condenser. 10. Provide keyless pull chain light in attic.
- 11. Mount Porch light @ 80" FFF.
- 12. Mount Garage coach light 5 1/2" below OHD header.
- 13. All smoke detectors to be installed a min of 36" from any supply or return air grille.

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Elevation D SOR • 1965 **The Pike**


Level Electrical Plan

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Standard Details

Wall Sections



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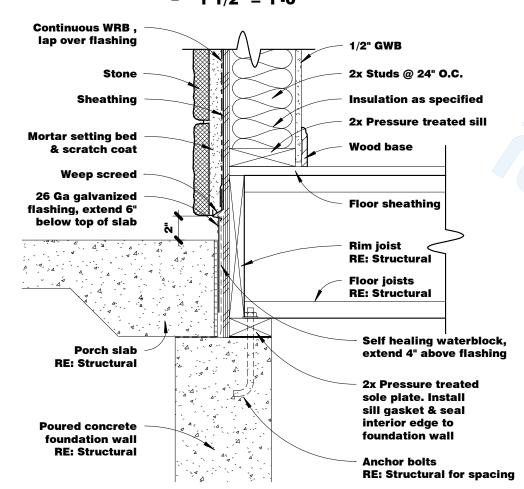
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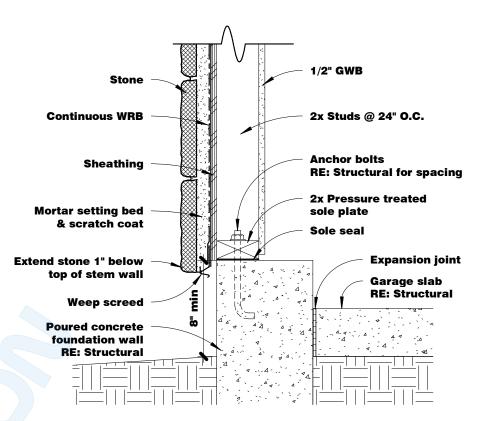
Sole Details @ Siding

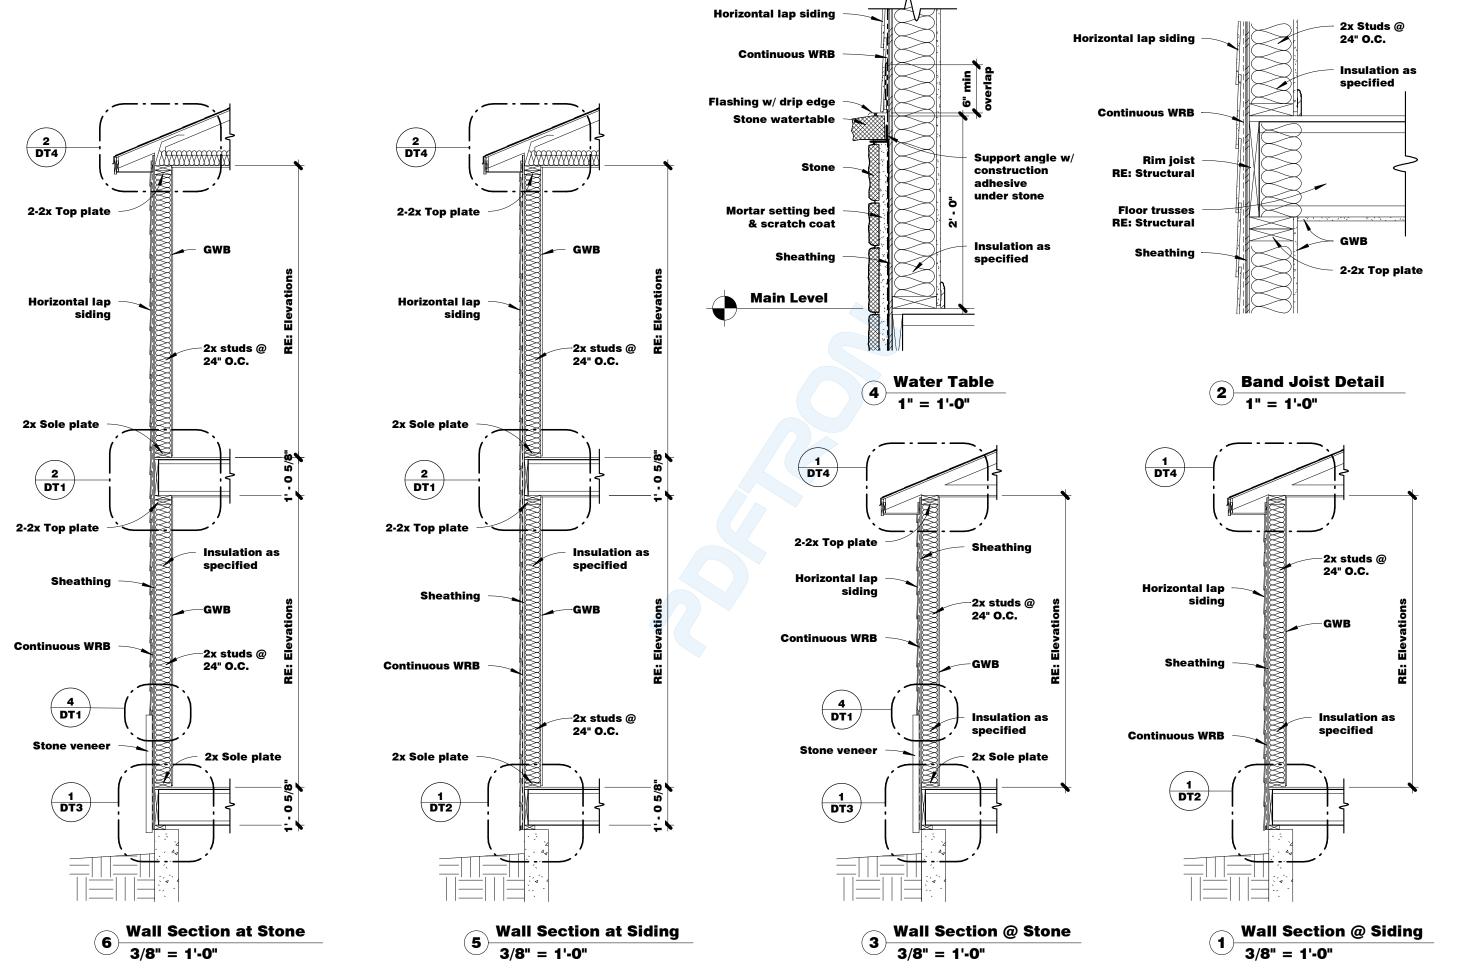


Stone @ Garage/Porch



Stone @ Porch Slab 1 1/2" = 1'-0"



Stone @ Garage Wall 1 1/2" = 1'-0"

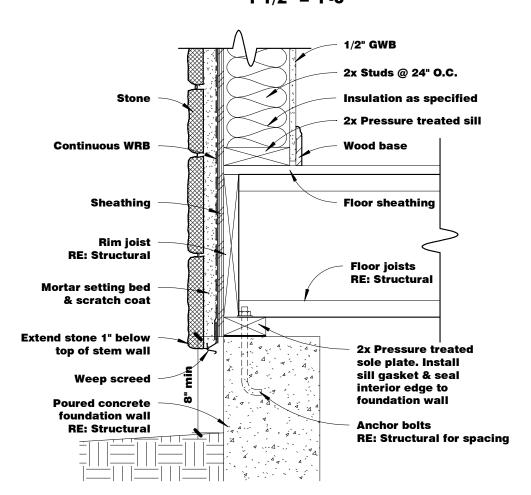

Stone @ Foundation Wall
1 1/2" = 1'-0"




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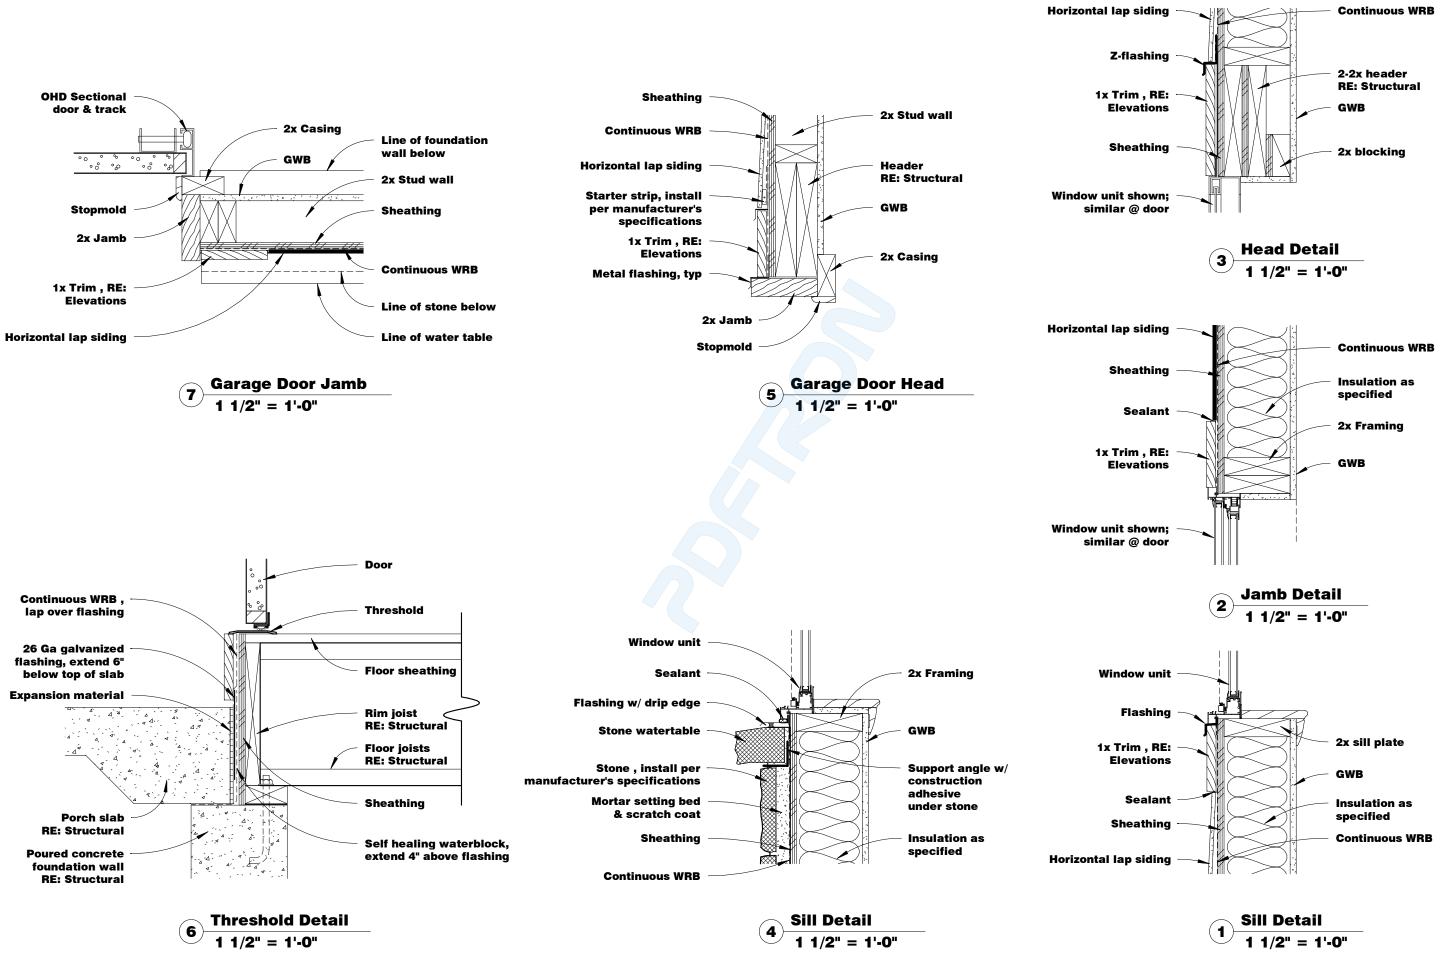
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Standard Details

Exterior Details





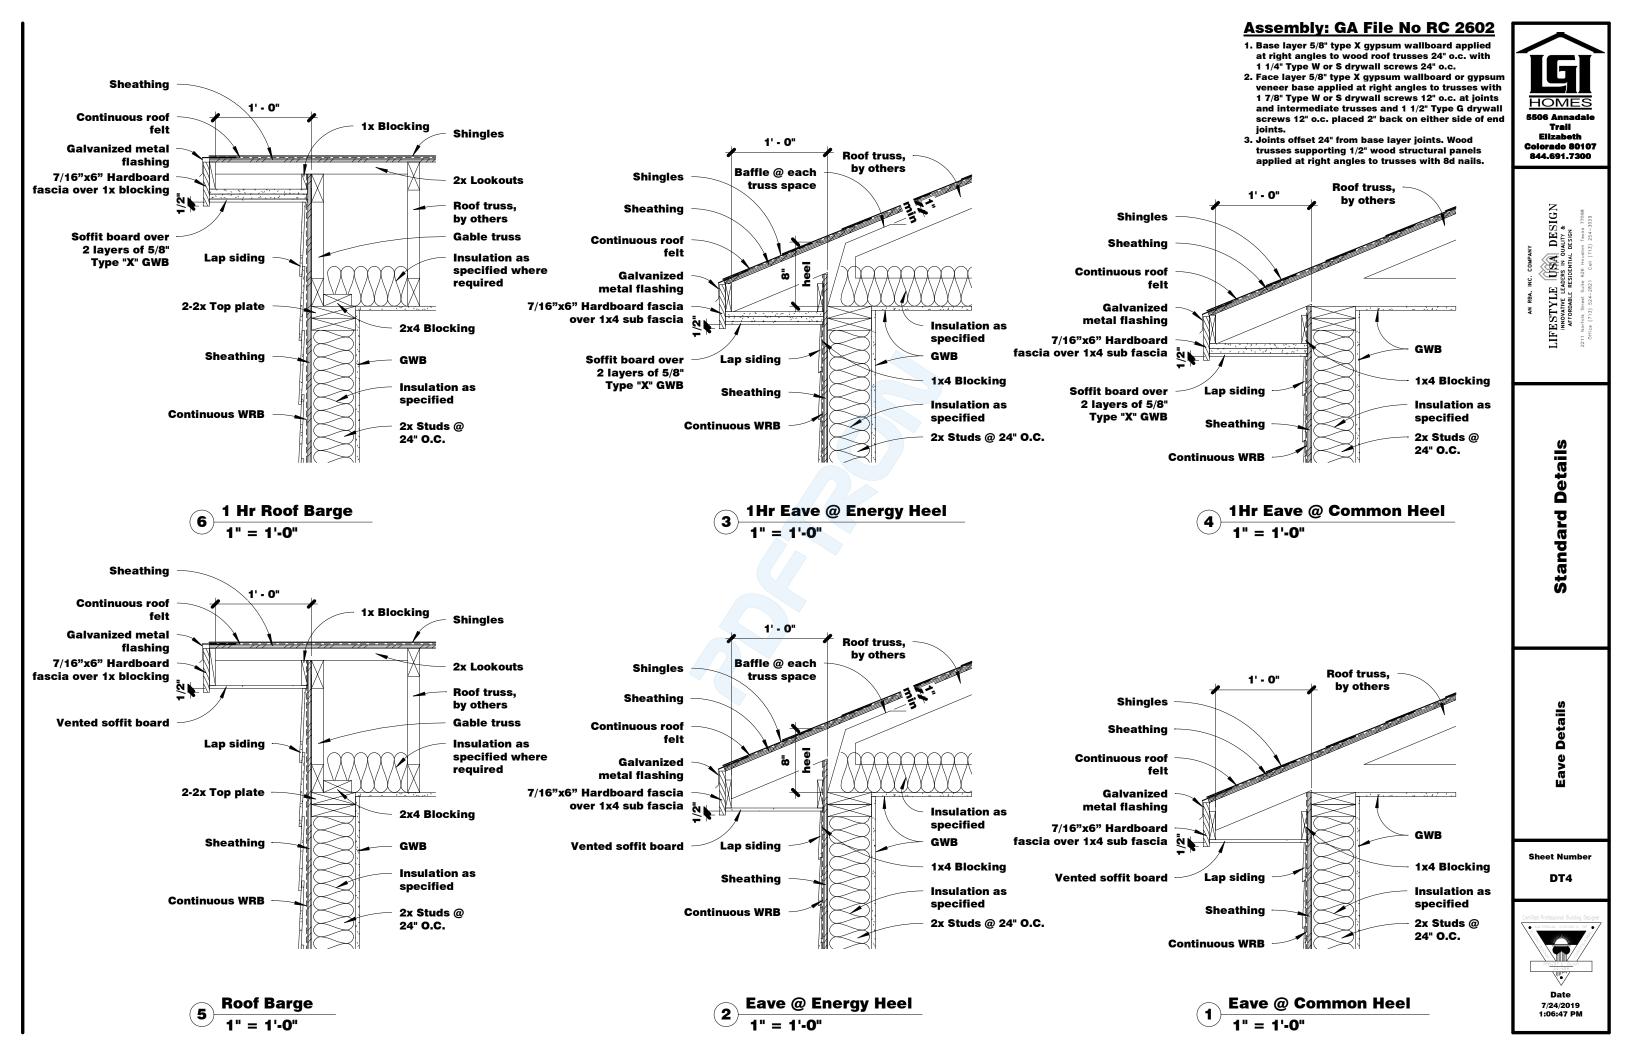



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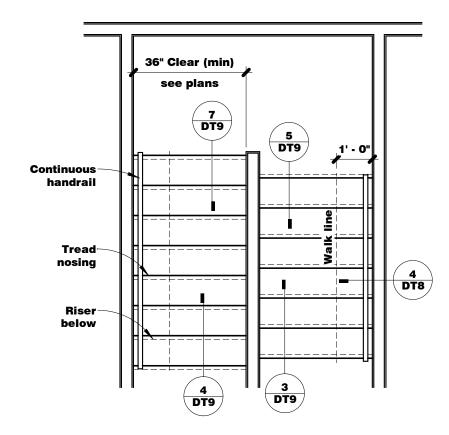
Door & Window Details








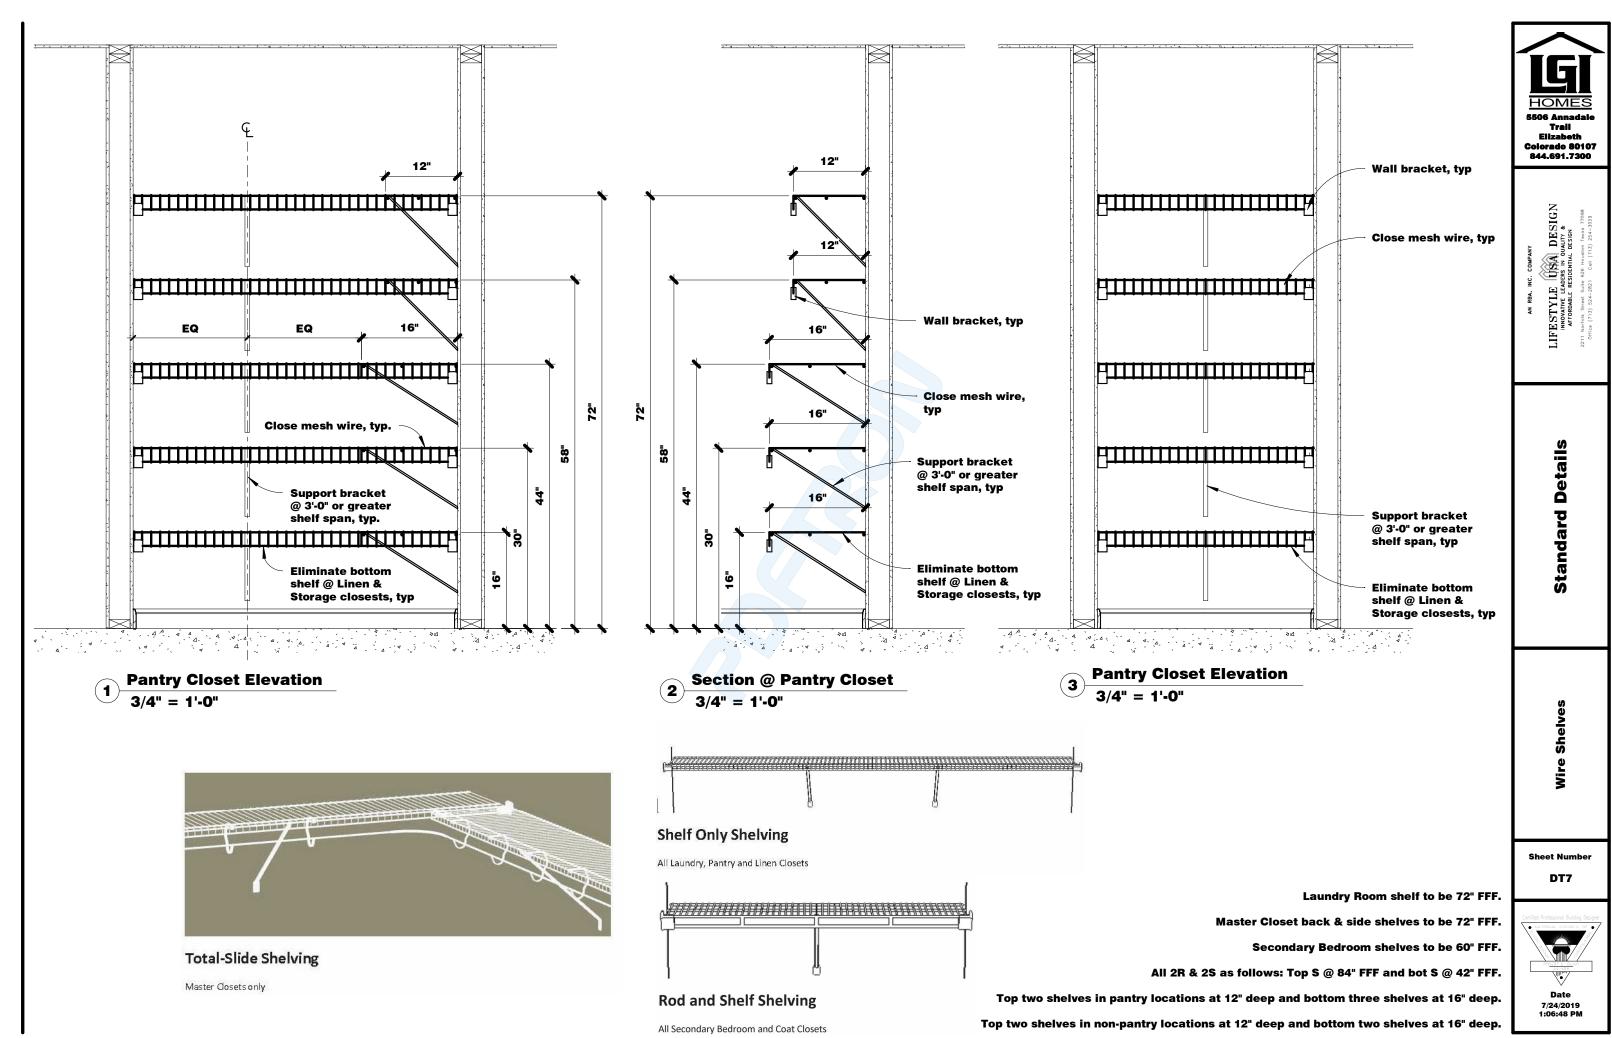


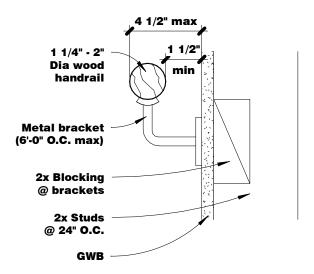

3 U-Shaped Plan 3/8" = 1'-0"

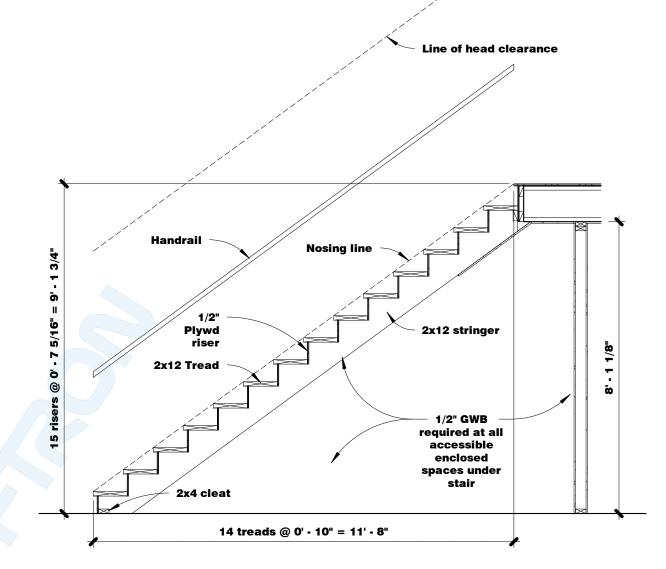



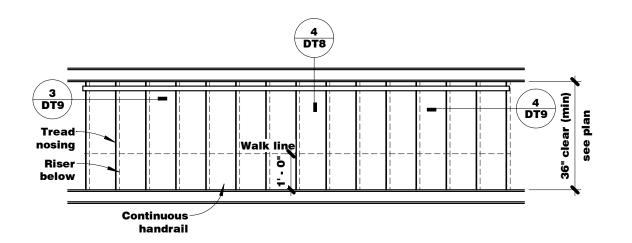




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OFFICE (713) 524-2821 C GHI (713) 524-5039

Standard Details

Stair Details



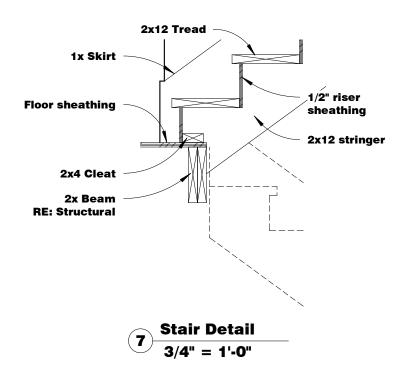


Floor sheathing


1x Skirt


2x12 Tread


1/2" riser

sheathing

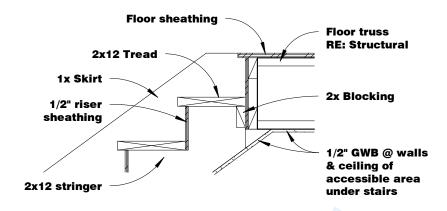


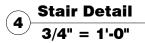

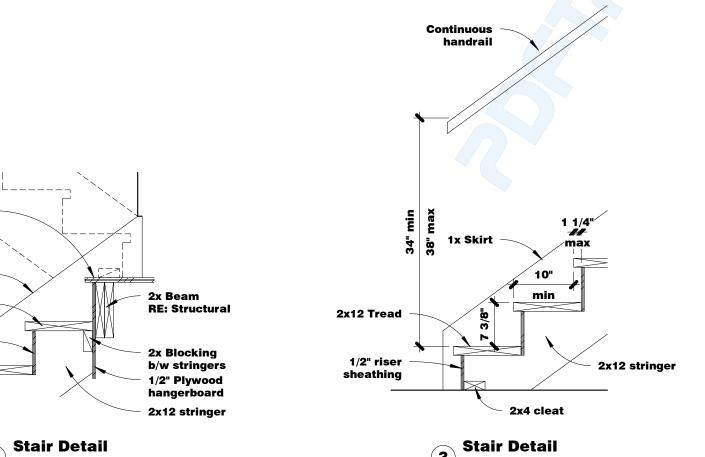

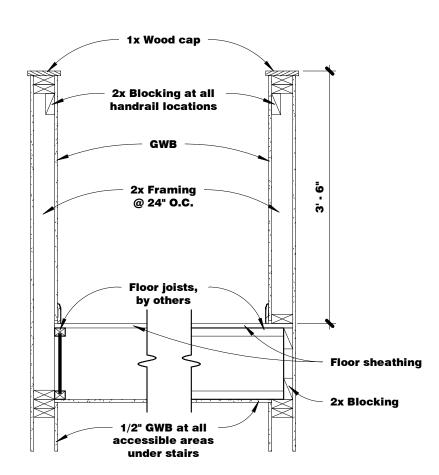



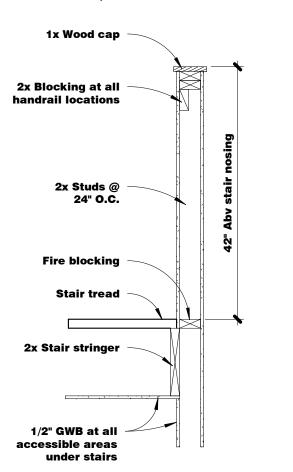





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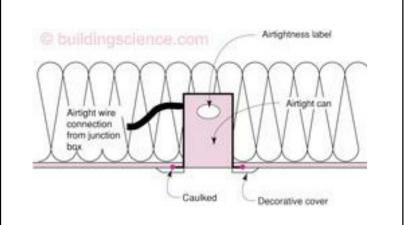
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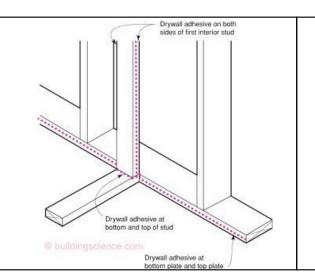
Office (713) 524-2821 Cell (713) 254-3039


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Stair Details









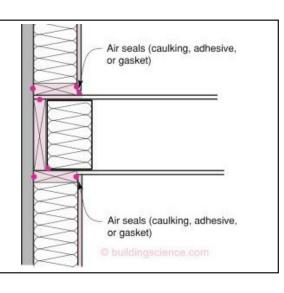

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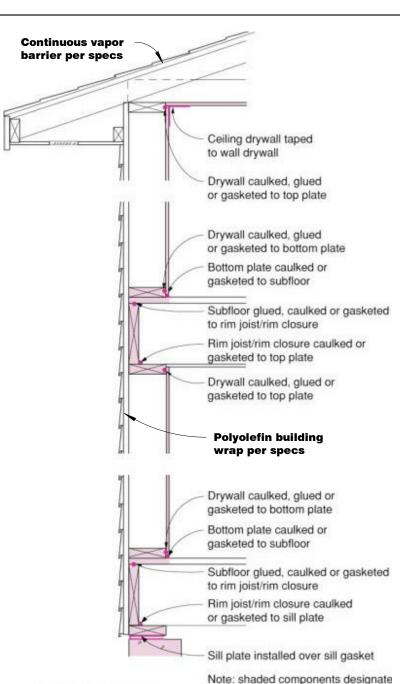
Standard Details

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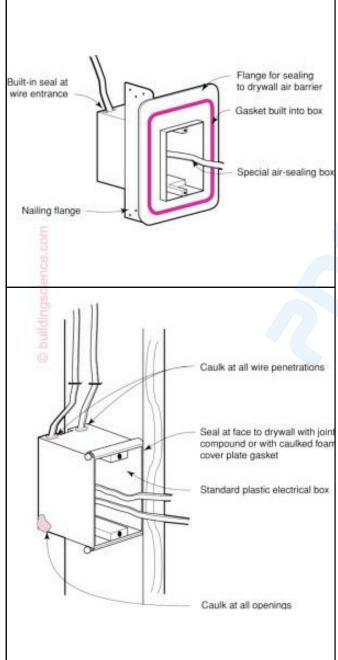
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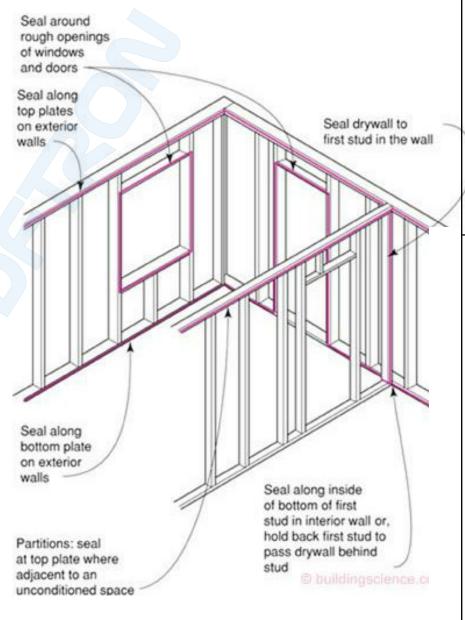
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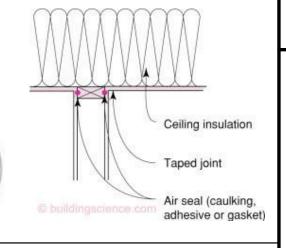




air barrier system







Air Barriers—Airtight Drywall Approach

Gypsum board drywall is, itself, a suitable air barrier material. The taping of drywall seams results in a plane of airtightness at the field of the wall. However, several steps must be taken to use this material property to create a continuous and complete air barrier system. To do this, it is important to create air barrier continuity at the perimeter of drywall assemblies, at all penetrations through the drywall, and, finally, in areas of the enclosure without interior drywall.

Drywall Assembly Perimeter

Air barrier continuity at the perimeter of drywall assemblies is achieved by sealing the edges of the drywall to solid framing materials. This requires a continuous bead of sealant along:

- · all exterior wall bottom and top plates,
- all top plates at insulated ceilings,
- · rough opening perimeters, and
- both sides of the first interior stud of partition walls.

The air seal at the partition wall intersection is shown in greater detail below.