




Lake Whakata Holiday Home

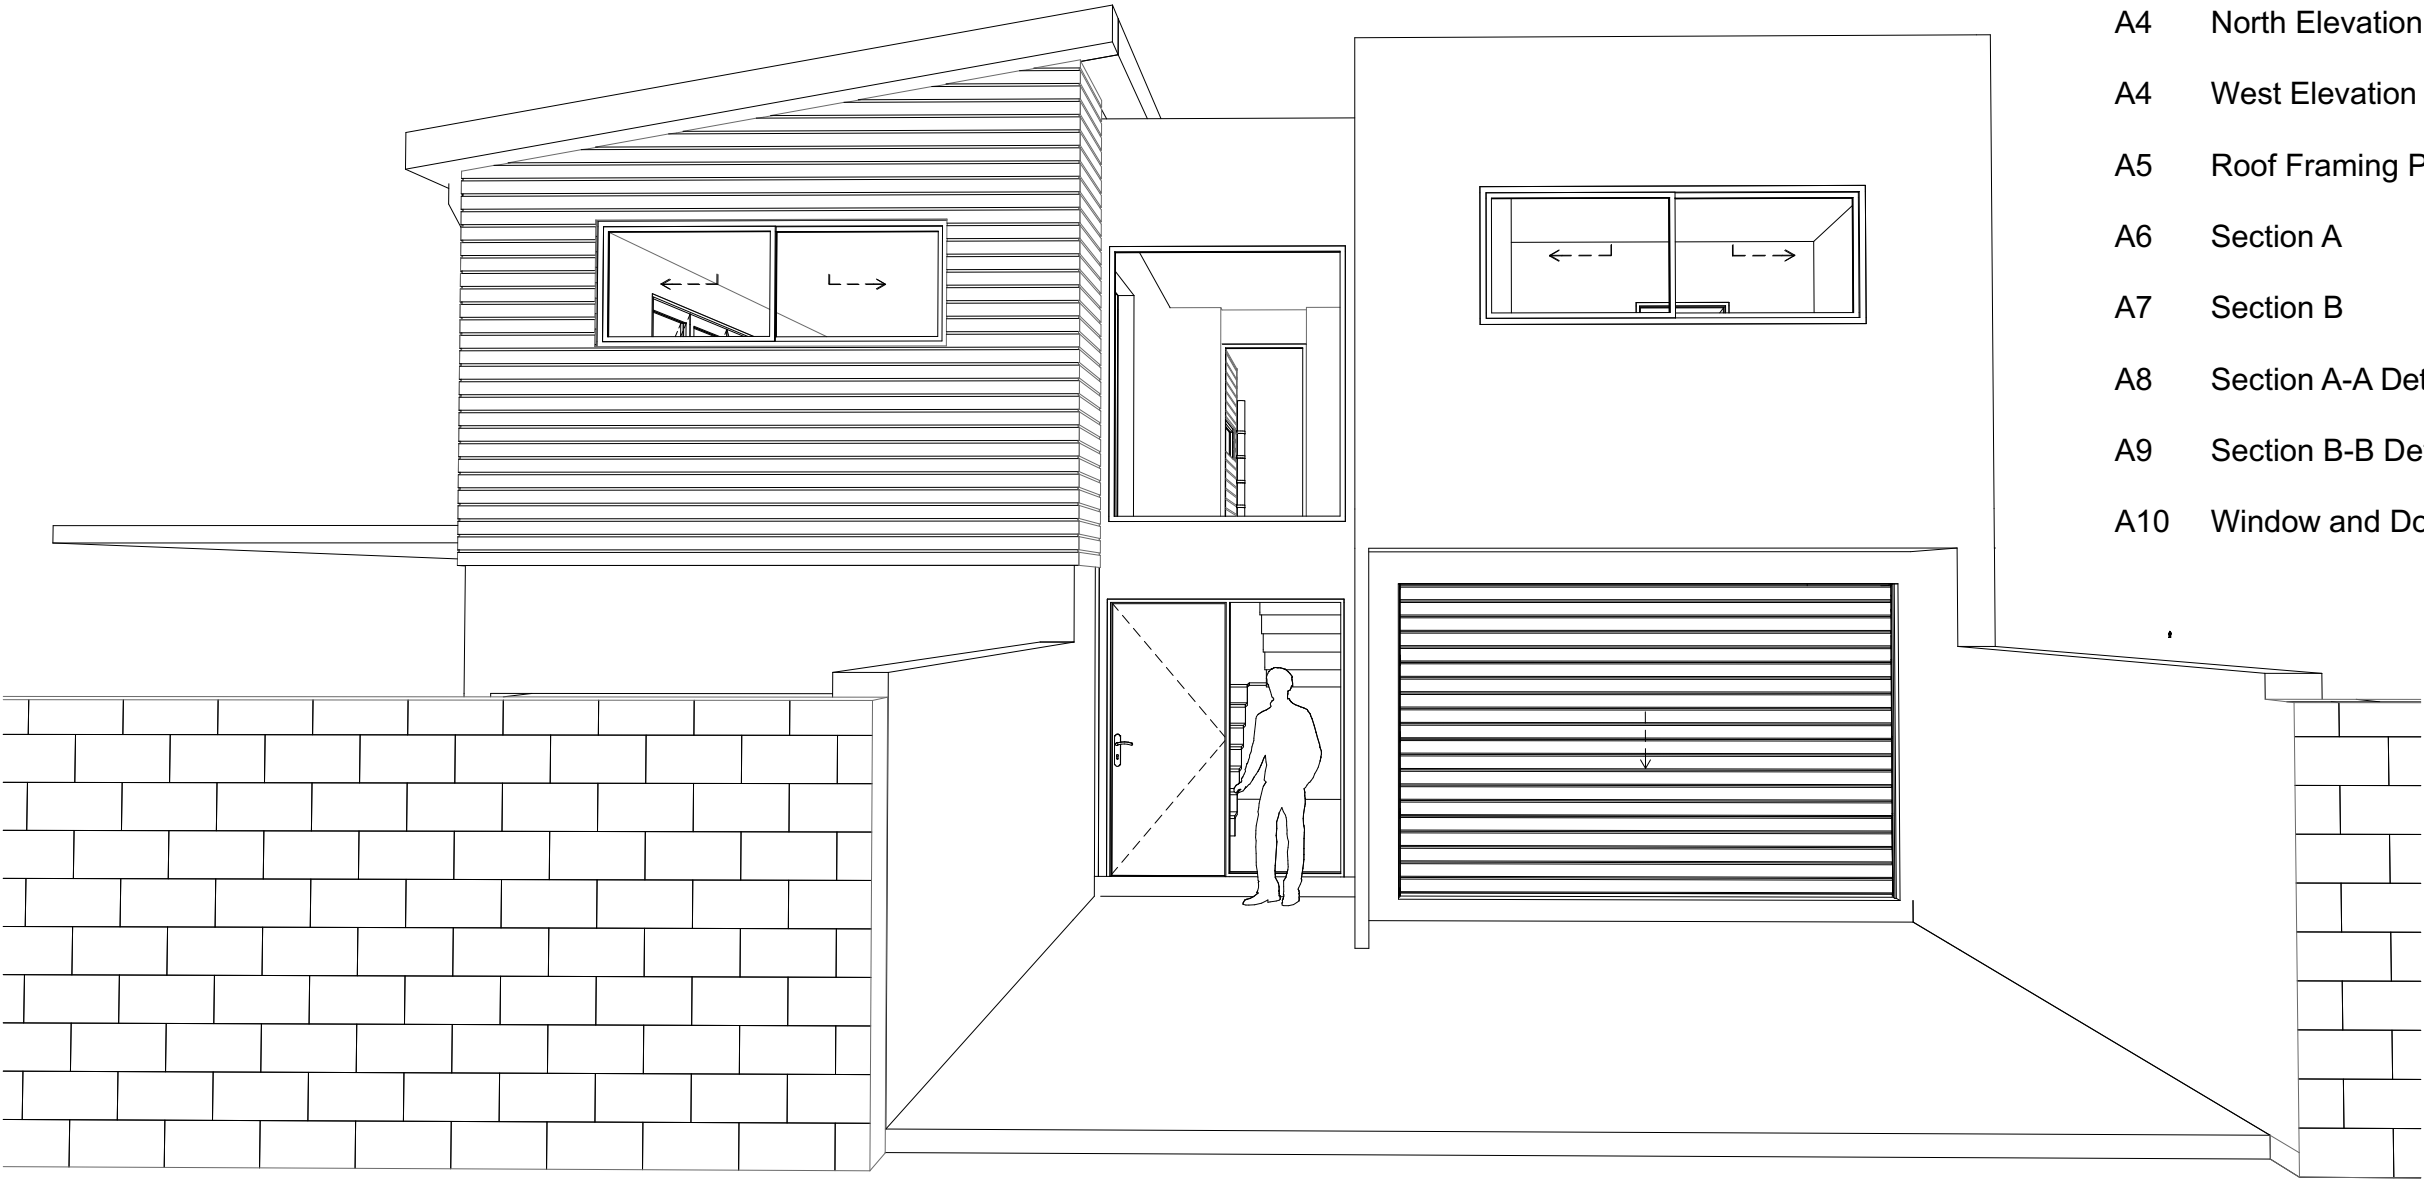


A1	Site Plan	1:100
A2	Ground Floor Plan	1:100
A3	First Floor Plan	1:100
A4	North Elevation	1:100
A4	West Elevation	1:100
A5	Roof Framing Plan	1:100
A6	Section A	1:50
A7	Section B	1:50
A8	Section A-A Details (1, 2 & 3)	1:5, 1:10
A9	Section B-B Details (4, 5 & 6)	1:10, 1:5
A10	Window and Door Schedule	1:50

Drawn by: Hazel de Paz

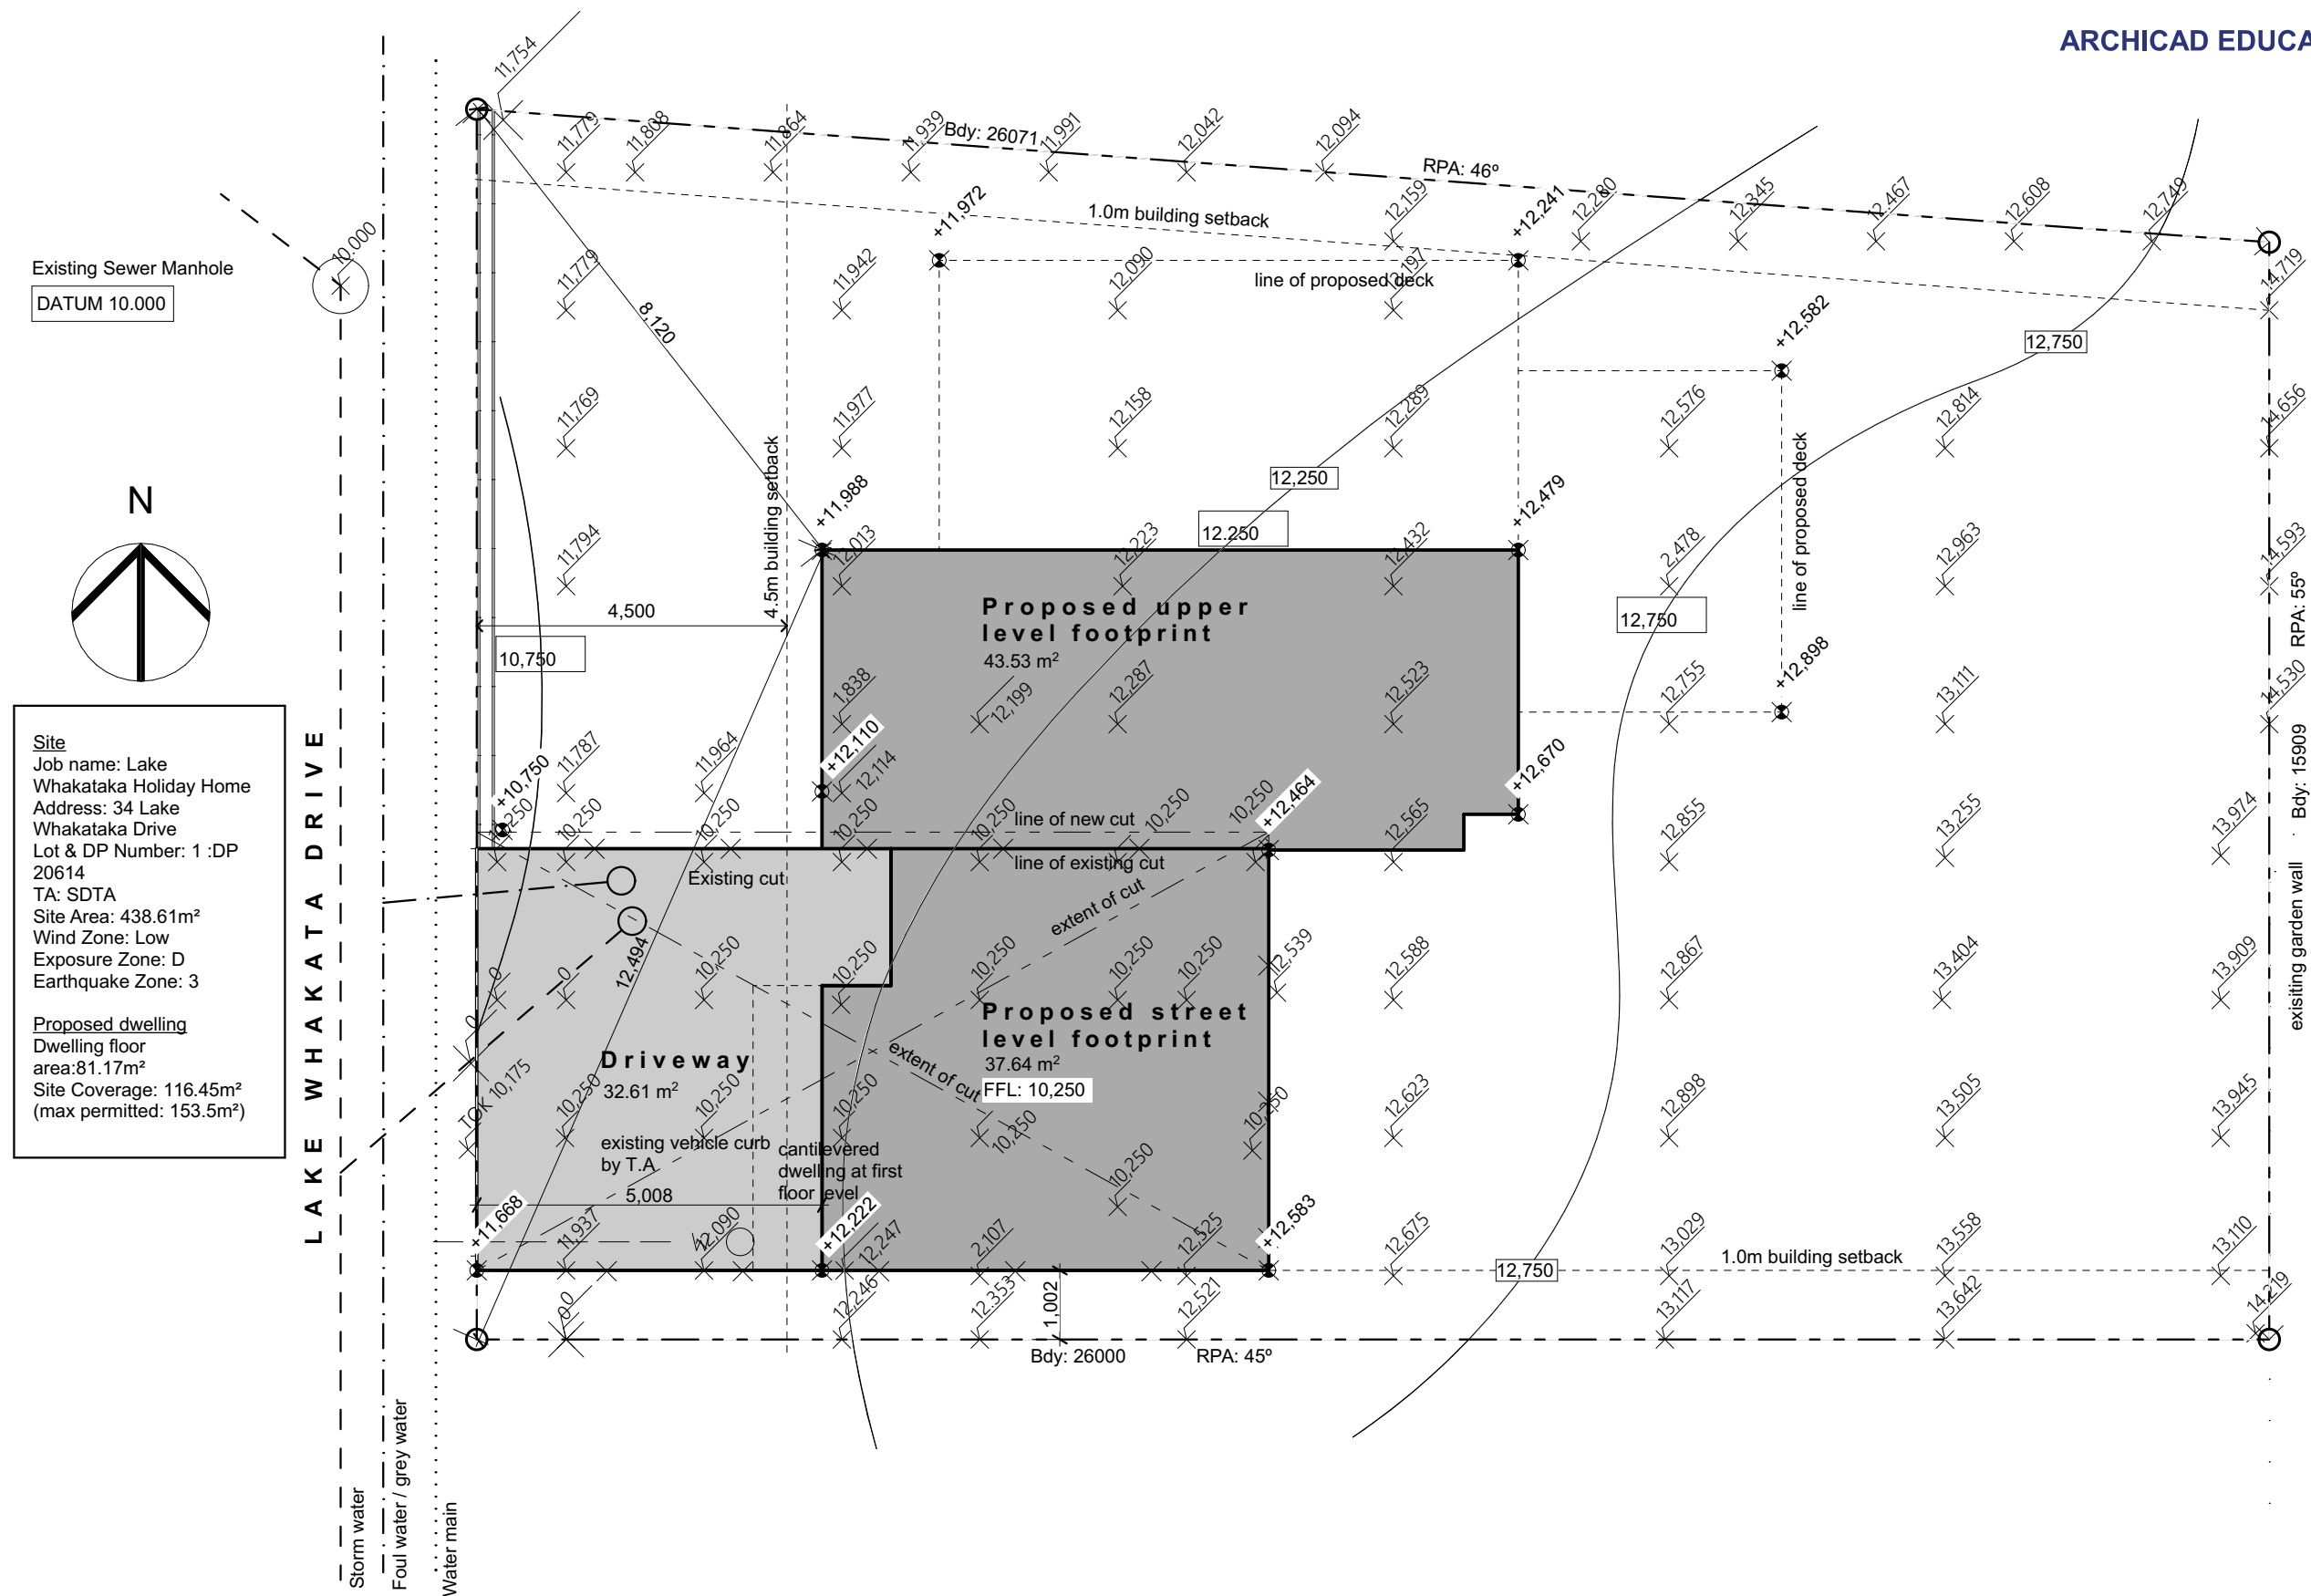


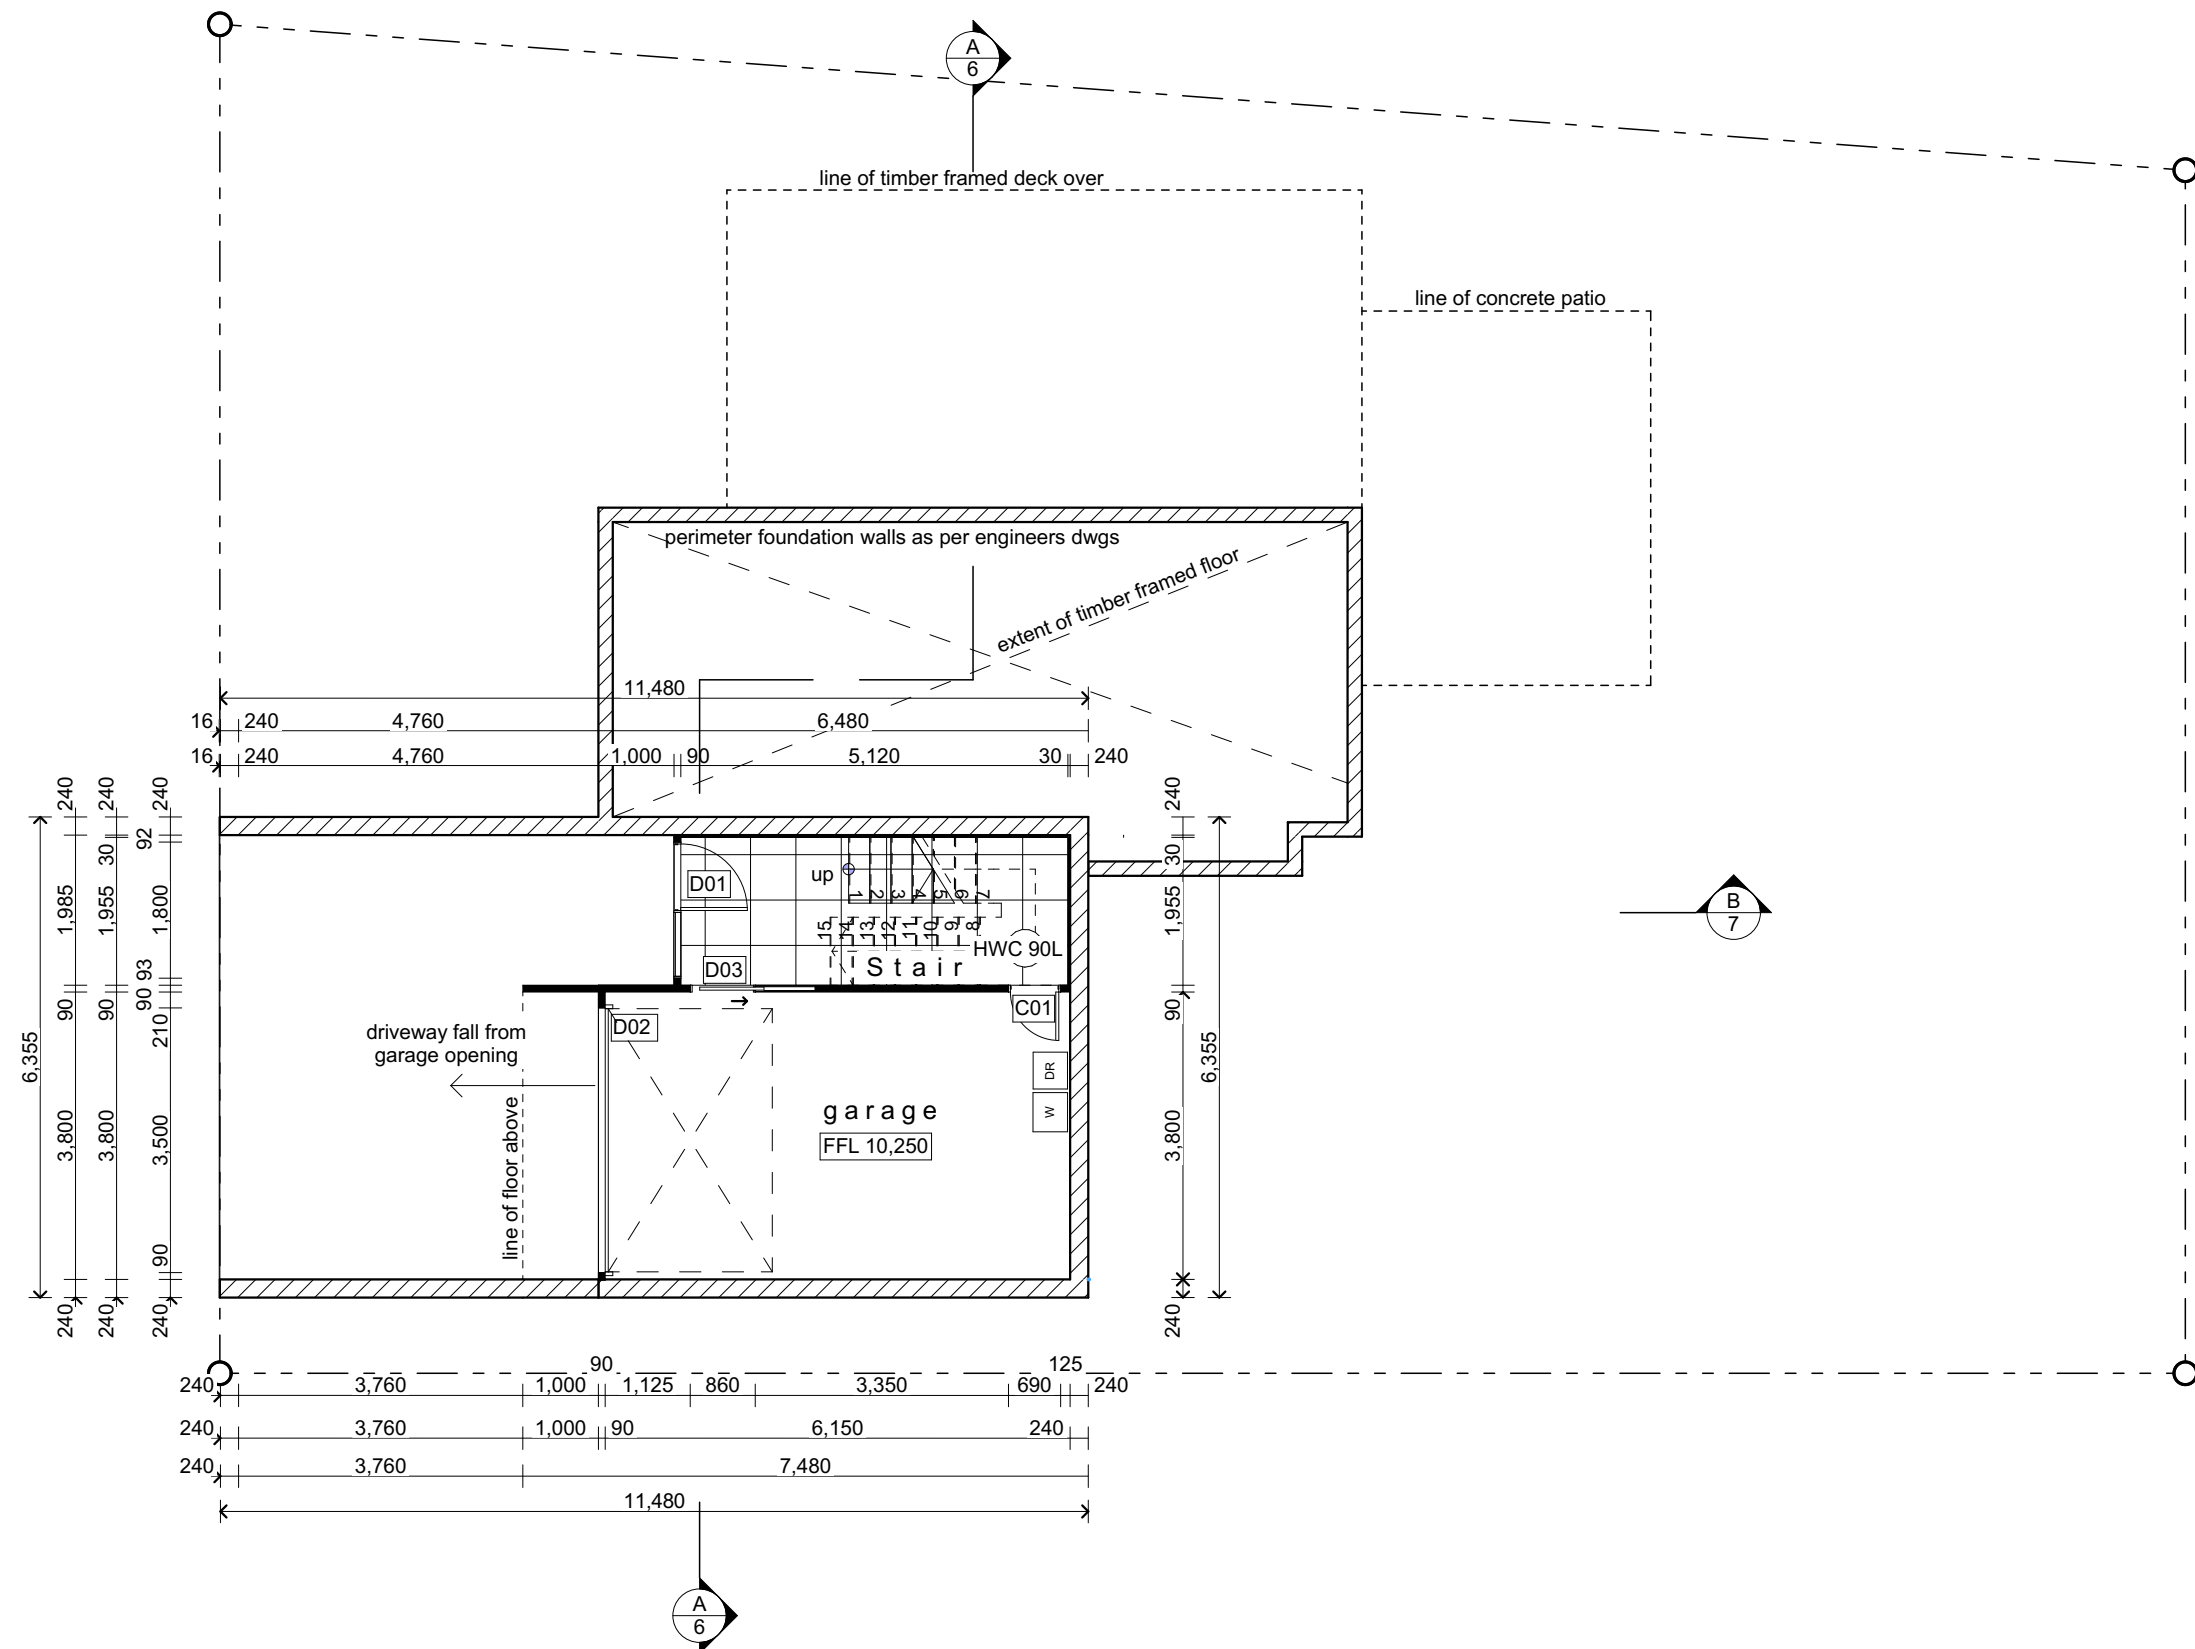

Project:	Lake Whakata Holiday House
Sheet Title:	Ground Floor Plan

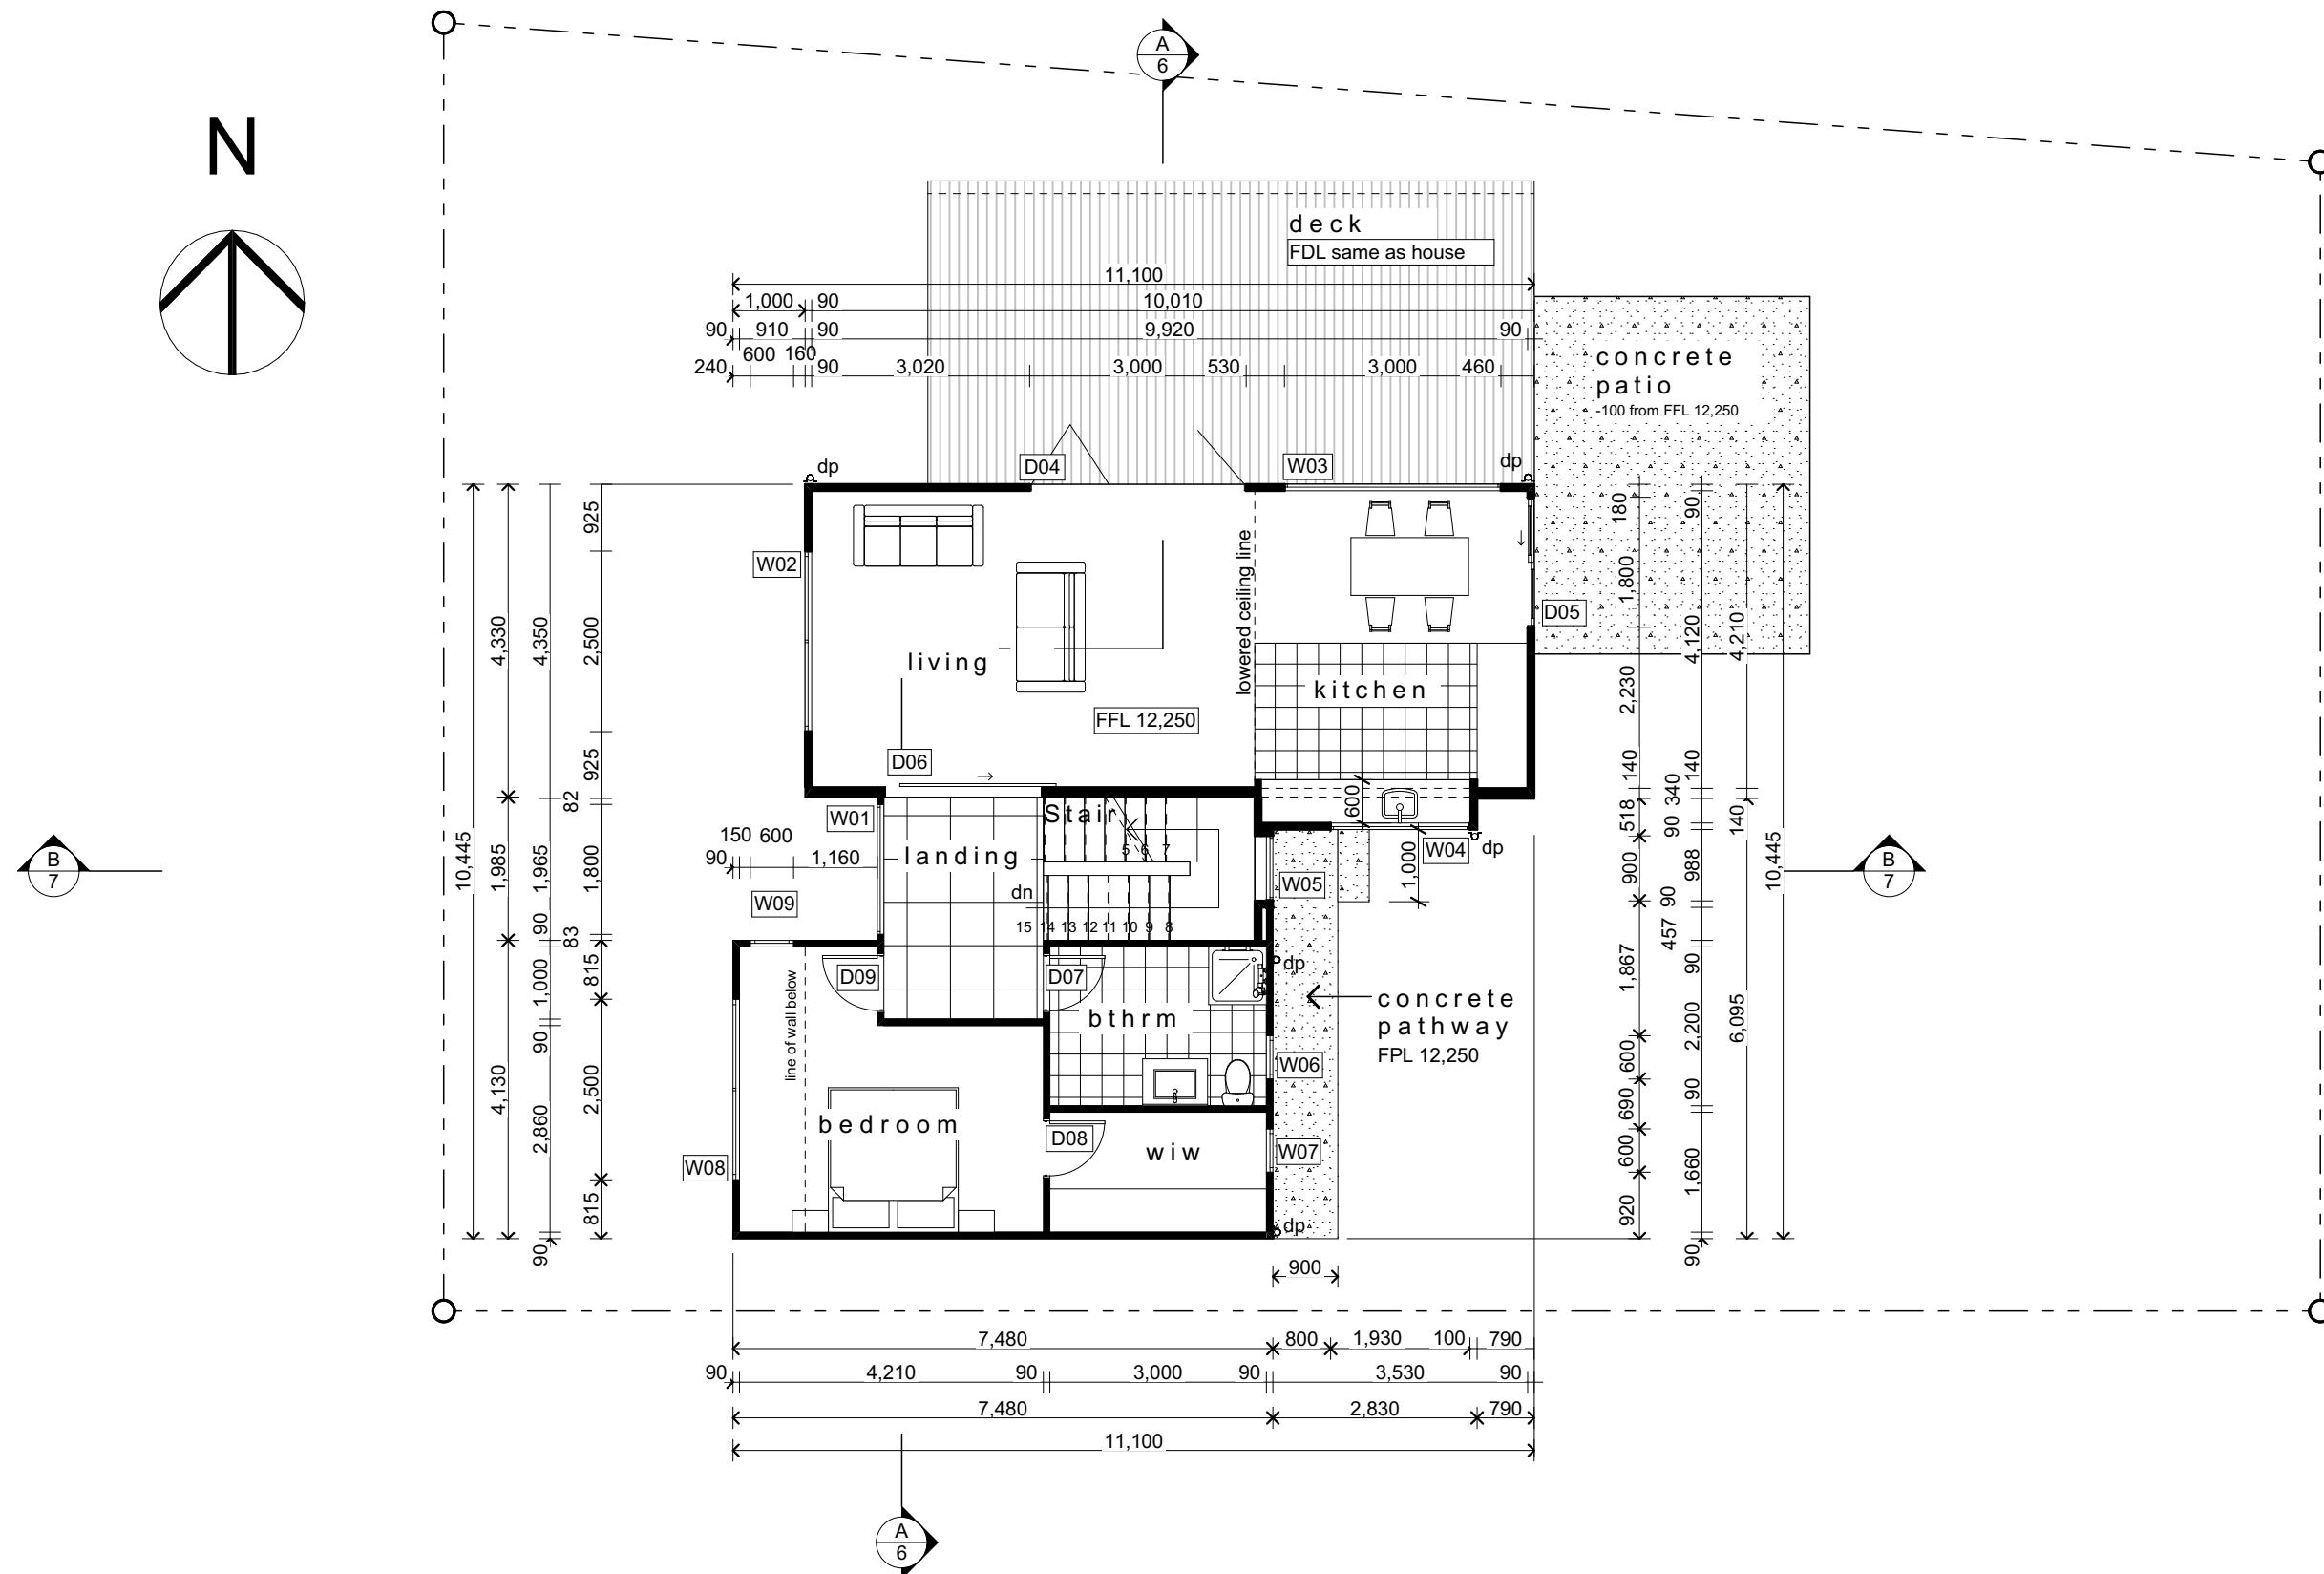


First Floor Plan
Scale 1:100

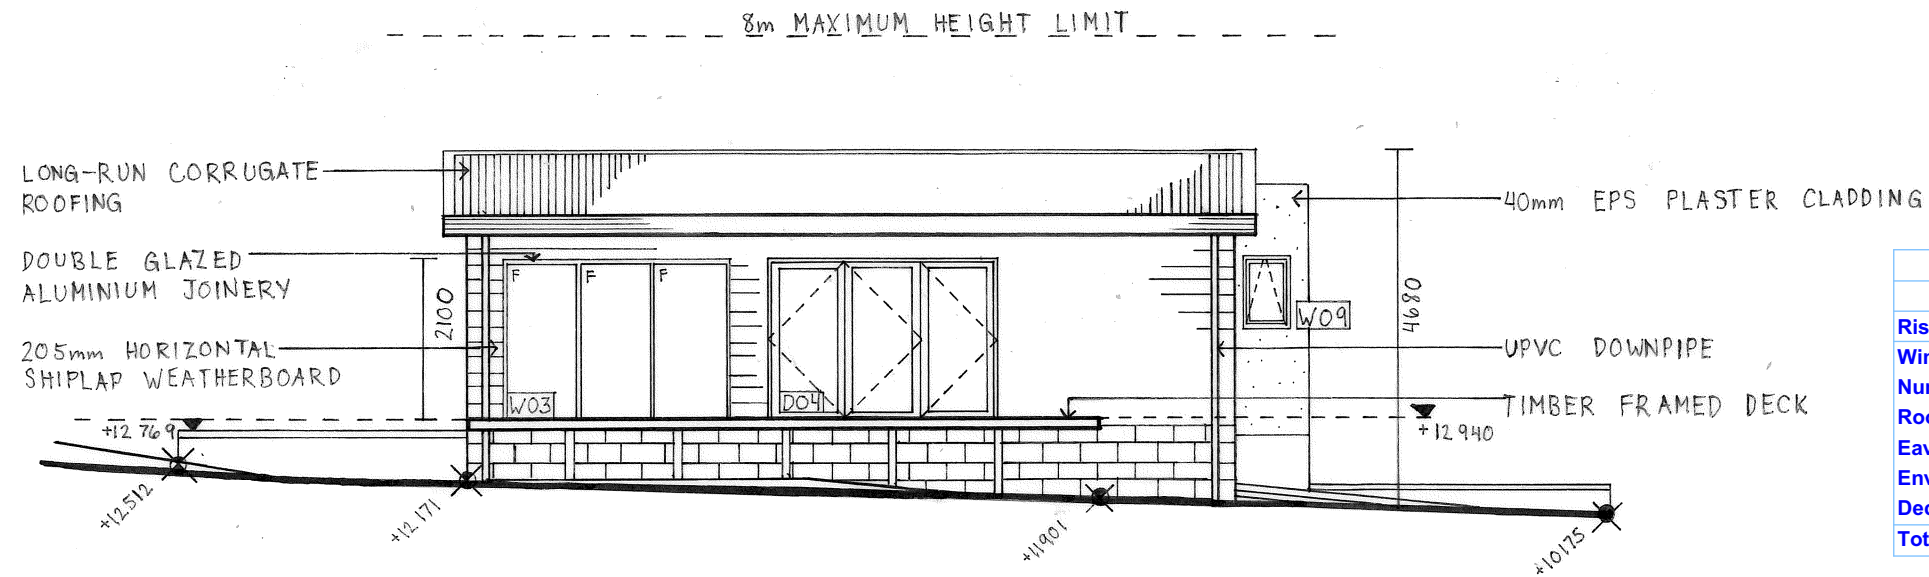


① NORTH ELEVATION
SCALE 1:100


BUILDING ENVELOPE RISK MATRIX		
North Elevation		
Risk Factor	Risk Severity	Risk Score
Wind zone (per NZS 3604)	Low risk	0
Number of storeys	Medium risk	1
Roof/wall intersection design	High risk	3
Eaves width	Very high risk	5
Envelope complexity	Medium risk	1
Deck design	Low risk	0
Total Risk Score:		10

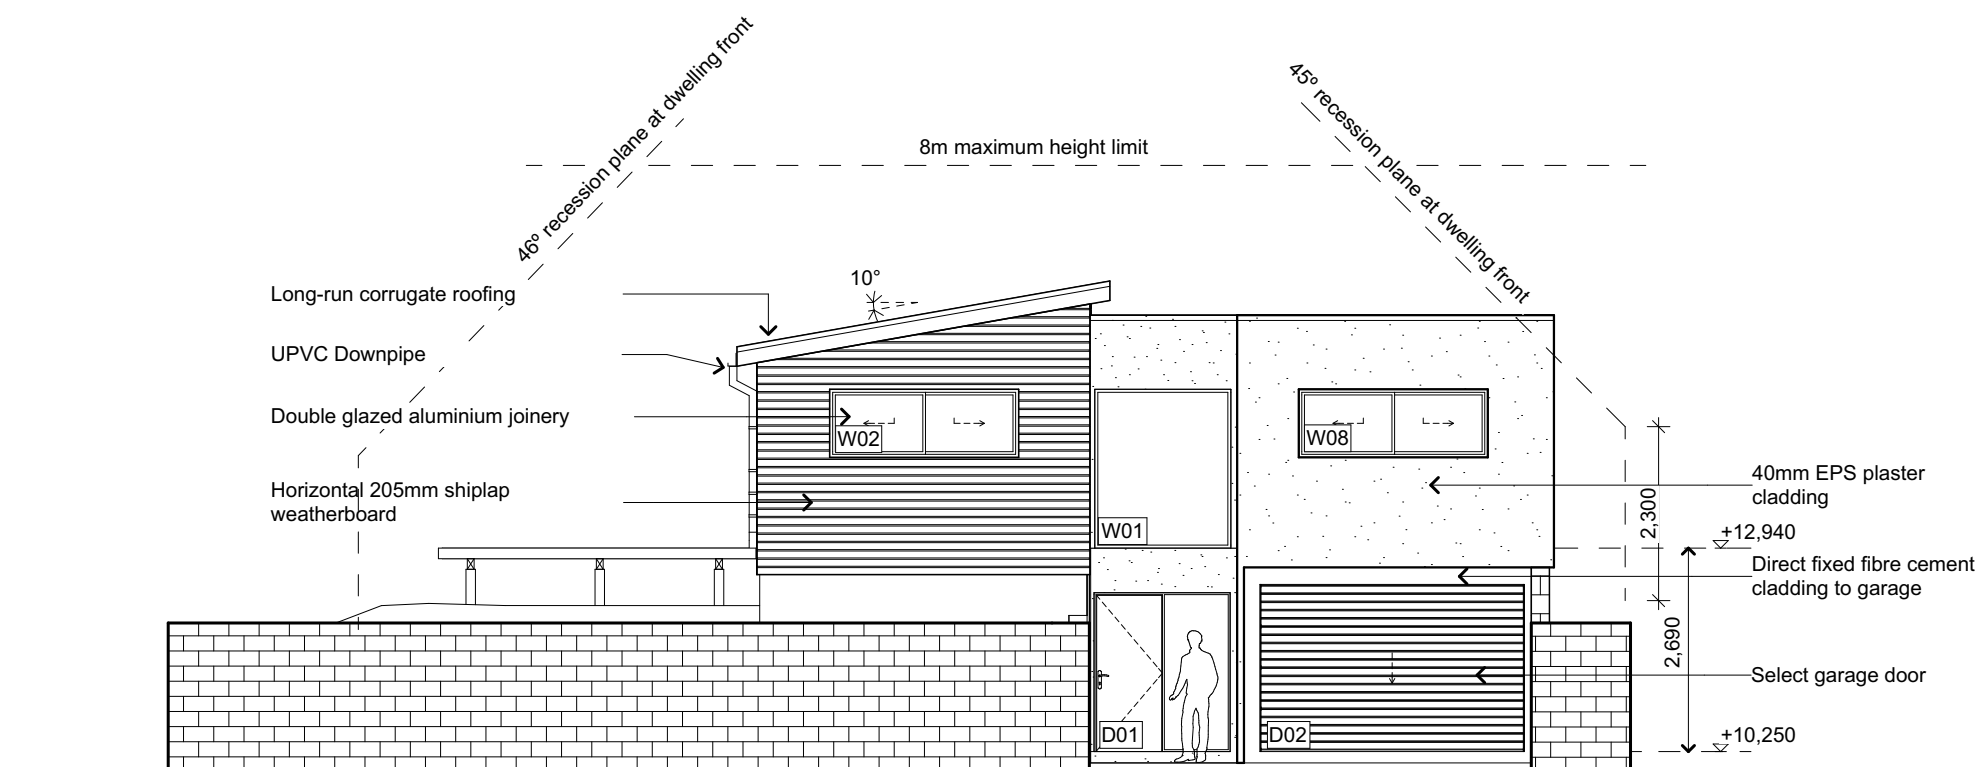

② West Elevation
Scale 1:100


BUILDING ENVELOPE RISK MATRIX		
West Elevation		
Risk Factor	Risk Severity	Risk Score
Wind zone (per NZS 3604)	Low risk	0
Number of storeys	Medium risk	1
Roof/wall intersection design	Very high risk	5
Eaves width	Very high risk	5
Envelope complexity	Medium risk	1
Deck design	Low	0
Total Risk Score:		12

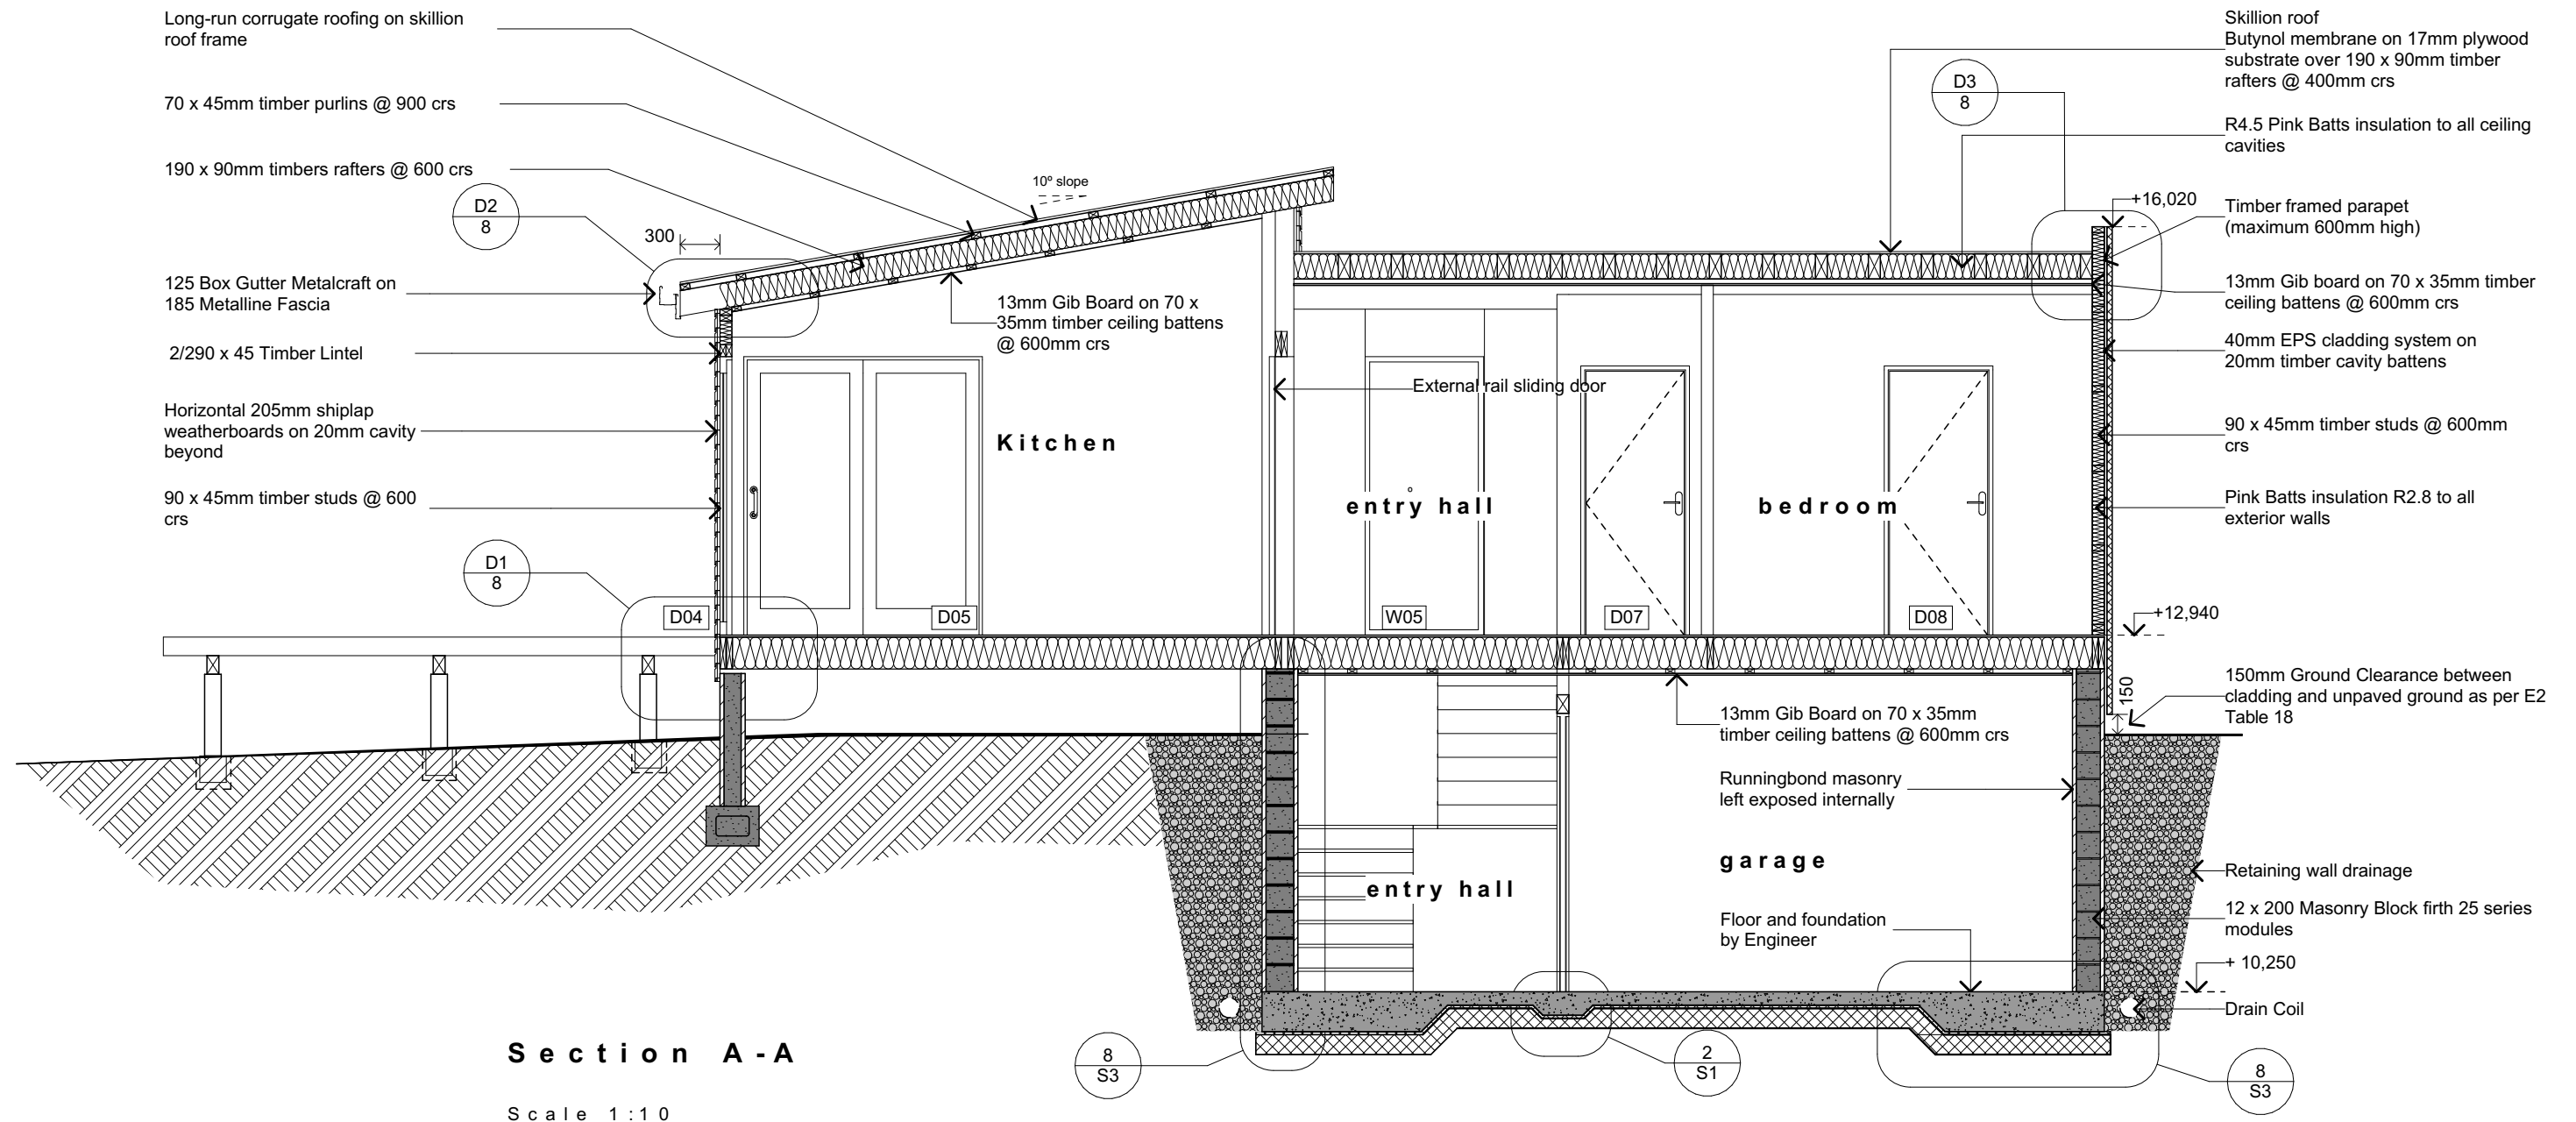

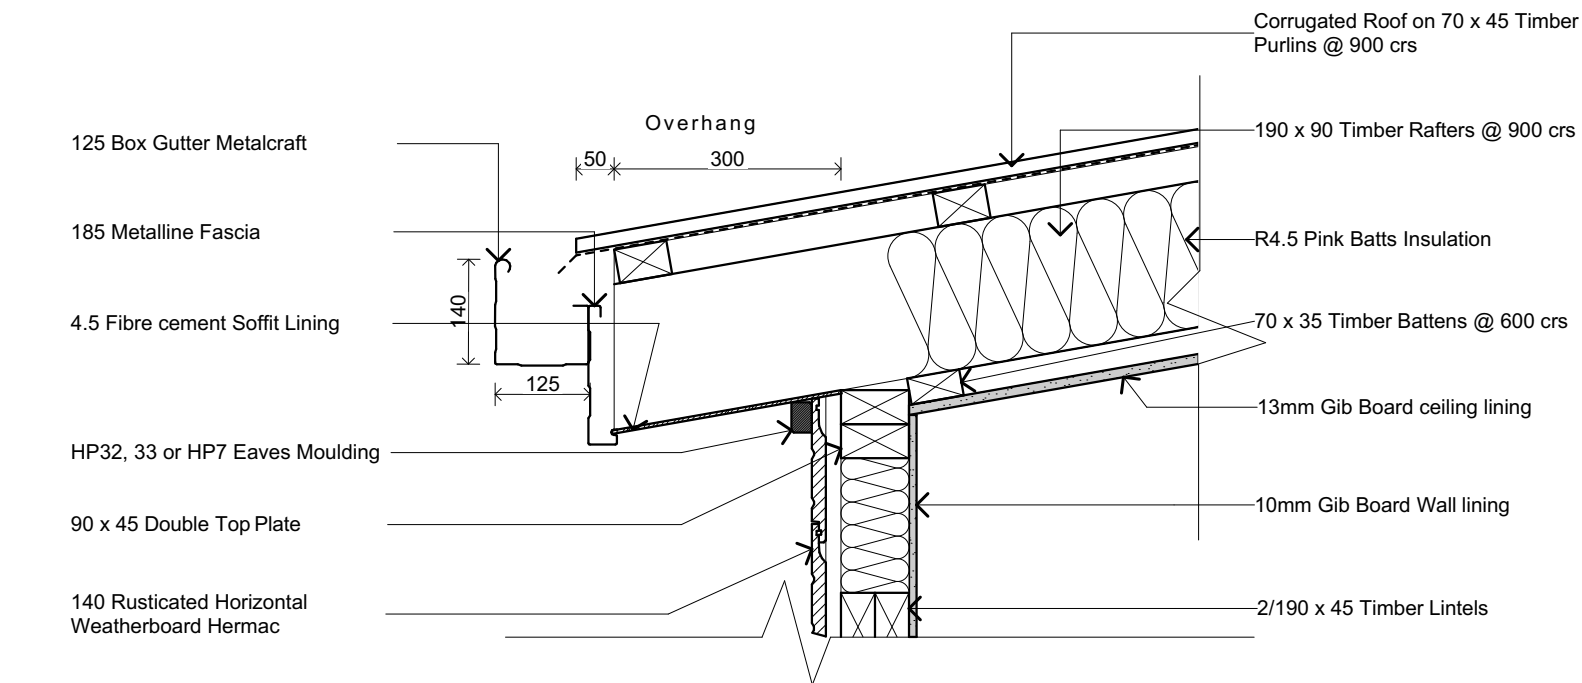


② Eaves Details

Scale 1:10

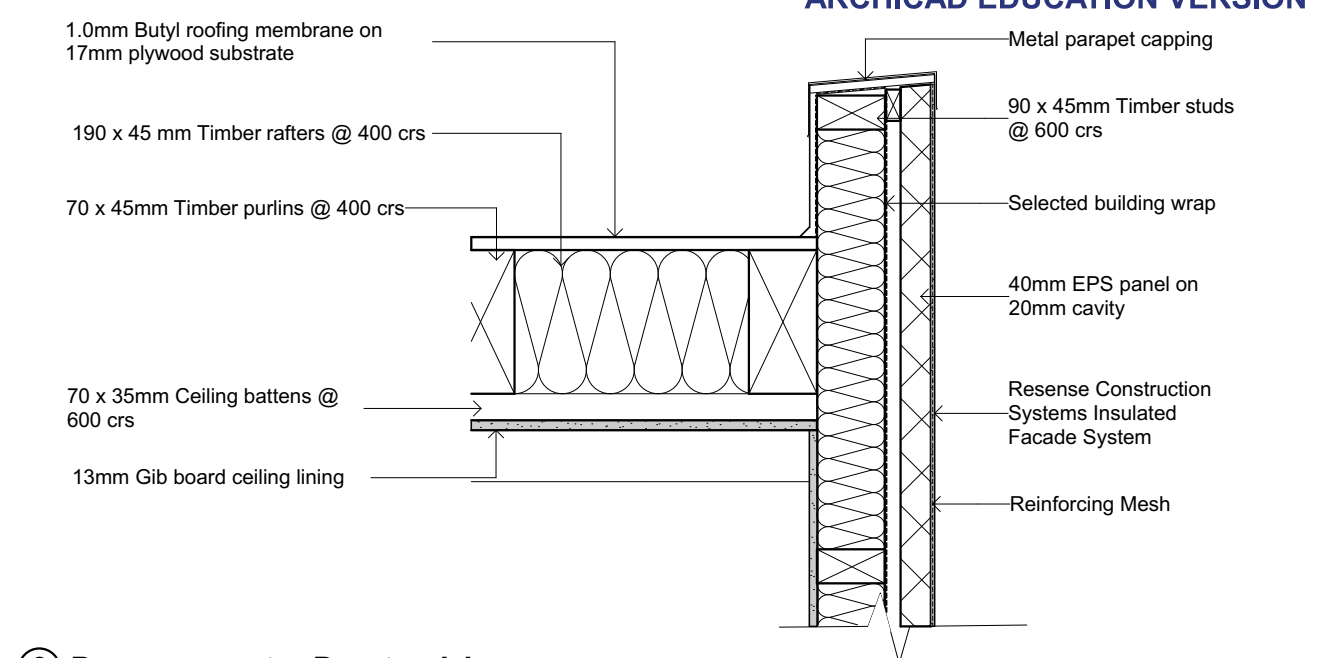


③ Parapet Details

Scale 1:10

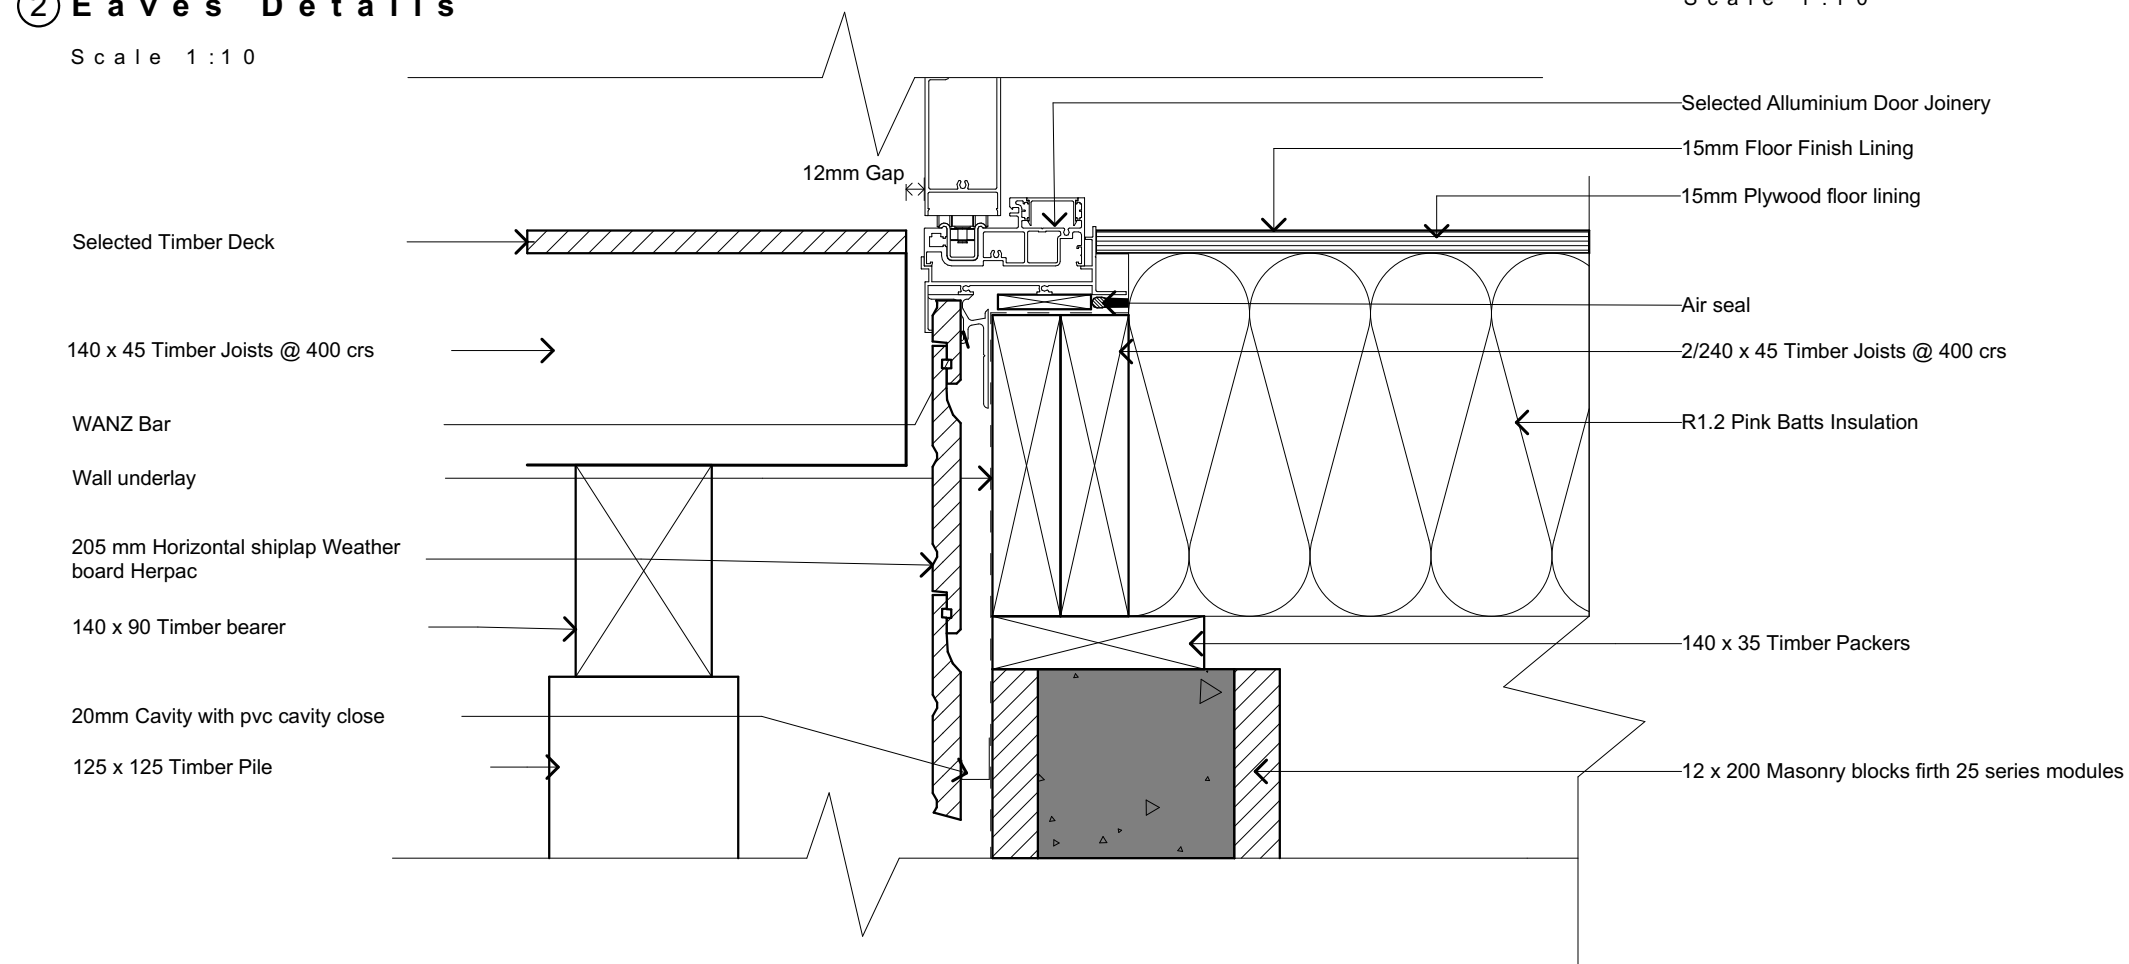

① Level threshold - door joinery Details

Scale 1:5

 <p>Ara Institute of Canterbury Ltd. Department of Engineering and Architectural Studies</p>	<p>Project: Lake Whakata Holiday House</p> <p>Sheet Title: Details</p>	<p>Name: Hazel de Paz Date: 29/09/2022 Scale: 1:5, 1:10 @ A3</p>	<p>Sheet #: 7 of 2</p>
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