

SHEET LIST:
 G.00 TITLE PAGE
 L.01 SITE PLAN
 A1.01 GROUND FLOOR PLAN
 A1.02 DECK PLAN
 A1.03 ROOF PLAN
 A2.01 NORTH ELEVATION
 A2.02 WEST ELEVATION
 A3.01 SECTION 1
 A3.02 SECTION 2
 A3.03 SECTION 3
 A4.01 DETAILS
 A4.02 DETAILS
 A4.03 DETAILS
 A4.04 DETAILS
 S1.01 DECK FRAMING PLAN
 S1.02 ROOF FRAMING PLAN
 PR.01 PROTOTYPE TITLE PAGE
 PR.02 PROTOTYPE PERSPECTIVE
 PR.03 PROTOTYPE PLAN EN SITU
 PR.04 PROTOTYPE ELEVATIONS EN SITU
 PR.05 PROTOTYPE CUT SHEET
 PR.06 PROTOTYPE ASSEMBLY SEQUENCE

ABBREVIATIONS:
 ABV. = ABOVE
 B.O. = BOTTOM OF
 CL. = CENTER LINE
 CLR. = CLEARANCE
 COL. = COLUMN
 CONC. = CONCRETE
 DN. = DOWN
 EL. = ELEVATION
 EPMD = ETHYLENE PROPYLENE DIENE MONOMER
 EXT. = EXTERIOR
 FDTN. = FOUNDATION
 GA. = GAUGE
 GALV. = GALVANIZED
 INT. = INTERIOR
 LF. = LINEAR FEET
 LVL. = LAMINATED VENEER LUMBER
 MAX. = MAXIMUM
 MIN. = MIN. = MINIMUM
 NTS. = NOT TO SCALE
 O.C. = ON CENTER
 OPP. = OPPOSITE
 R.O. = ROUGH OPENING
 S.F. = SQUARE FEET
 T.O. = TOP OF
 TYP. = TYPICAL
 W/ = WITH
 ' = INCHES
 " = FEET
 # = NUMBER

WOODHENG

COMMUNITY FORGE PORCH ADDITION

1 2 5 6 F R A N K L I N A V E N U E
 W I L K I N S B U R G , P A 1 5 2 1 1

DESIGN BUILD STUDIO

CARNEGIE MELLON UNIVERSITY
 SCHOOL OF ARCHITECTURE
 5000 FORBES AVENUE
 PITTSBURGH, PA 15213

K Y L E B A N C R O F T
 T A K U M I J O R D A N D A V I S
 T A Y L O R L A T I M E R
 D E C E M B E R 1 0 , 2 0 1 9
 F O R E R E V I E W

SYMBOLS:

W1 — ASSEMBLY DESIGNATION

WALL TYPE TAG

15 — NOTE DESIGNATION

KEYNOTE TAG

11300 — SHEET DETAIL

ELEVATION TAG

11400 — SHEET DETAIL

BUILDING SECTION TAG

11500 — SHEET DETAIL

WALL SECTION TAG

RESTROOM
 101 203 SF — ROOM NAME
 101 — SQUARE FOOTAGE
 ROOM NUMBER

ROOM DESIGNATION TAG

A33 — DESIGNATOR

WINDOW TYPE TAG

333C — DESIGNATOR

DOOR TYPE TAG

A202 — DETAIL SHEET

DETAIL REFERENCE TAG

LL — DESIGNATOR

SPOT ELEVATION TAG

S44 — SLOPE DIRECTION

SLOPE TAG

SC2 — DESIGNATOR

BEAM SC2

CENTERLINE TAG

ENTRANCE — MAIN ENTRANCE

ENTRANCE — SECONDARY ENTRANCE

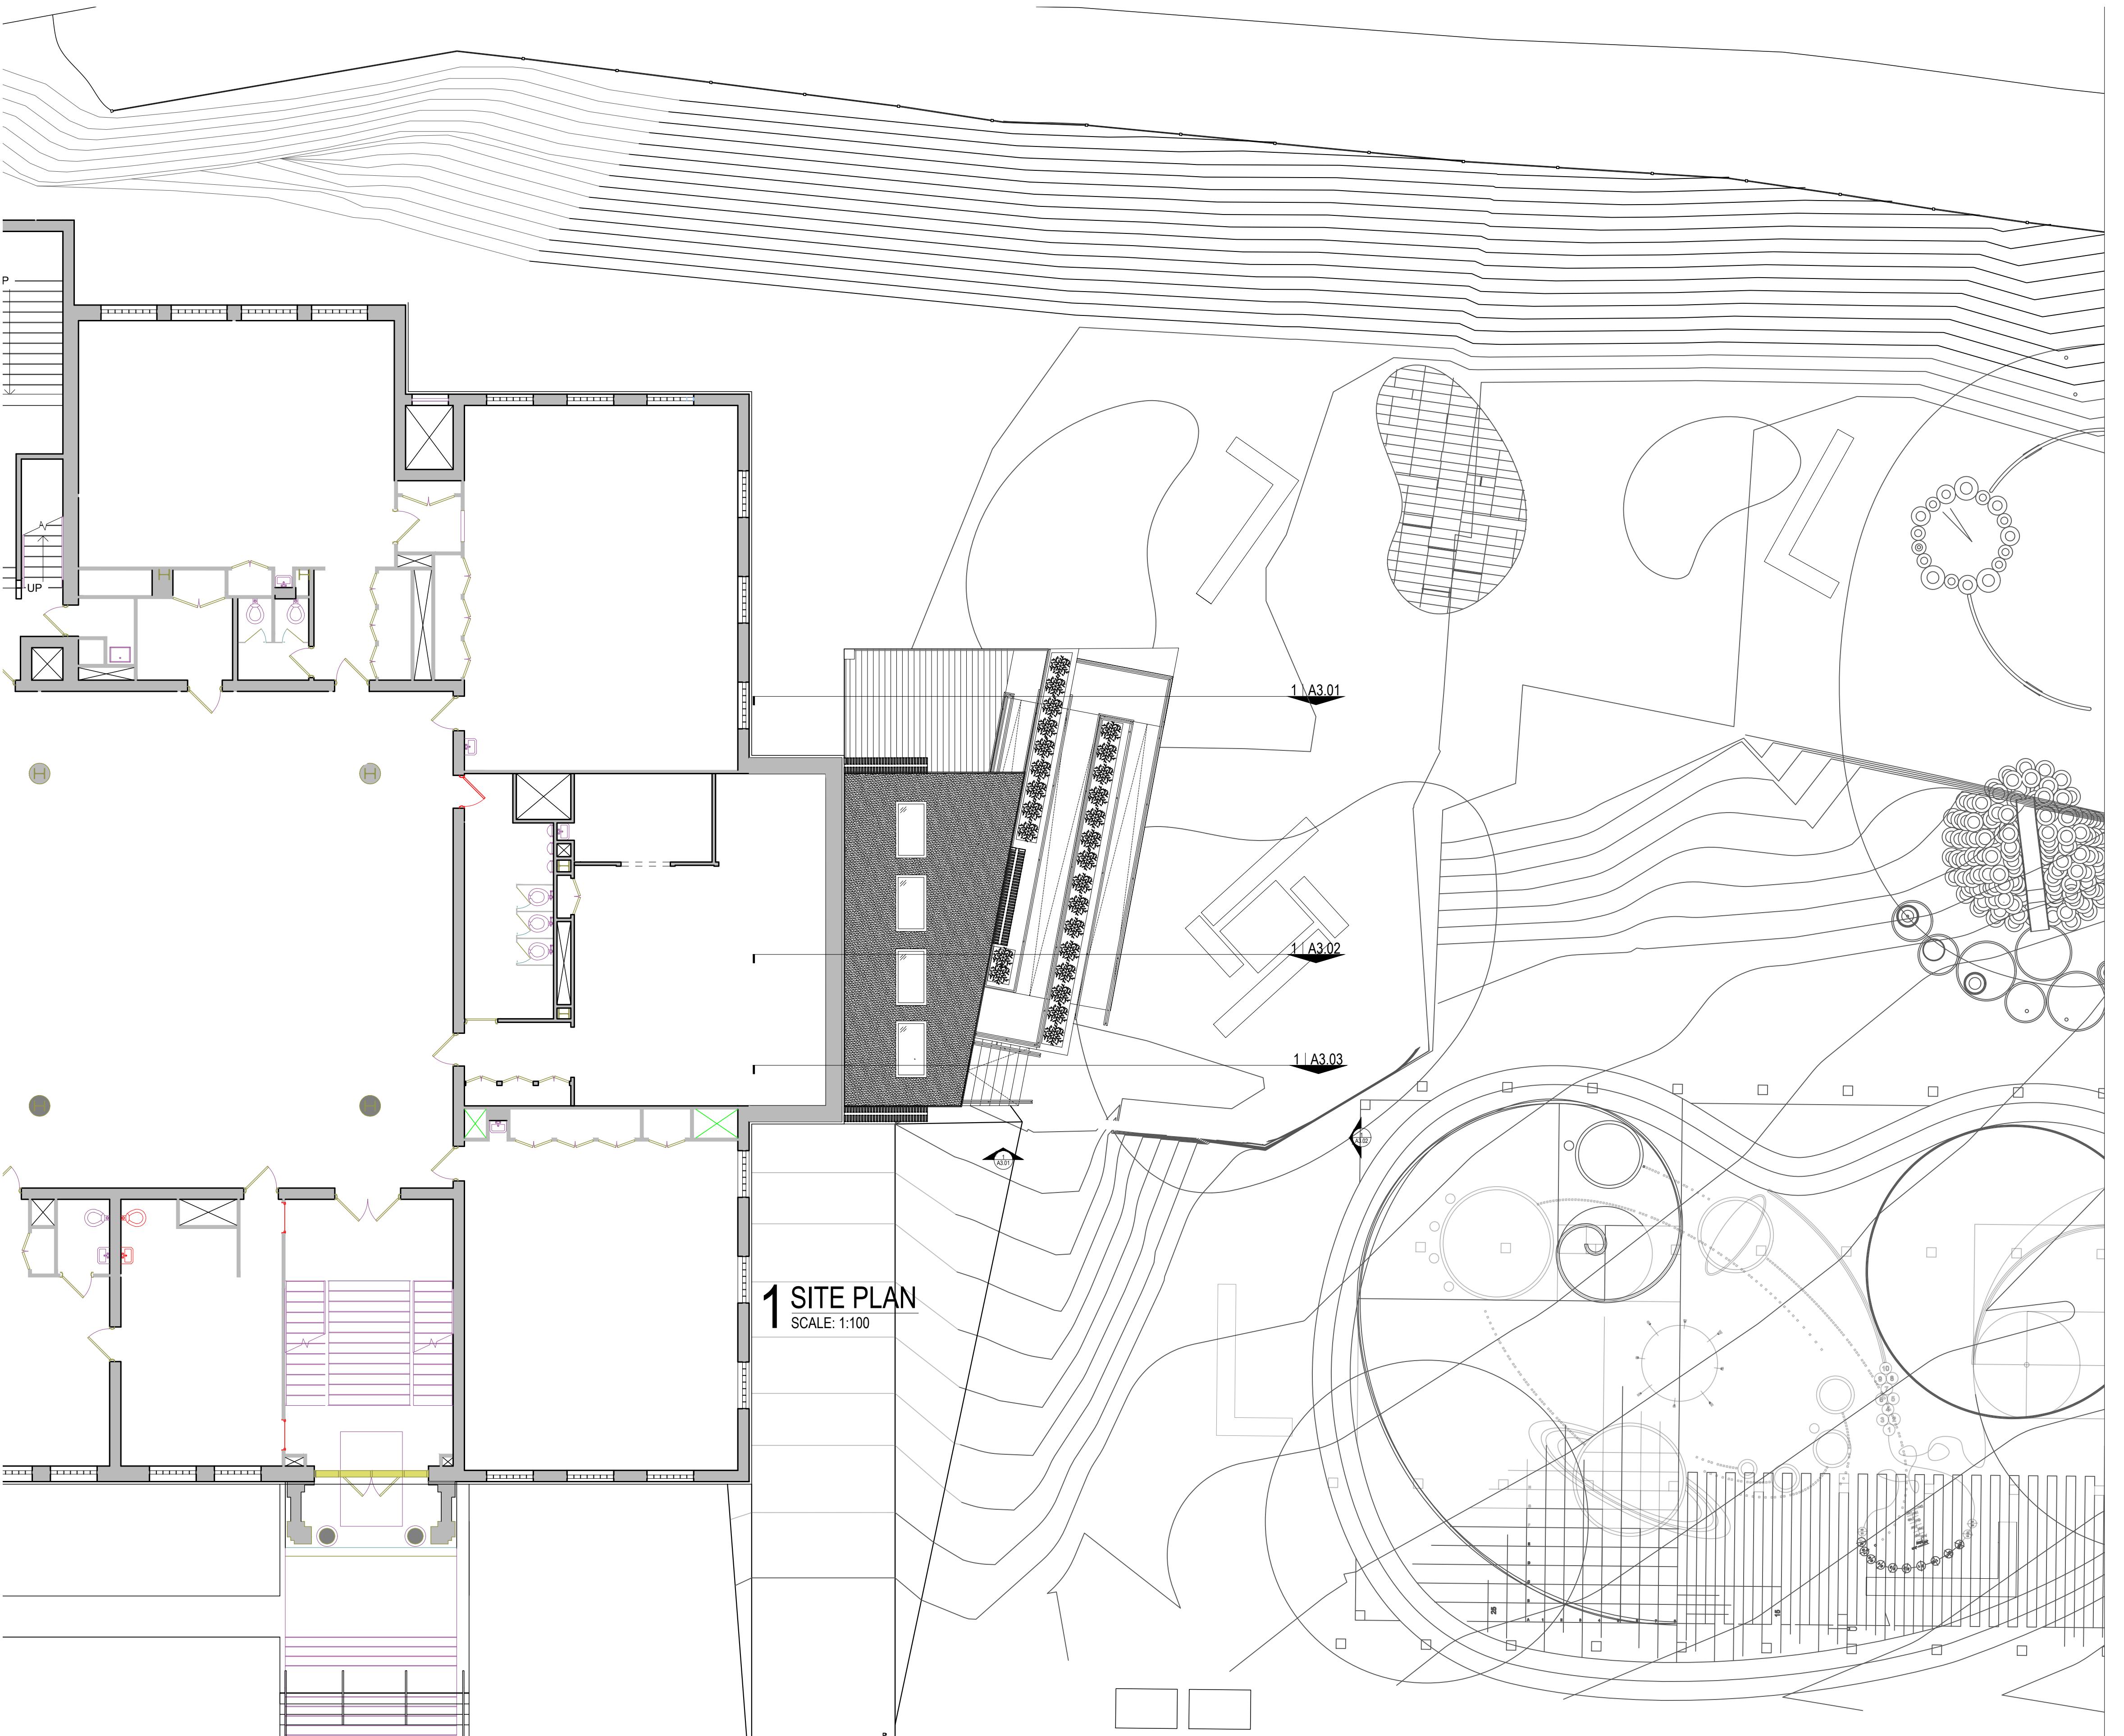
COVERED SECONDARY

ENTRANCE — COVERED SECONDARY ENTRANCE

CONTACT:

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	INFILL SOIL
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	GRASS
	SAND OR GRANULAR PAD
	CUT WOOD GRAIN

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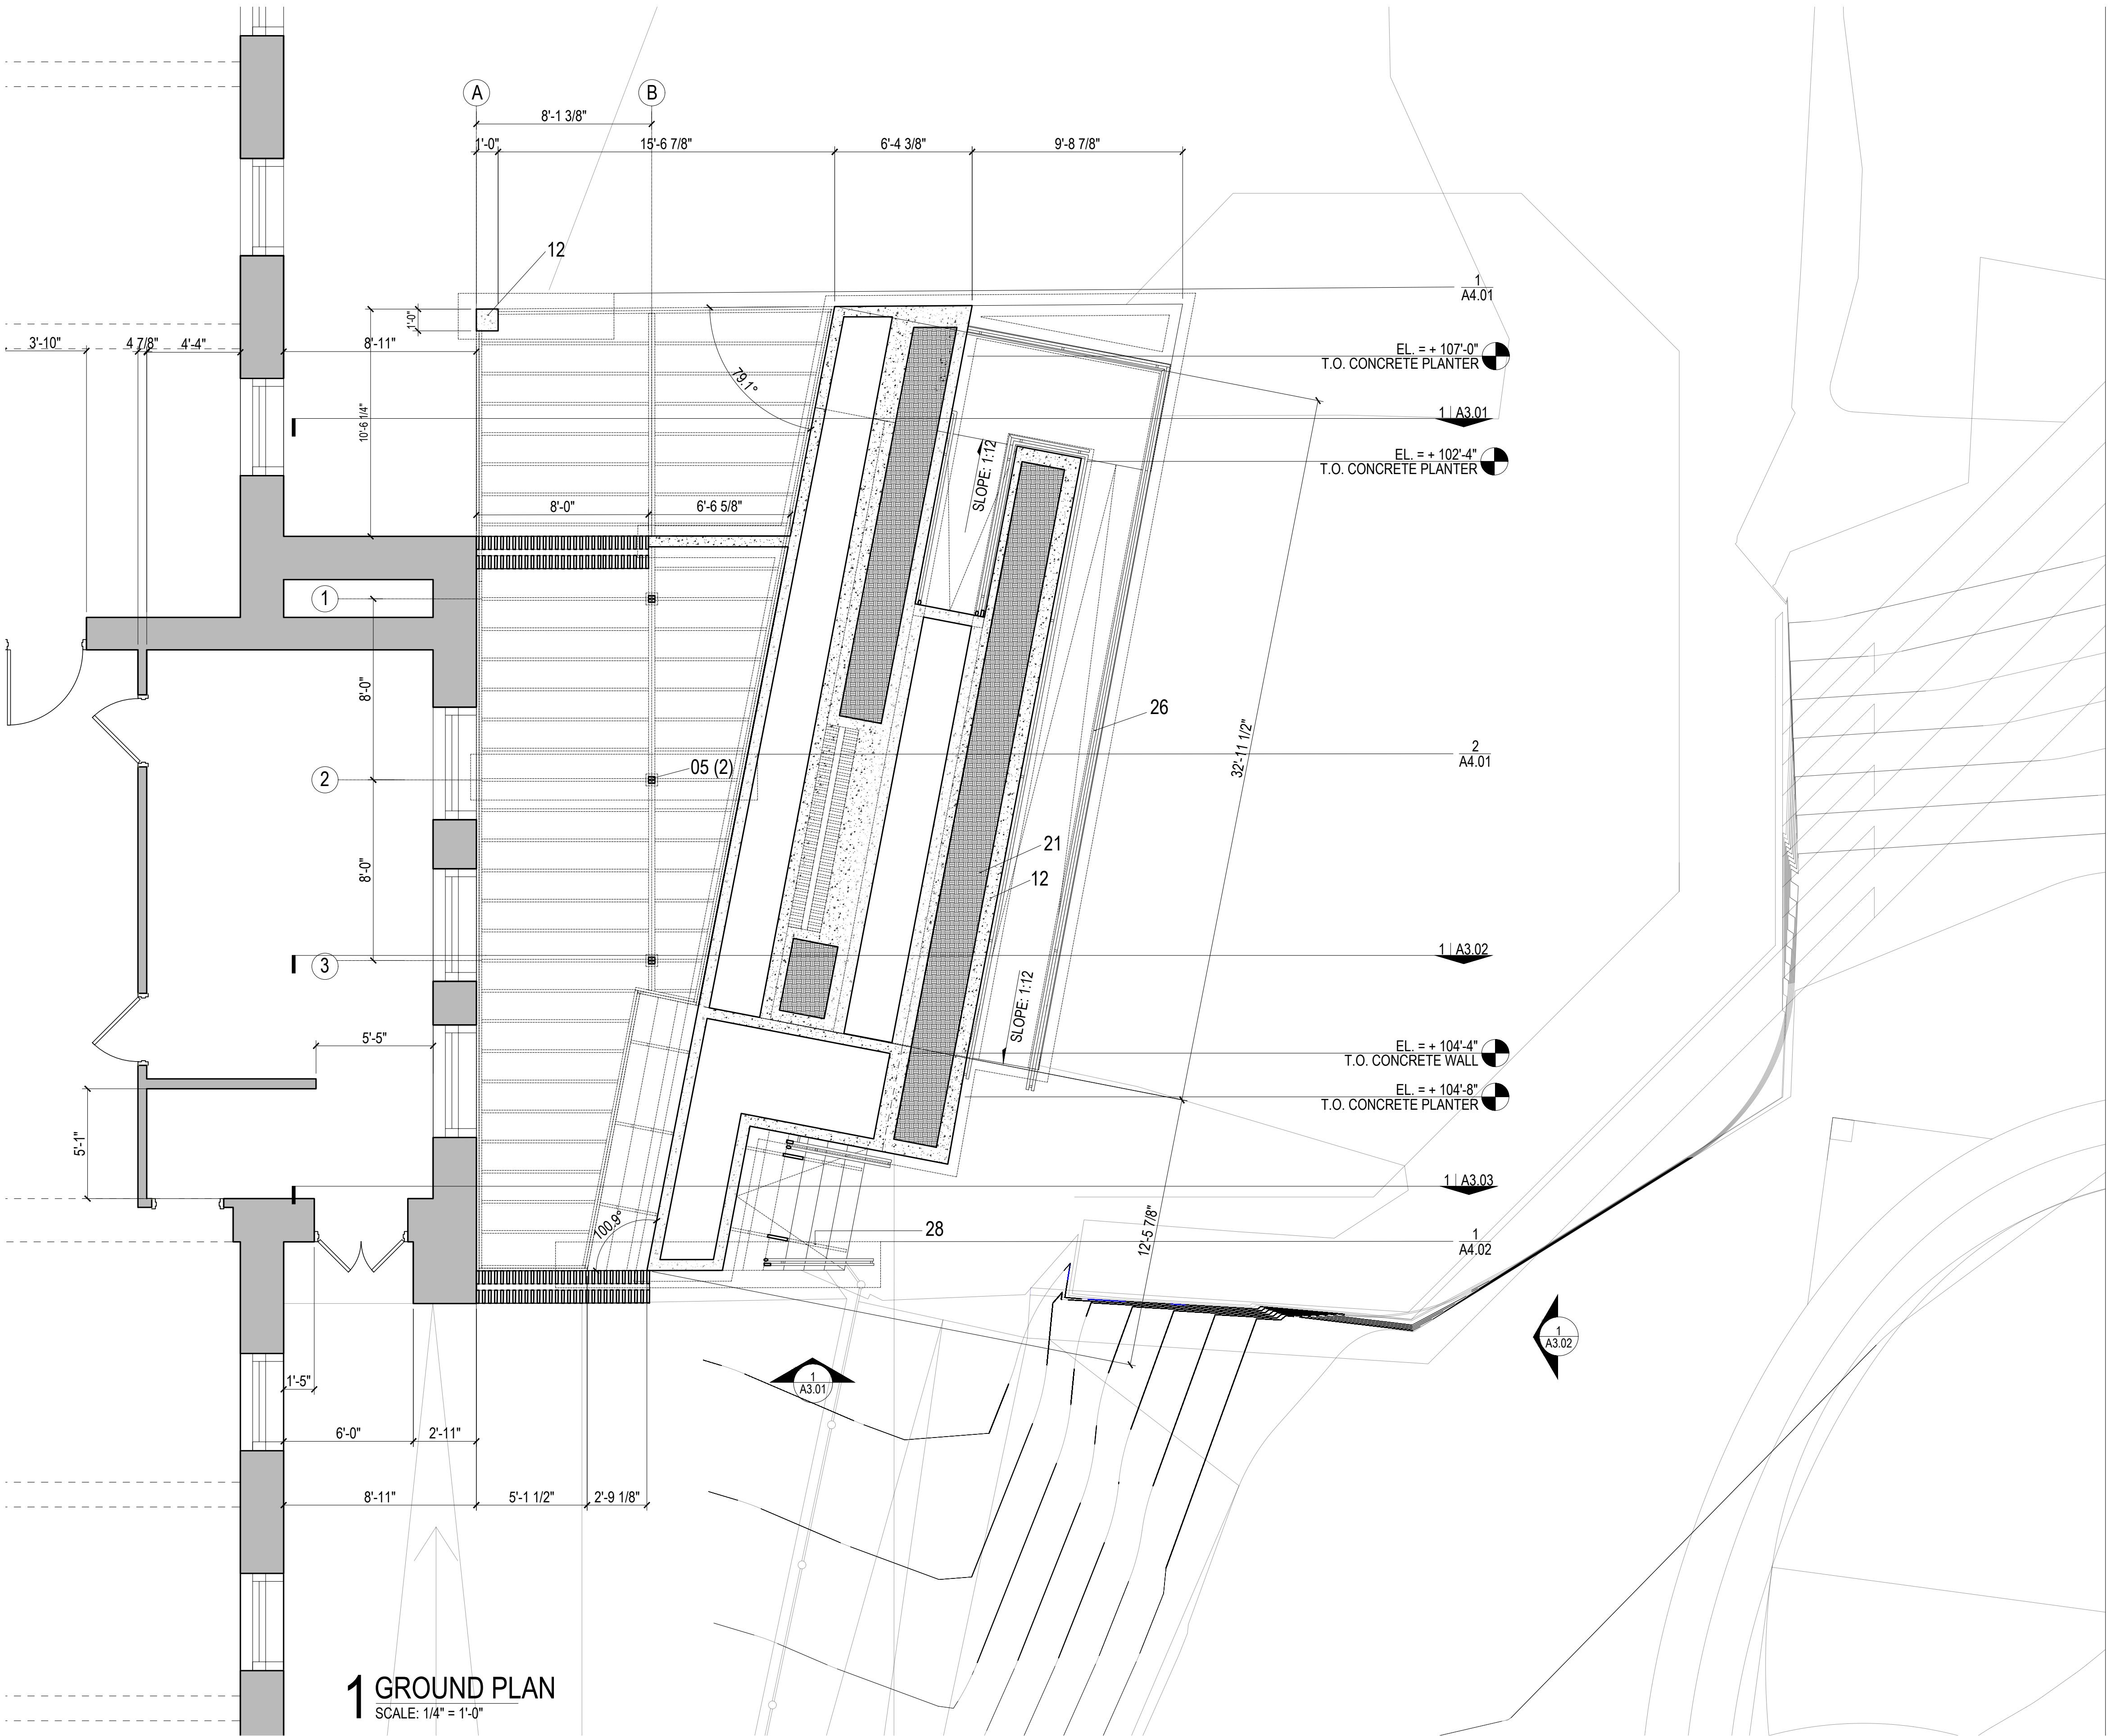
WOODHENGE COMMUNITY FORCE

1256 FRANKLIN AVE.
WILKINSBURG, PA 15221

A1.01
GROUND FLOOR PLAN

DRAWN BY:
KYLE BANCROFT
TAKUMI DAVIS
TAYLOR LATIMER

1 DECEMBER
2019
F O R
R E V I E W



DESIGN BUILD STUDIO
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WOODHENGE

A1.02

DRAWN BY:
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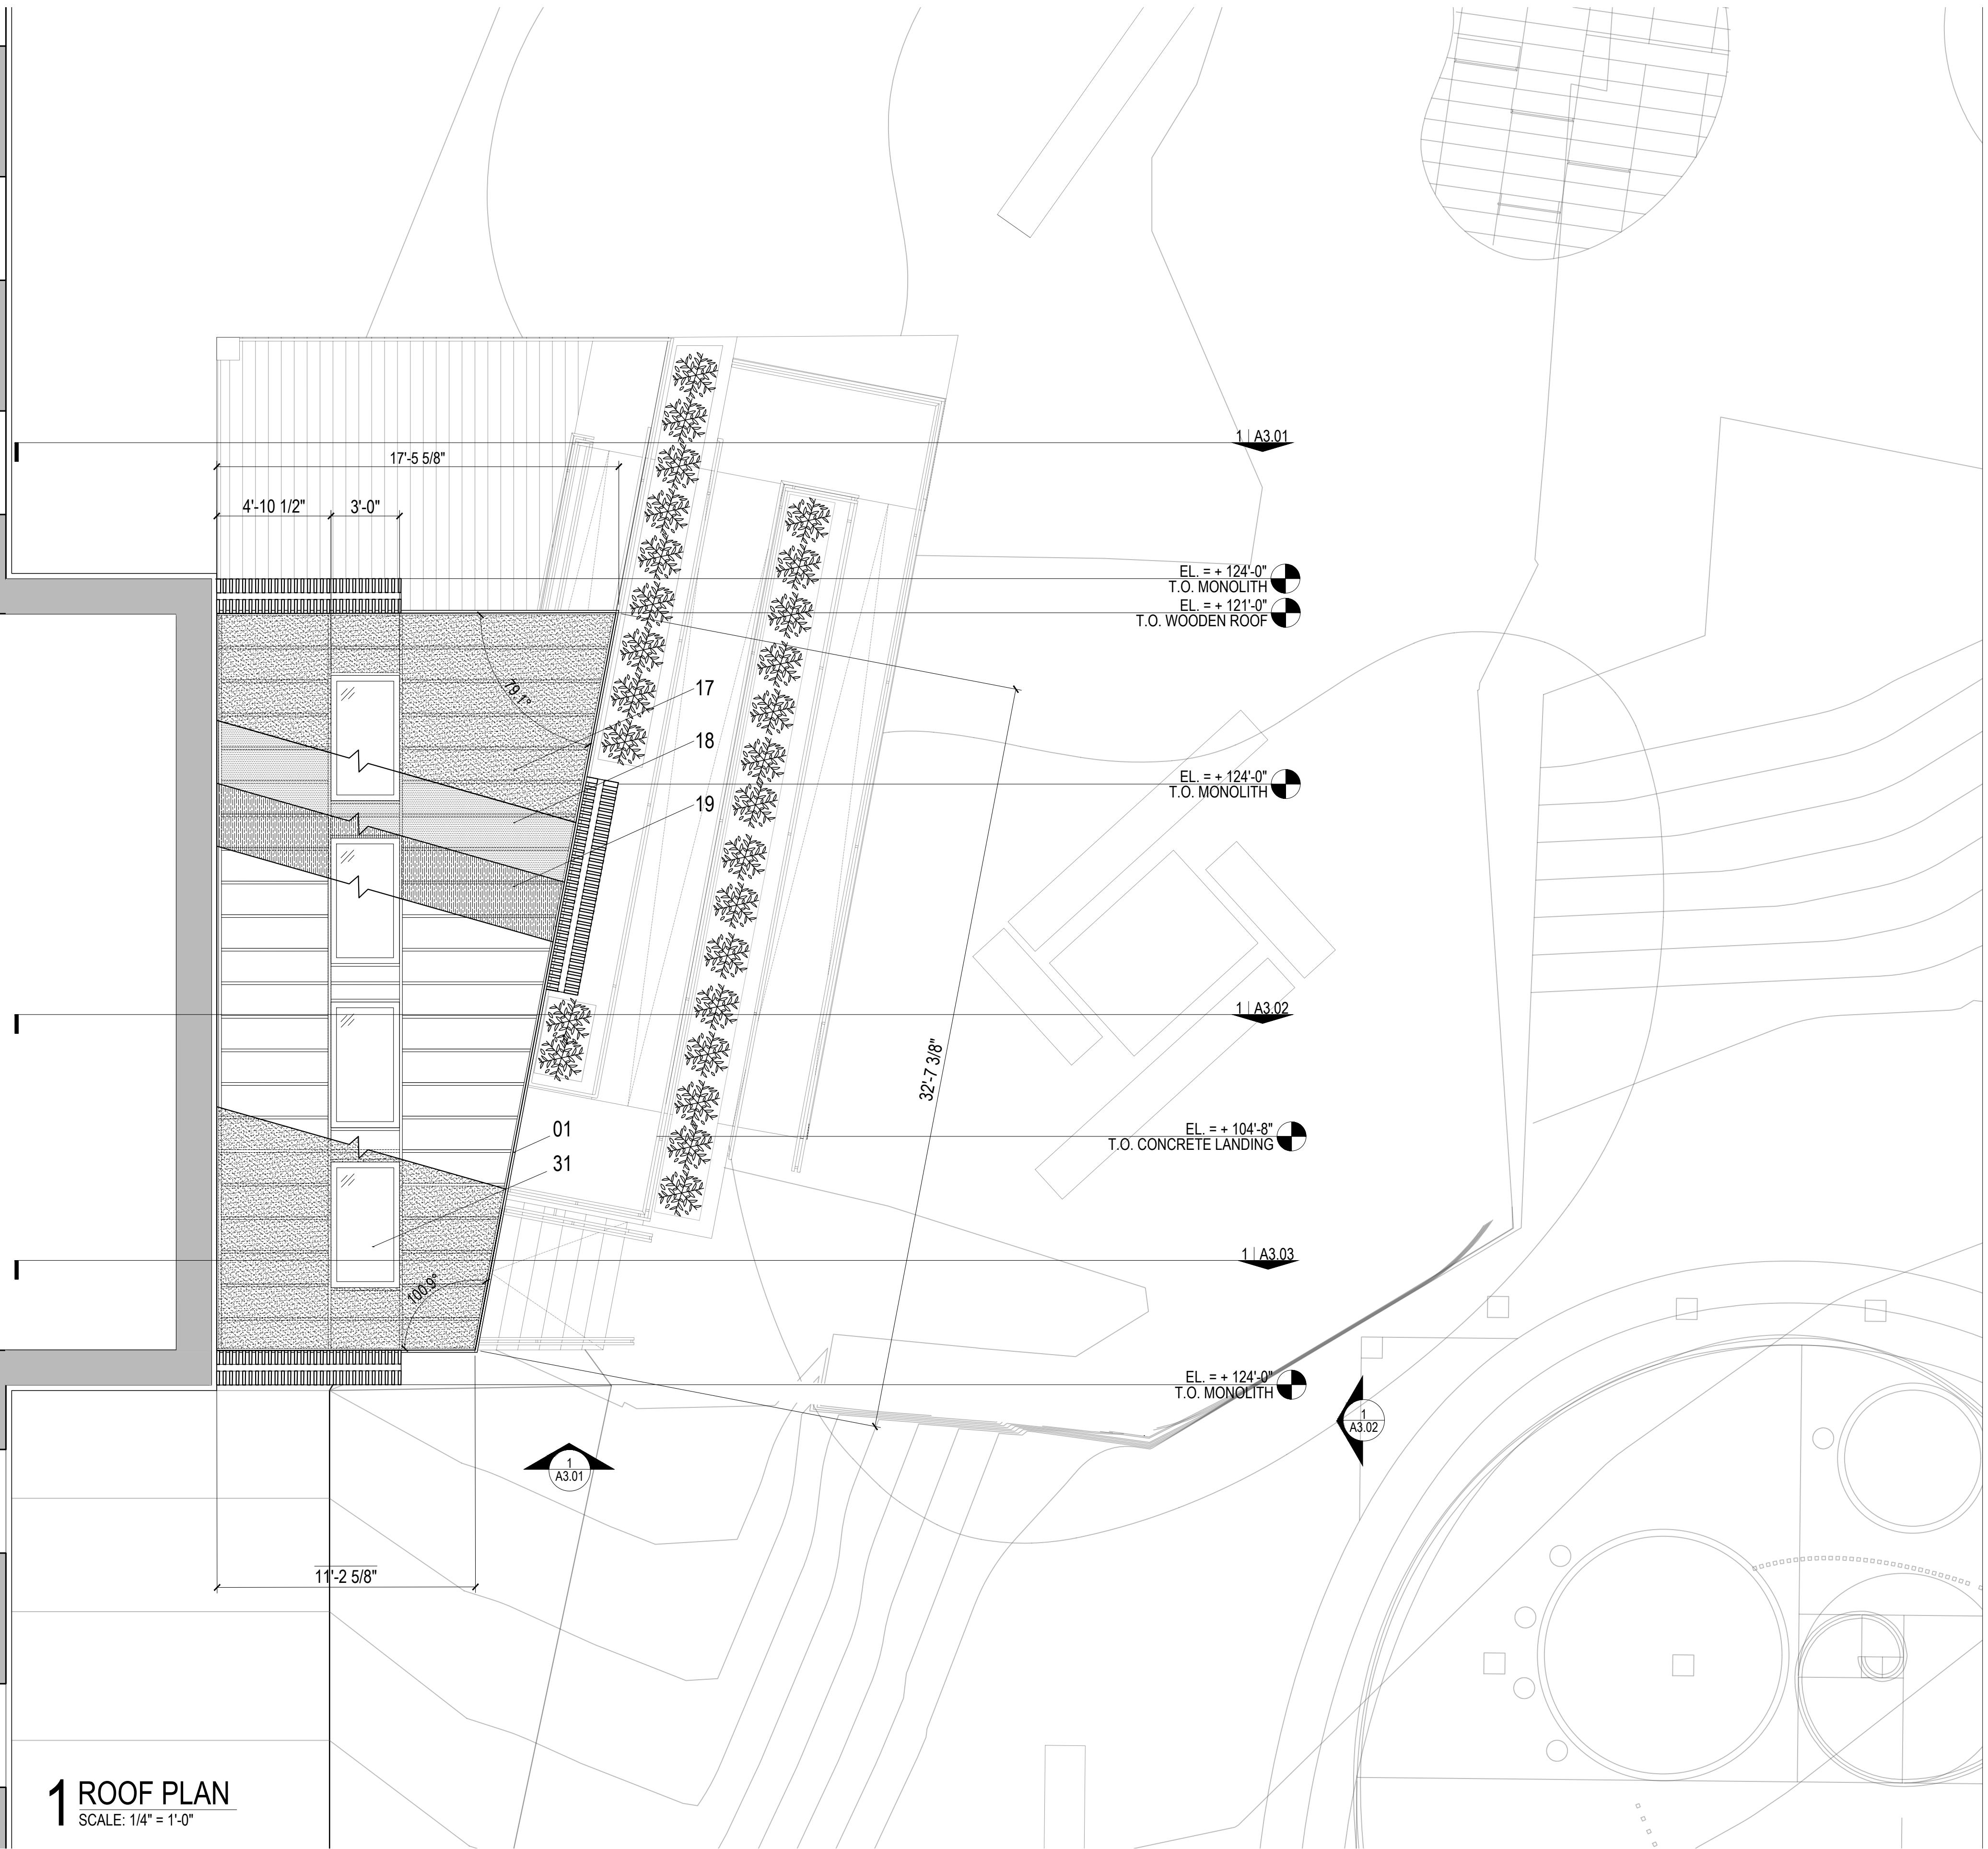
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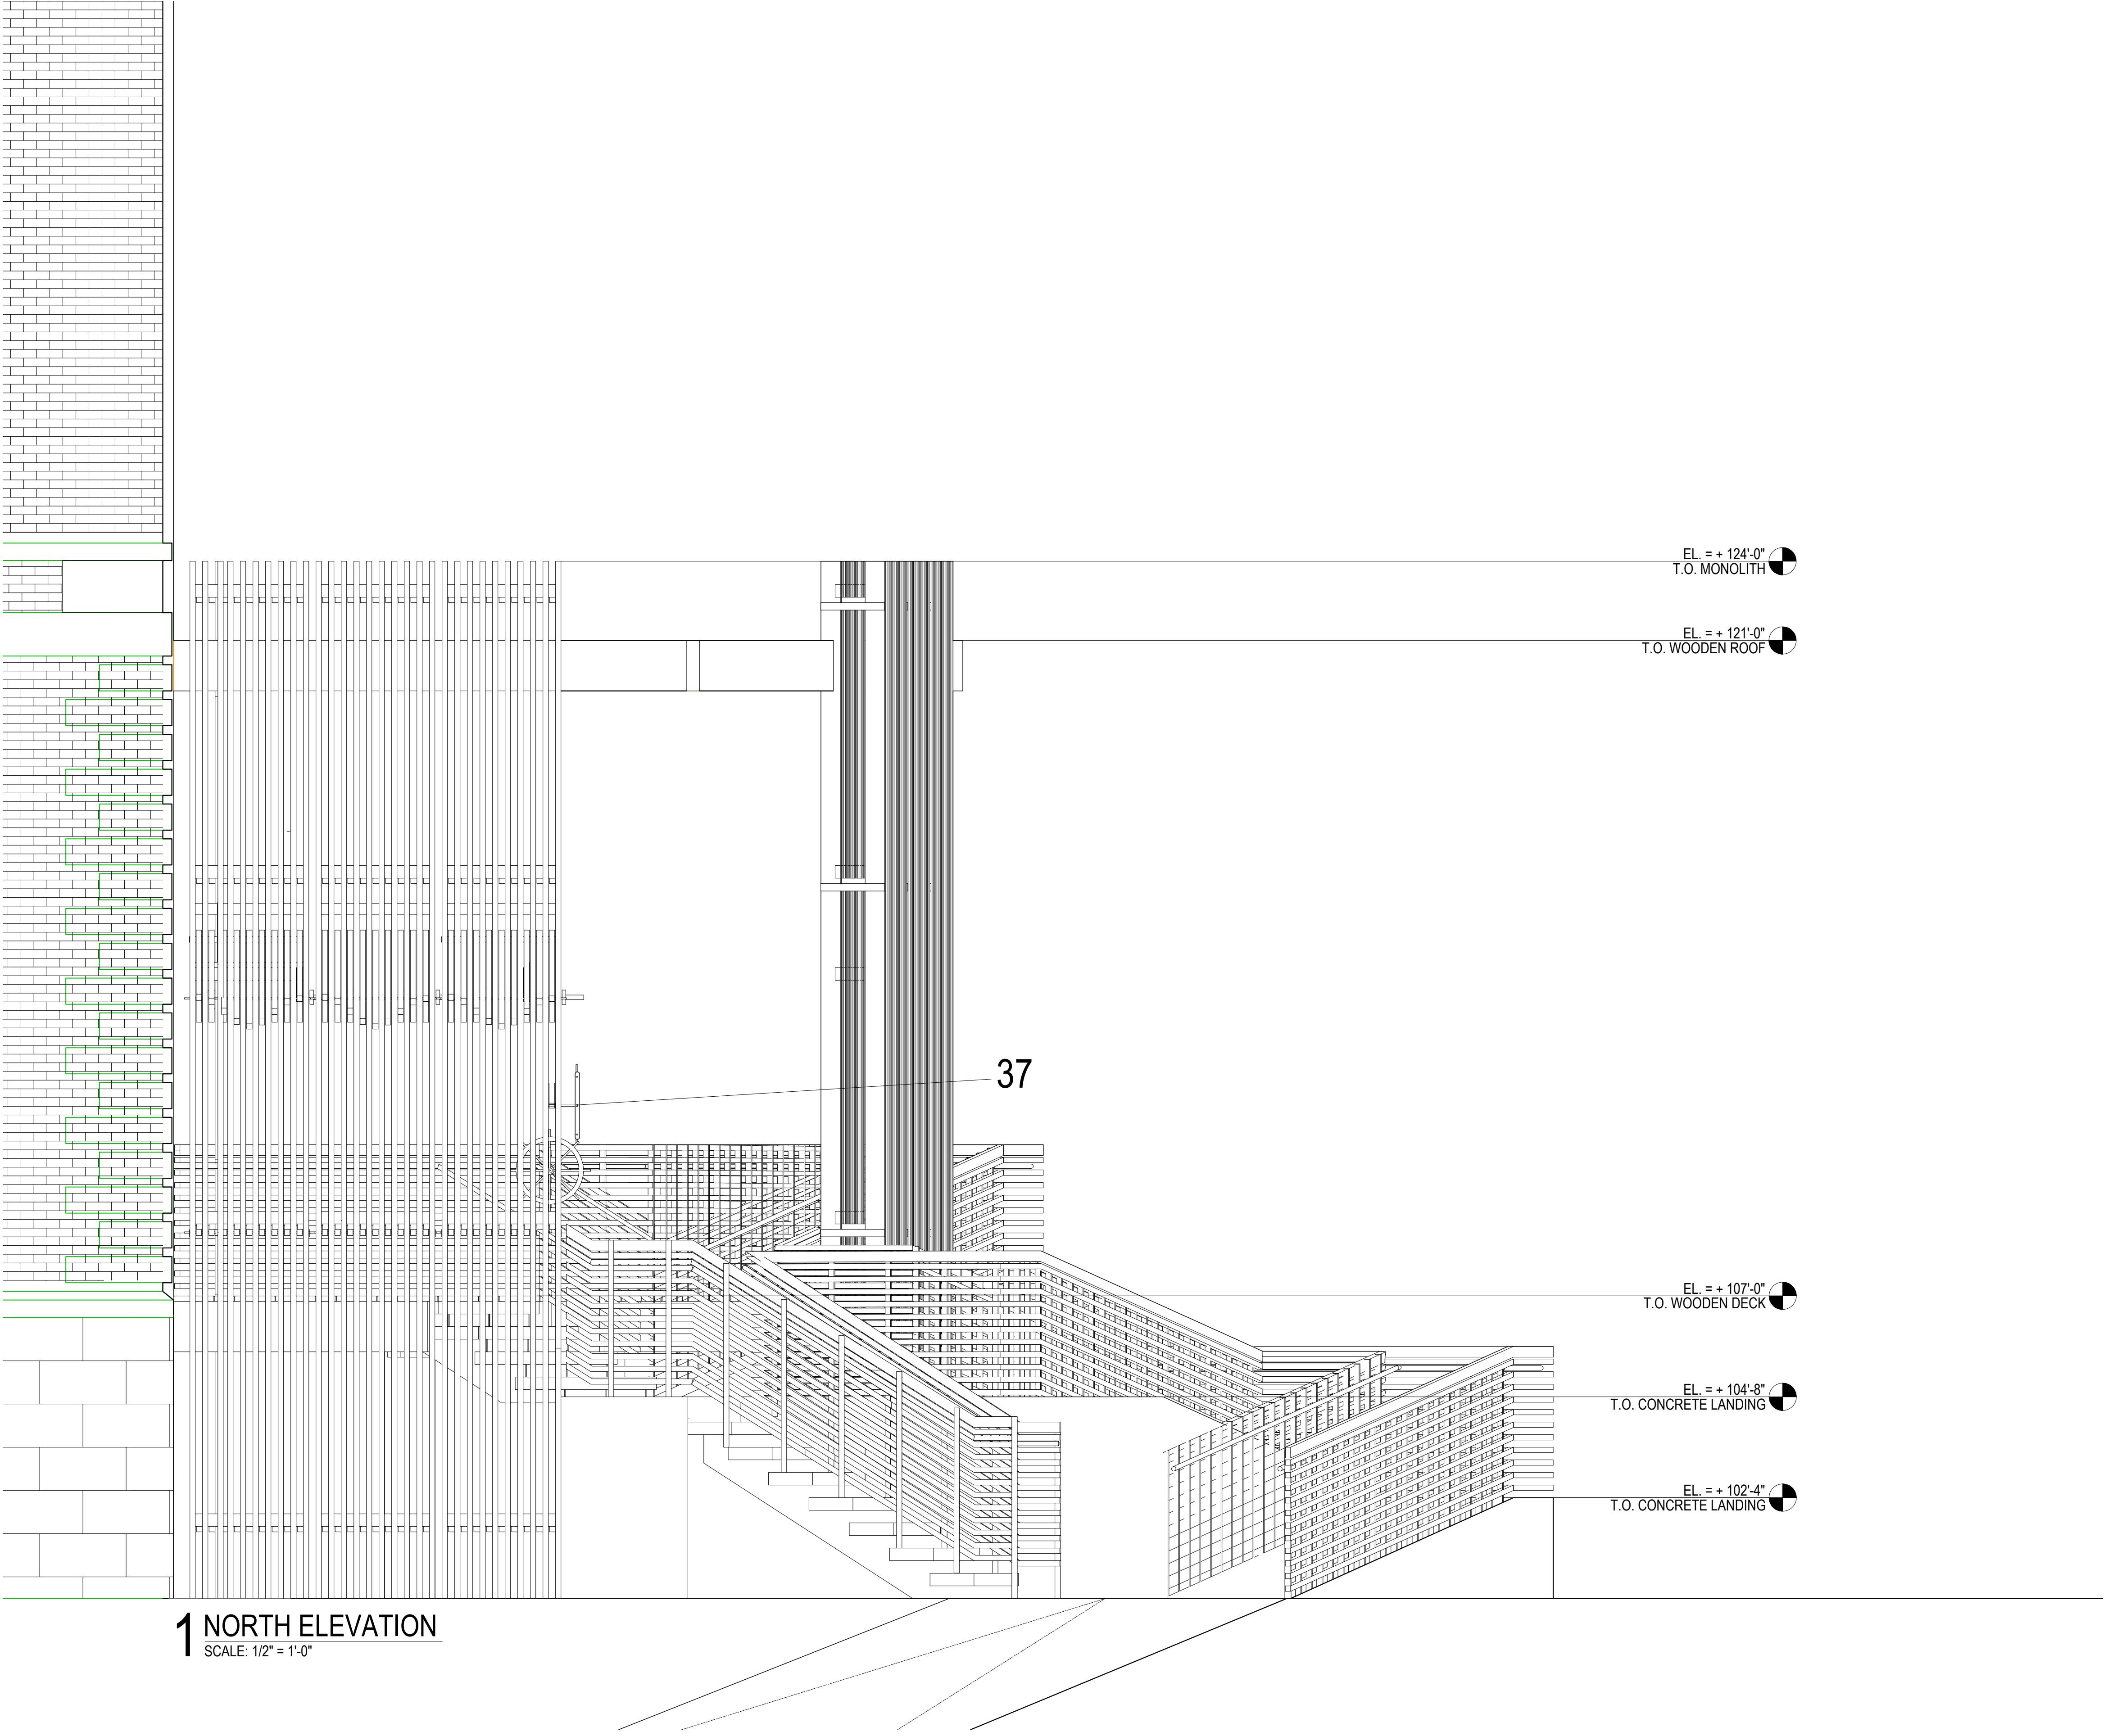
WOODHENGE

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A2.01
NORTH ELEVATION

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1 NORTH ELEVATION
SCALE: 1/2" = 1'-0"



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1 DECEMBER
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F O R
R E V I E W

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A2.02
WEST ELEVATION

07 OF 22



WOODHENGE COMMUNITY FORCE

1256 FRANKLIN AVE.
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A3.01
SECTION DRAWING 1

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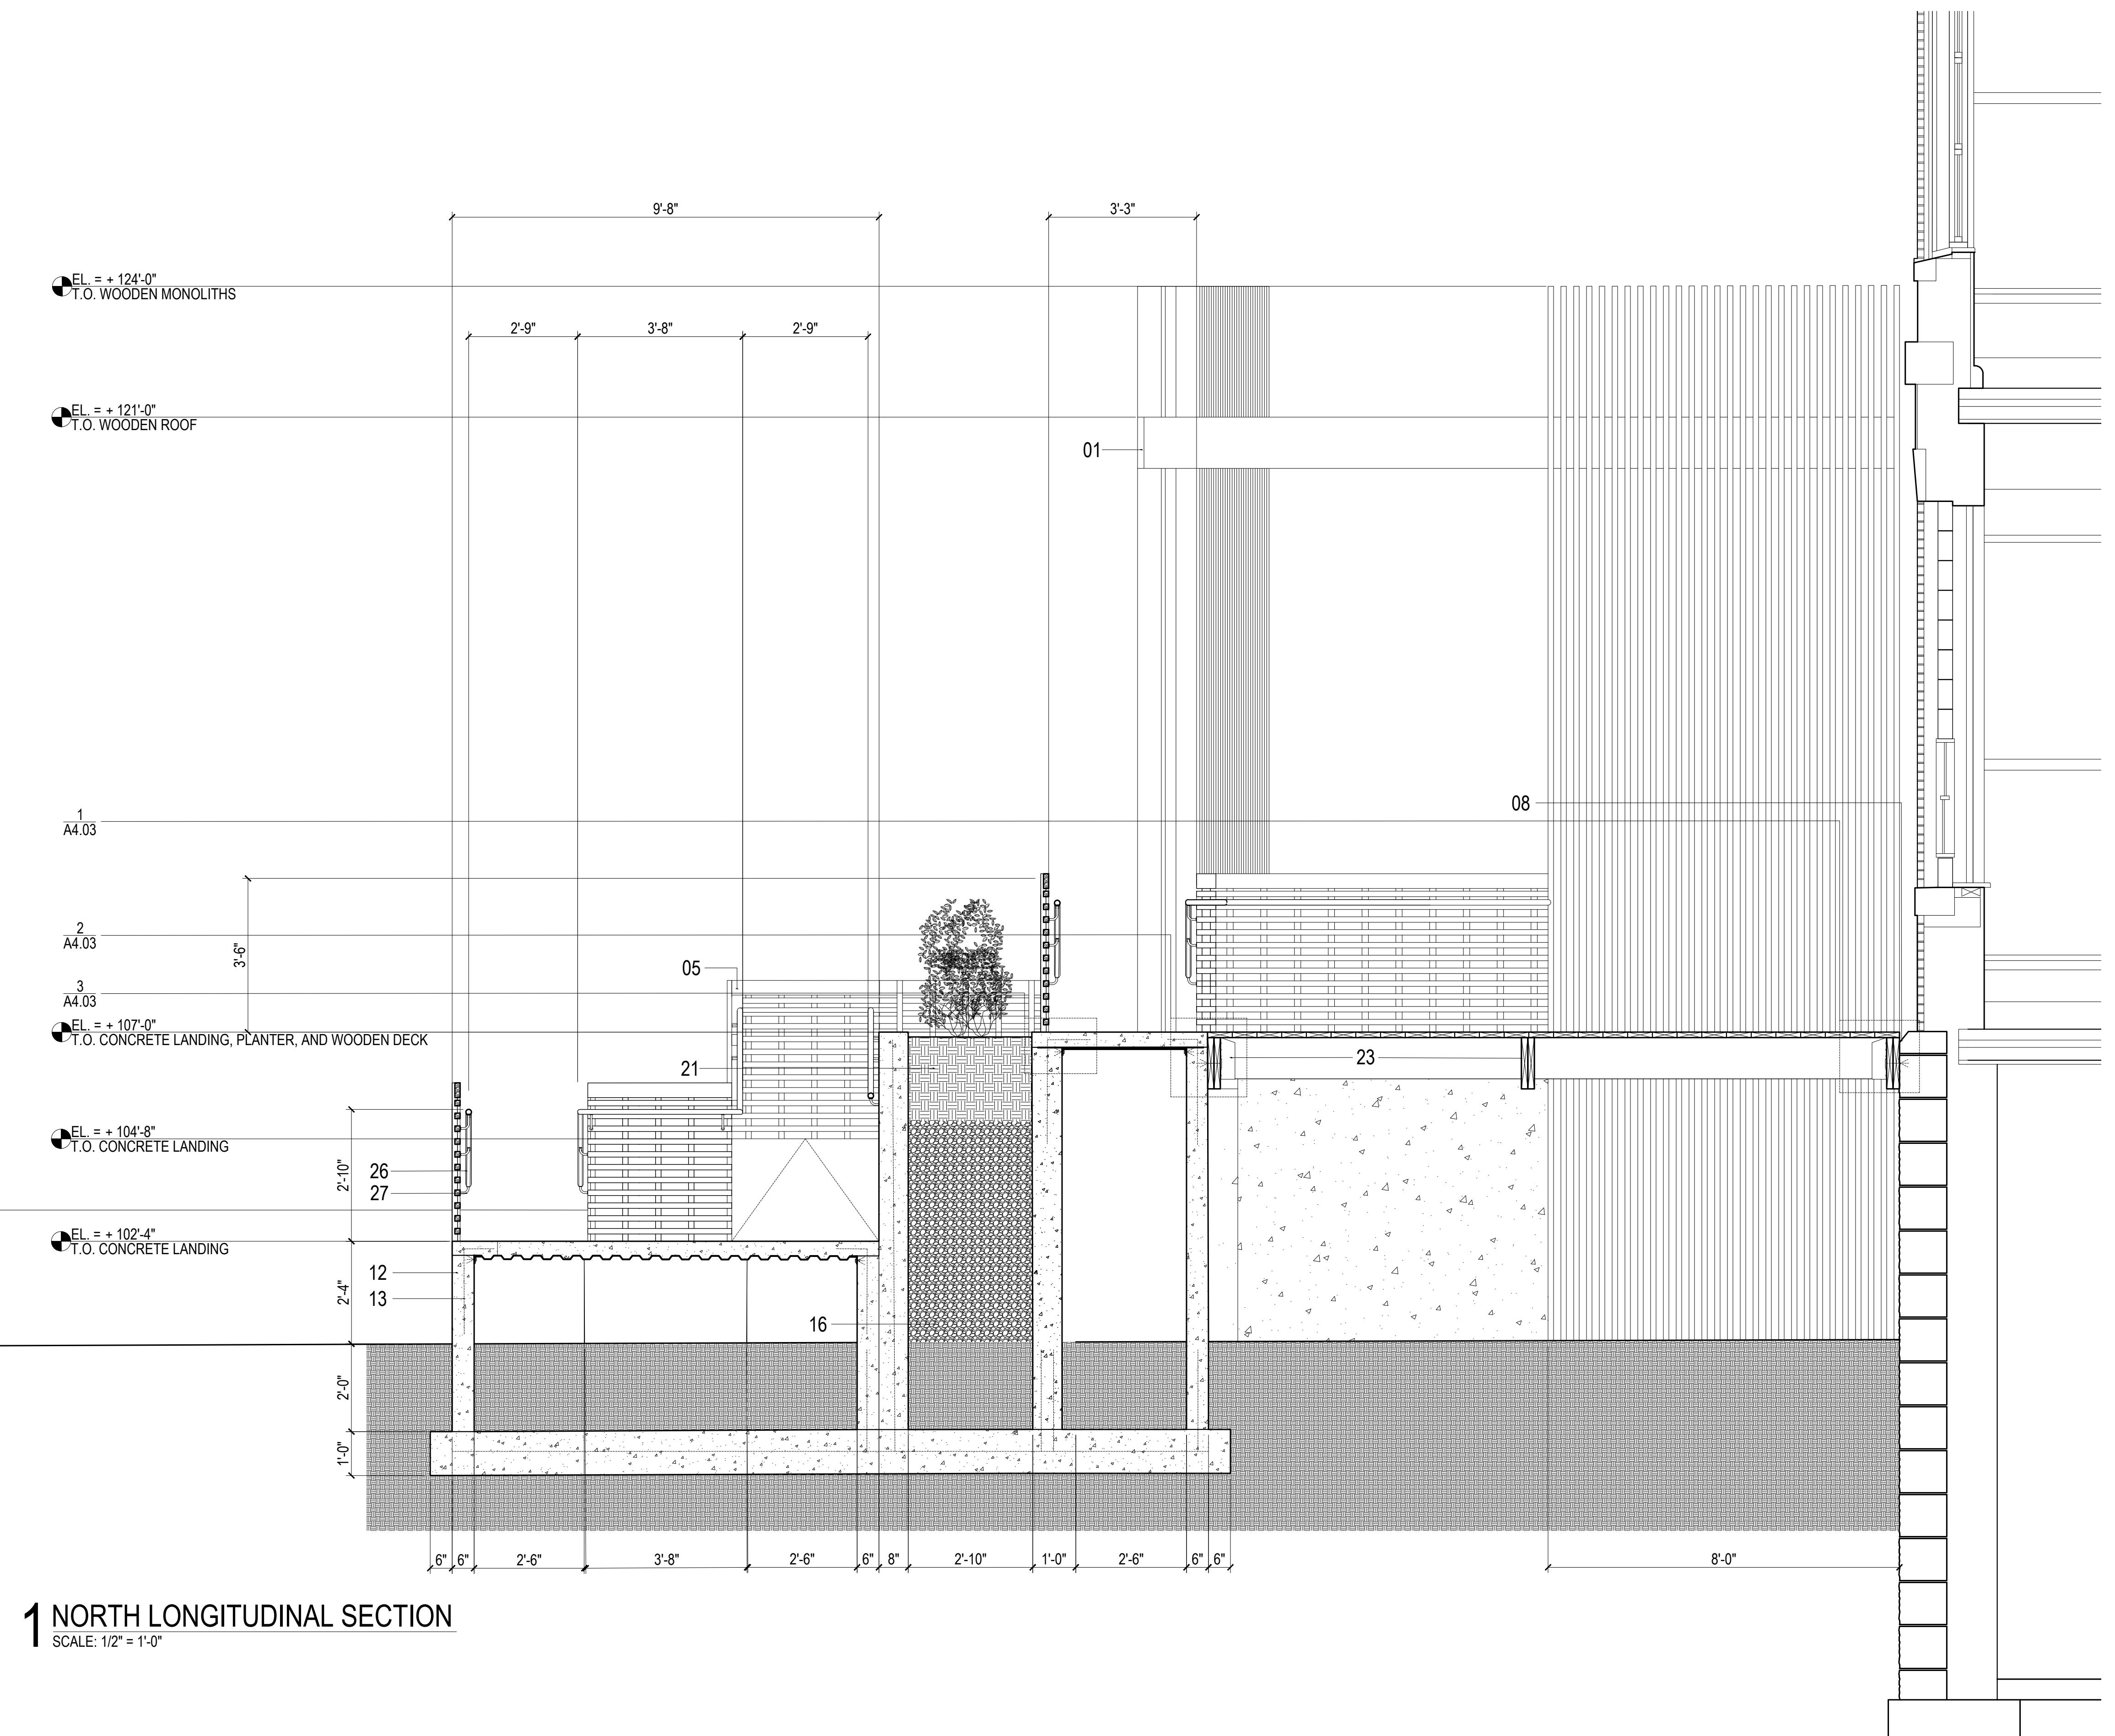
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DRAWN BY:
KYLE BANCROFT
TAKUMI DAVIS
TAYLOR LATIMER

1 DECEMBER
2019
F O R E V I E W

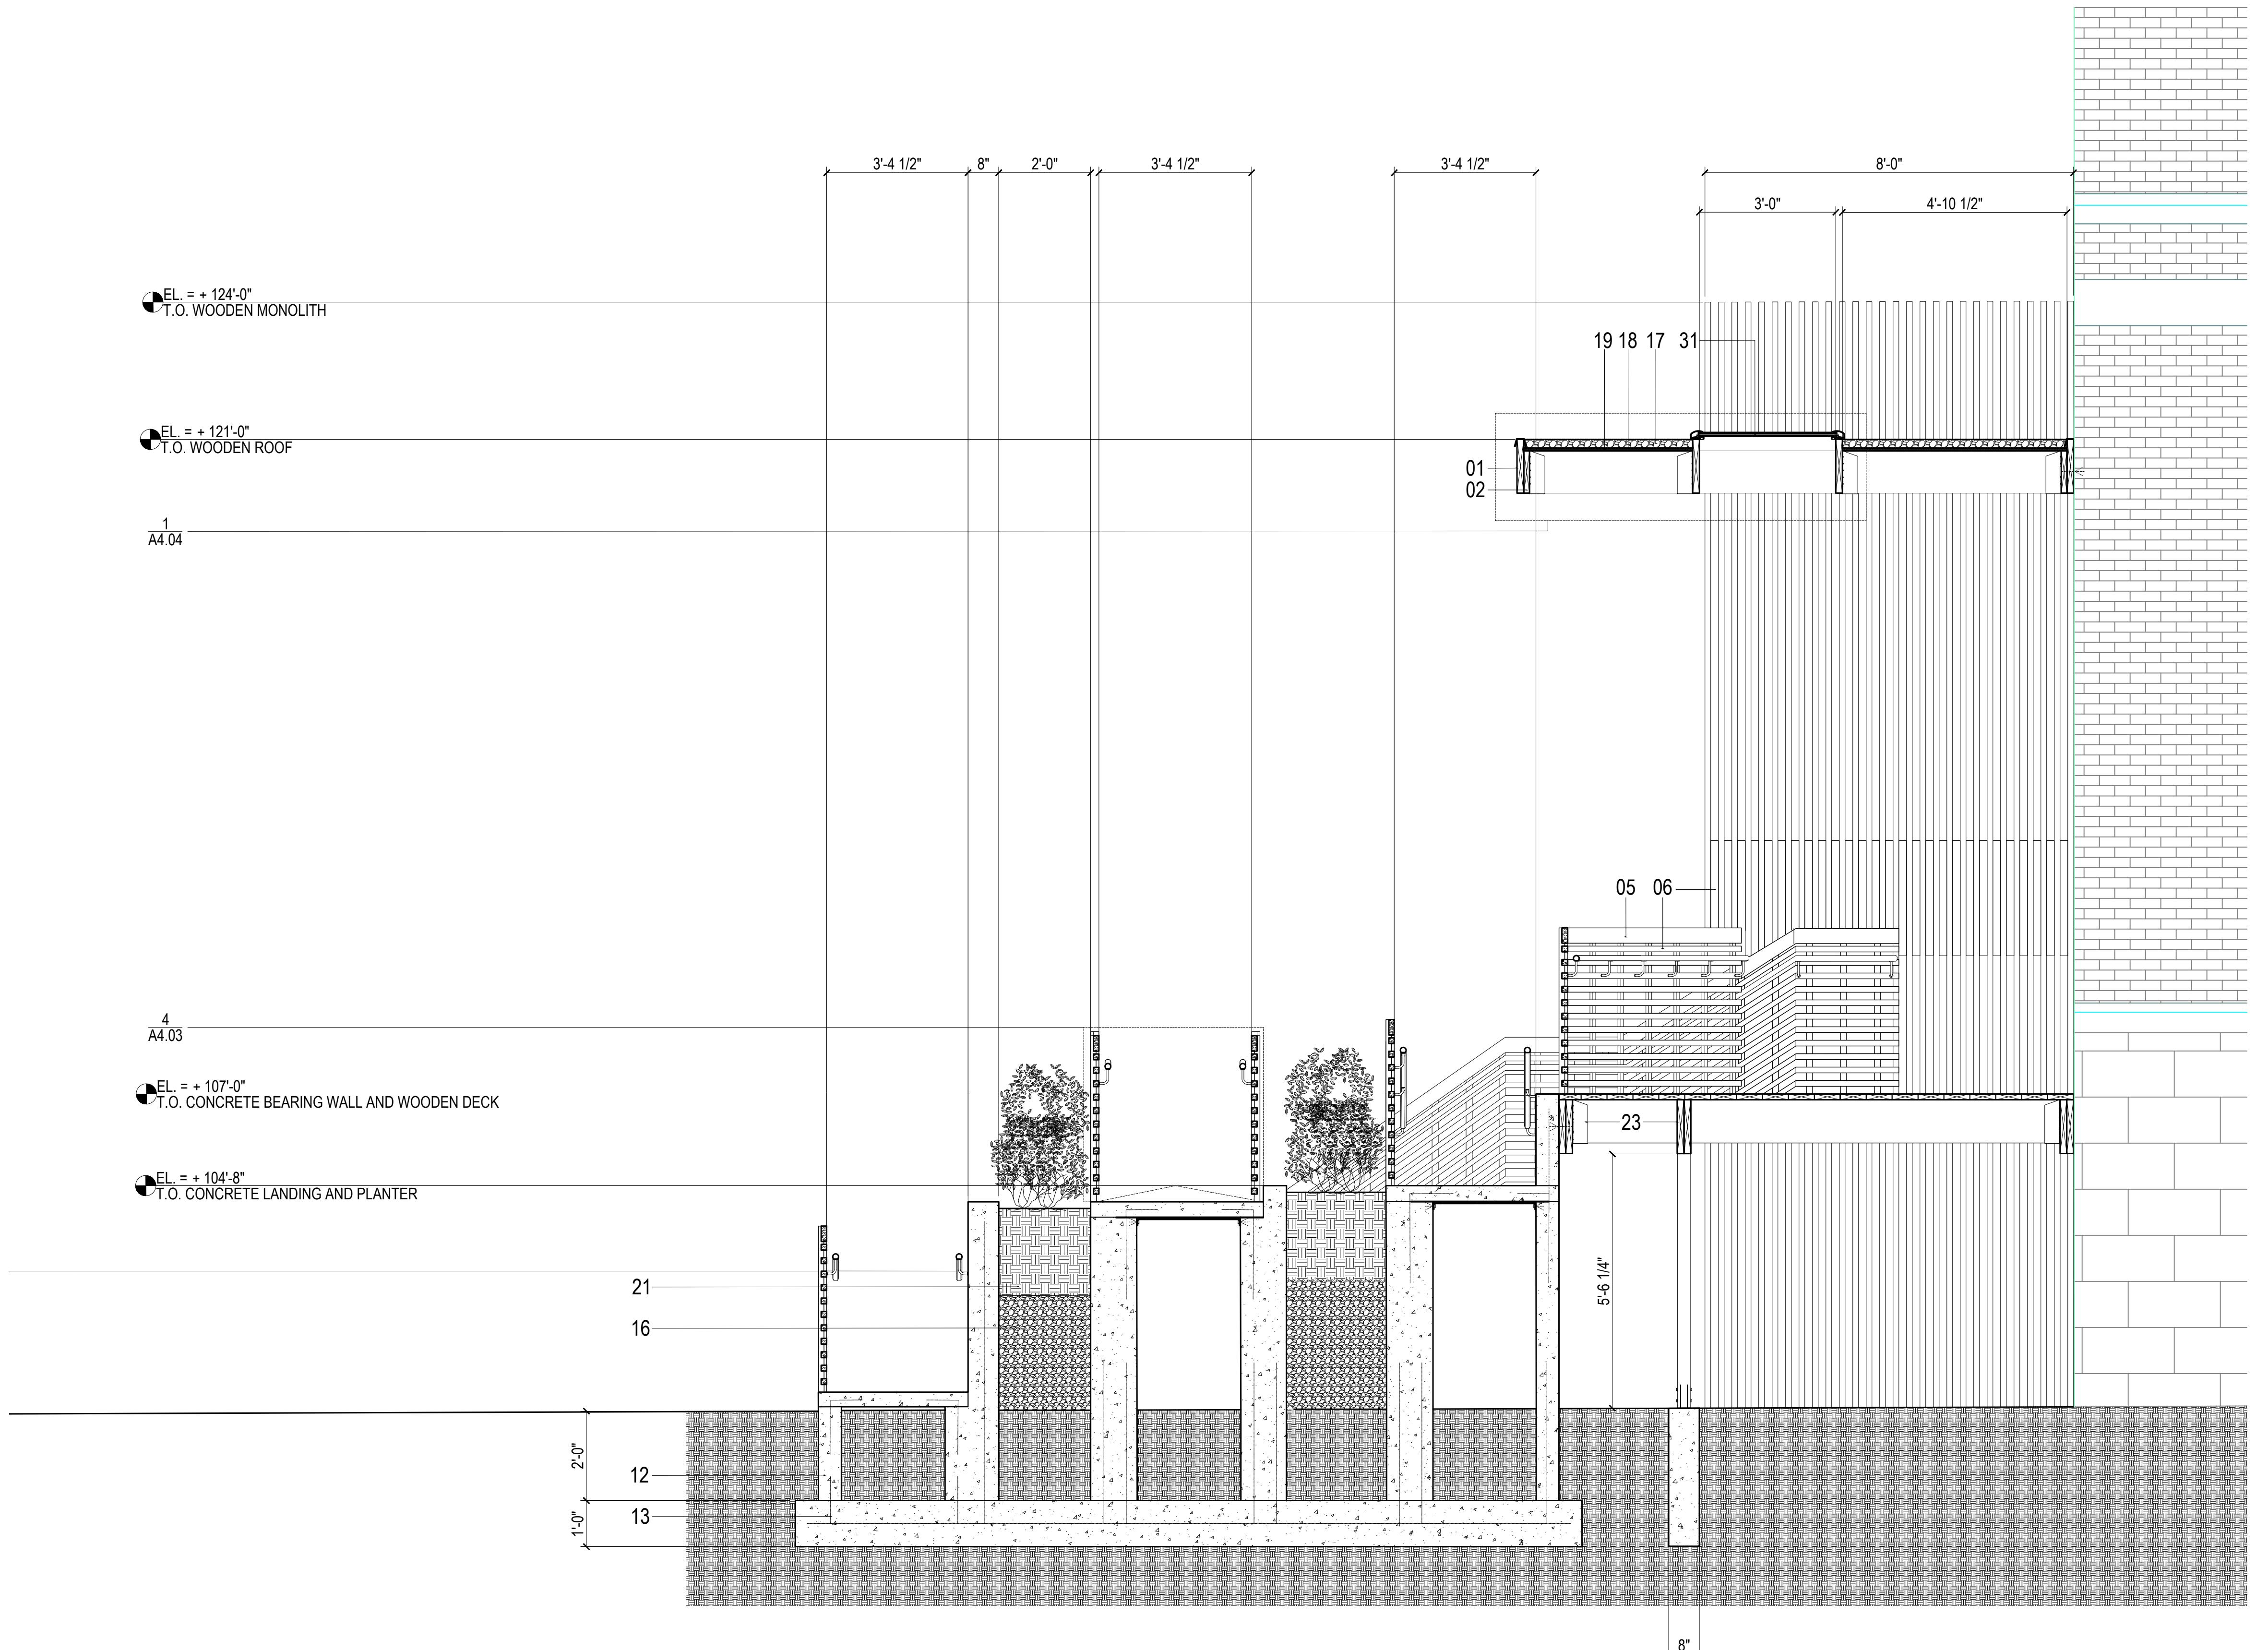


WOODHENGE

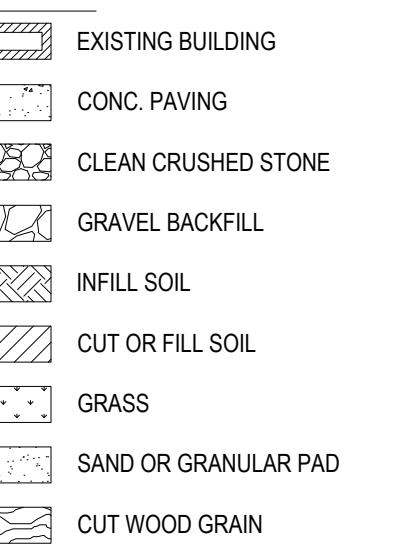
COMMUNITY FORCE
1256 FRANKLIN AVE.
WILKINSBURG, PA 15221

A3.02
SECTION DRAWING 2

09 OF 22



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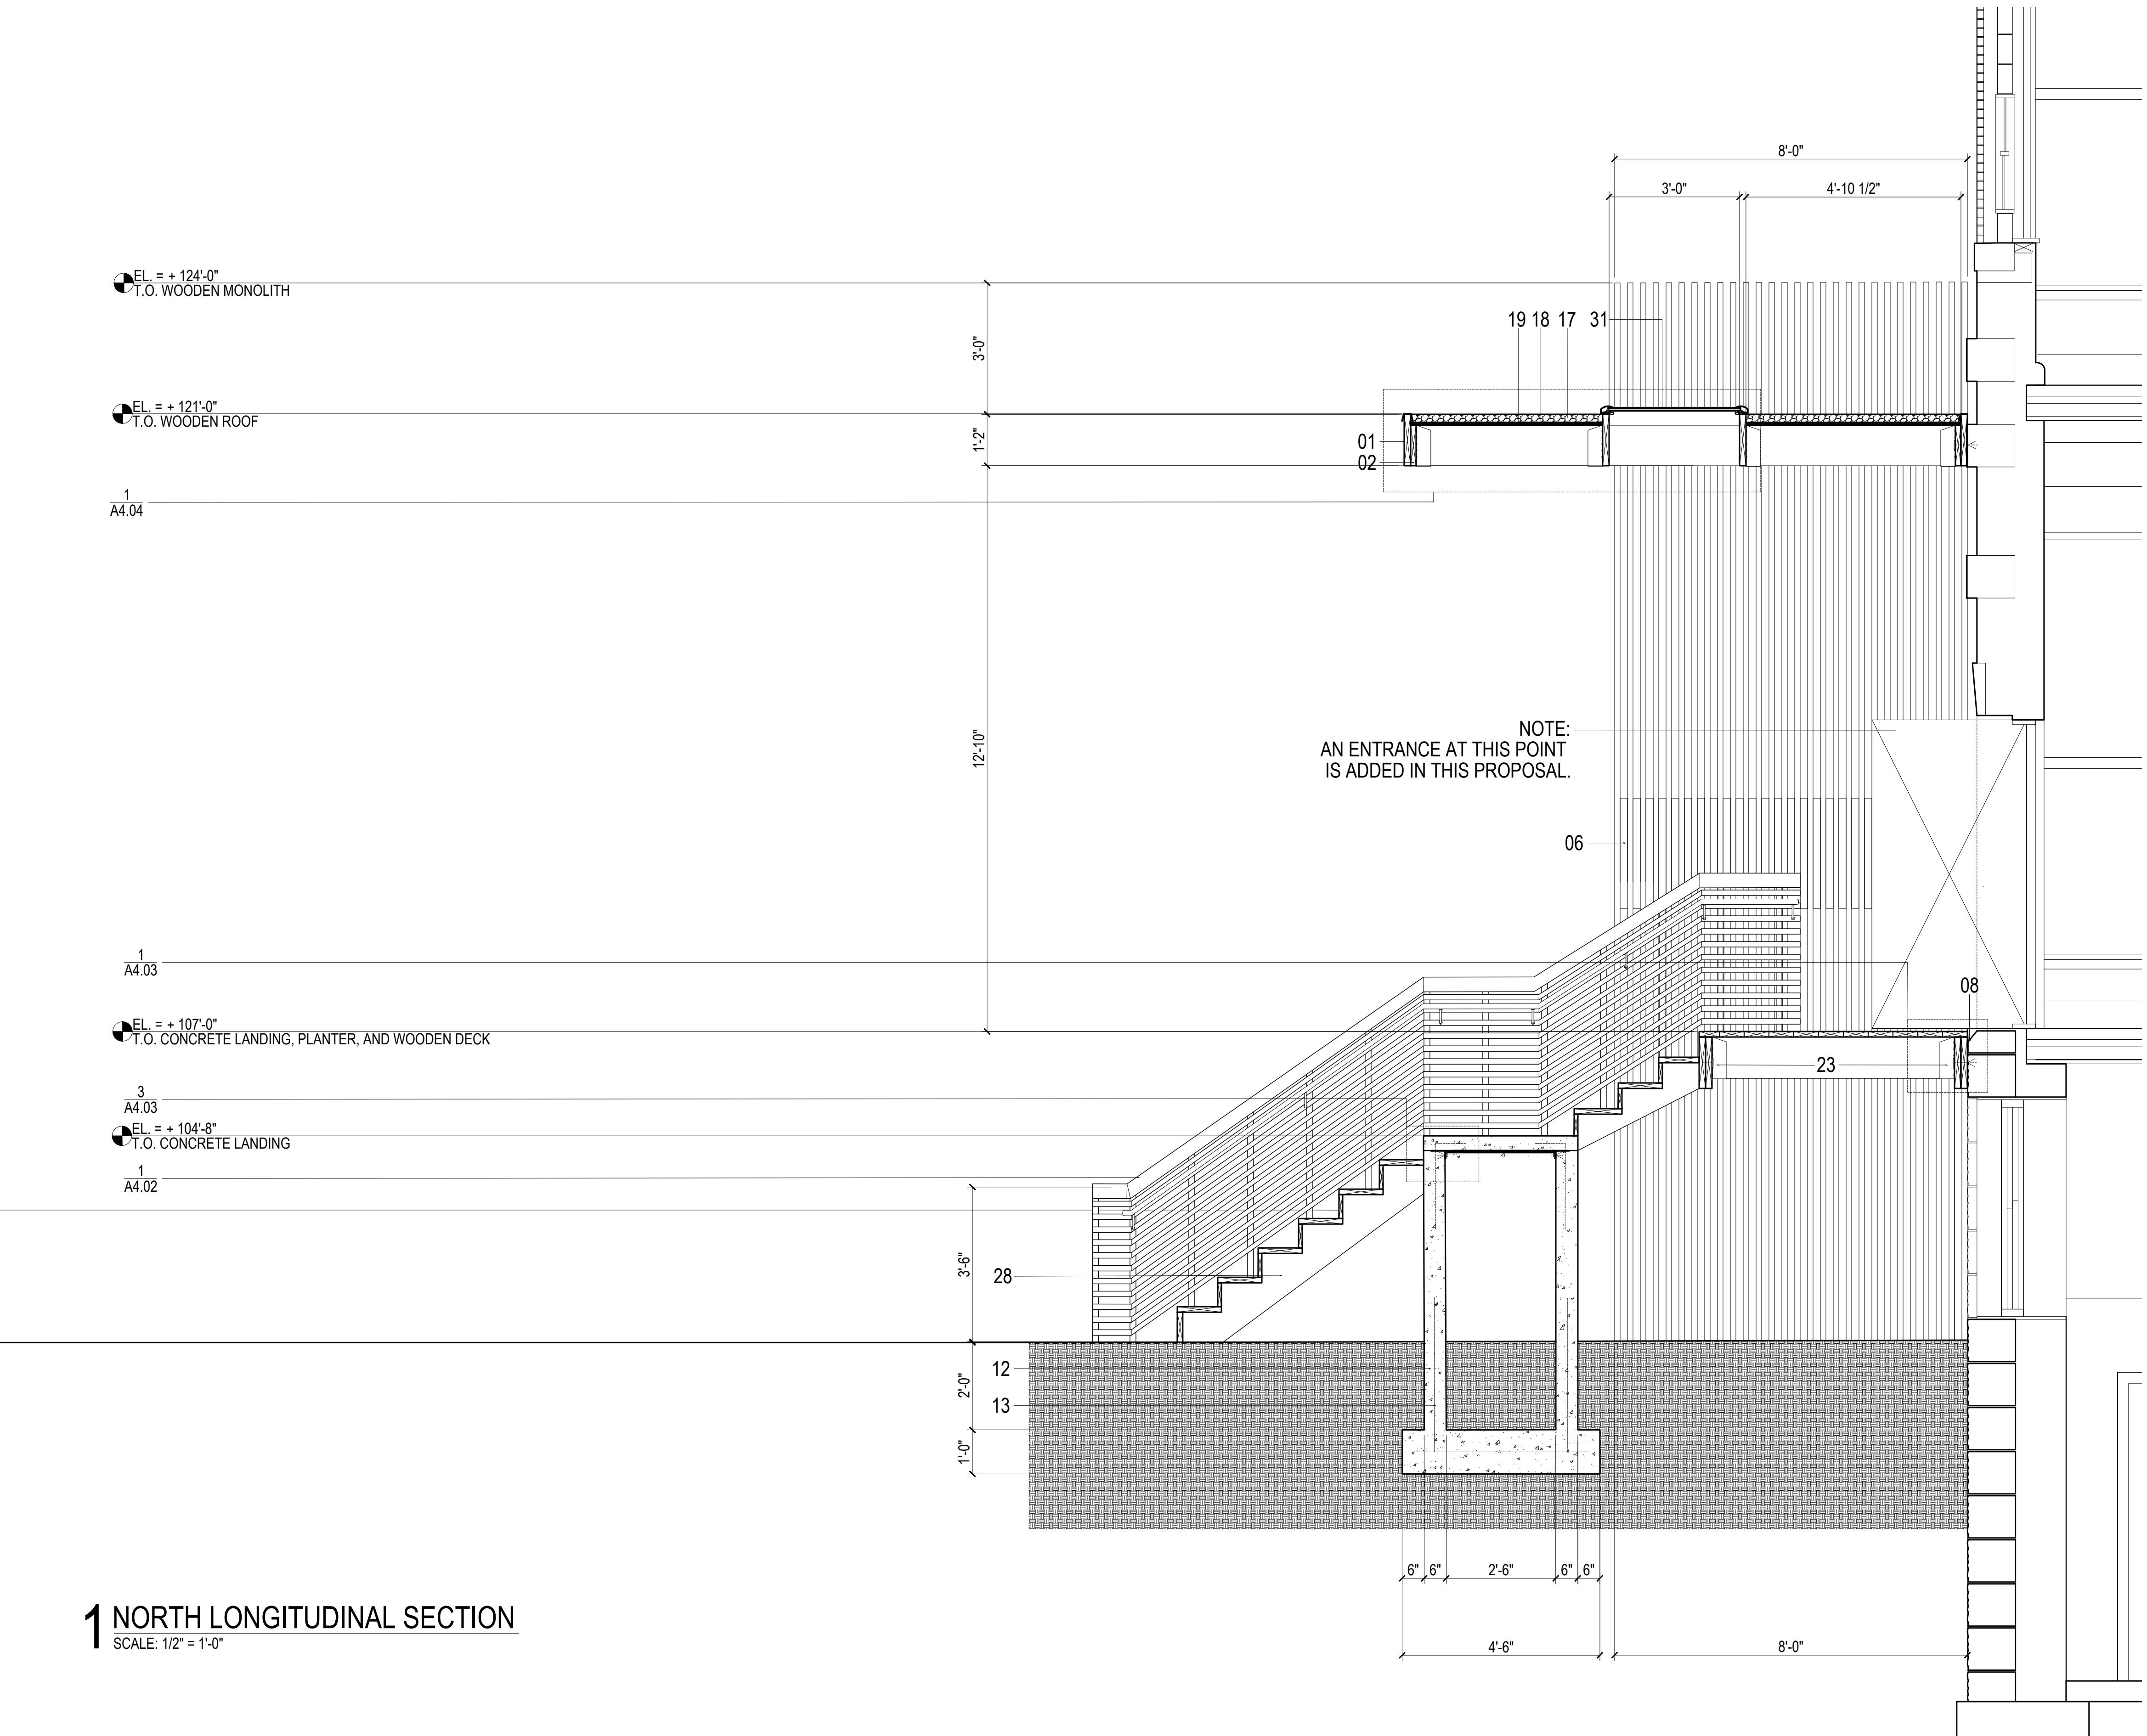
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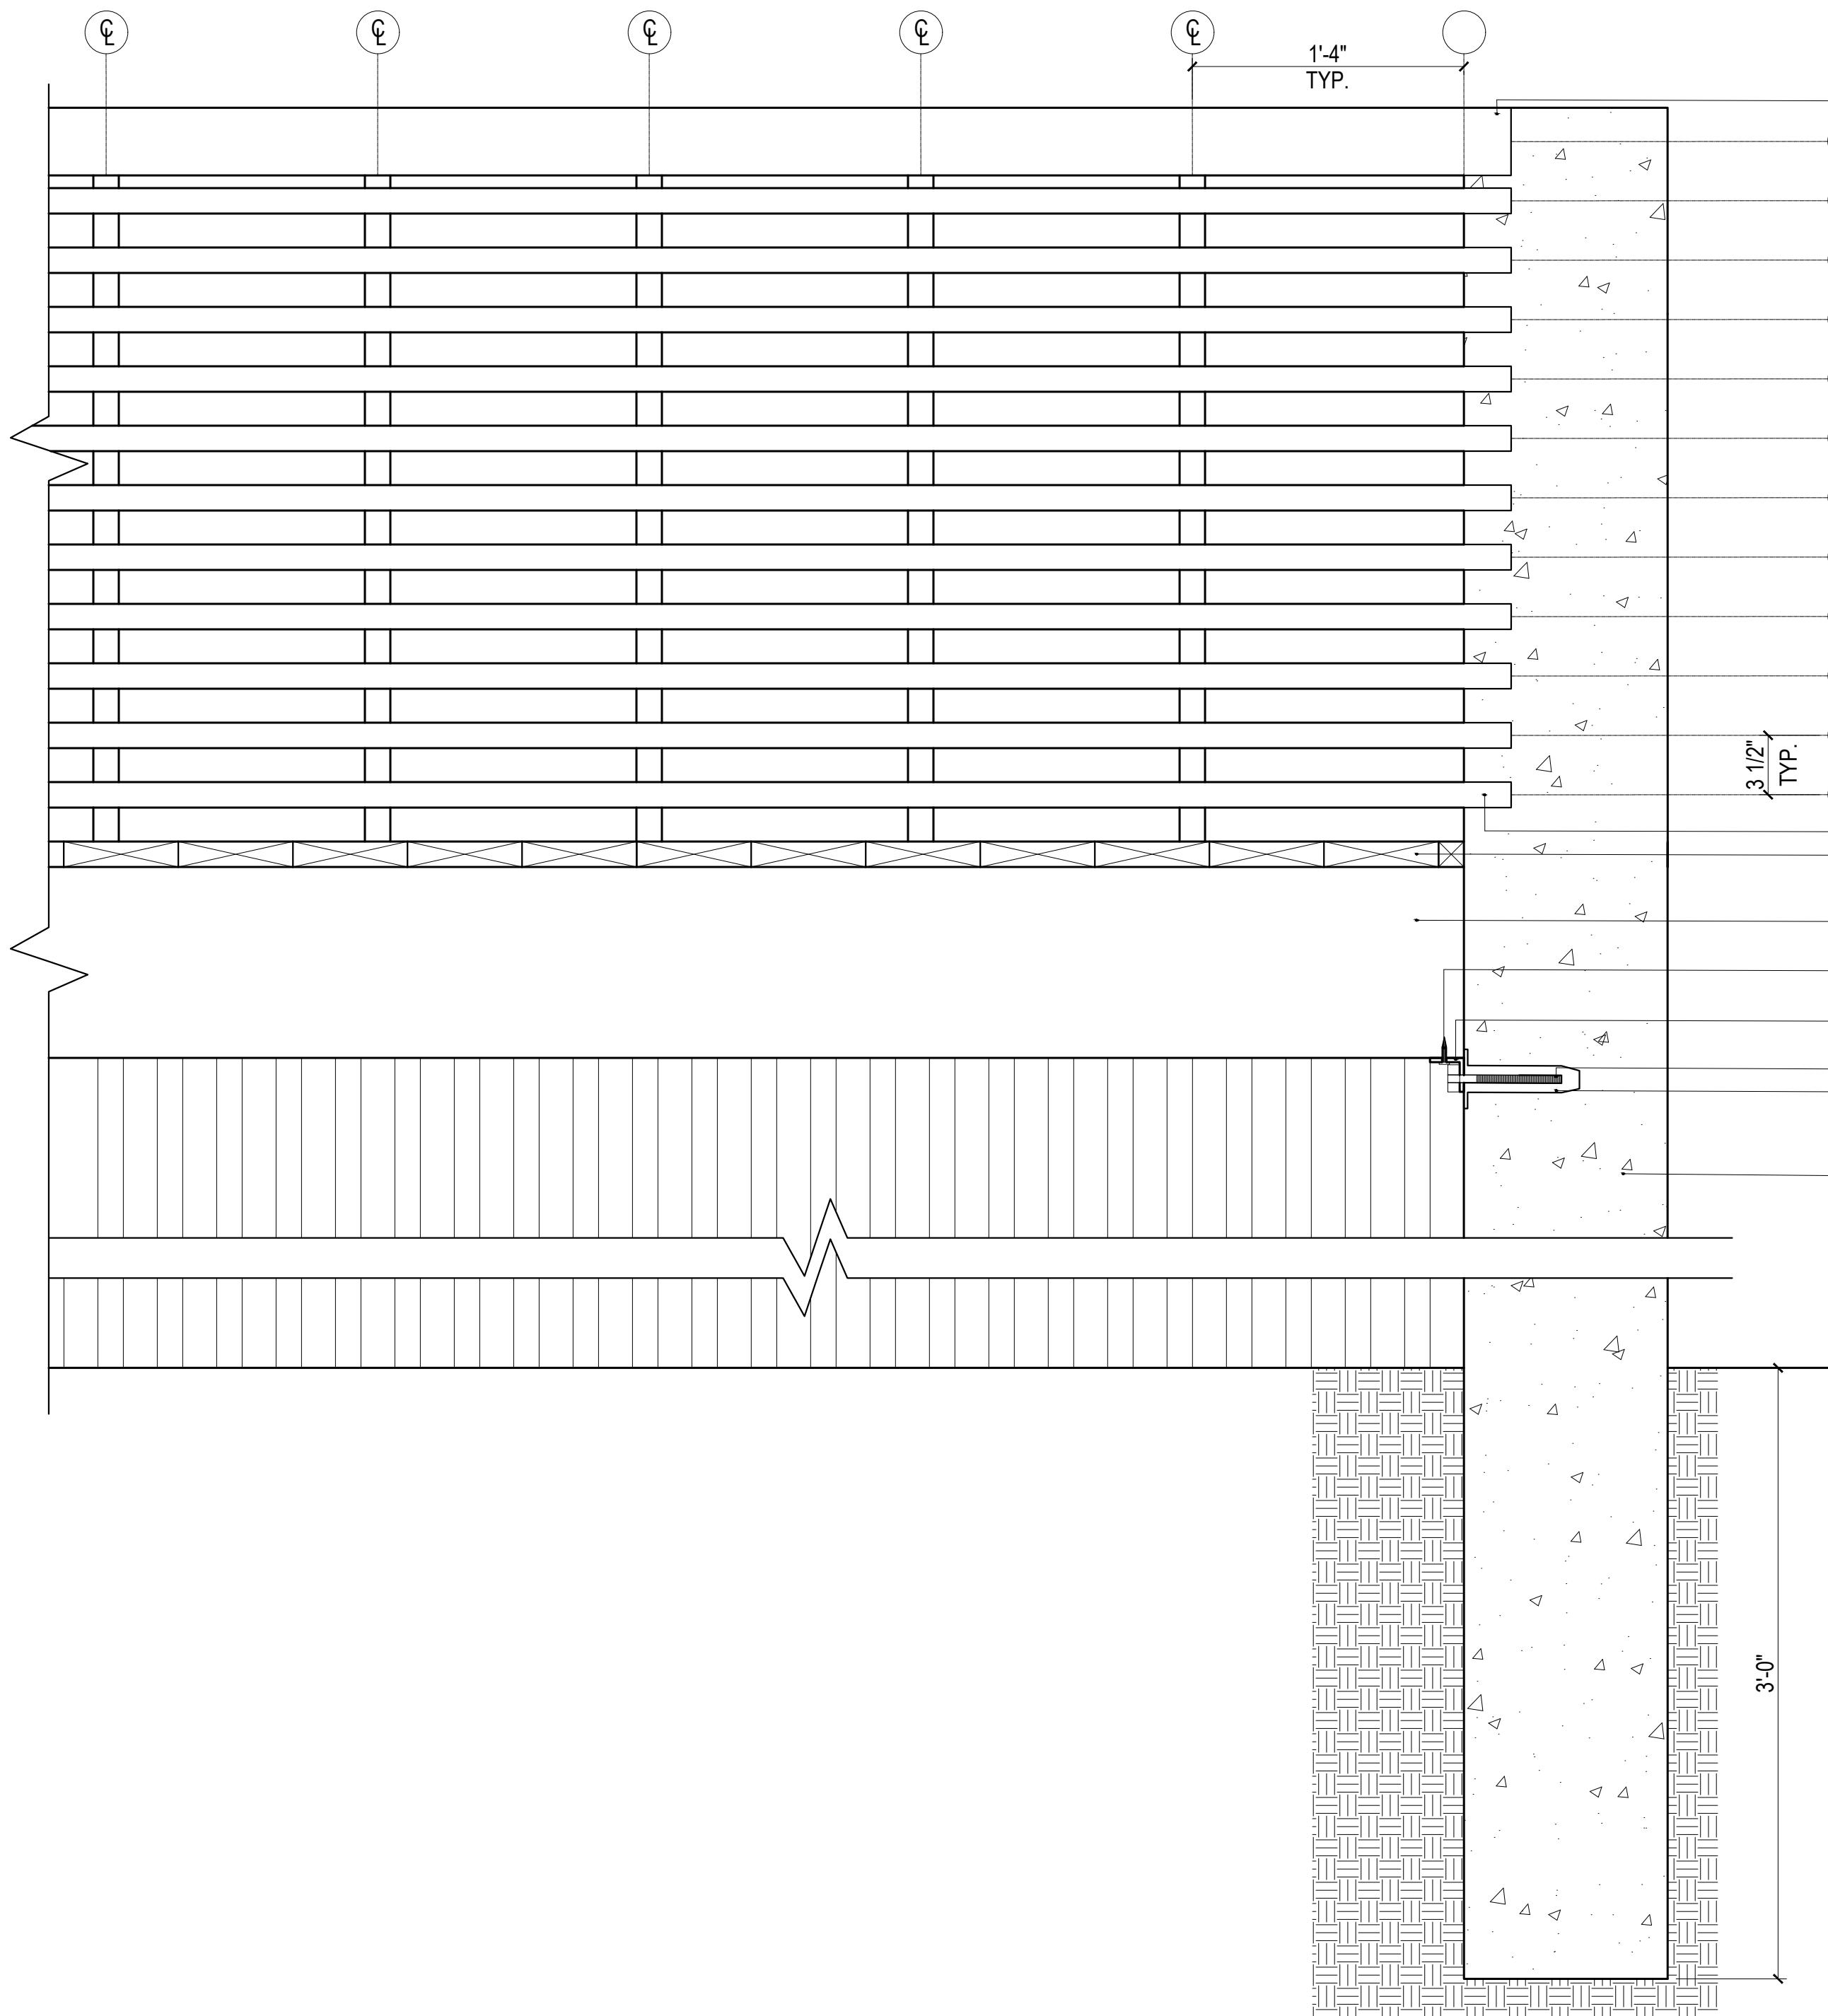
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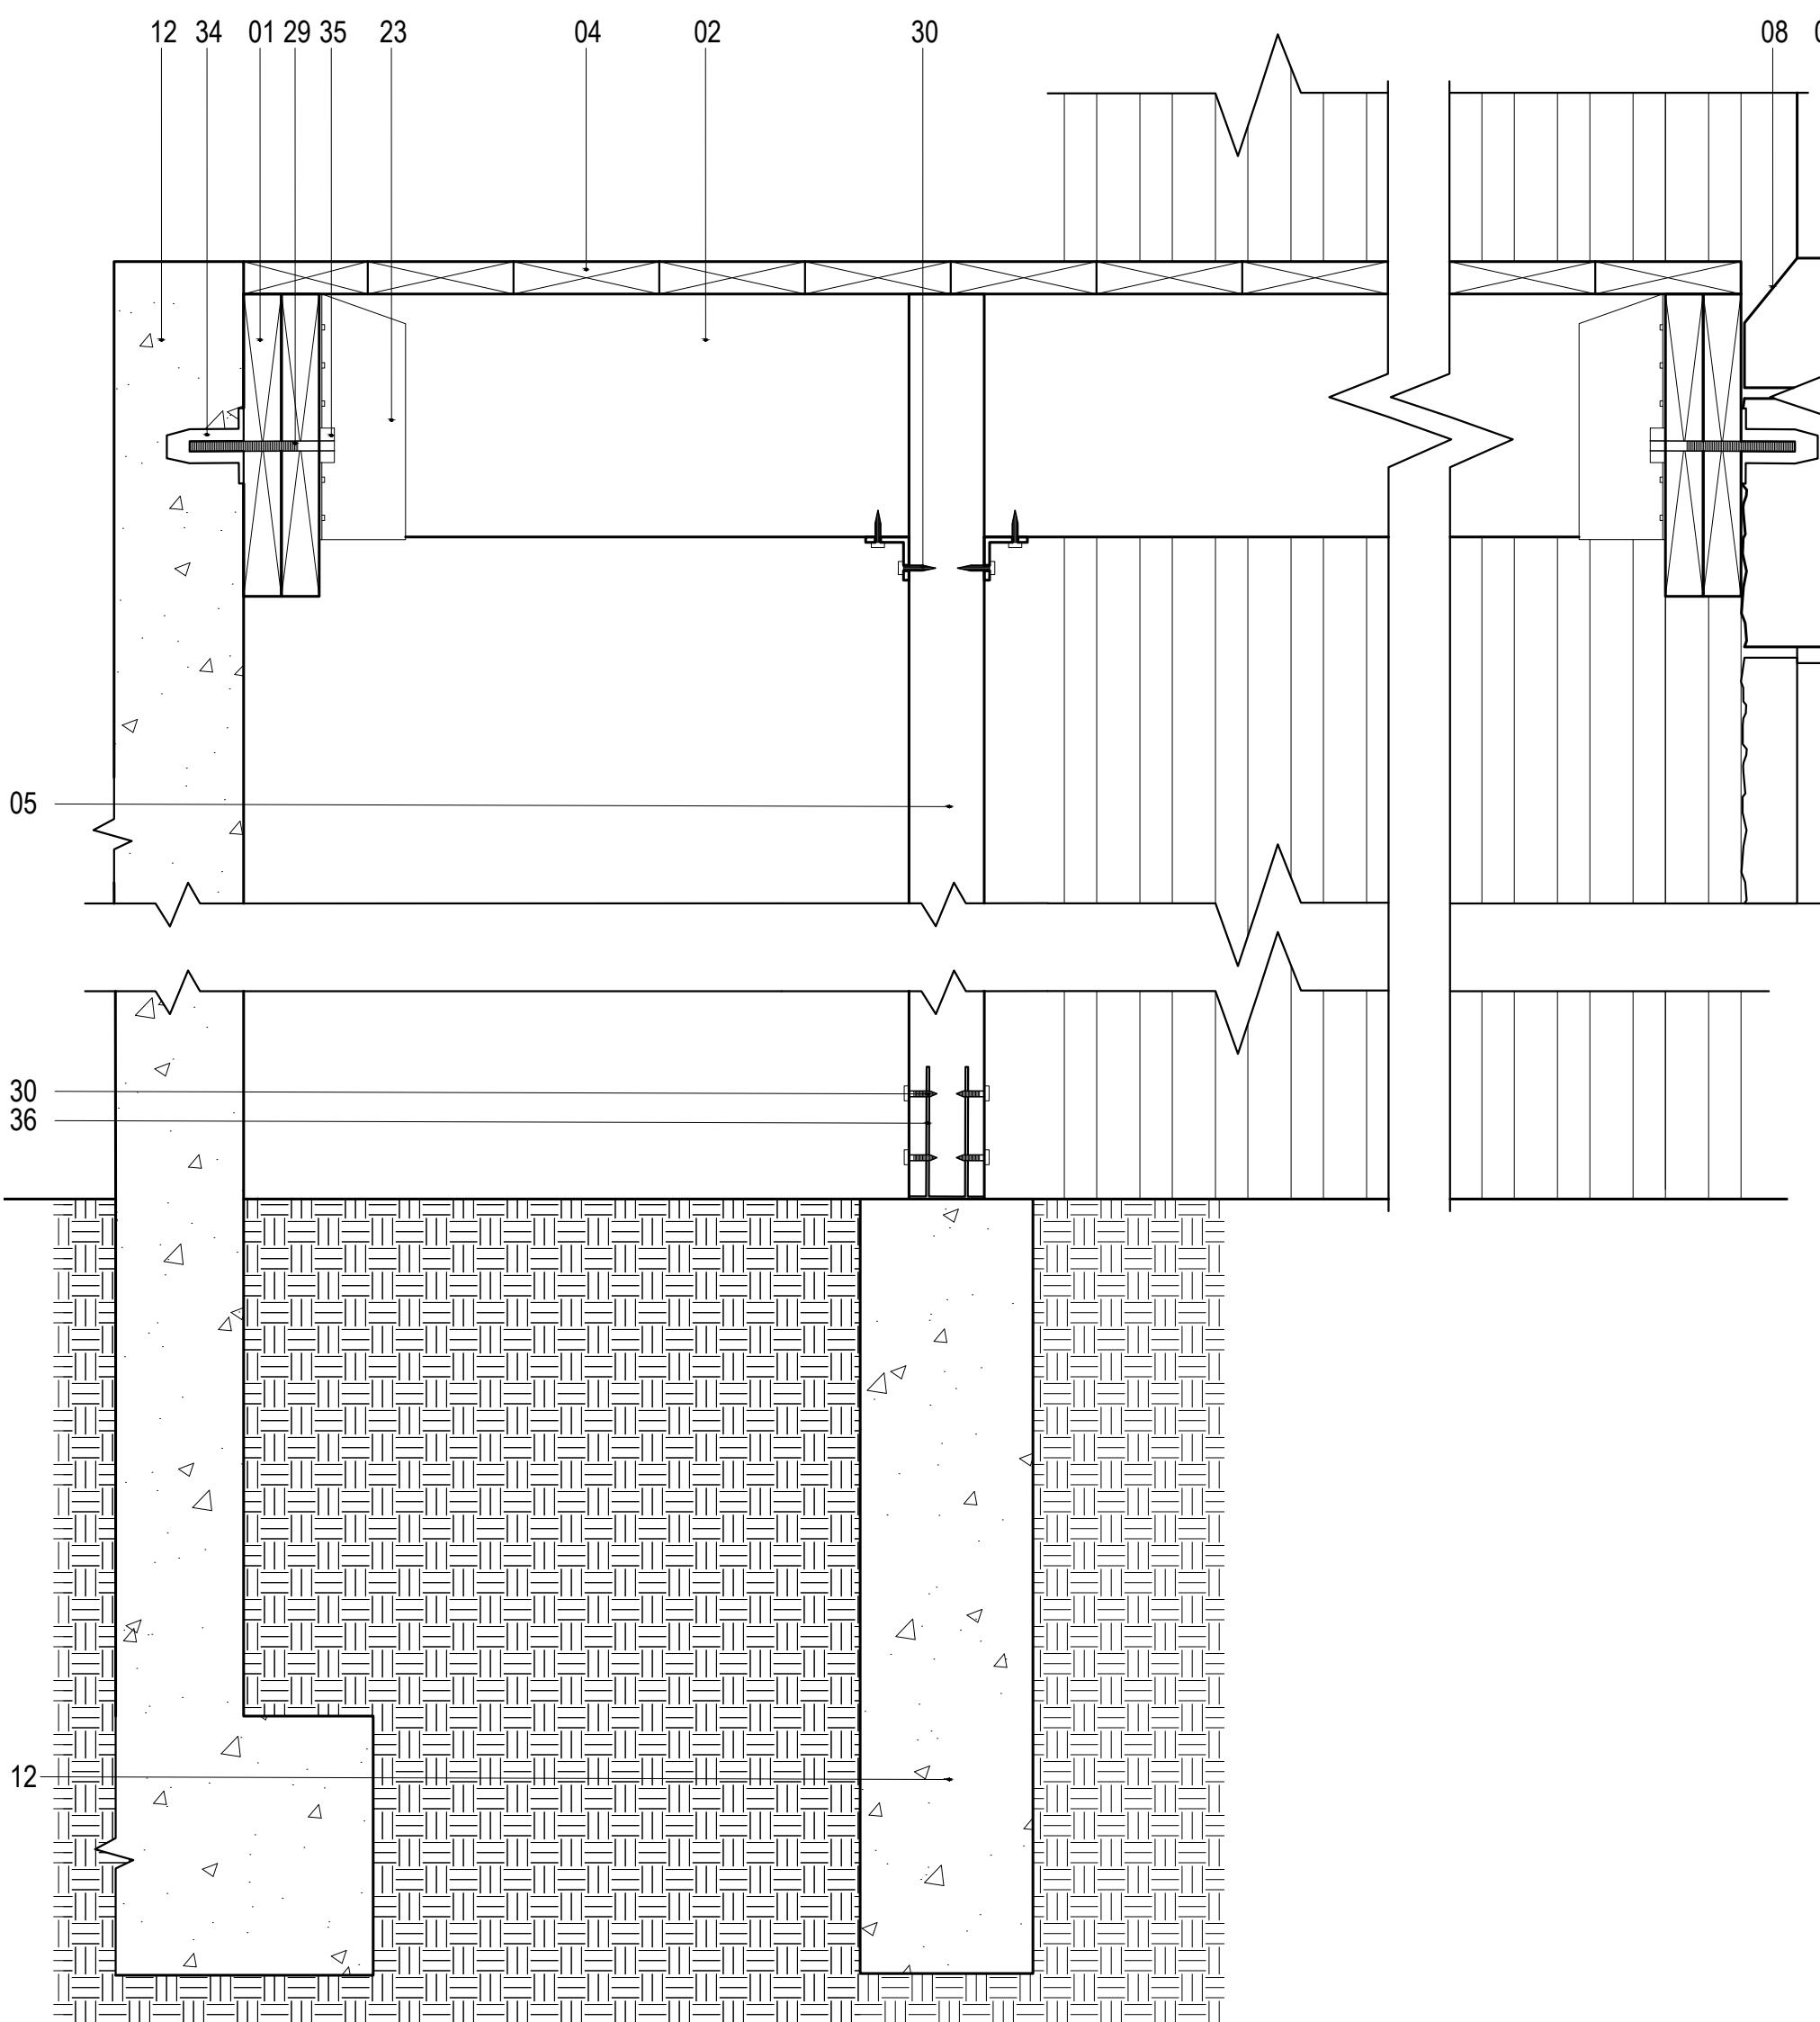
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1 DETAIL SECTION

SCALE: 1 1/2" = 1'-0"



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SCALE: 3" = 1'-0"

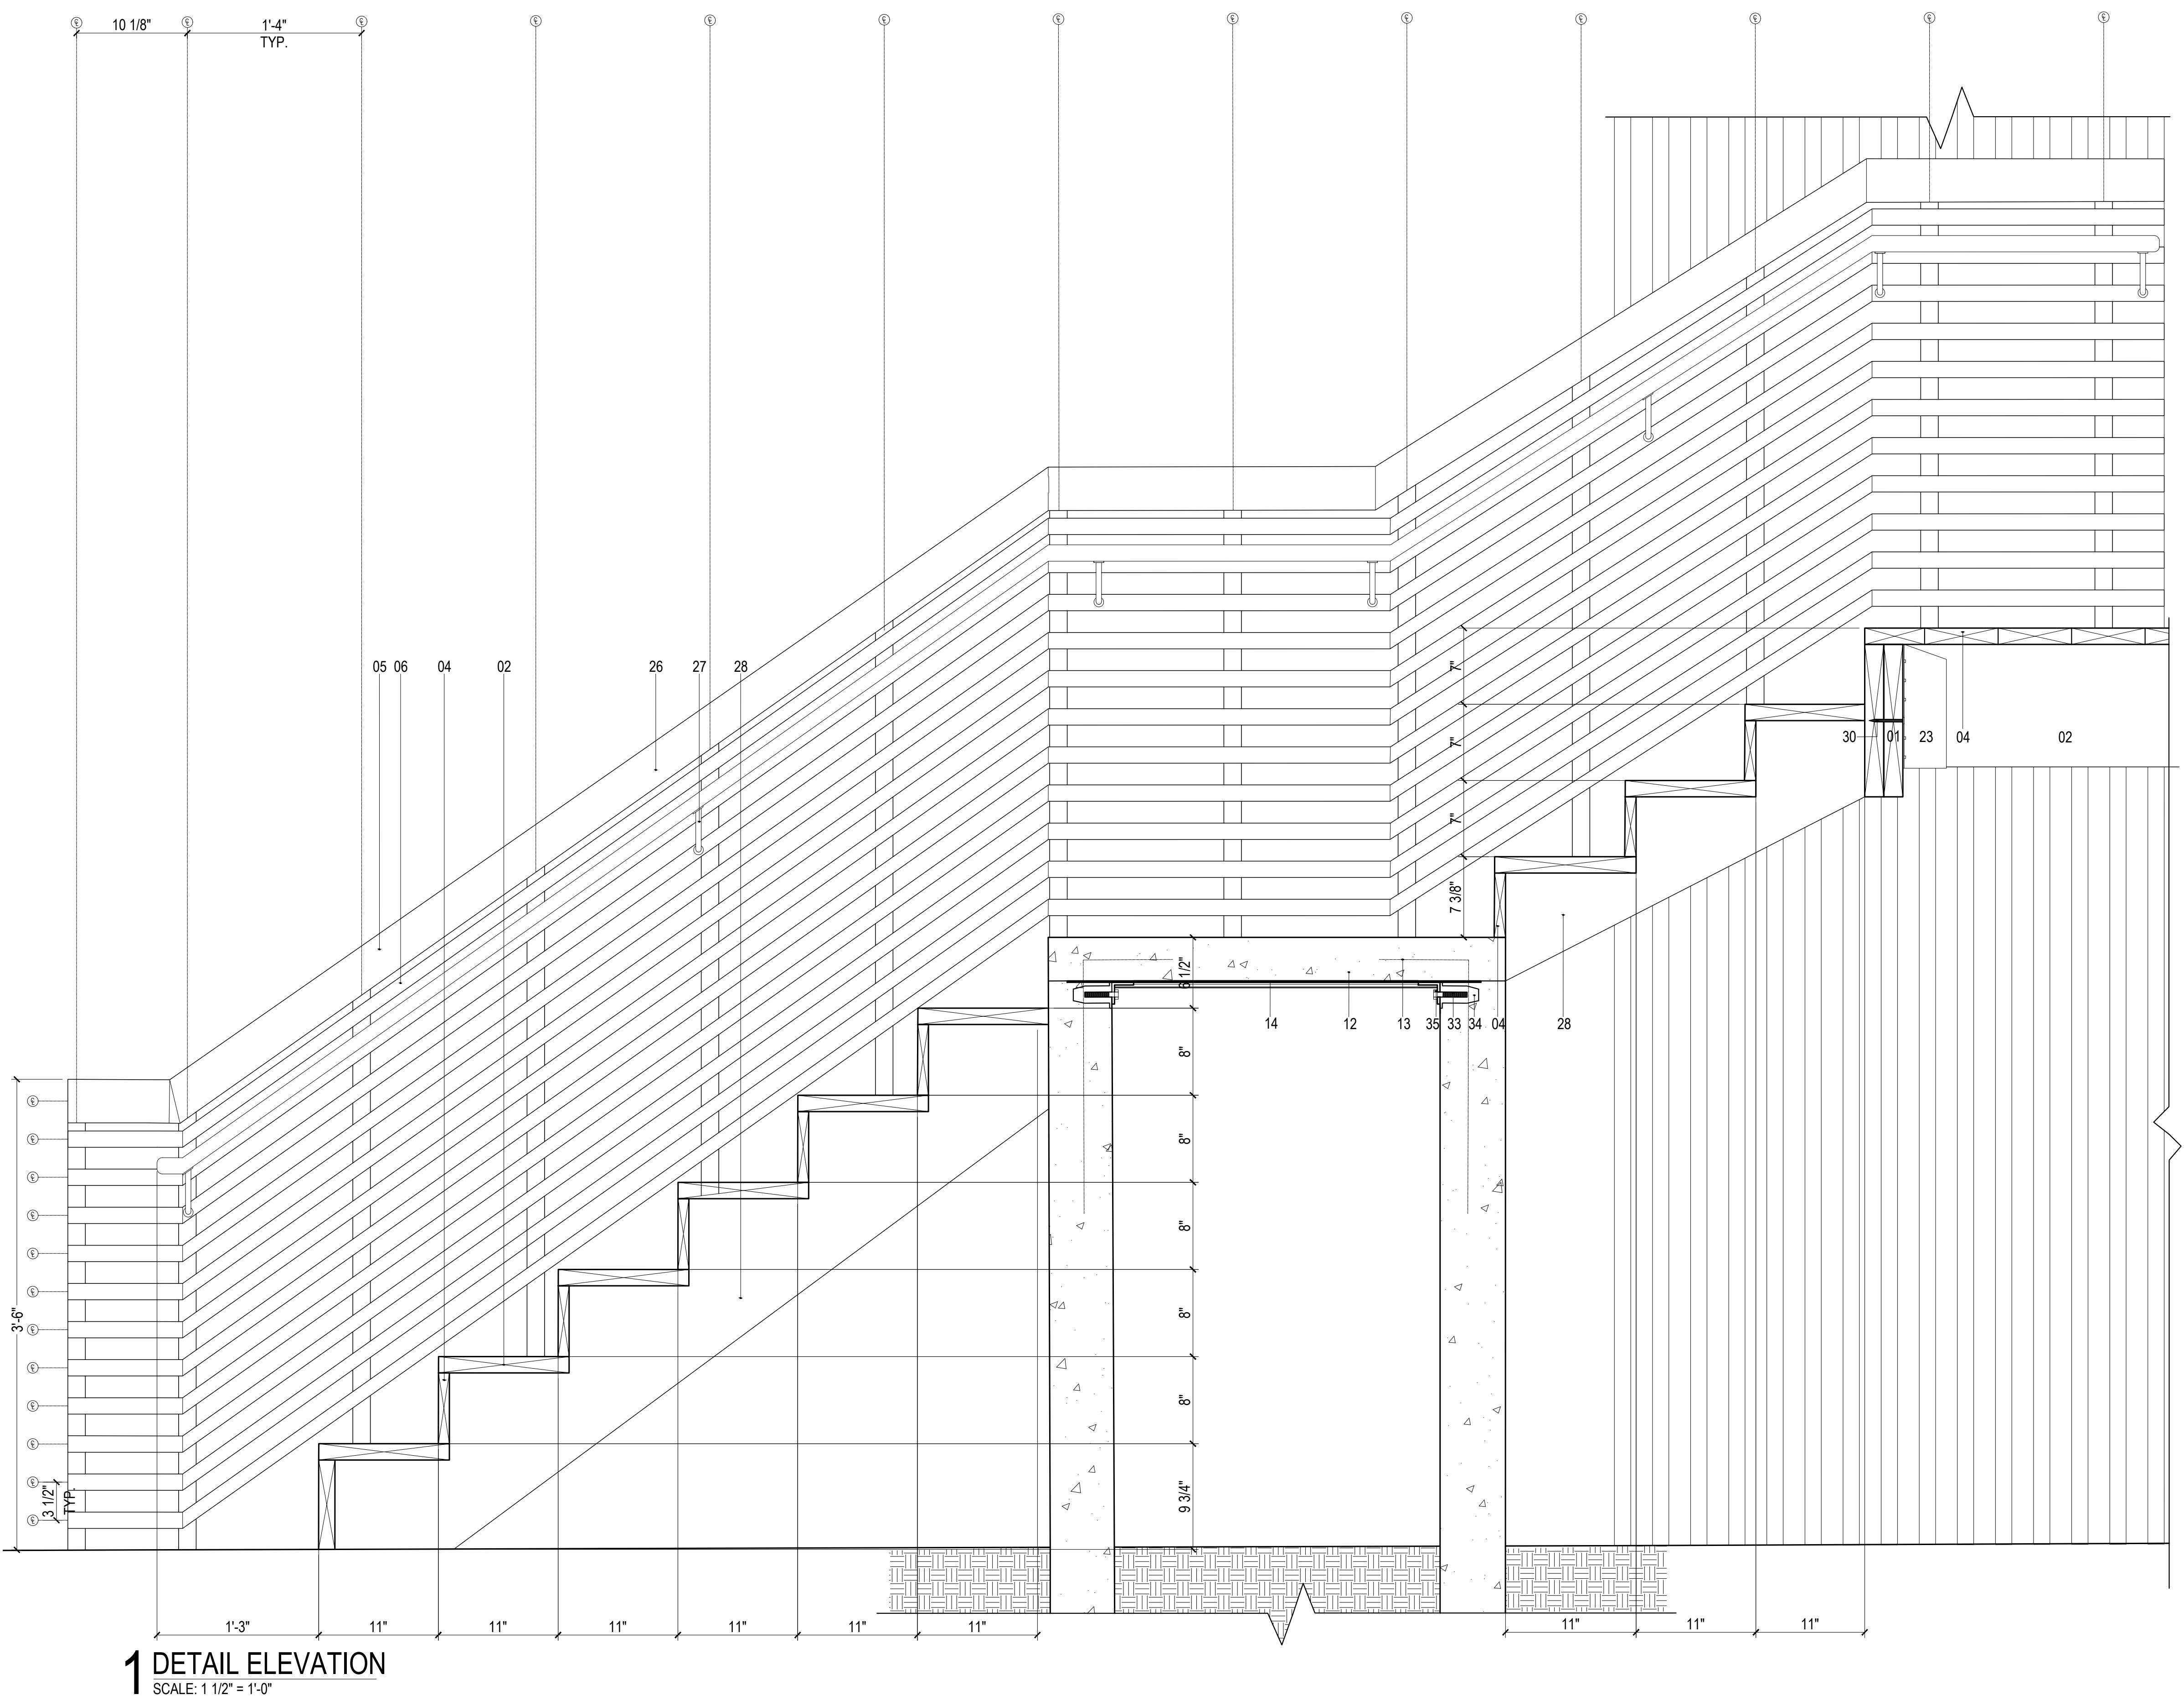
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WOODHENGE

DESIGN BUILD STUDIO
CARNEGIE MELLON UNIVERSITY
SCHOOL OF ARCHITECTURE
500 FORBES AVENUE
PITTSBURGH, PA 15213

A4.03
DETAILS

DRAWN BY:
KYLE BANCROFT
TAKUMI DAVIS
TAYLOR LATIMER

1 0
DECEMBER
2 0 1 9
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R E V I E W

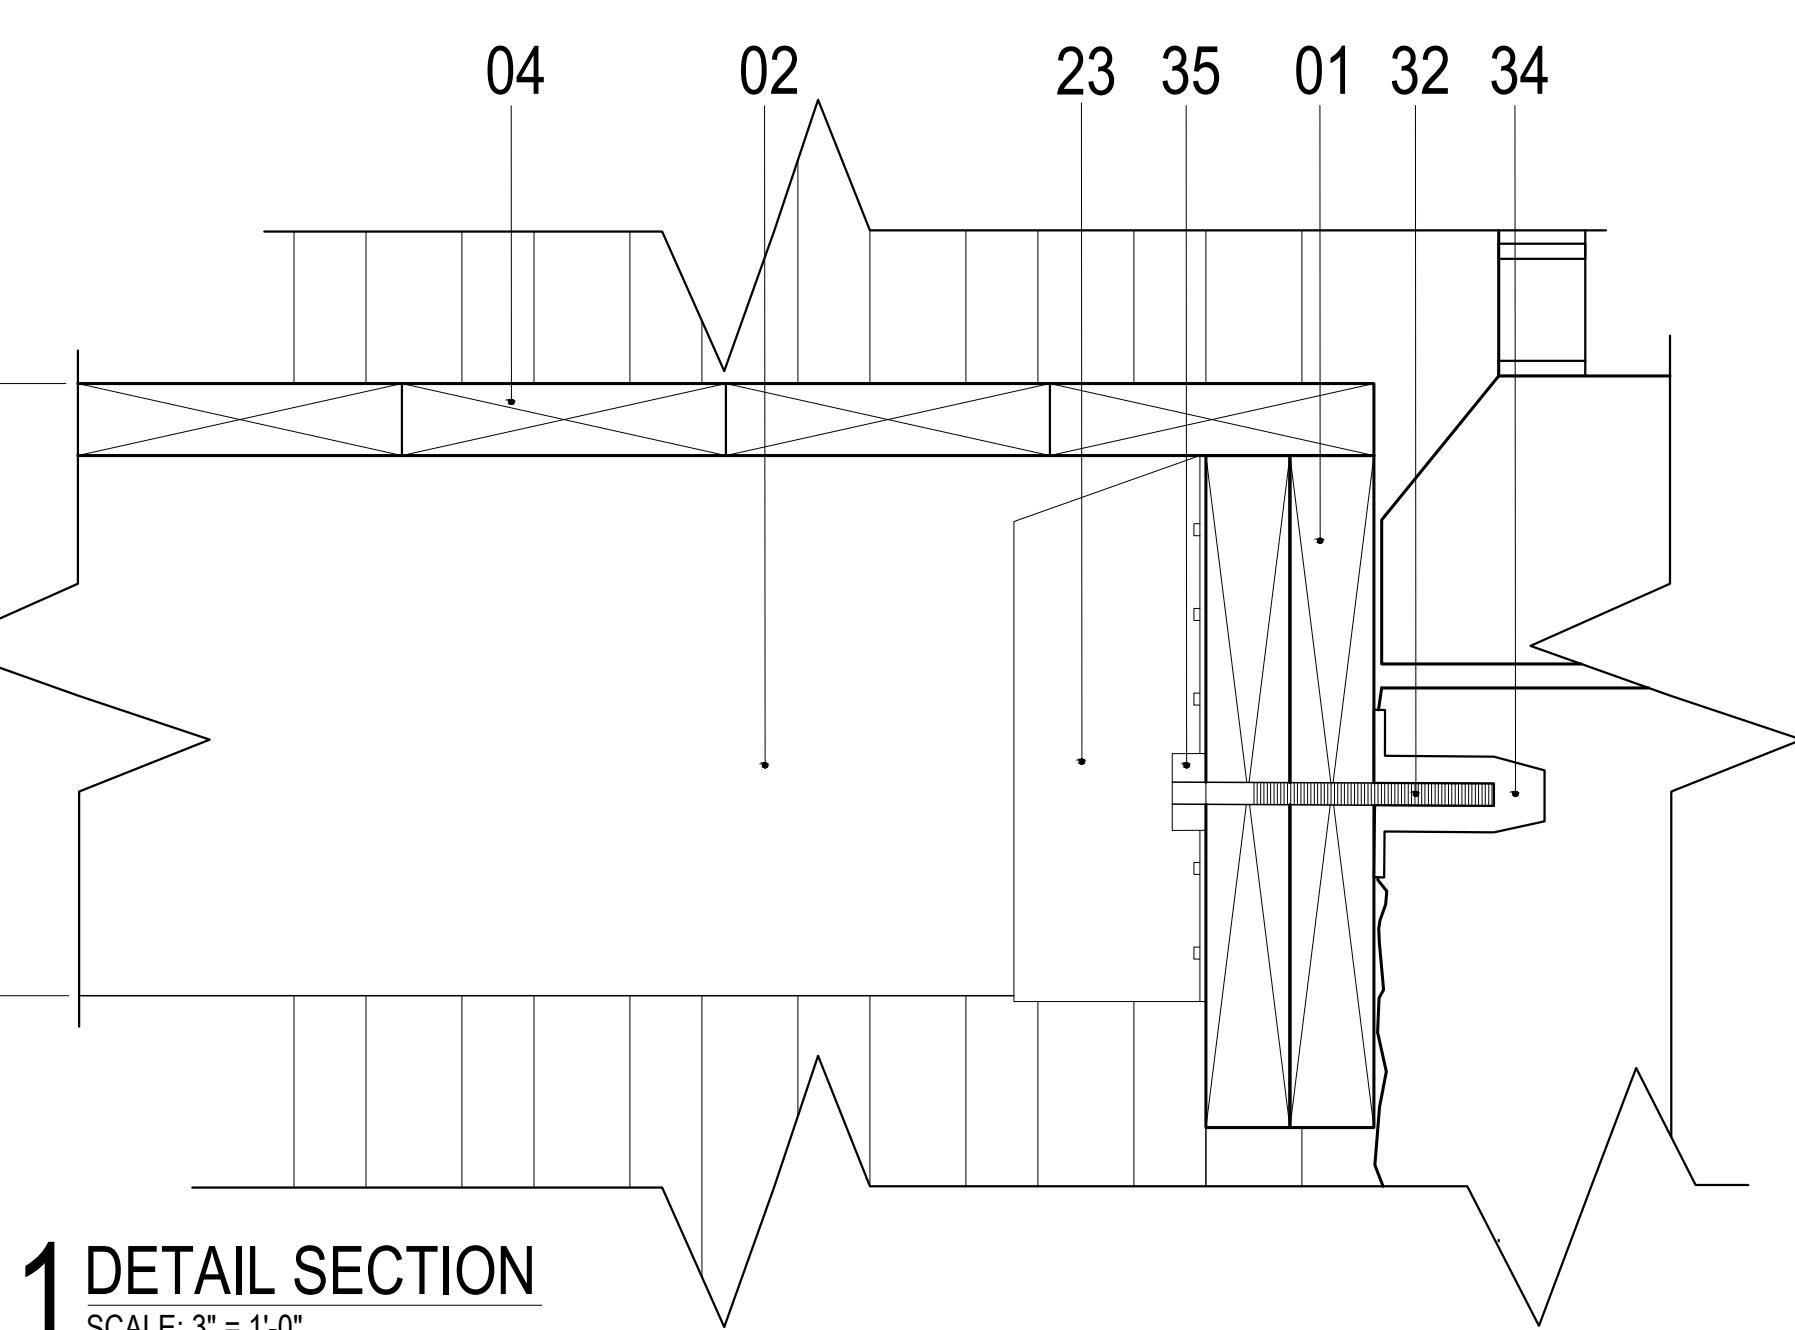
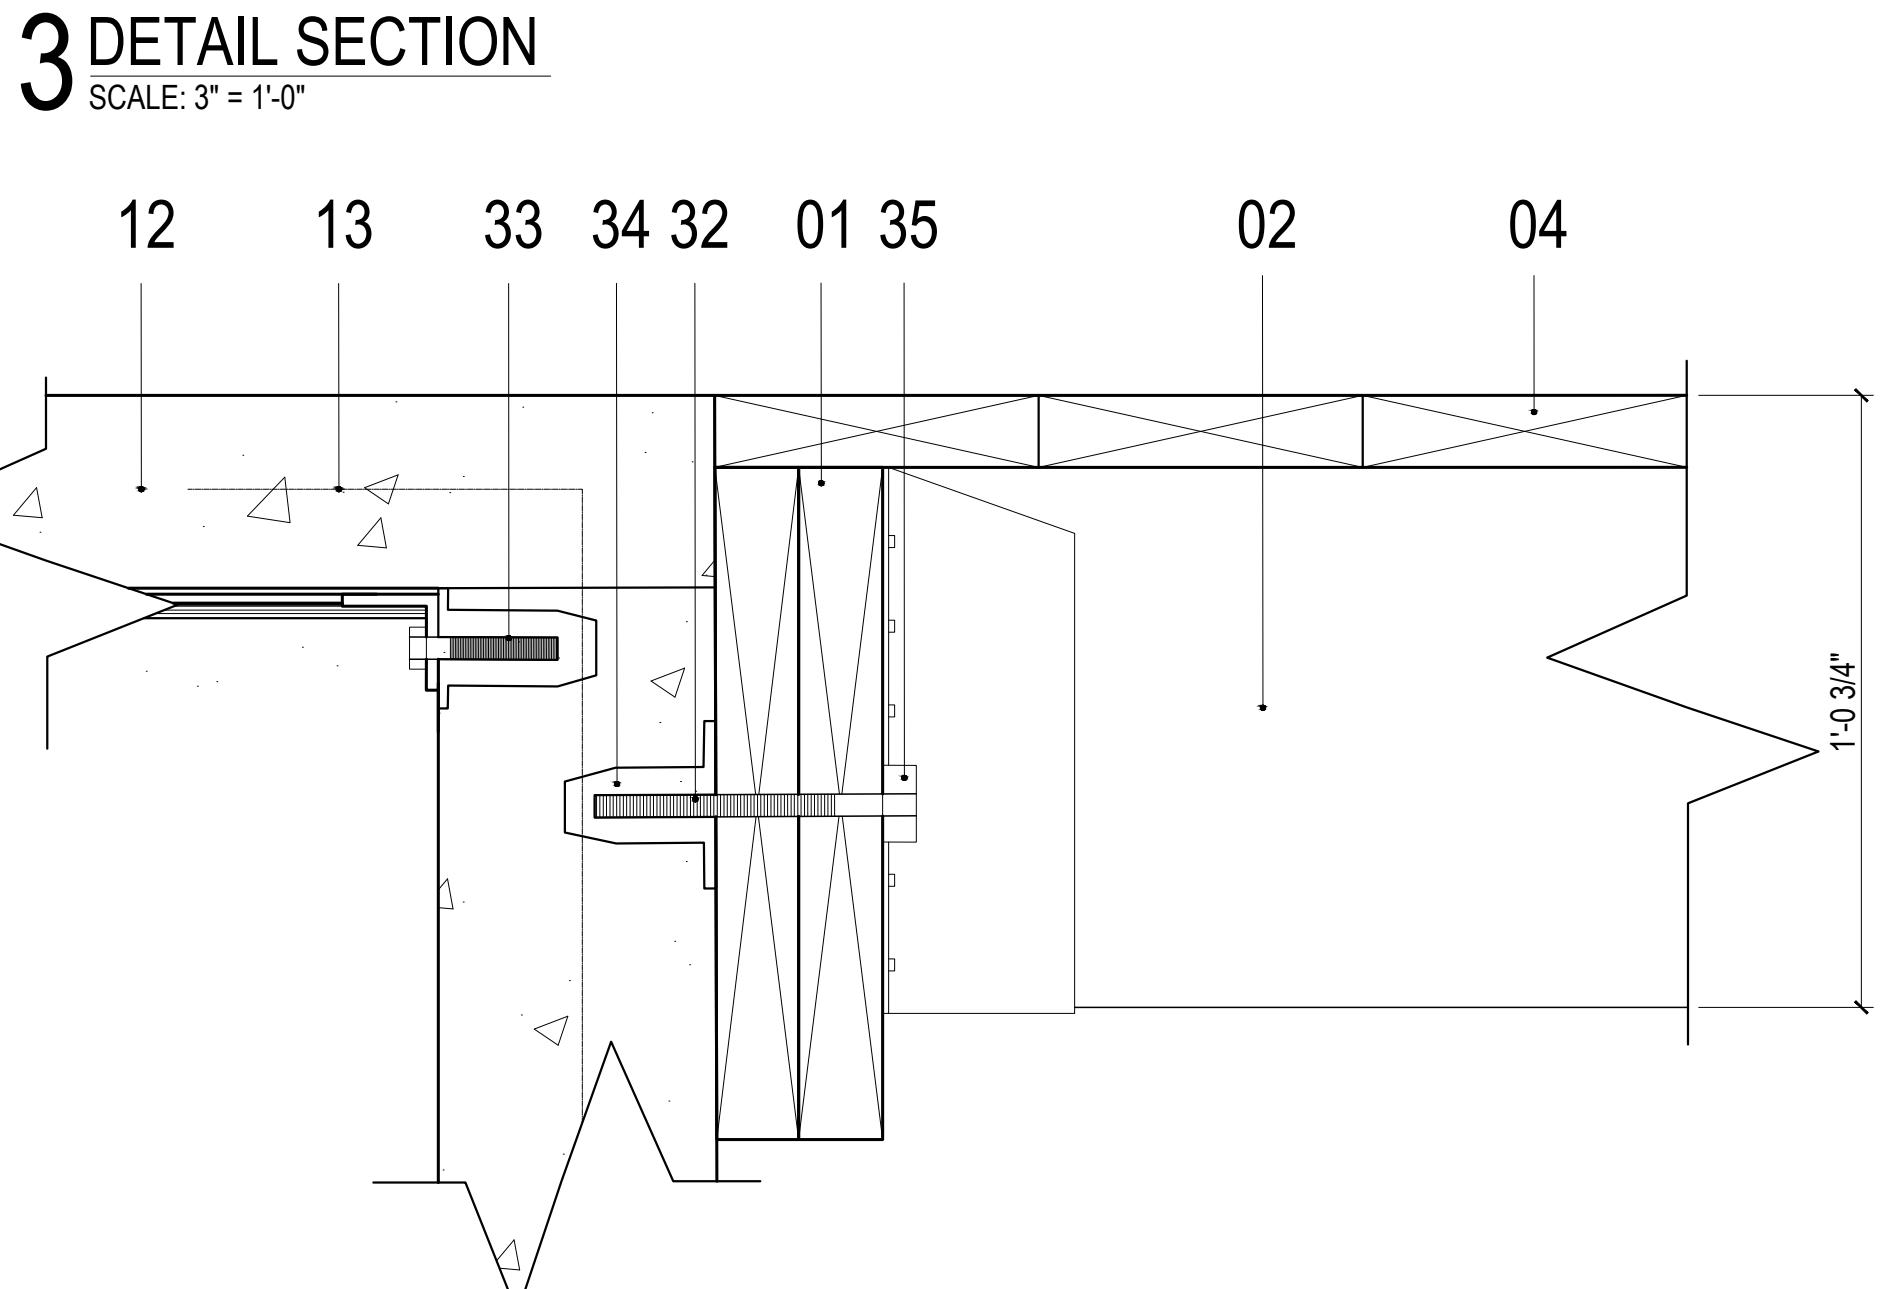
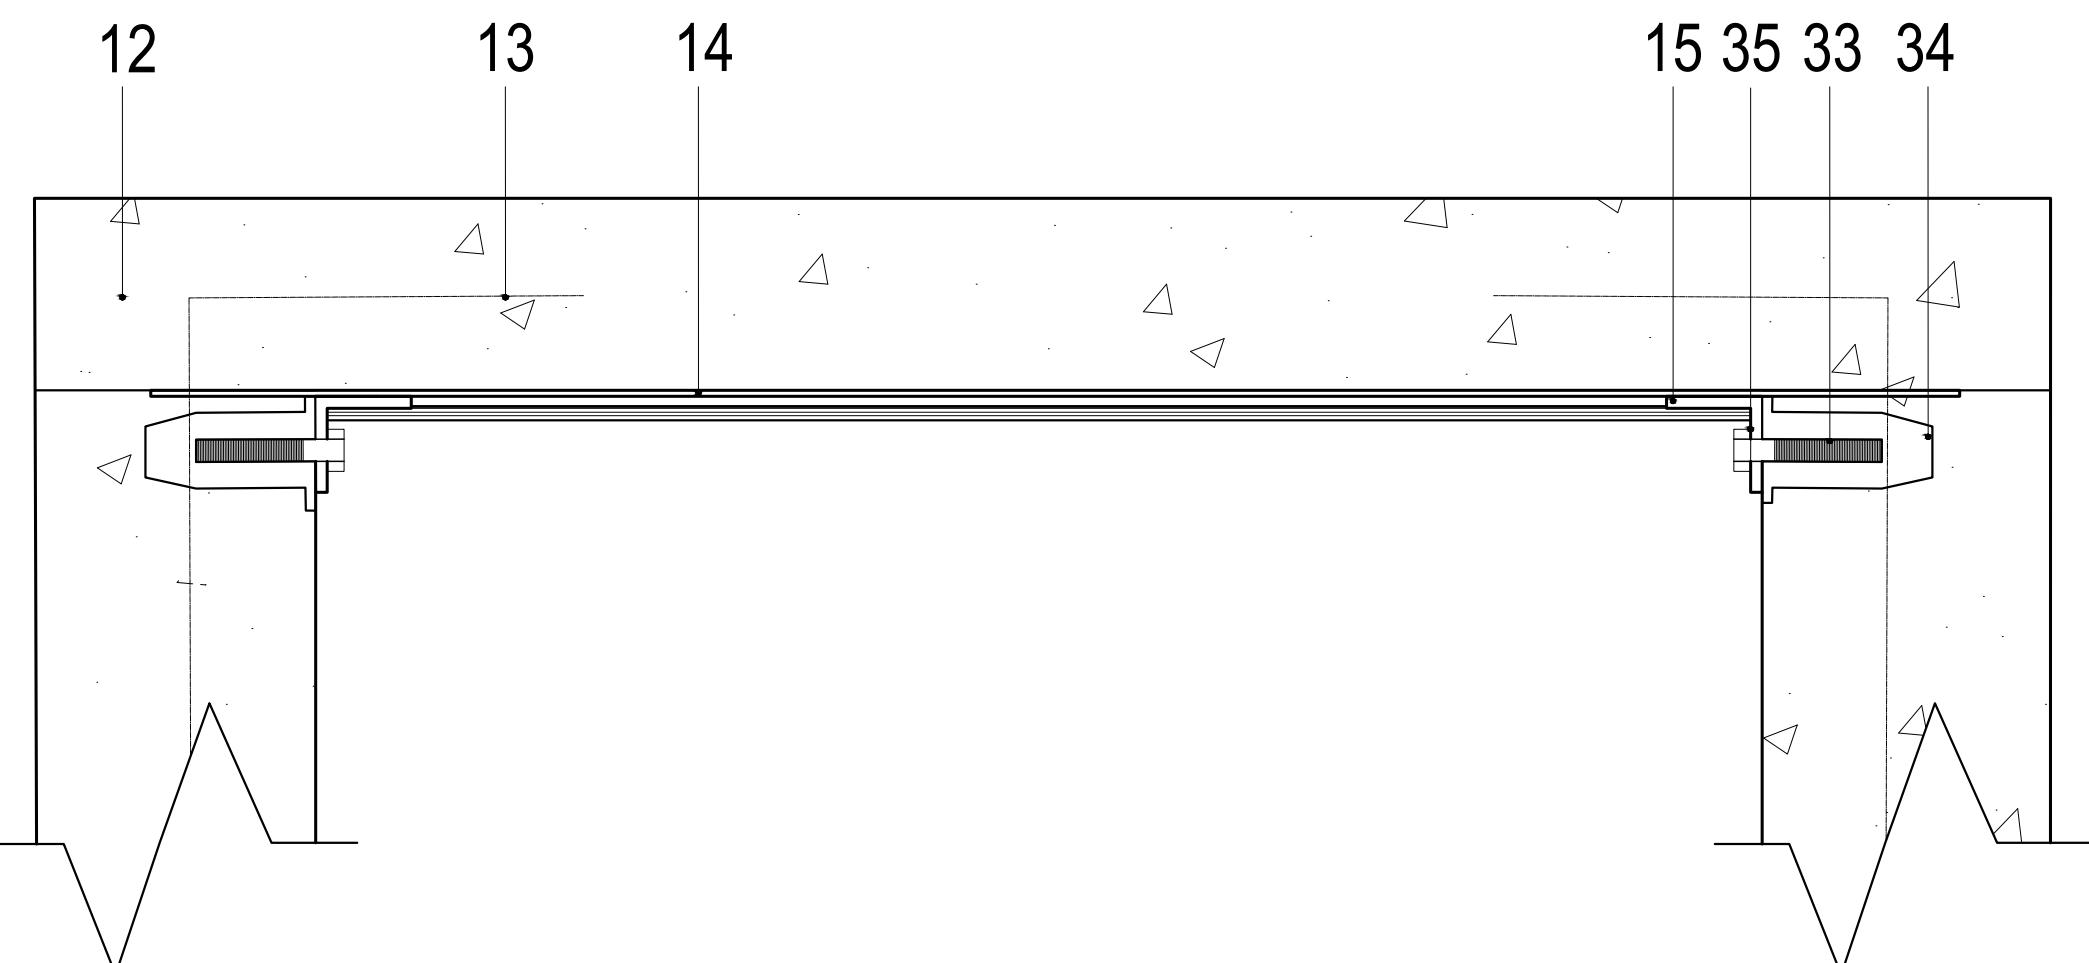
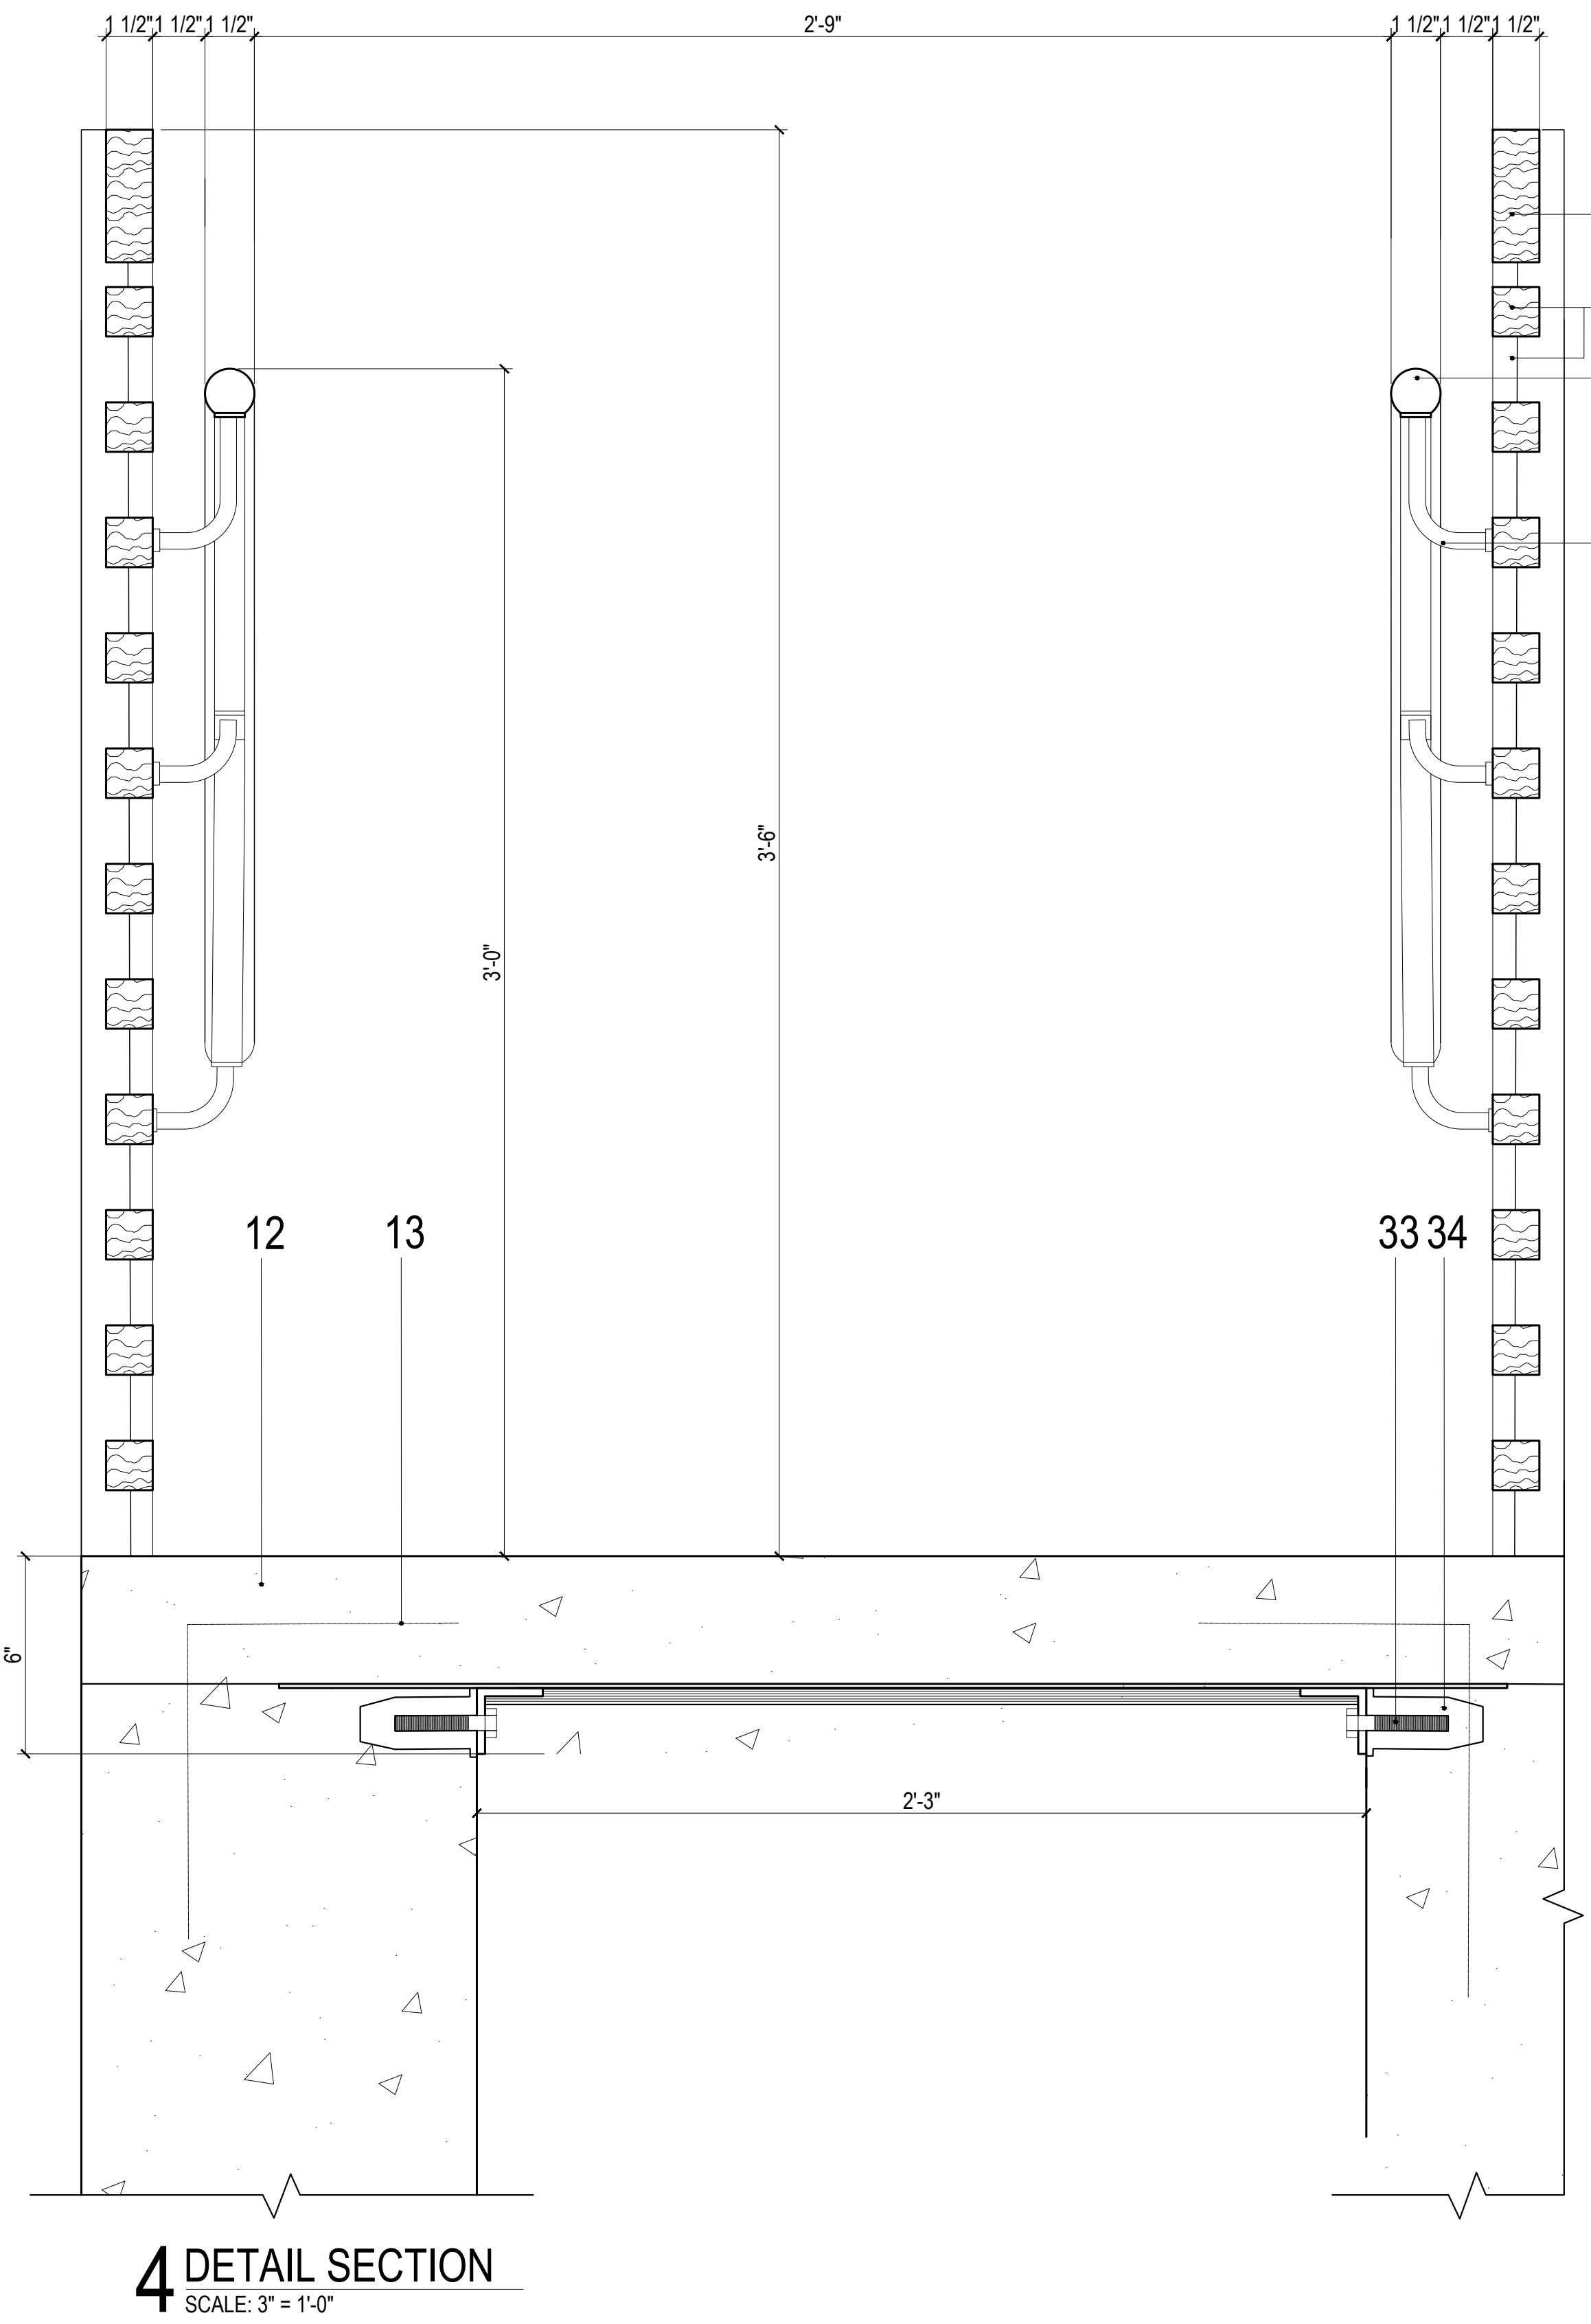
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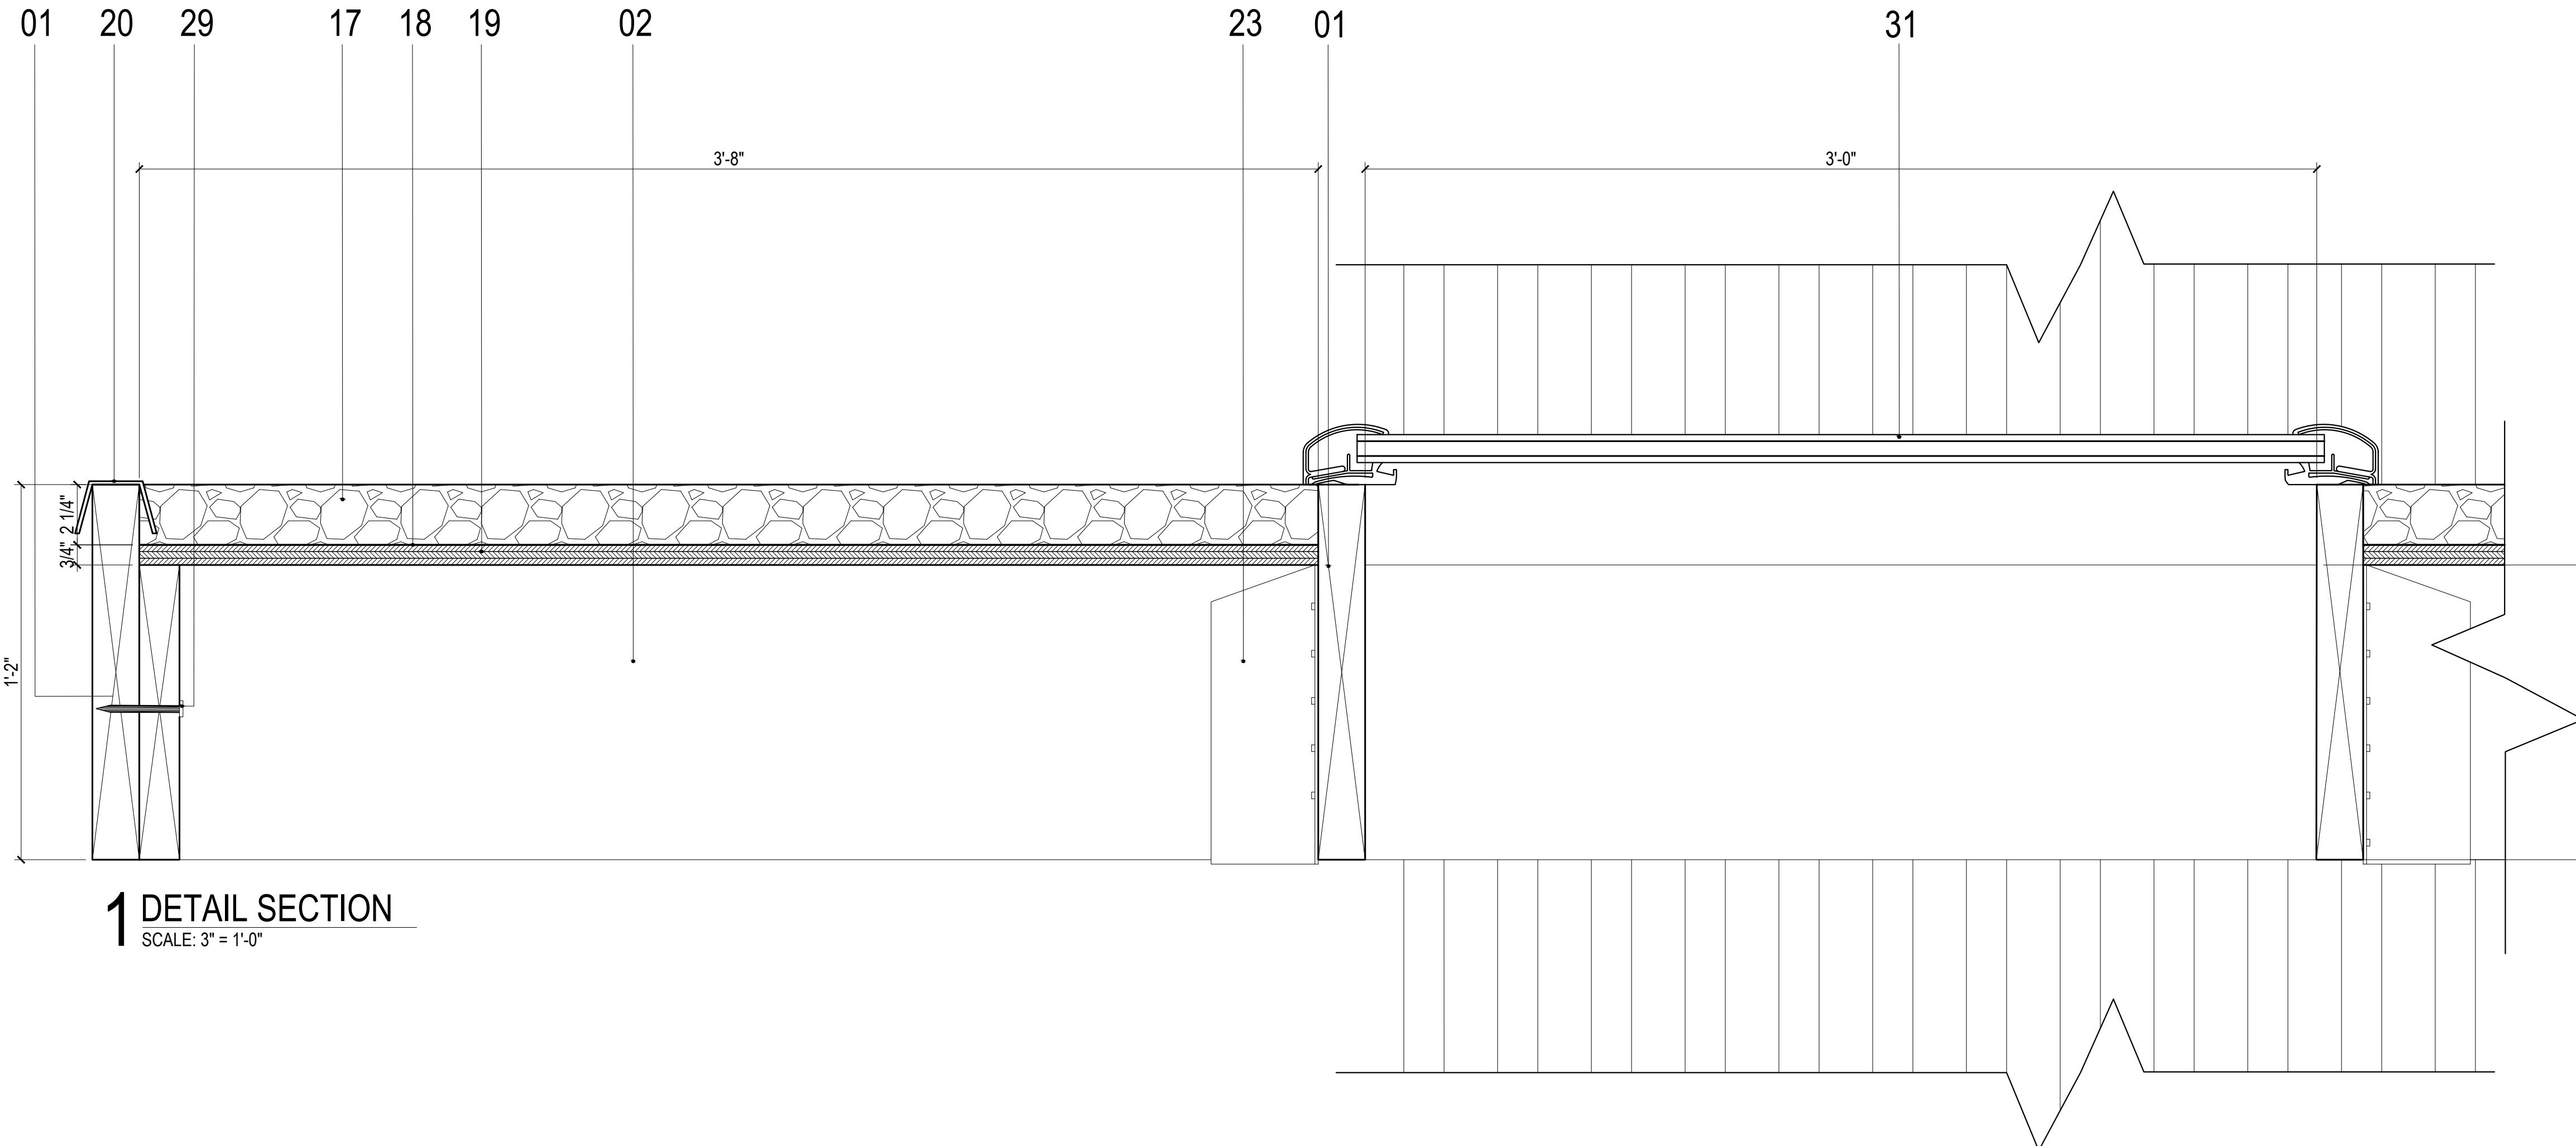


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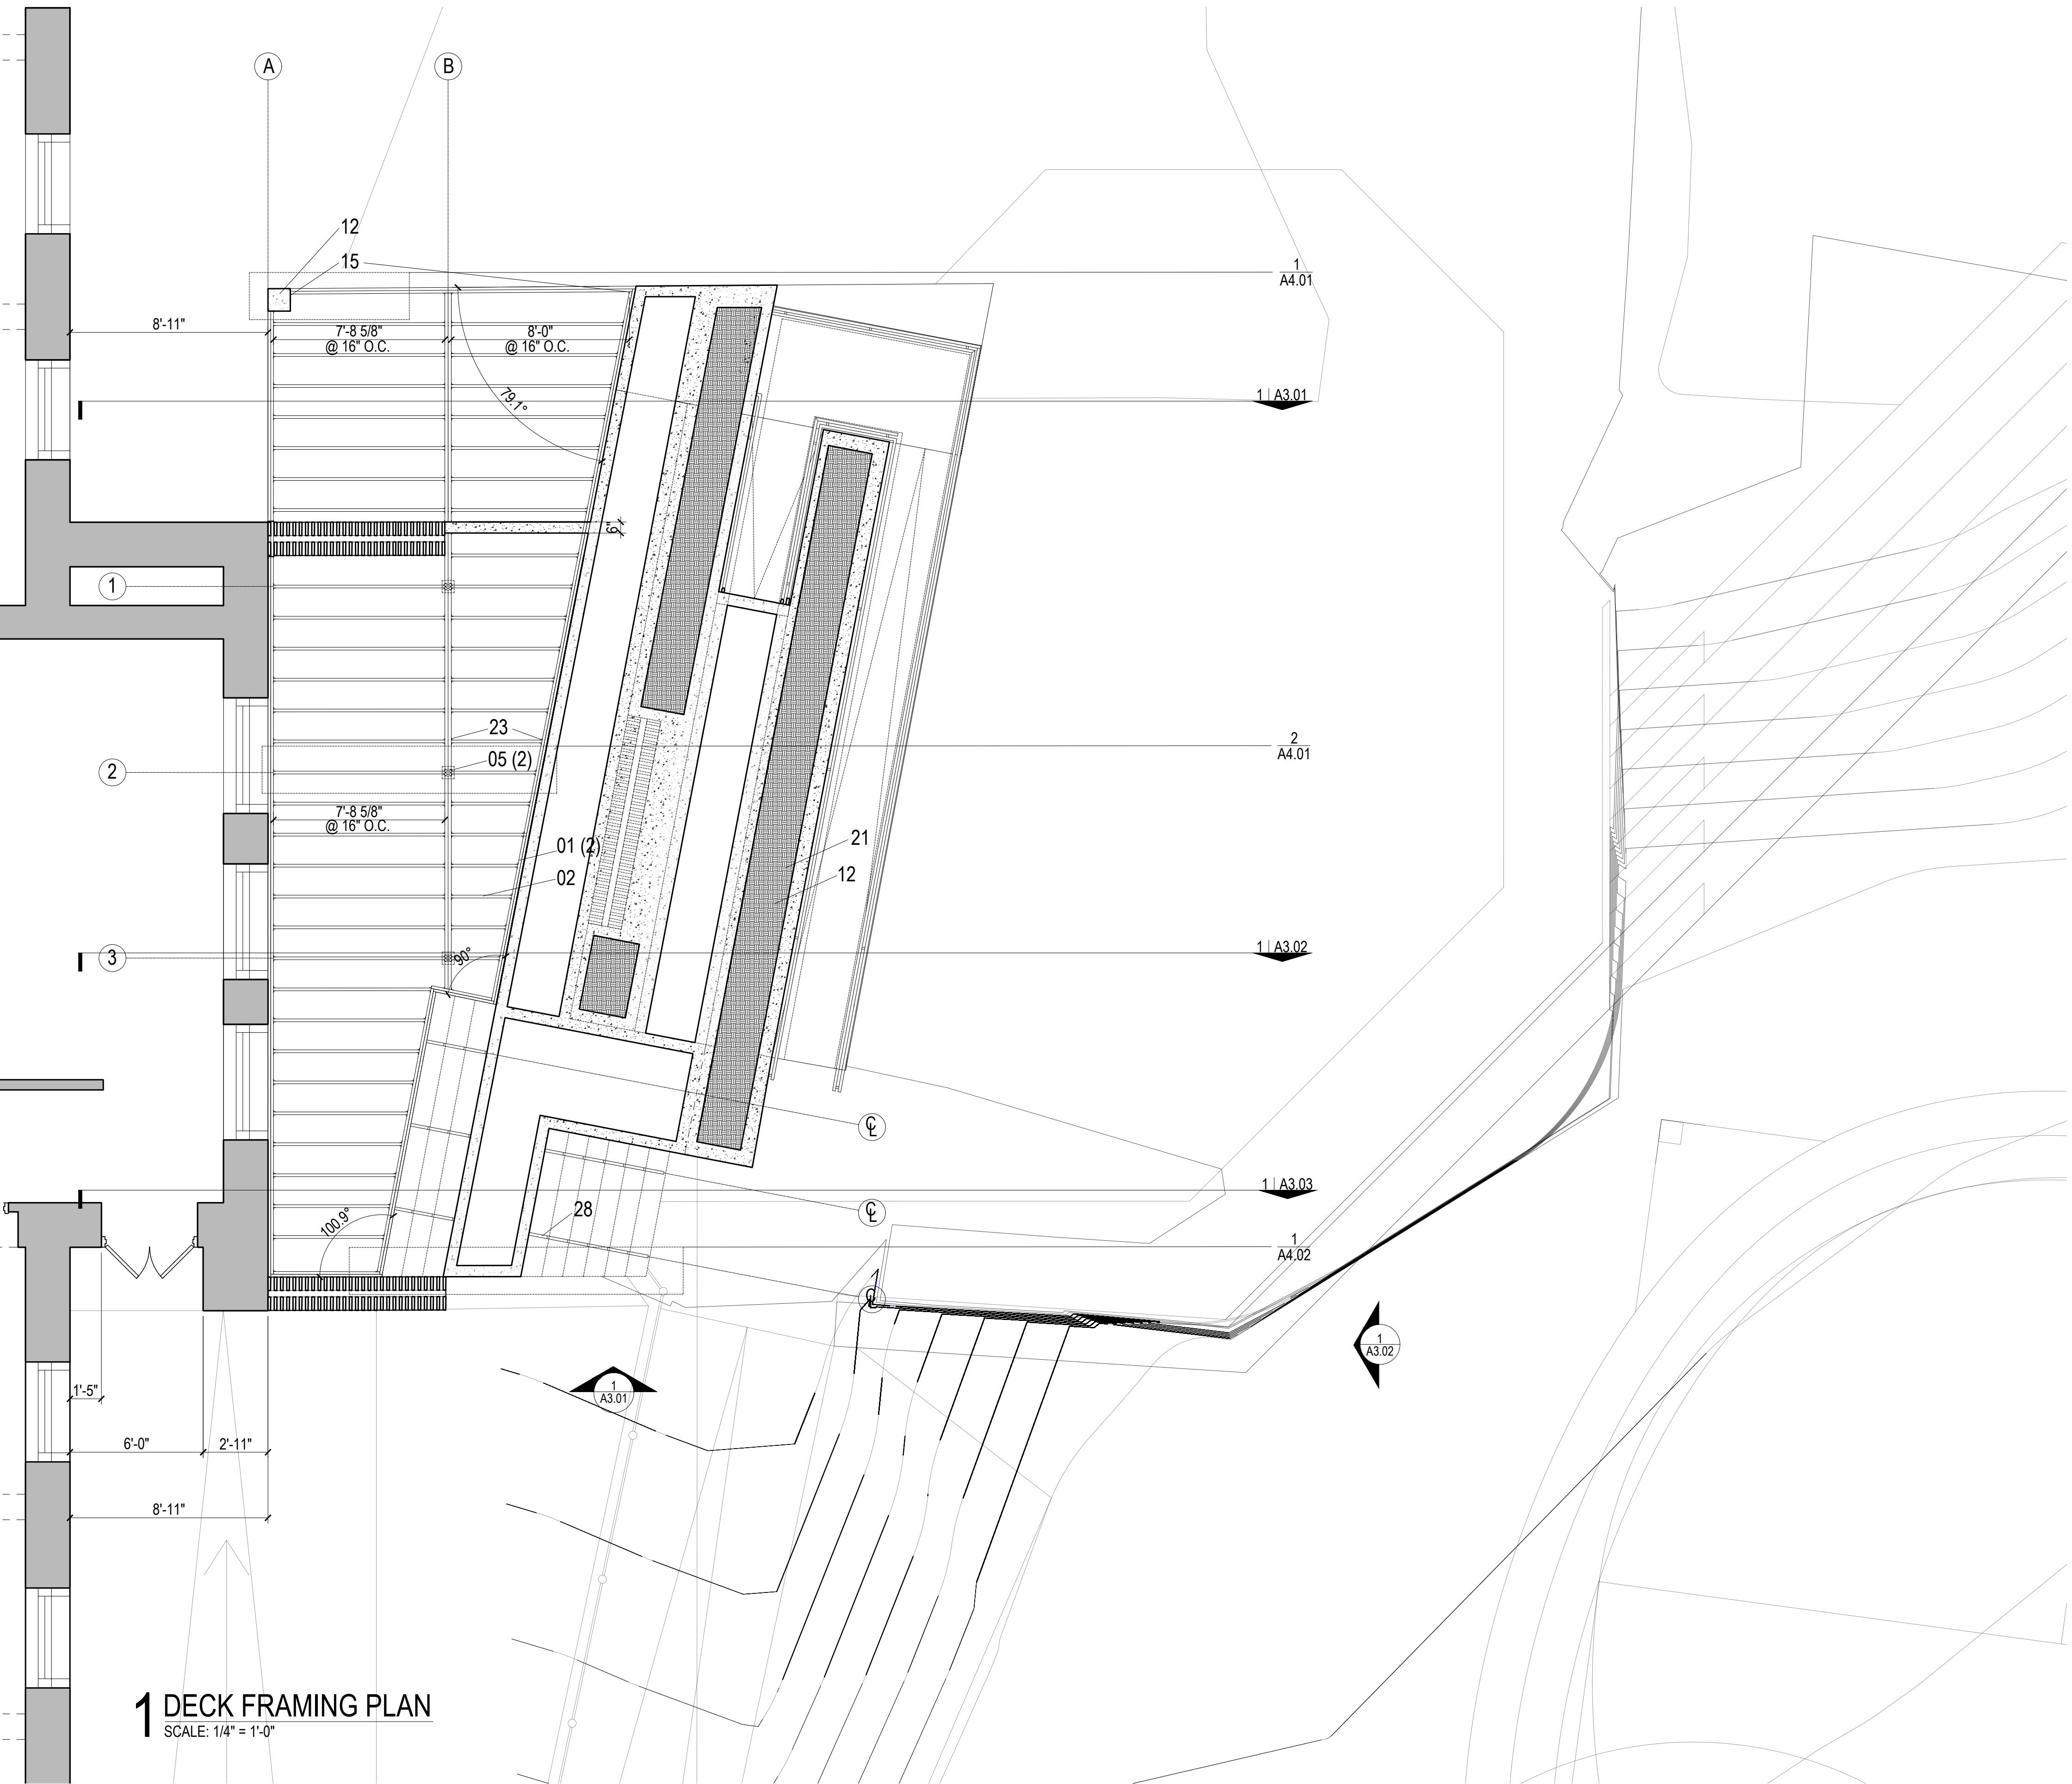


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KYLE BANCROFT
TAKUMI DAVIS
TAYLOR LATIMER

WOODHENGE COMMUNITY FORCE

1256 FRANKLIN AVE.
WILKINSBURG, PA 15221

S1.01
DECK FRAMING PLAN



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	INFIL SOIL
	CUT OR FILL SOIL
	GRASS
	SAND OR GRANULAR PAD
	CUT WOOD GRAIN

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DRAWN BY:
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1 DECEMBER
2019
F O R
R E V I E W

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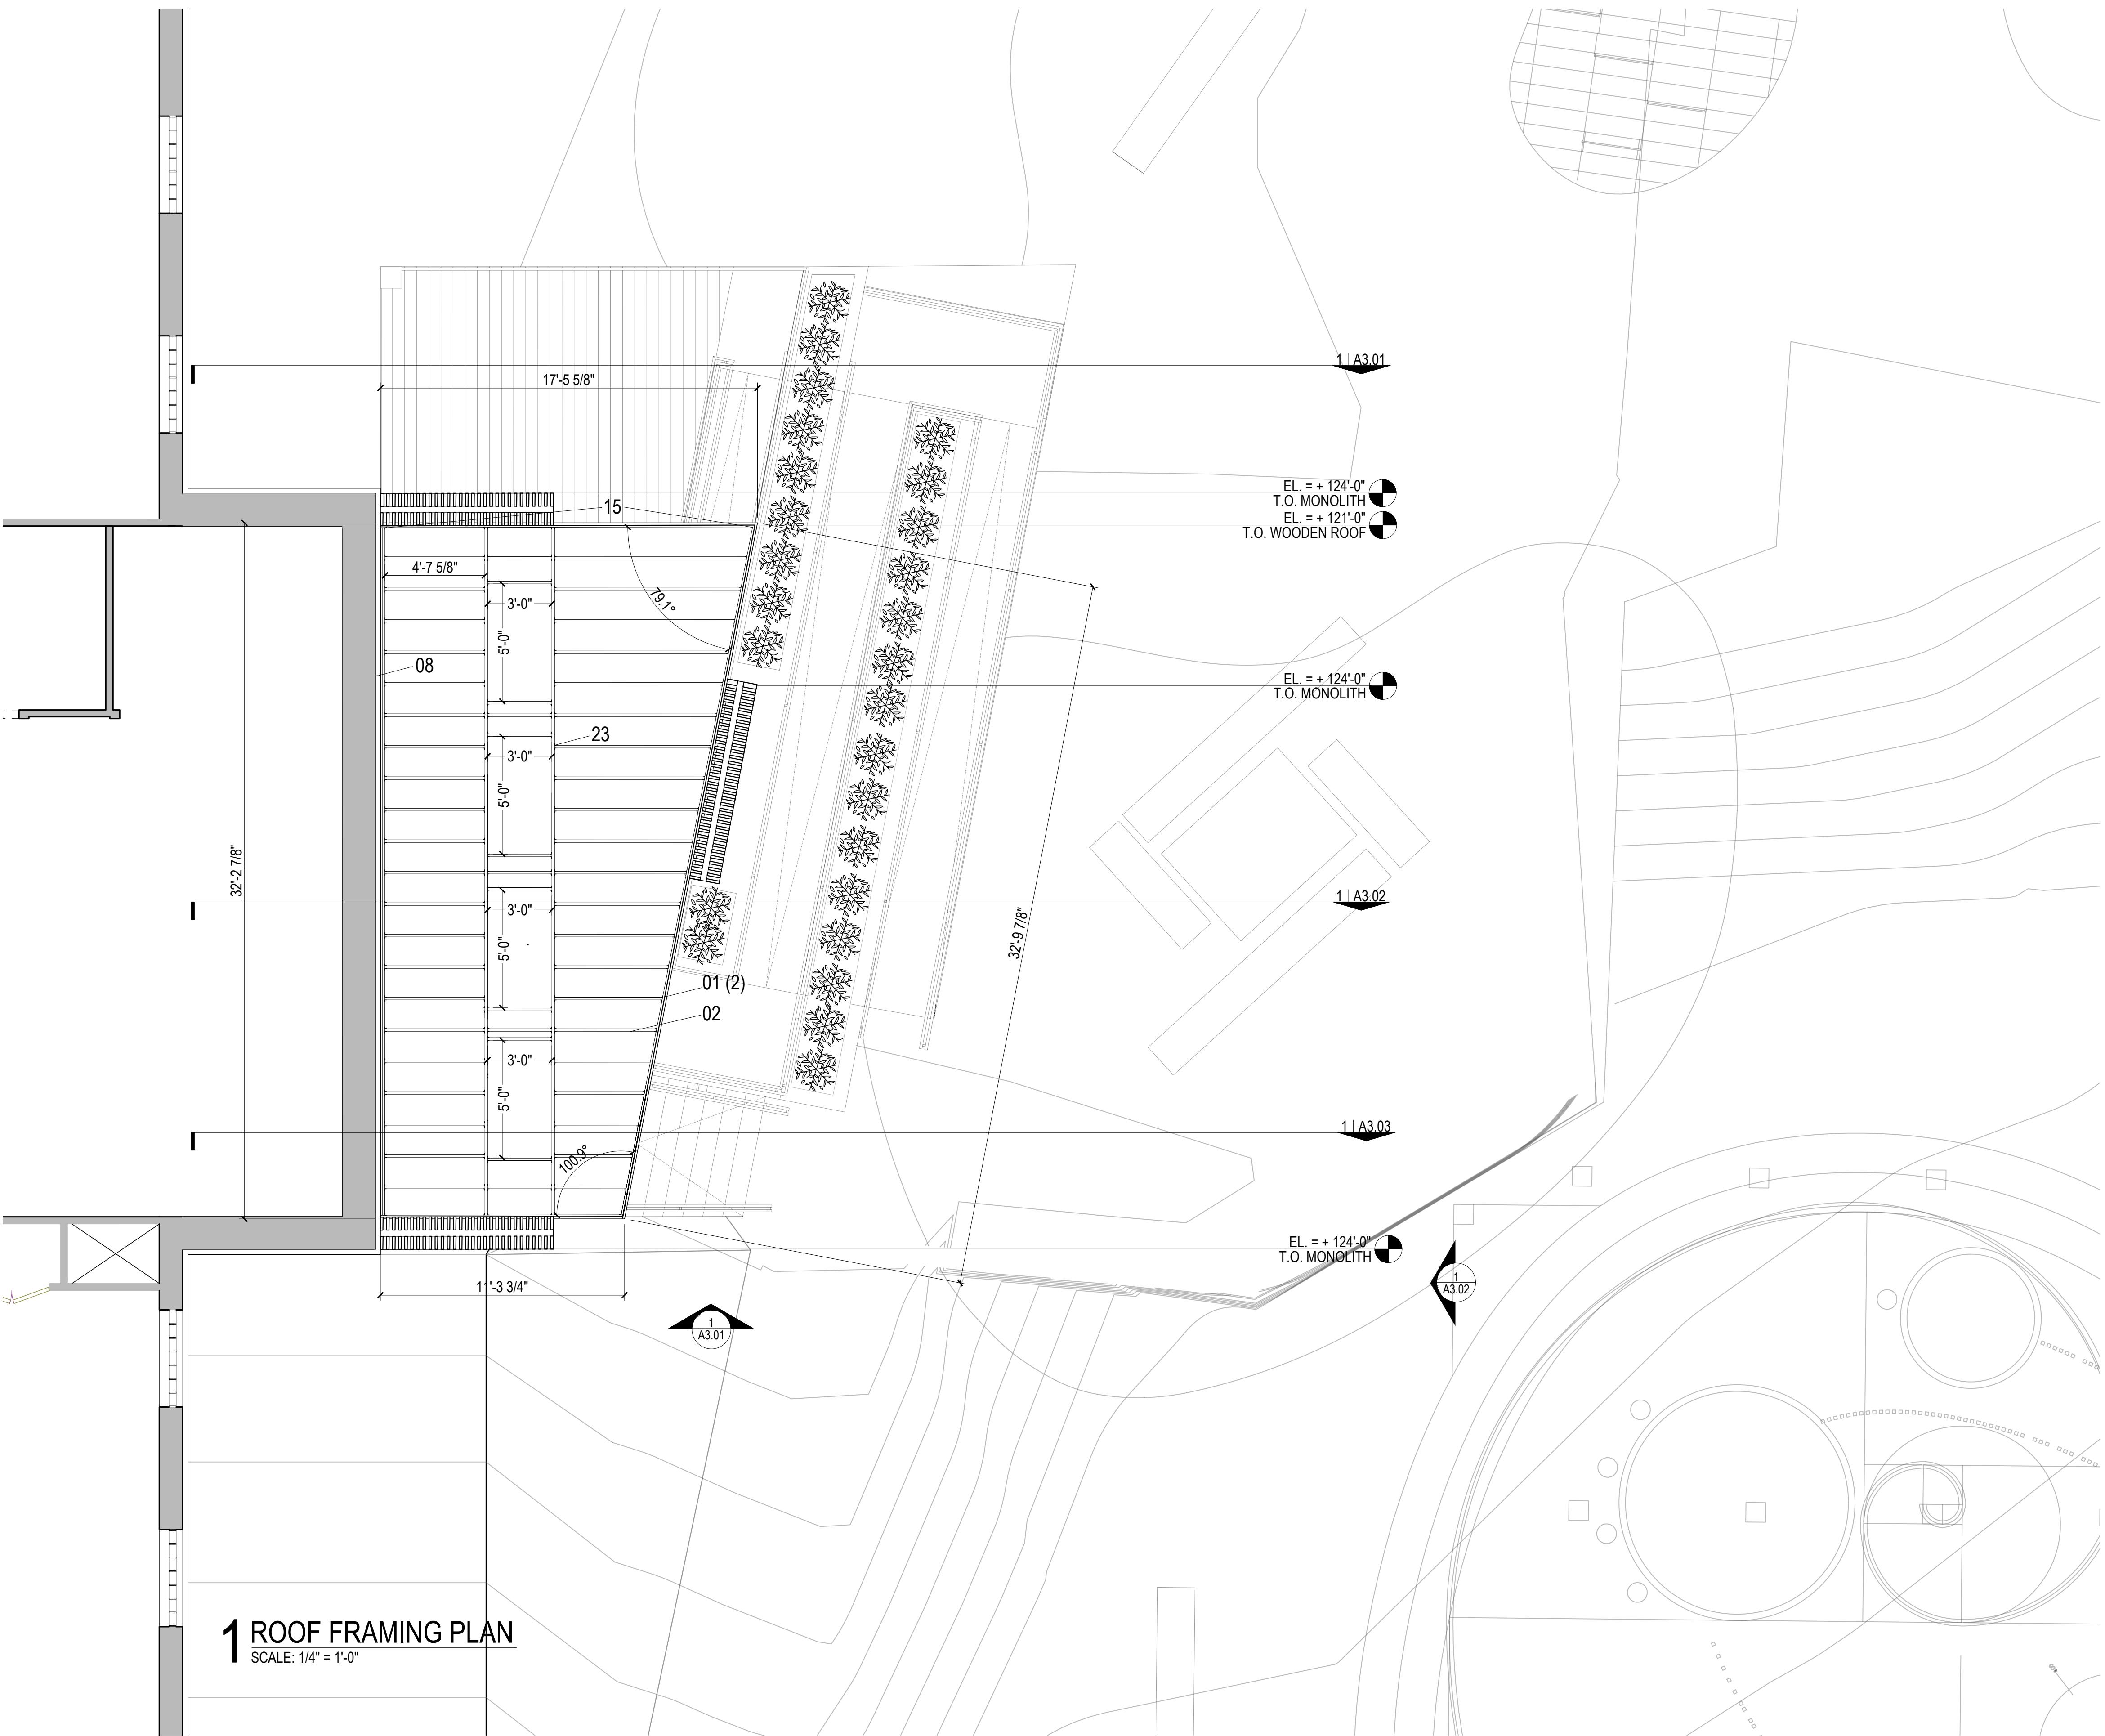
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1 ROOF FRAMING PLAN
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SHEET LIST:
 G.00 TITLE PAGE
 L.01 SITE PLAN
 A1.01 GROUND FLOOR PLAN
 A1.02 DECK PLAN
 A1.03 ROOF PLAN
 A2.01 NORTH ELEVATION
 A2.02 WEST ELEVATION
 A3.01 SECTION 1
 A3.02 SECTION 2
 A3.03 SECTION 3
 A4.01 DETAILS
 A4.02 DETAILS
 A4.03 DETAILS
 A4.04 DETAILS
 S1.01 DECK FRAMING PLAN
 S1.02 ROOF FRAMING PLAN
 PR.01 PROTOTYPE TITLE PAGE
 PR.02 PROTOTYPE PERSPECTIVE
 PR.03 PROTOTYPE PLAN EN SITU
 PR.04 PROTOTYPE ELEVATIONS EN SITU
 PR.05 PROTOTYPE CUT SHEET
 PR.06 PROTOTYPE ASSEMBLY SEQUENCE

ABBREVIATIONS:
 ABV. = ABOVE
 B.O. = BOTTOM OF
 CL. = CENTER LINE
 CLR. = CLEARANCE
 COL. = COLUMN
 CONC. = CONCRETE
 DN. = DOWN
 EL. = ELEVATION
 EPMD = ETHYLENE PROPYLENE DIENE MONOMER
 EXT. = EXTERIOR
 FDTN. = FOUNDATION
 GA. = GAUGE
 GALV. = GALVANIZED
 INT. = INTERIOR
 LF. = LINEAR FEET
 LVL. = LAMINATED VENEER LUMBER
 MAX. = MAXIMUM
 MIN. = MIN. = MINIMUM
 NTS. = NOT TO SCALE
 O.C. = ON CENTER
 OPP. = OPPOSITE
 R.O. = ROUGH OPENING
 S.F. = SQUARE FEET
 T.O. = TOP OF
 TYP. = TYPICAL
 W/ = WITH
 ' = INCHES
 ' = FEET
 # = NUMBER

MONOLITH PROTOTYPE

P R O J E C T R E E
 2 1 4 N O R T H L E X I N G T O N S T R E E T
 PITTST T S B U R G H , P A 1 5 2 1 3

DESIGN BUILD STUDIO

CARNEGIE MELLON UNIVERSITY
 SCHOOL OF ARCHITECTURE
 5000 FORBES AVENUE
 PITTSBURGH, PA 15213

K Y L E B O A N C R O A V I S T
 T A K U M I J O R D A N C R O A V I S T
 T A K Y L O R L A T I M E R
 D E C E M B E R 1 0 . 2 0 1 9
 F O R E R E V I E W

SYMBOLS:
 W1 — ASSEMBLY DESIGNATION
 WALL TYPE TAG

15 — NOTE DESIGNATION
 KEYNOTE TAG

11300 — SHEET DETAIL
 ELEVATION TAG

11400 — SHEET DETAIL
 BUILDING SECTION TAG

11500 — SHEET DETAIL
 WALL SECTION TAG

RESTROOM [101 203 SF] — ROOM NAME
 [101 203 SF] — SQUARE FOOTAGE
 ROOM NUMBER

A33 — DESIGNATOR
 WINDOW TYPE TAG

333C — DESIGNATOR
 DOOR TYPE TAG

A202 — DETAIL SHEET

DETAIL REFERENCE TAG

LL* — DESIGNATOR

SPOT ELEVATION TAG

S44 — SLOPE DIRECTION

SLOPE TAG

SC2 — DESIGNATOR
 BEAM SC2

CENTERLINE TAG

ENTRANCE — MAIN ENTRANCE

ENTRANCE — SECONDARY ENTRANCE

COVERED SECONDARY ENTRANCE

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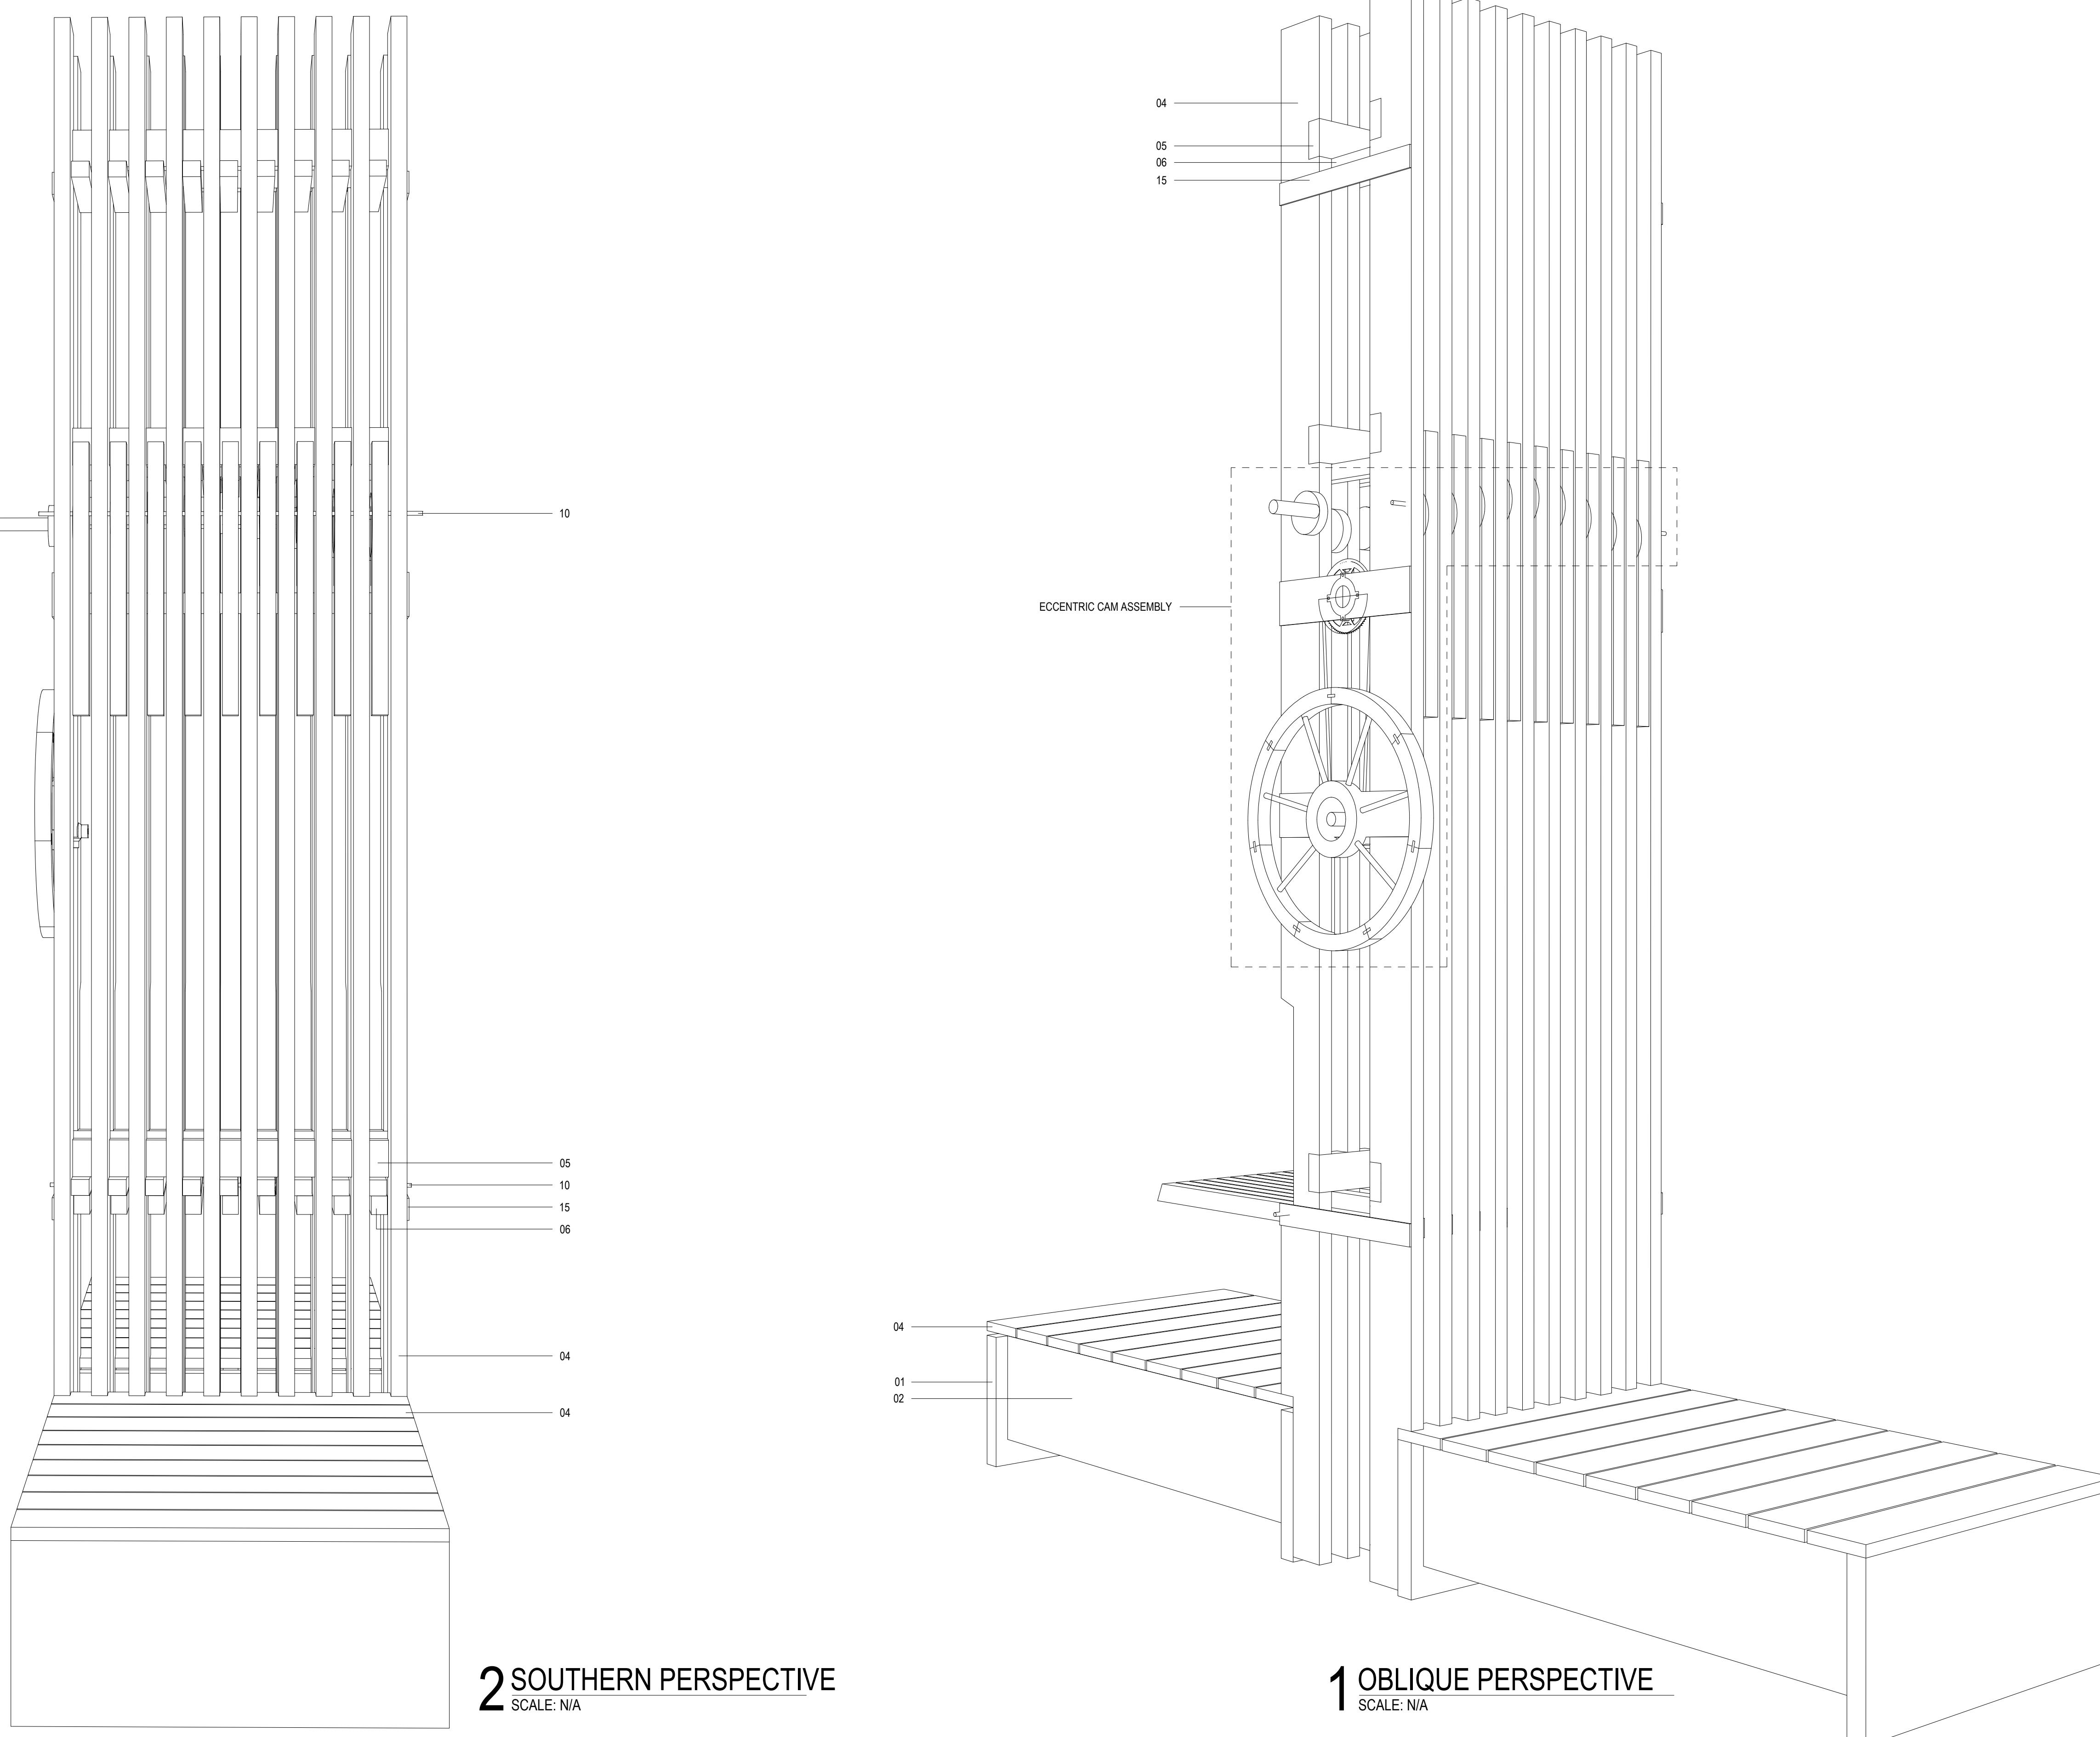
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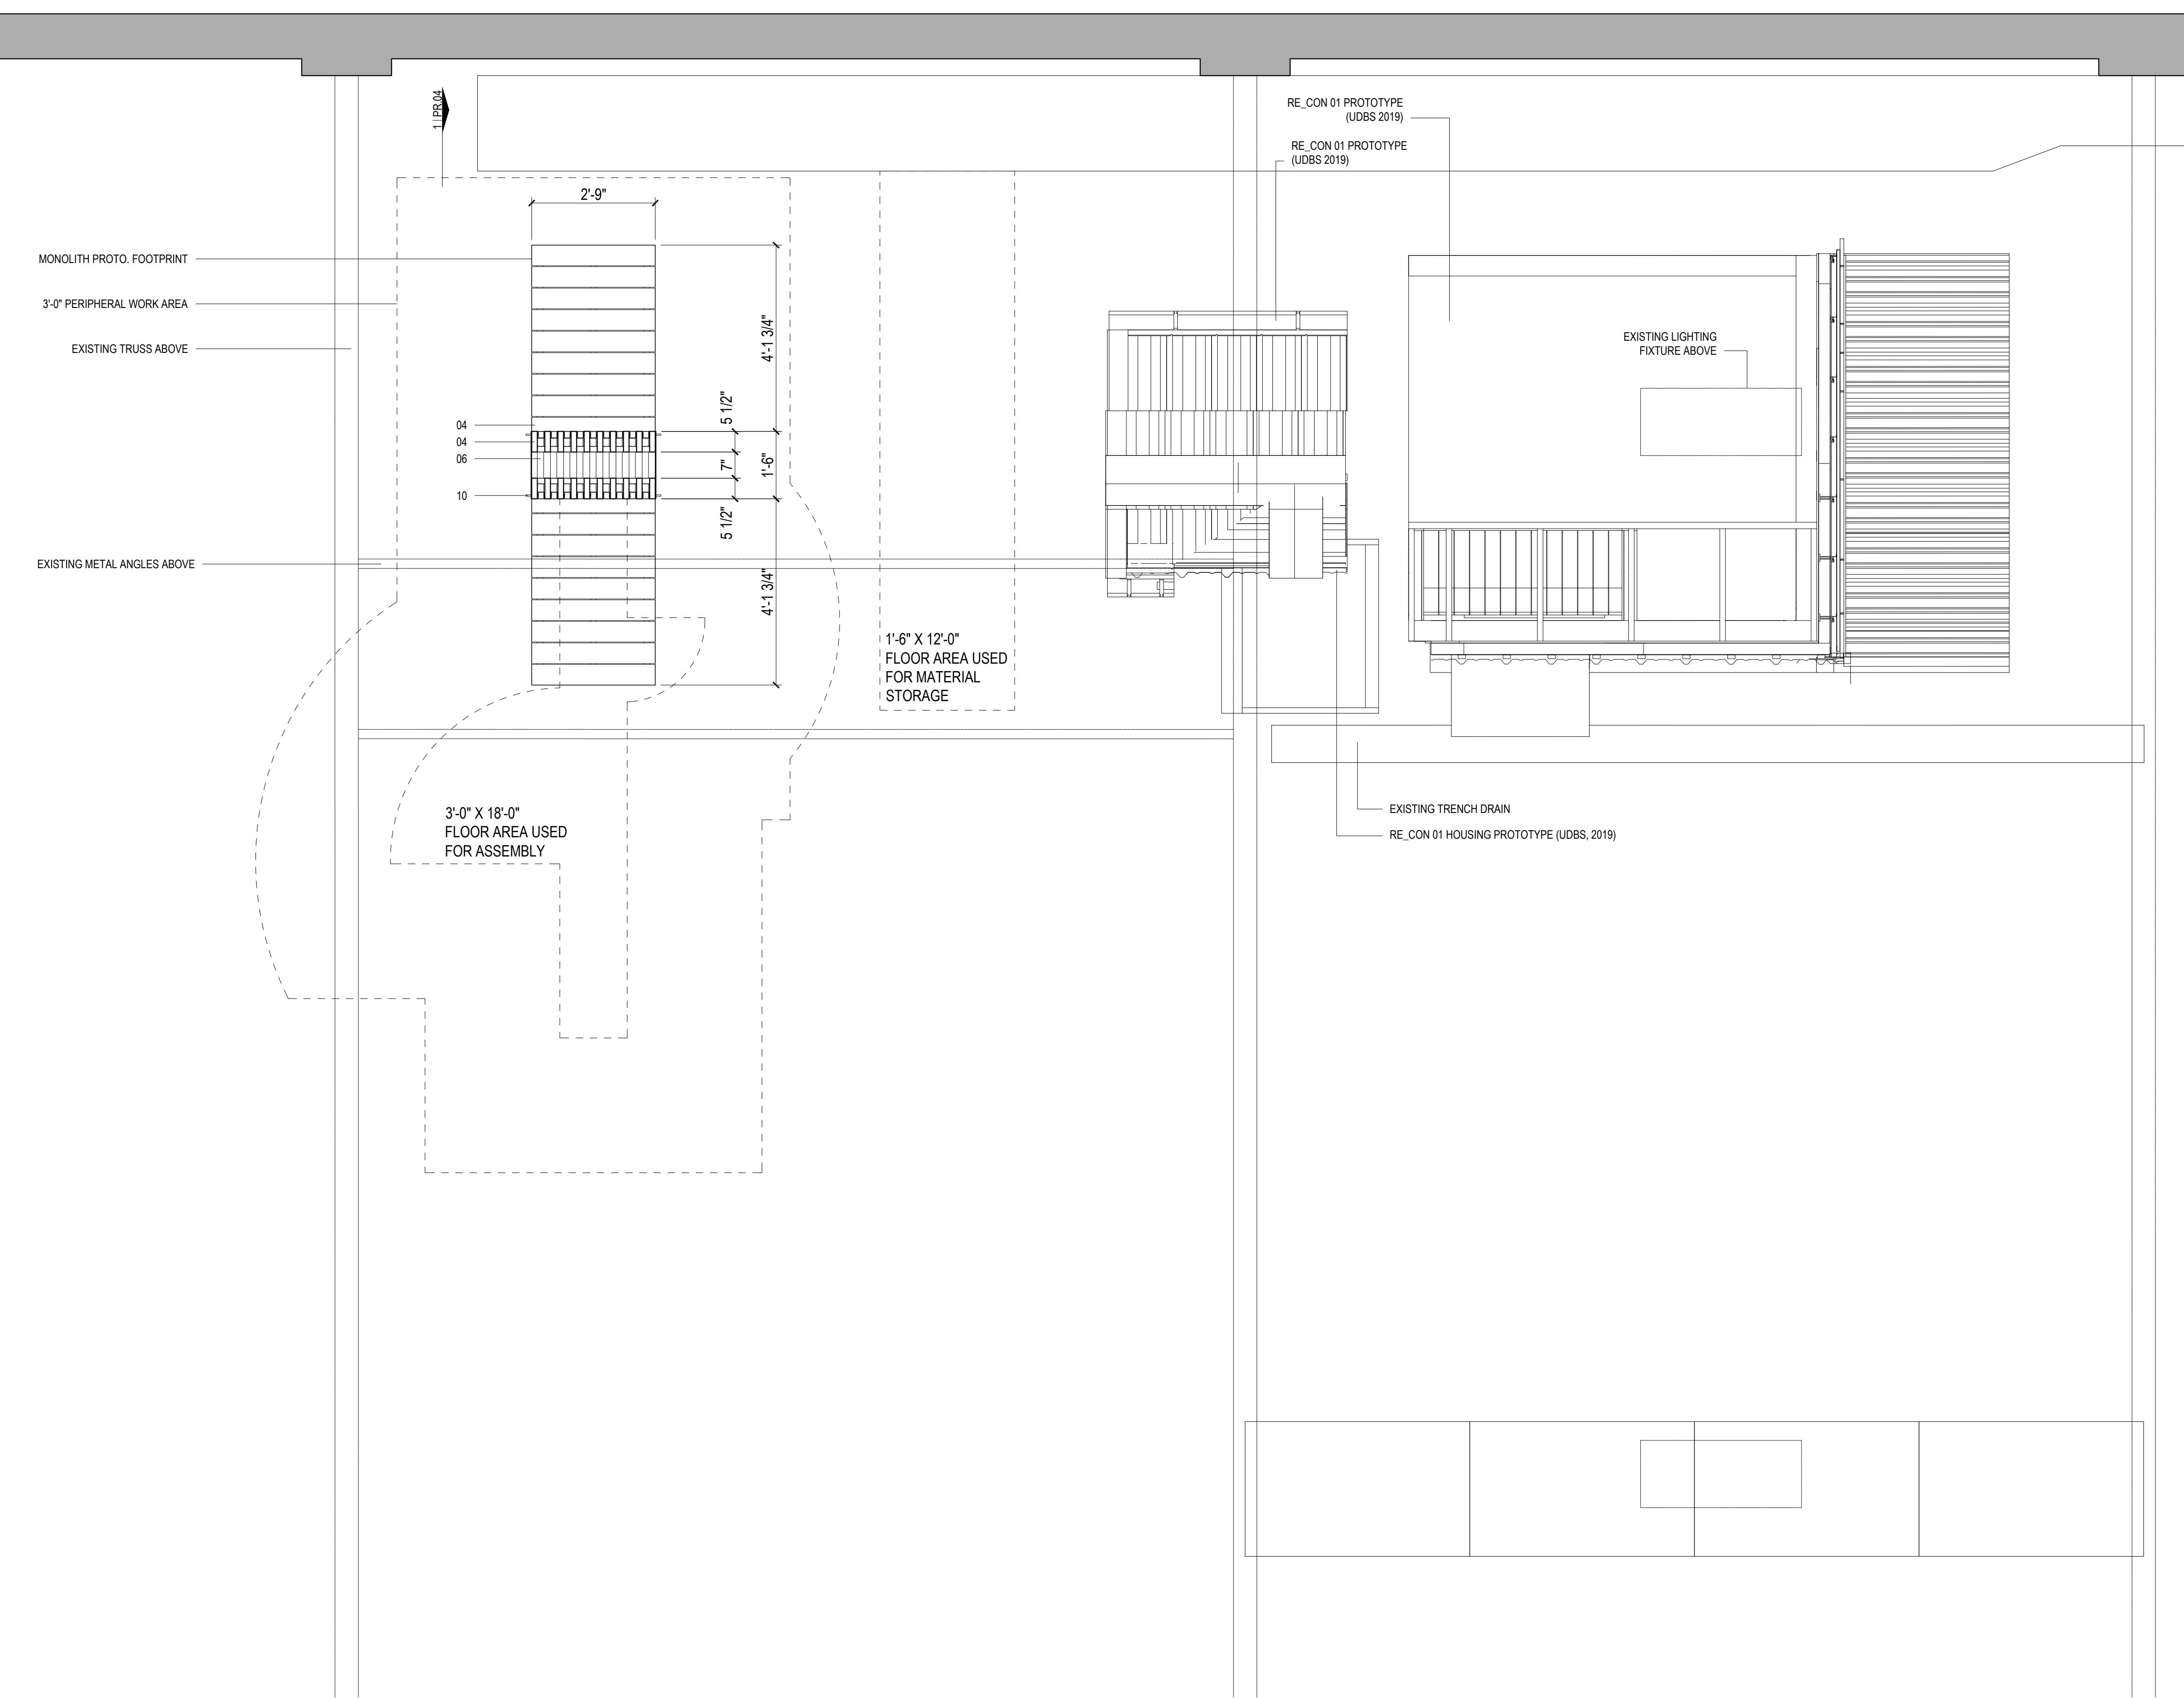


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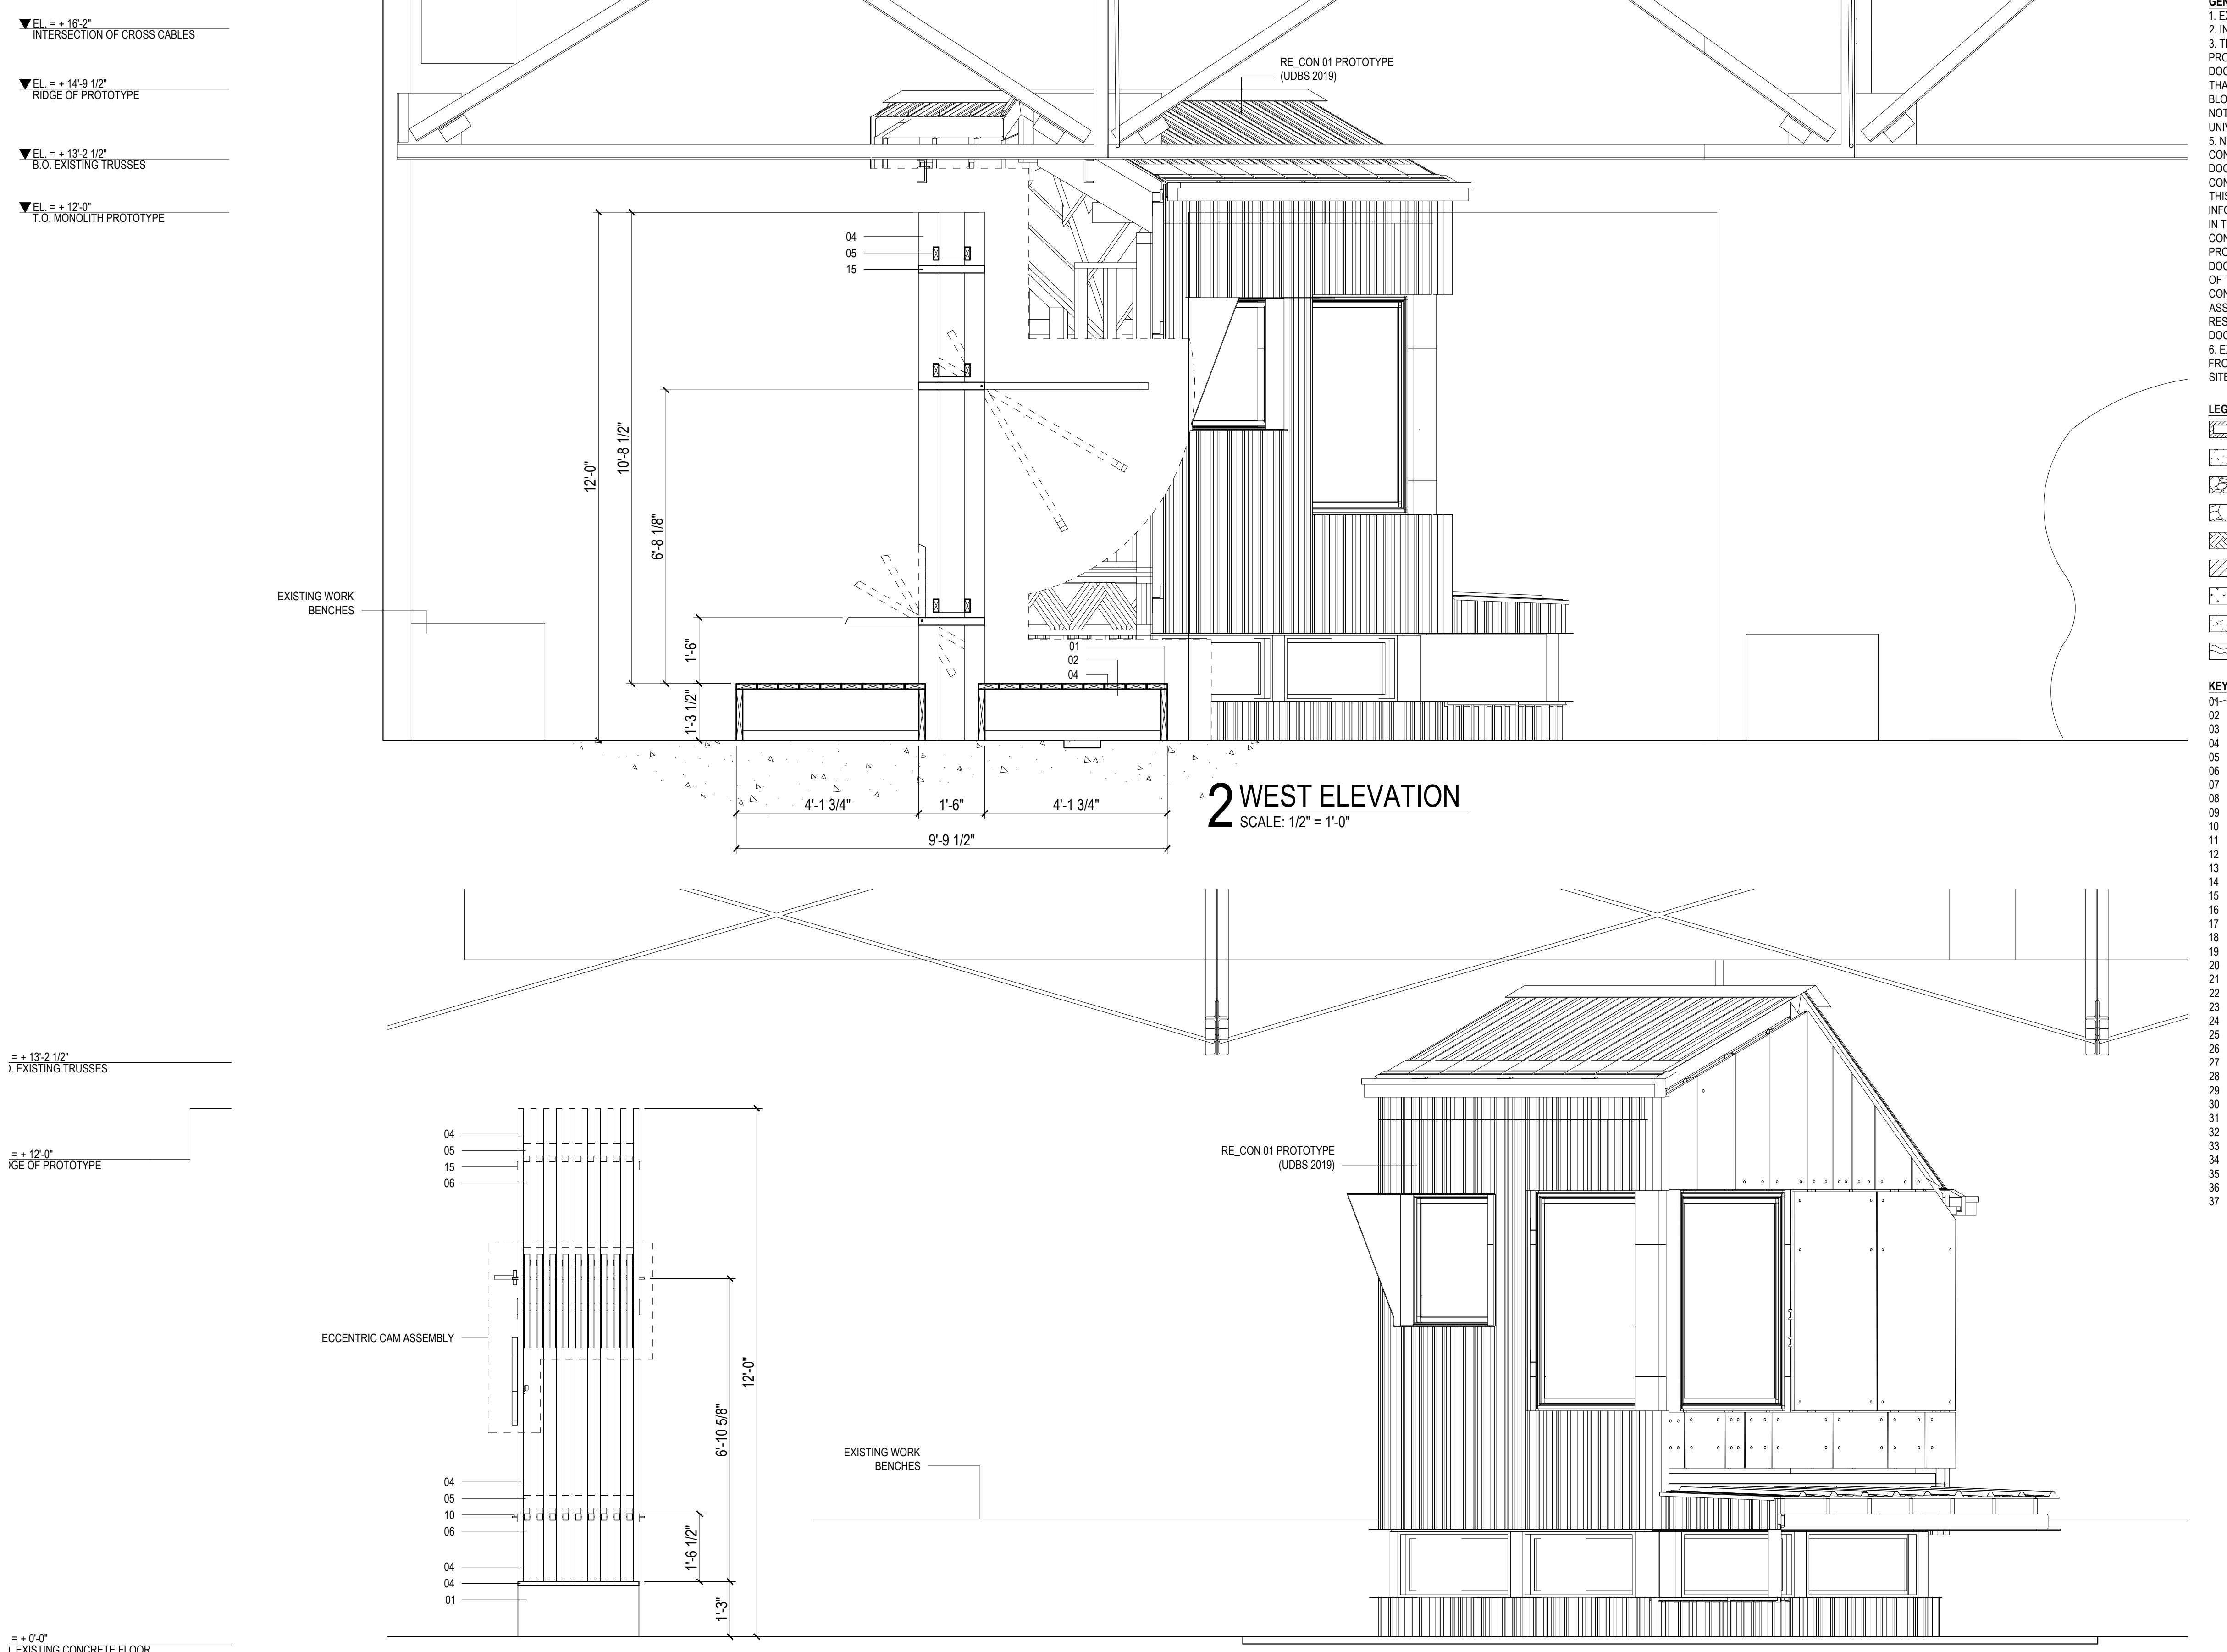
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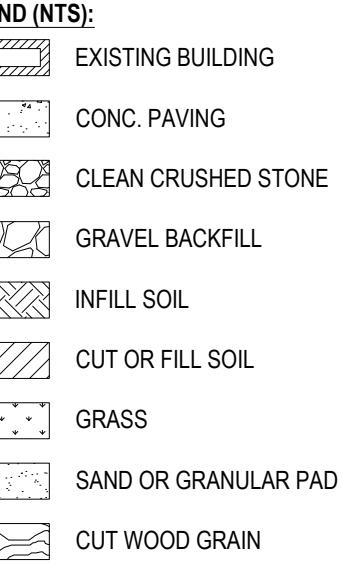
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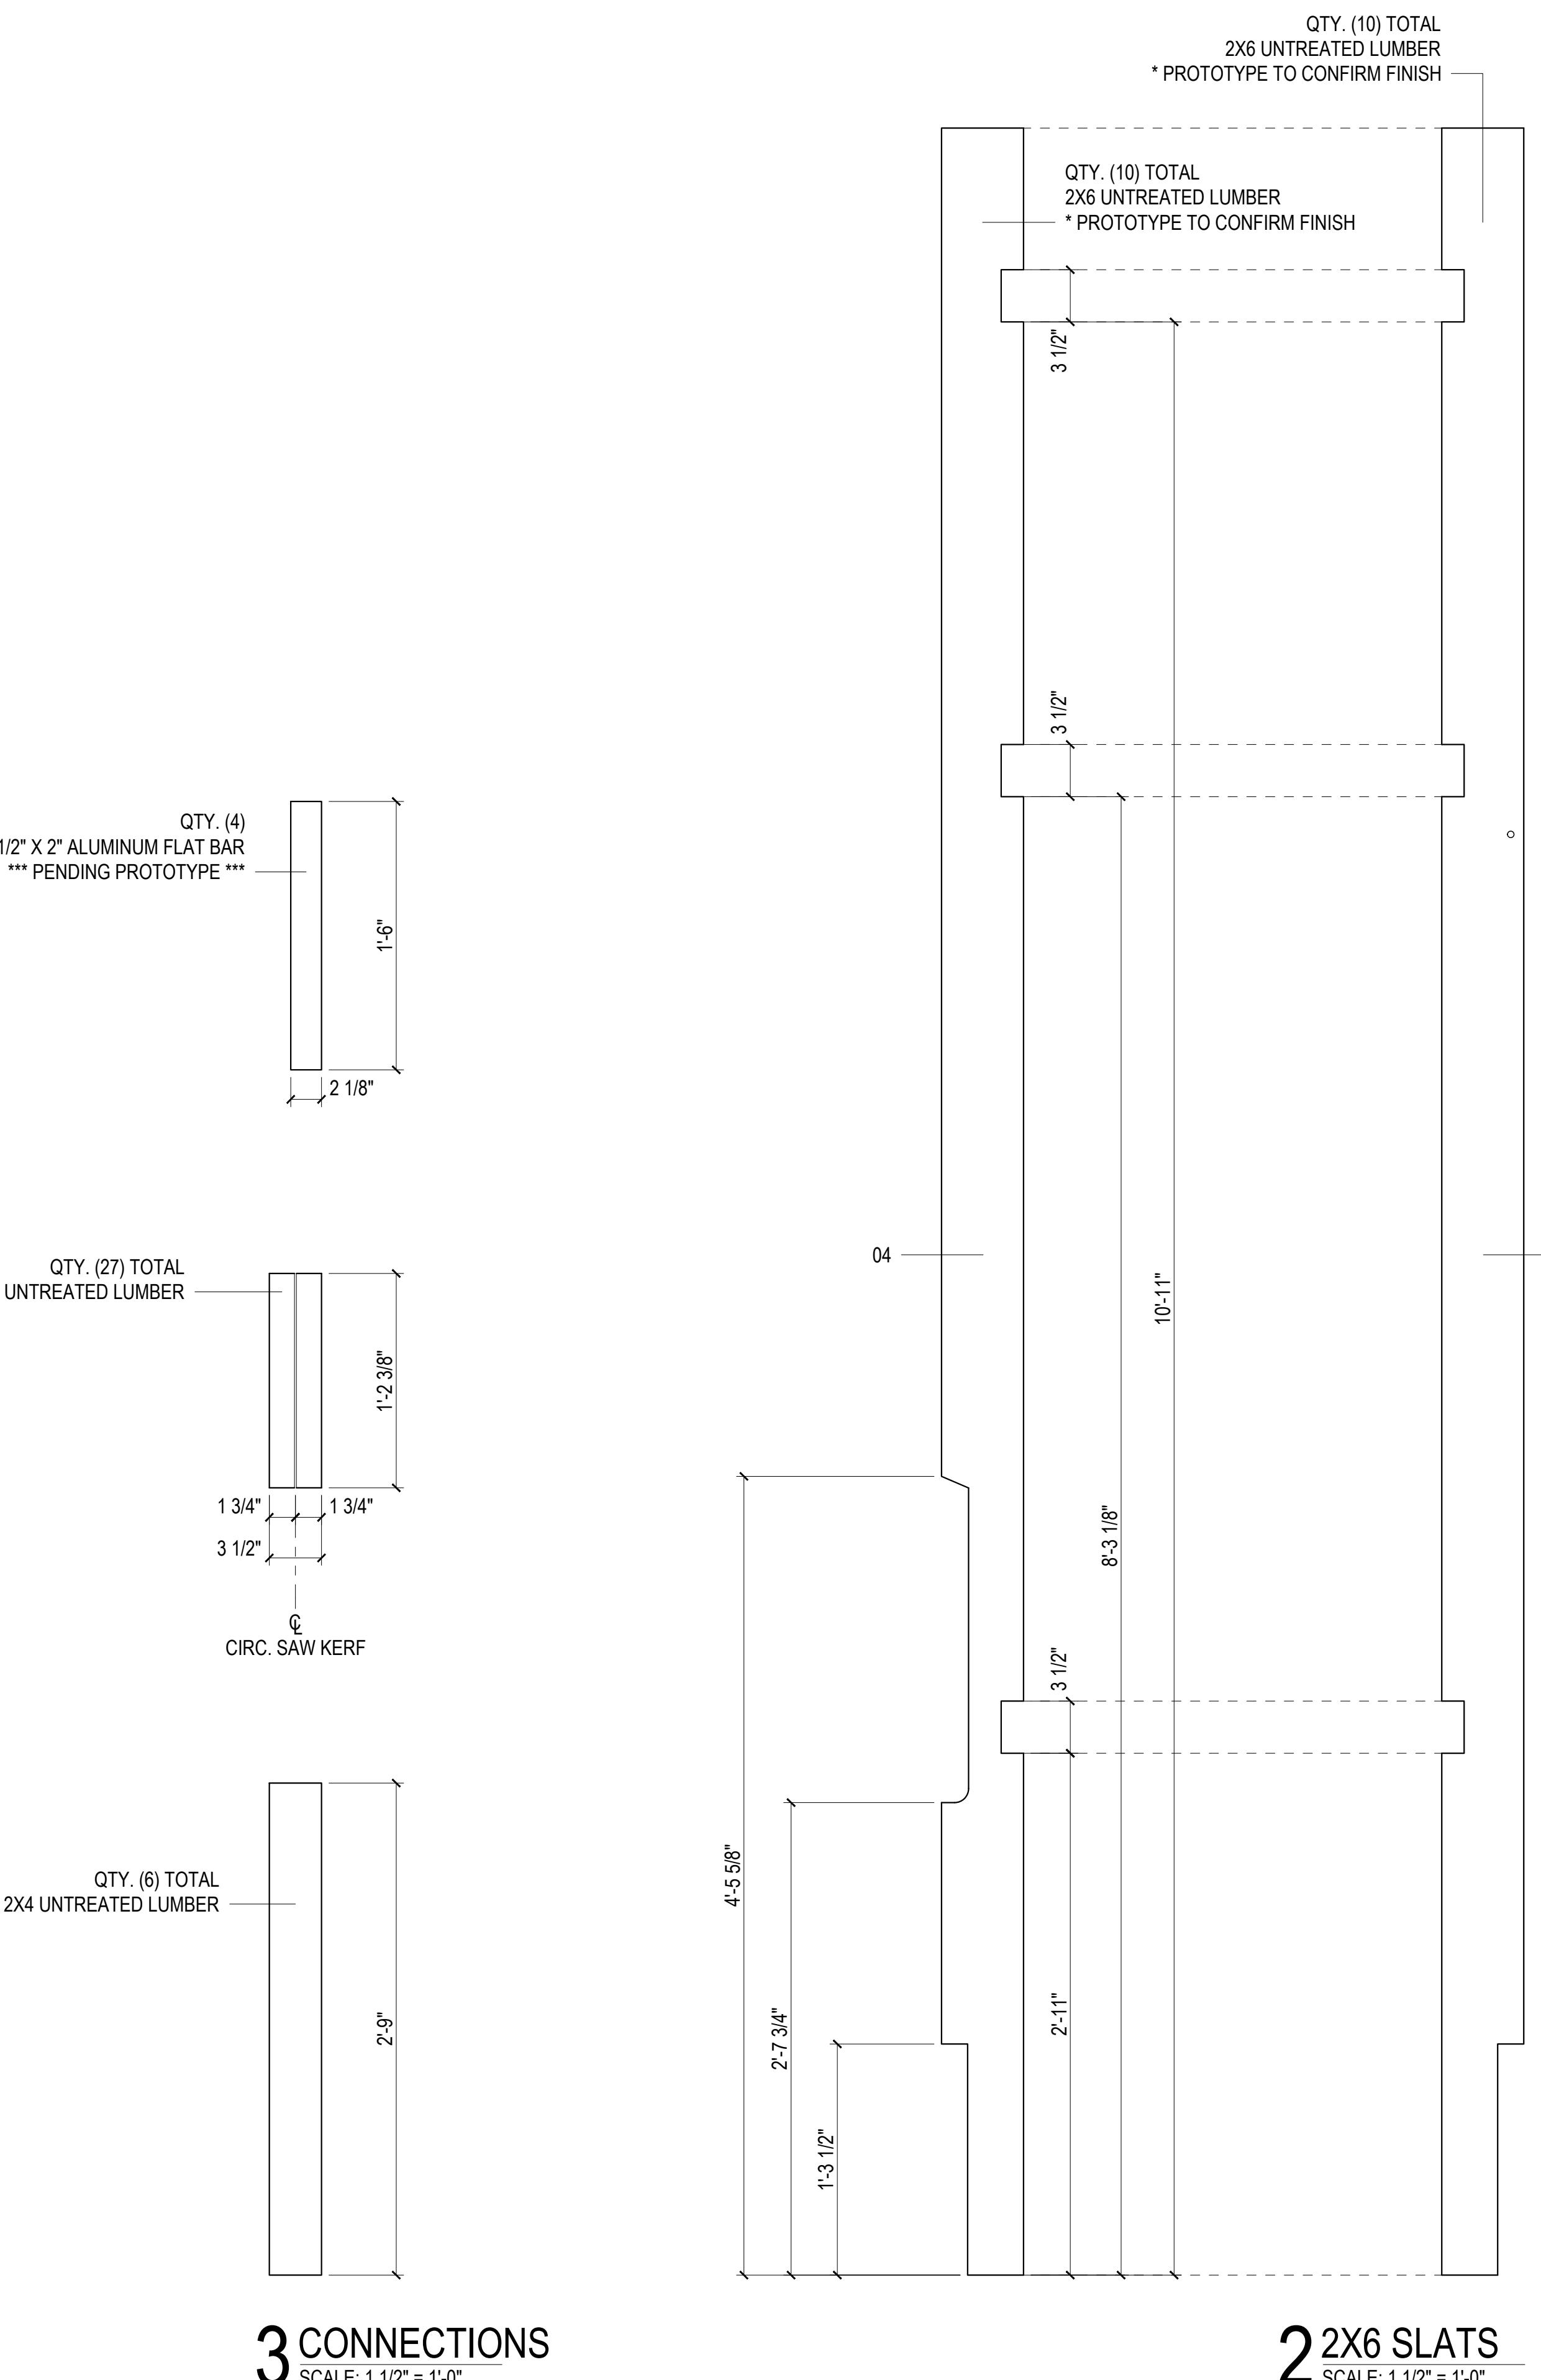
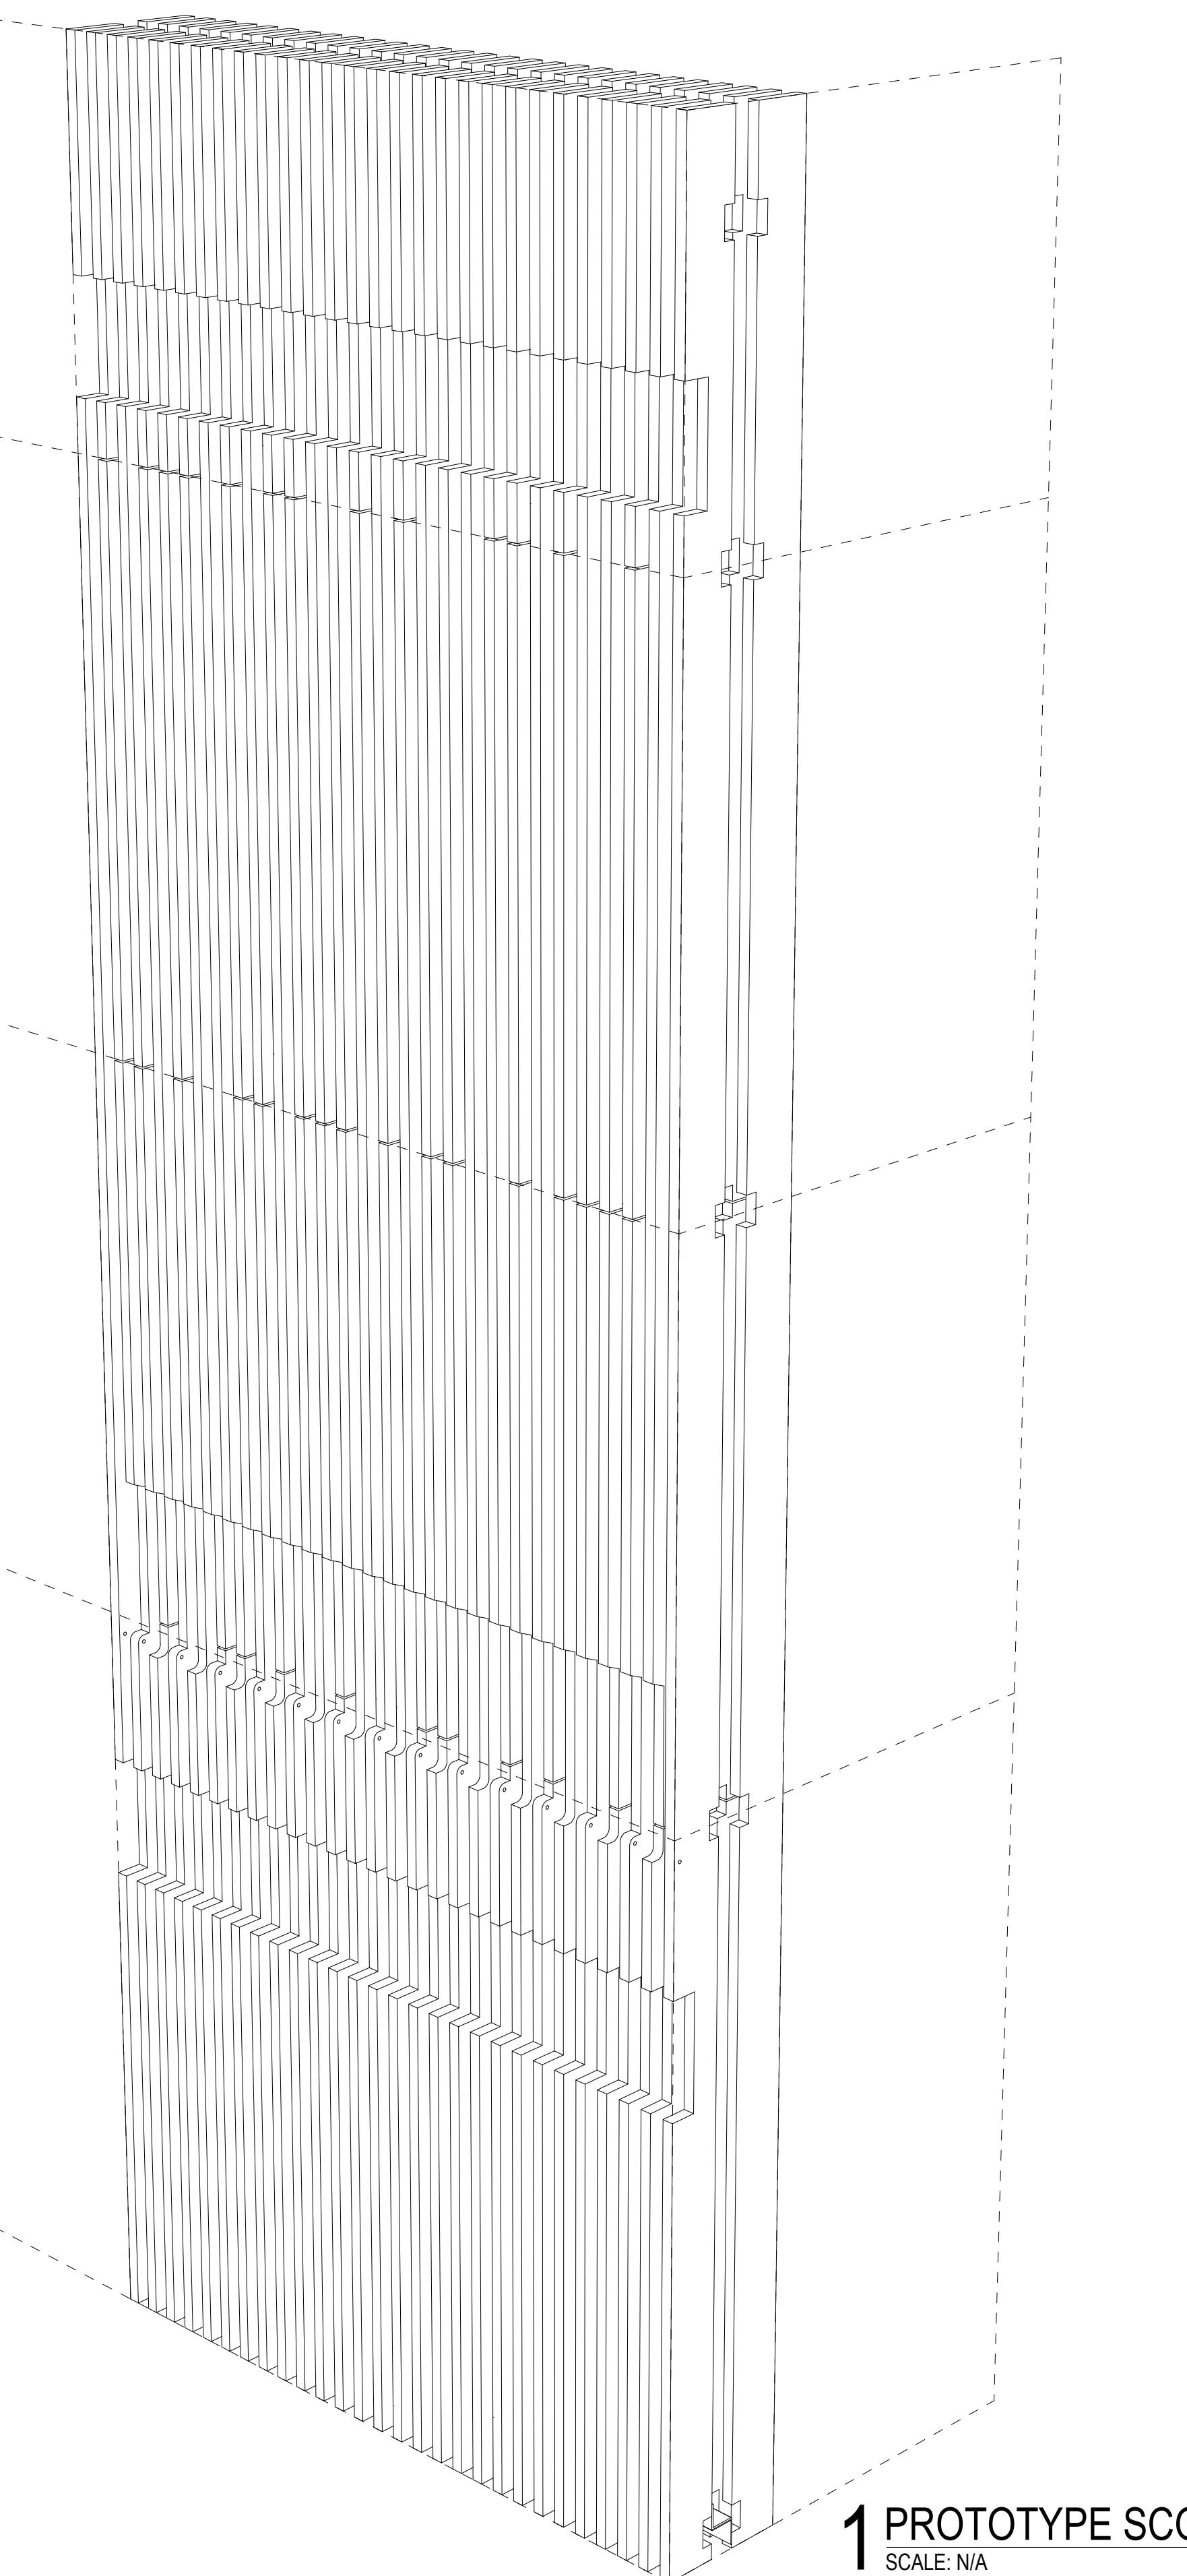
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 - 26 1.25" DIAM. ALUMINUM RAILING
 - 27 NICKEL DECORATIVE HANDRAIL BRACKET
 - 28 8" RISE, 11" DEPTH PRESSURE TREATED STAIR STRINGER
 - 29 EXTERNAL GRADE NAIL @ 6" LG.
 - 30 EXTERNAL GRADE NAIL @ 3 1/8" LG.
 - 31 DOUBLE PANED SKYLIGHT
 - 32 CONCRETE DRILL BOLT @ 6 3/4" LG.
 - 33 CONCRETE DRILL BOLT @ 3" LG.
 - 34 CONCRETE ANCHOR @ 1 1/2" LG.
 - 35 7/16" DIAM. OPENING NUT
 - 36 INTERNAL STEEL CONNECTOR
 - 37 WINDOW ADJUSTMENT WHEEL



WOODHENGE

PR.06
PROTOTYPE ASSEMBLY SEQUENCE

DRAWN BY:
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CARNEGIE MELLON UNIVERSITY
500 FORBES AVENUE
PITTSBURGH, PA 15213

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2. INTERIOR DIMENSIONS ARE TAKEN FROM FACE OF STUD UNLESS OTHERWISE NOTED.
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5. EXISTING SITE INFORMATION IS BASED ON ALLEGHENY COUNTY G.I.S. INFORMATION FROM THE PENNSYLVANIA SPATIAL DATA ACCESS (PASDA). OWNER SHALL PROVIDE SITE SURVEY FOR FINAL SITE PLAN AND GRADING.

LEGEND (NTS):

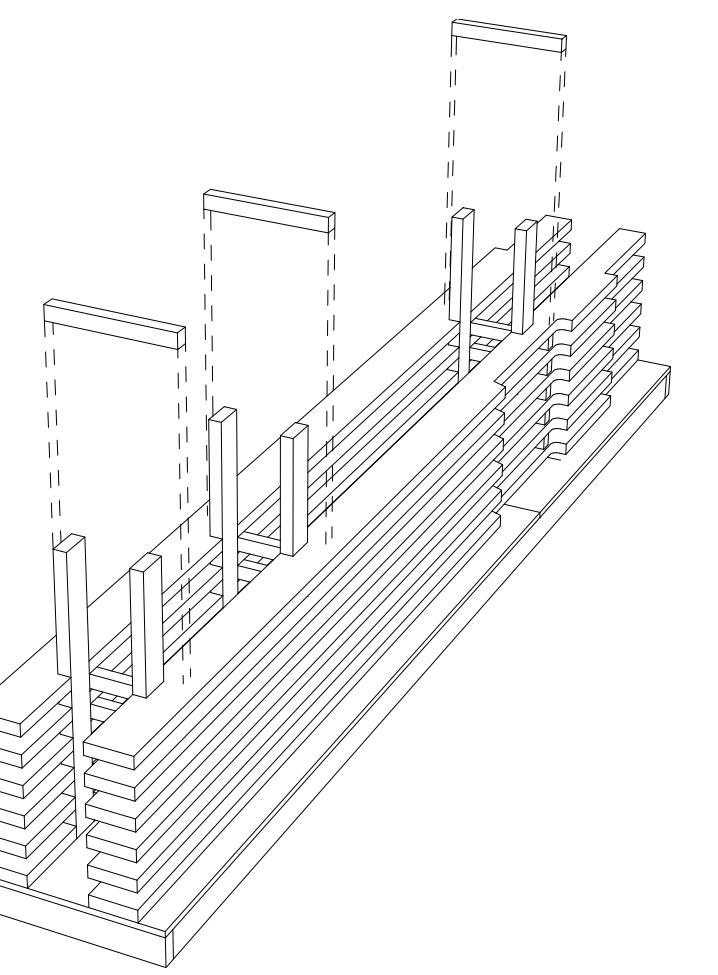
	EXISTING BUILDING
	CONC. PAVING
	CLEAN CRUSHED STONE
	GRAVEL BACKFILL
	INFILL SOIL
	CUT OR FILL SOIL
	GRASS
	SAND OR GRANULAR PAD
	CUT WOOD GRAIN

KEY NOTES:

- 01 ~1.75" X 14" LVL
- 02 2" X 12" UNTREATED DIM. LUMBER
- 03 2" X 8" UNTREATED DIM. LUMBER
- 04 2" X 6" UNTREATED DIM. LUMBER
- 05 2" X 4" UNTREATED DIM. LUMBER
- 06 2" X 2" UNTREATED DIM. LUMBER
- 07 EXISTING TRIPLE WTWE BRICK WALL
- 08 EXISTING WATER TABLE
- 09 EXISTING GRADE
- 10 1/2" ZINC THREADED ROD
- 11 0.5" THK LDPE SPACER
- 12 CAST-IN-PLACE CONCRETE
- 13 NO. 4 REINFORCEMENT
- 14 METAL DECKING
- 15 A36 STEEL ANGLE @ 1.5" X 1.5" X 12 GA.
- 16 GRAVEL BACKFILL
- 17 PEA GRAVEL ROOF FINISH
- 18 EPDM ROOFING MEMBRANE
- 19 3/4" THK OSB PLYWOOD
- 20 METAL FLASHING
- 21 SOIL
- 22 NATIVE PLANTLIFE
- 23 SIMPSON STRONG-TIE GALV. 2x12 HANGER
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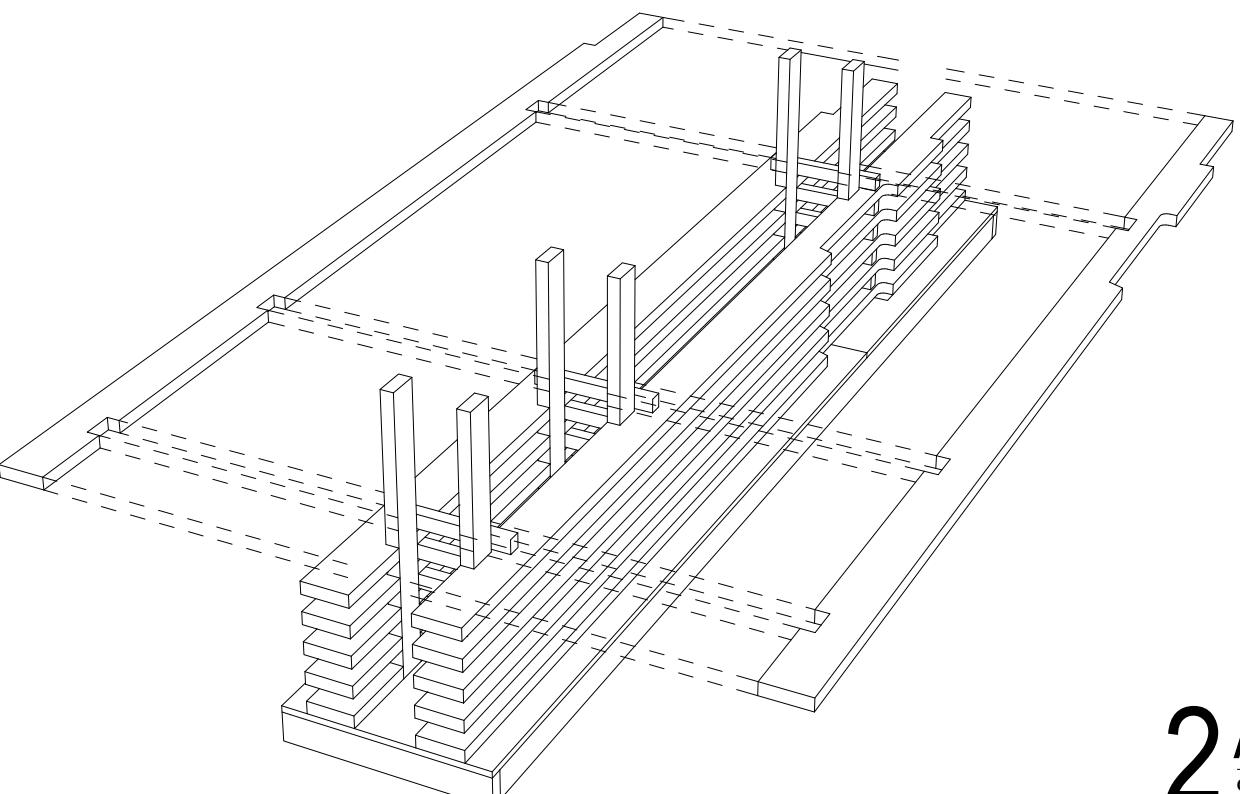
3 ASSEMBLY SEQUENCE

SCALE: N/A



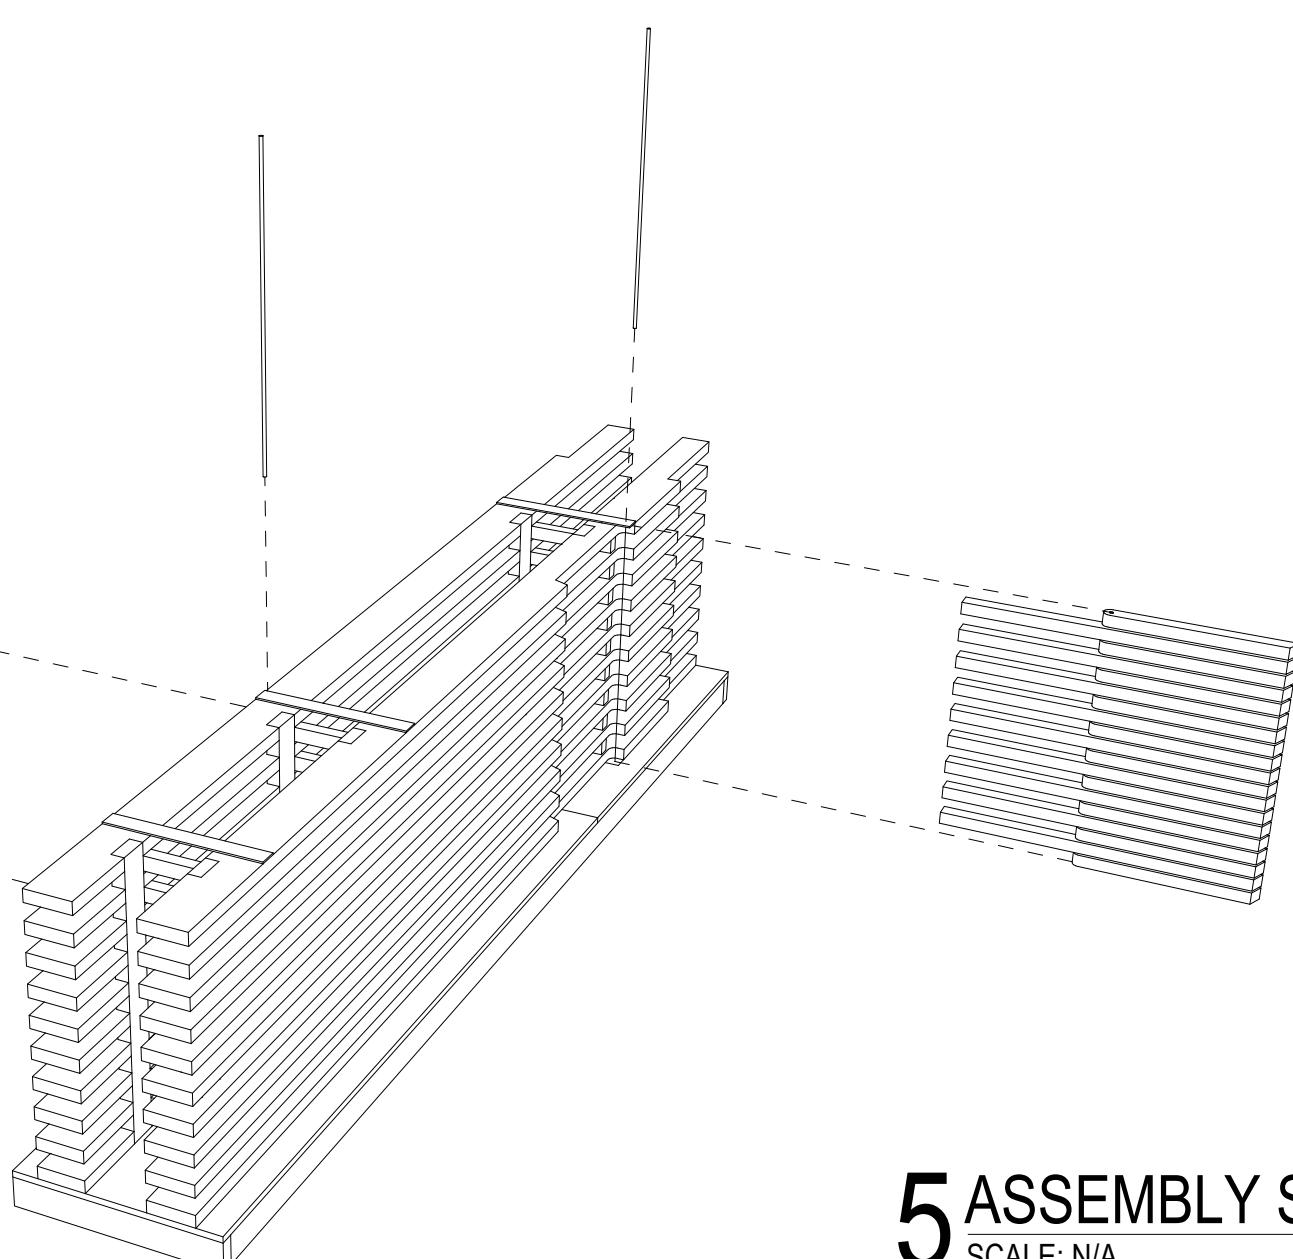
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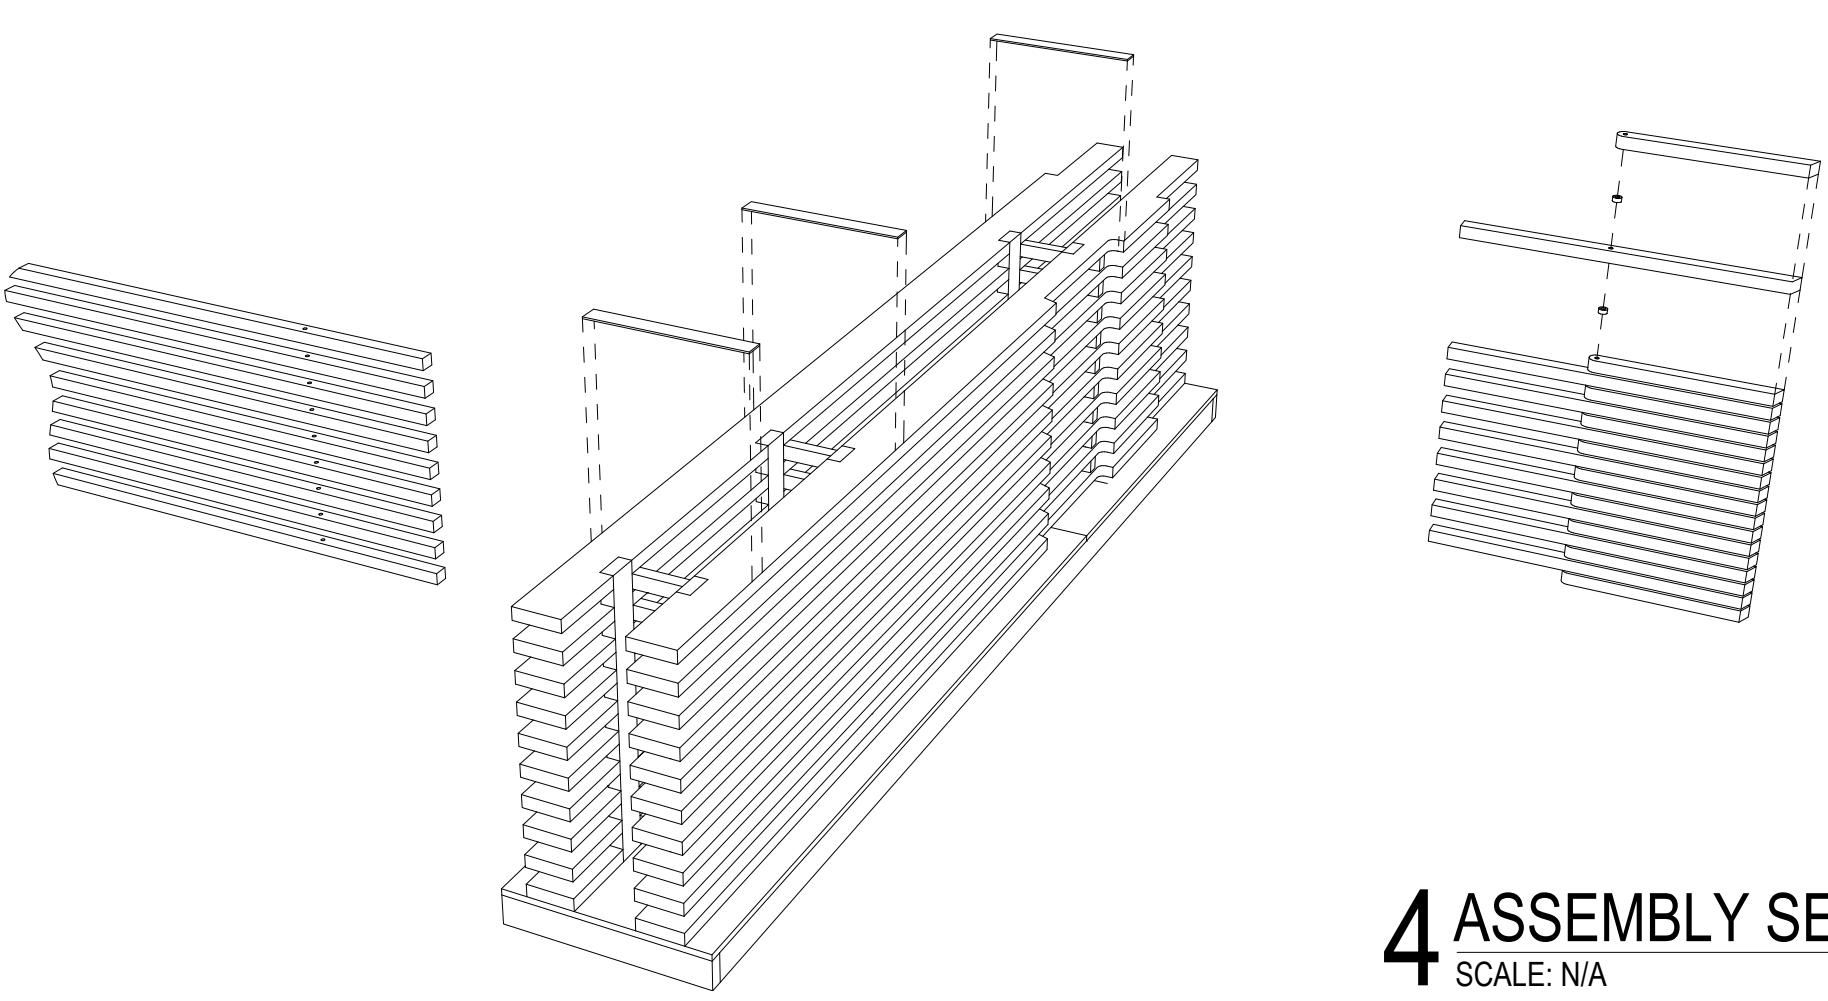
5 ASSEMBLY SEQUENCE

SCALE: N/A



4 ASSEMBLY SEQUENCE

SCALE: N/A



1 ASSEMBLY SEQUENCE

SCALE: N/A

