

LUMOS NETWORKS
JOB NUMBER: R01963-136
ROUTE NAME: RT_29_FDH_01 (C)


PERMIT DRAWING

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LUMOS PROPOSED FIBER OPTIC NETWORK PLACEMENT

CONSTRUCTION METHOD	FOOTAGE
UNDERGROUND	3436'
AERIAL	0'

TOTAL PROPOSED FOOTAGE = 3436'

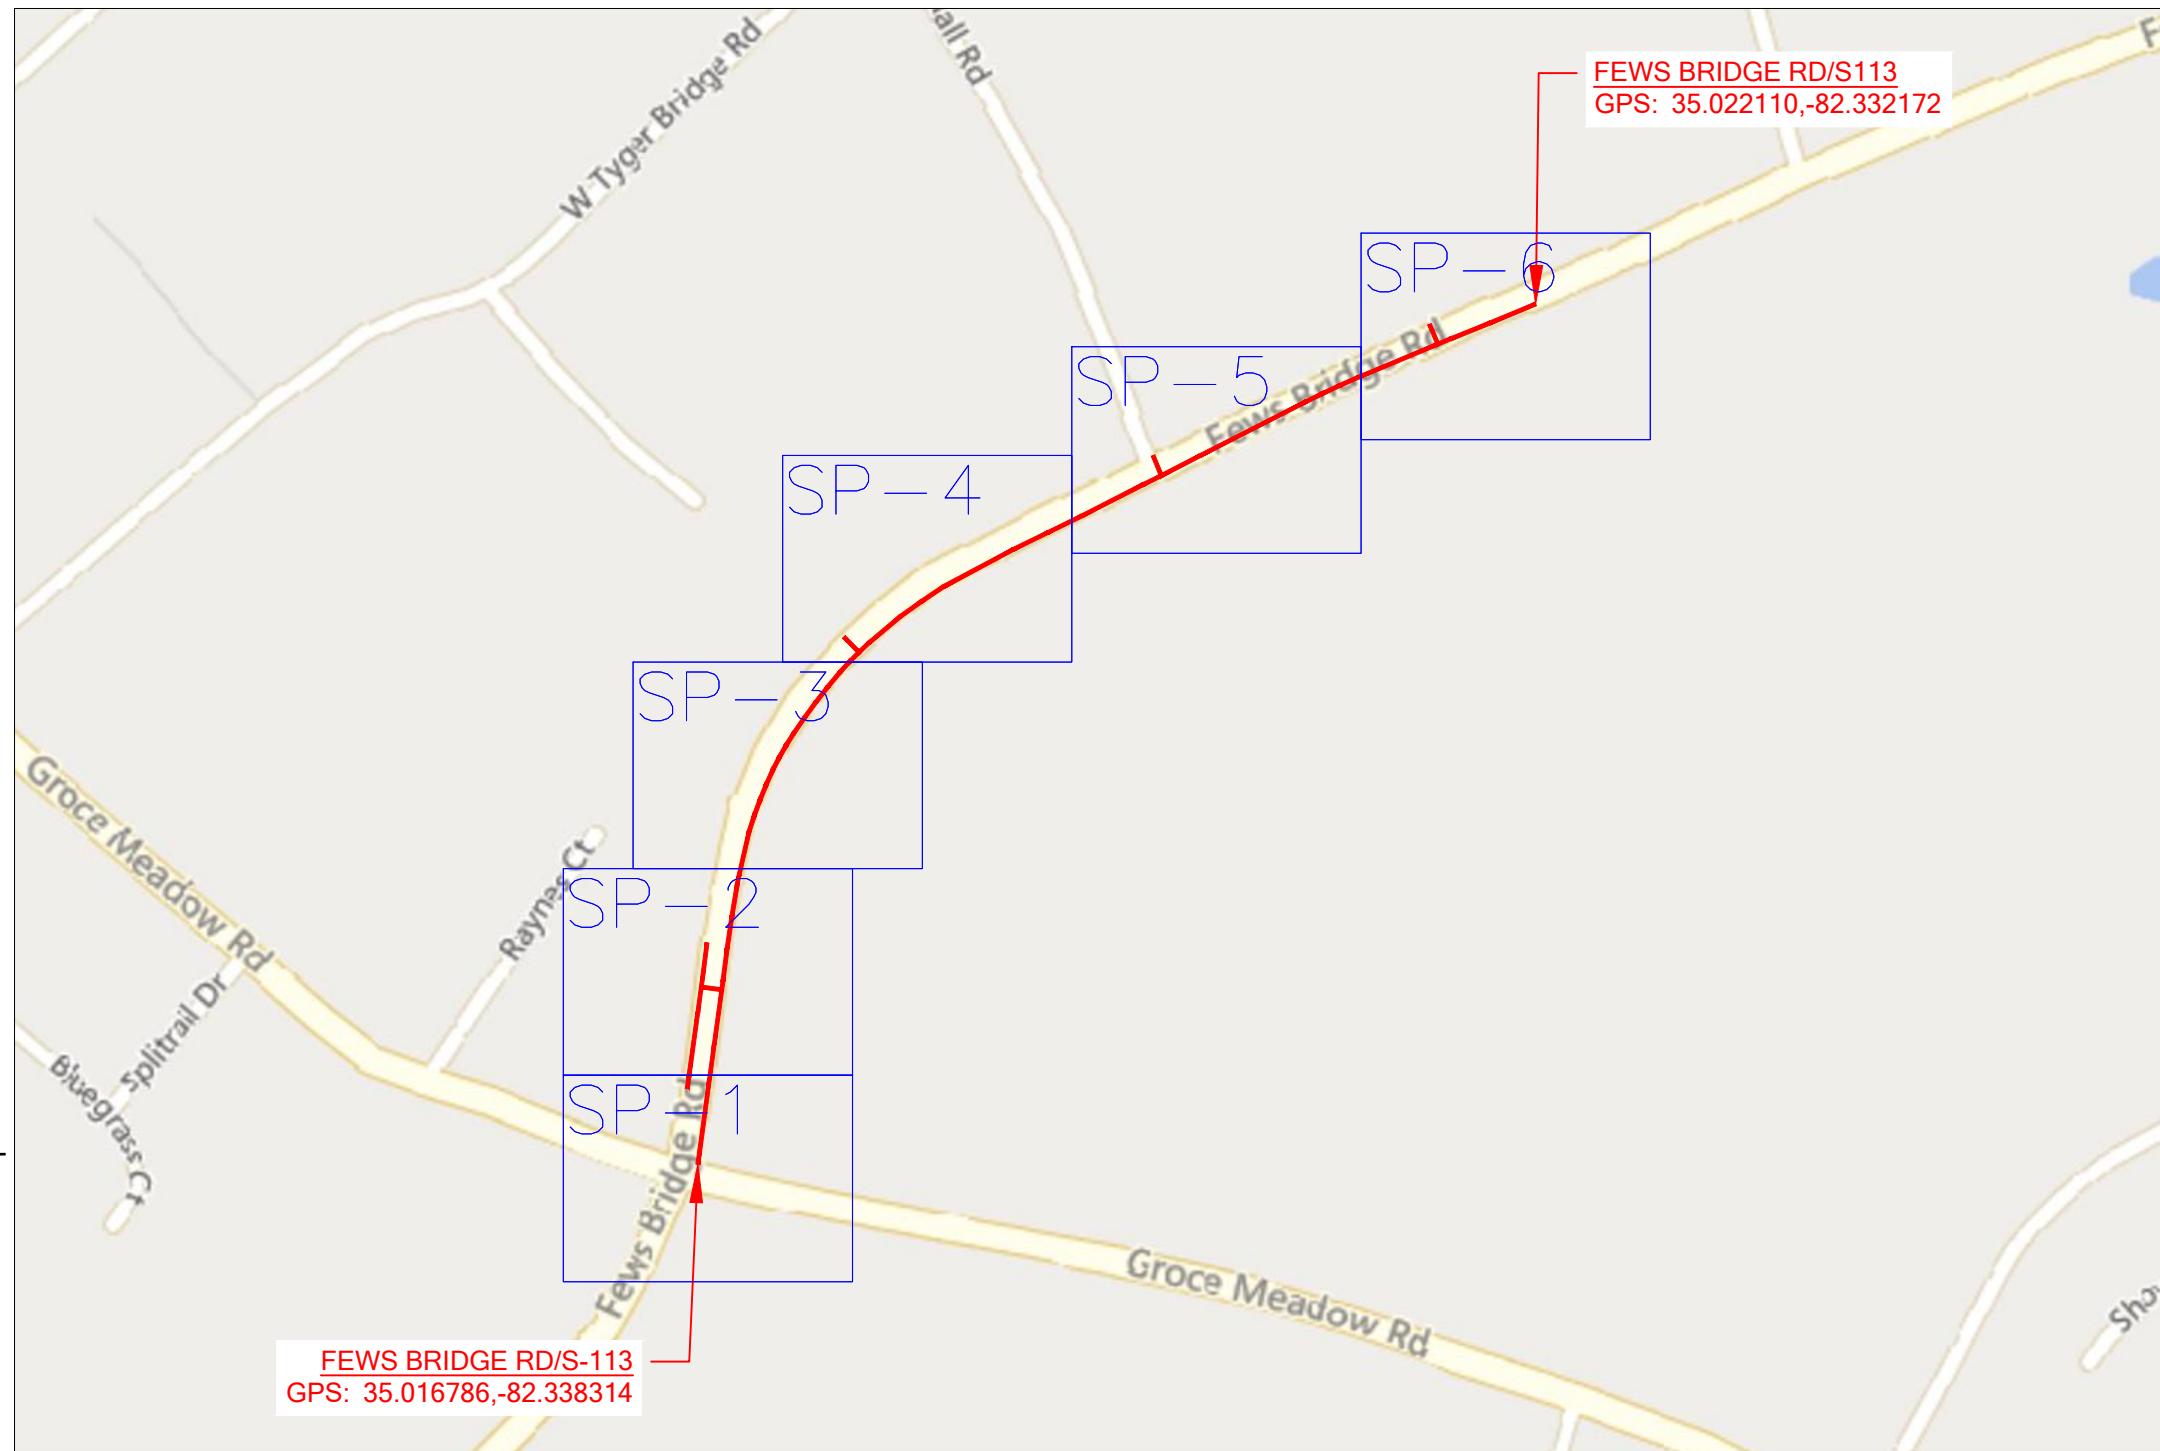

PROJECT INFORMATION

SITE NAME:	RT_29_FDH_01
SITE ADDRESS:	1390 GROCE MEADOW RD
COUNTY:	GREENVILLE
APPROVER:	

SUBMITTAL INFORMATION

REV	DATE	DESCRIPTION	INIT
0	07/16/2024	PERMIT DRAWING	CENT

SHEET TITLE

LOCATION MAP



T-1

1 OF 20

LUMOS:

NAME: RONNY POSTON
(CELL)903-948-3099
NAME: PAUL JERKINS
(CELL)803-413-8686

CENTILLION:


CRAIG BLACK - PROJECT MANAGER
(CELL)720-597-5320

UTILITIES:

SC8II (I-888-72I-7877)

PERMITS:

GREENVILLE COUNTY - PERMIT NUMBER / DATE: TBD
SCDOT - PERMIT NUMBER / DATE: TBD

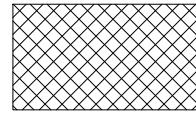LINETYPE LEGEND	
— EOP —	= EX. EDGE OF PAVEMENT
— C/L —	= EX. CENTER LINE
— R/W —	= EX. RIGHT OF WAY
— ESMT —	= EX. EASEMENT
—	= EX. PROPERTY LINE
—	= EX. BUILDING EDGE
— OHF — OHF —	= EX. OVERHEAD FIBER
— BFO — BFO —	= EX. BURIED FIBER
— EX_STRAND —	= EX. BURIED FIBER
—○—○—○—	= EX. FENCE
— GR — GR —	= EX. GUARDRAIL
— — —	= RAILROAD
— OHF —————— 144 ——————	= PROP. OVERHEAD FIBER
— 144 ——————	= PROP. BURIED FIBER
— ORANGE ——————	= PROP. CONDUIT
— STRAND ——————	= PROP. STRAND
— ——————	= PROP. MULTIPORT TAIL
— SD ——————	= STORM DRAINAGE
— SS ——————	= SEWER LINE
— W ——————	= WATER LINE
— T ——————	= TELCO LINE
— TV ——————	= CABLE TV LINE
— E ——————	= ELECTRIC LINE
— TRAFF ——————	= TRAFFIC LINE
— G ——————	= GAS LINE
	= ALL ROADS HATCHED ARE COUNTY ROADS AND NOT FOR SCDOT PERMIT

SYMBOL LEGEND			
SYMBOL	DESCRIPTION	SYMBOL	DESCRIPTION
	PROPOSED ANCHOR & GUY		PROPOSED TERMINAL SPLICE
	FOREIGN/EXISTING ANCHOR & GUY		FIRE HYDRANT
	MGNV		WATER VALVE / METER
	JOINT USE POLE		WATER MANHOLE
	POWER POLE		SEWER MANHOLE
	COMMUNICATION POLE		STORM MANHOLE
	STEEL POLE		STORM INLET / CATCH BASIN
	CATV POLE		GAS VALVE / METER
	PROPOSED POLE		ELECTRIC MANHOLE
	RISER		ELECTRIC HANDHOLE
	PROPOSED STORAGE LOOP		STREET LIGHT
	PROPOSED AERIAL SPLICE		BURIED TRANSFORMER
	PROPOSED BURIED SPLICE		TRAFFIC HANDHOLE
	PROPOSED AERIAL FIBER DIRECTION		TRAFFIC POLE / SIGNAL
	PROPOSED BURIED FIBER DIRECTION		TELCO MANHOLE
	PROPOSED HANDHOLE		TELCO HANDHOLE
	EXISTING HANDHOLE		TELCO PEDESTA:L
	PROPOSED PEDESTA:L		CABLE TV HANDHOLE
	EXISTING PEDESTA:L		CABLE TV PEDESTA:L
	PROPOSED FLOWER POT		PROPOSED 1x8 SPLITTER
	PROPOSED LCP CABINET		PROPOSED 1x4 SPLITTER
	EXISTING LCP CABINET	—	SIGN
—	CULVERT		FIBER MARKER



GENERAL NOTES:

1. ALL WORK WILL COMPLY WITH APPLICABLE LOCAL, STATE, AND FEDERAL REGULATORY AGENCIES, INCLUDING, BUT NOT LIMITED TO, OSHA, NESC, DOT, RPA, ETC. GENERAL NOTES WILL APPLY TO ALL DRAWINGS.
2. ALL TRAFFIC CONTROL DEVICES WILL BE IN PLACE PRIOR TO CONSTRUCTION. DEVICES NO LONGER NEEDED WILL BE REMOVED AS QUICKLY AS POSSIBLE.
3. PEDESTRIAN TRAFFIC AREAS MUST BE MAINTAINED AT ALL TIMES. PEDESTRIANS WILL NOT BE ROUTED ON TO PRIVATE PROPERTY.
4. NO MATERIALS OR EQUIPMENT WILL BE STORED OR ALLOWED TO STAND UNPROTECTED WHERE PEDESTRIAN OR VEHICULAR TRAFFIC IS PRESENT.
5. NO EQUIPMENT OR MATERIALS WILL BE STORED ON ROAD SURFACE DURING NON-WORK PERIODS.
6. NO EQUIPMENT OR MATERIALS MAY BE STORED ON THE SIDEWALK.
7. EXCAVATION MATERIAL WILL BE STORED AWAY FROM THE PAVED ROADWAY. ALL SPILLED MATERIAL WILL BE PICKED UP IMMEDIATELY.
8. MUNICIPAL ROAD SIGNS, DELINEATORS, GUARDRAILS, ETC. WILL NOT BE REMOVED WITHOUT PRIOR WRITTEN PERMISSION FROM THE APPROVING AUTHORITY.
9. ALL WORK WILL BE PERFORMED IN ACCORDANCE WITH THE CITY, COUNTY, TOWNSHIP AND STATE SPECIFICATIONS AND STANDARDS.
10. GROUND RESTORATION/RIGHT-OF-WAY SHALL BE RESTORED TO ORIGINAL OR BETTER CONDITION.
11. ANY CONDUIT/INNERDUCT RUNNING LINES SHOWN ON PRINT ARE ESTIMATES ONLY. ACTUAL RUNNING LINES TO BE DETERMINED VIA TEST HOLES BY CONTRACTOR PRIOR TO TRENCHING OPERATION. MOST UNDERGROUND UTILITIES ARE NOT SHOWN ON PRINTS. CONTACT UTILITY COMPANIES FOR EXACT LOCATION.
12. THE CONTRACTOR SHALL BE RESPONSIBLE FOR ALL DAMAGE TO STREETS, CURBS, ROADS, HIGHWAYS, SHOULDERS, DITCHES, EMBANKMENTS, CULVERTS, STORM DRAINS, BRIDGES OR OTHER PUBLIC OR PRIVATE PROPERTY, REGARDLESS OF LOCATION OR CHARACTER, WHICH MAY BE CAUSED BY MOVING, HAULING OR OTHERWISE TRANSPORTING EQUIPMENT MATERIALS OR MEN TO OR FROM WORK OR ANY SITE THERE-OF, WHETHER BY HIM OR HIS CONTRACTOR OR SUBCONTRACTOR.
13. EXTREME CARE SHALL BE EXERCISED TO AVOID HITTING OR CAUSING DAMAGE TO AERIAL AND SUBSURFACE OBSTRUCTIONS, OWNERS OF STRUCTURES WILL BE NOTIFIED IN ADVANCE OF EXCAVATION WORK BY THE CONTRACTOR AND A REQUEST WILL BE MADE TO LOCATE THE AFFECTED PLANT.
14. ALL MATERIAL PLACED SHALL BE APPROVED BY A PROJECT MANAGER.
15. DEVIATIONS FROM THE ENGINEERED ROUTE REQUIRES A PROJECT MANAGER AND RIGHT-OF-WAY OWNER OR CARETAKER APPROVAL PRIOR TO CONSTRUCTION.
16. CABLE SHALL BE UNREELED AND REREELED IN FIGURE 8 FASHION AT BRIDGES, RAILROAD TRACKS, ROADS, STREETS, UTILITY CROSSINGS AND OTHER LOCATIONS TO PREVENT CUTTING OF THE CABLE UNLESS NOTED IN THE DESIGN.
17. WHERE PERMITS FROM STATE, COUNTY, TOWNSHIP, CITY, RAILROAD OR GOVERNMENTAL AGENCIES ARE REQUIRED, ALL WORK PERFORMED WILL COMPLY WITH THESE AGENCIES STANDARD SPECIFICATION.
18. THE CONTRACTOR SHALL NOTIFY BUILDING MANAGEMENT WHEN WORK WILL BEGIN ON BUILDING. CONTRACTOR TO COORDINATE ROOM ACCESS AND WORK START AND STOP TIMES WITH BUILDING MANAGEMENT.

CONSTRUCTION NOTES:

19. CONTRACTOR SHALL BE LIABLE FOR ANY DAMAGE DONE TO EXISTING STRUCTURE DURING THE COURSE OF PERFORMING THE JOB INDICATED ON THE PRINTS, REPAIR AND/OR REPLACEMENT OF DAMAGE TO BUILDING SHALL BE DONE SOLELY AT THE CONTRACTORS EXPENSE.
20. THE PROJECT MANAGER WILL RESERVE THE RIGHT TO INSPECT AT ANY TIME THE WORK BEING PERFORMED BY THE CONTRACTOR. IF STC/SNC DETERMINES THAT THE WORK IS NOT BEING PERFORMED TO MINIMUM QUALITY STANDARDS, THEN THE CONTRACTOR SHALL PROVIDE REWORK AT HIS OWN COST.
21. ANY CHANGE IN PROJECT SCOPE, INCLUDING BUT NOT LIMITED TO, CONDUIT LENGTH, CONDUIT PATH, AERIAL PATH ETC., MUST BE APPROVED BY THE PROJECT MANAGER.
22. ALL CORING/CONSTRUCTION THAT WILL CAUSE NOISE AND/OR VIBRATION SHALL BE DONE OUTSIDE NORMAL BUSINESS HOURS OR TO THE DISCRETION OF THE BUILDING MANAGEMENT.
23. THE CONTRACTOR SHALL PROTECT, SHORE, BRACE AND MAINTAIN ALL UNDERGROUND PIPES, CONDUITS, DRAINS AND OTHER UNDERGROUND CONSTRUCTION UNCOVERED OR OTHERWISE AFFECTED BY THE CONSTRUCTION WORK.
24. CERTAIN PIPE LINES, SEWERS, CULVERTS, DRAINS, CABLES AND OTHER EXISTING SUBSURFACE STRUCTURES IN THE VICINITY OF THE WORK TO BE DONE ARE INDICATED ON THE PLANS ACCORDING TO THE BEST INFORMATION AVAILABLE TO THE SURVEY CREW. DAMAGE TO SUBSURFACE STRUCTURES, OR DELAY TO THE CONTRACTOR DUE TO ENCOUNTERING STRUCTURES, CABLES OR PIPELINE NOT SHOWN OR IN LOCATIONS DIFFERENT FROM THOSE INDICATED ON THE PLANS SHALL NOT CONSTITUTE A CLAIM FOR EXTENSION OF WORK DELAYS.
25. THE REMOVAL AND STORAGE OF ALL SHRUBBERY TO BE REPLACED IS THE RESPONSIBILITY OF THE CONTRACTOR.

GENERAL LAND CONSERVATION NOTES:

1. DURING CONSTRUCTION, ALL STORM SEWER INLETS SHALL BE PROTECTED BY SILT TRAPS MAINTAINED AND MODIFIED AS REQUIRED DURING CONSTRUCTION PROGRESS.
2. AT THE COMPLETION OF THE CONSTRUCTION PROJECT AND PRIOR TO RELEASE OF THE BOND, ALL TEMPORARY SILTATION AND EROSION CONTROLS SHALL BE REMOVED UPON THE APPROVAL OF PROJECT MANAGER AND ALL DENUDED AREAS SHALL BE STABILIZED WITH VEGETATION.
3. EXCAVATION MATERIAL SHALL BE PLACED ON THE UPHILL SIDE OF THE TRENCH.

AERIAL CABLE PLACEMENT:

1. CONVENTIONAL AERIAL CONSTRUCTION TECHNIQUES WILL BE USED IN THE PLACEMENT OF FIBER OPTIC CABLE.
2. CABLE TENSION WILL BE MONITORED AND RECORDED AS THE CABLE IS PULLED THROUGH CABLE ROLLERS.
3. CABLE ROLLERS WILL BE SPACED AT A MAXIMUM INTERVAL OF THIRTY-FIVE FEET (35'). TYPE "B" ROLLERS WILL BE USED. CONTRACTORS ARE REQUIRED TO PROVIDE SUFFICIENT ROLLERS AND PULL-LINE TO PLACE AT LEAST FIVE KILOMETERS (5 KM) OF CABLE IN A SINGLE PULL.
4. AERIAL CABLE GUIDES WILL BE USED.
5. AERIAL STRAND WILL BE USED AND TENSIONED WITH A STRAND DYNAMOMETER.
6. STRAND WILL BE PLACED AS SPECIFIED ON ENGINEERING PLANS.
7. PRELASHING OF CABLE TO STRAND WILL NOT BE ALLOWED. CABLE WILL BE DOUBLE LASHED WITH 45 MIL STAINLESS LASHING WIRE.
8. ONLY NEW HARDWARE, i.e. LASHING WIRE, LASHING WIRE CLAMPS, ETC., WILL BE ACCEPTED.
9. LASHING WIRE CLAMPS SHALL BE PLACED 12" EACH FROM CENTER THROUGH BOLT, AND METAL STRAP WITH 1/4" SPACER SHALL BE PLACED 10" FROM CENTER THROUGH BOLT.
10. OVERLASHING OPERATIONS REQUIRE THE LOWERING OF EXISTING FIBER OPTIC CABLE SLACK COILS AND SPLICE CASES PRIOR TO OVERLASHING THE PROPOSED FIBER OPTIC CABLE (UNLESS OTHERWISE NOTED).
11. ALL UTILITY POLE HARDWARE MUST BE TIGHTENED BEFORE LASHING OPERATIONS.
12. LASHING WIRES SHALL BE TERMINATED IN A MANNER SO AS NOT TO CROSS ONE ANOTHER OR ANY OTHER SHARP OBJECTS, WHICH MIGHT CREATE FUTURE BREAKS IN THE WIRE. ENDS OF LASHING WIRE AND METAL STRAPS SHALL BE TRIMMED, TUCKED, AND KEPT NEAT.
13. FIBER OPTIC WARNING TAGS SHALL BE PLACED AT EVERY WORK POLE, MANHOLE, SLACK COIL, SPLICE CASE AND WHERE SO INDICATED BY PROJECT MANAGER.
14. COMPLY WITH NESC REGULATION PART 92 AND RUS BULLETIN 1751F-815 REQUIRING EIGHT OR MORE BONDS PER MILE.
15. ALL ANCHORS WILL BE IN PLACE PRIOR TO PLACING AND TENSIONING OF STRAND. TEMPORARY GUYING CAN BE USED IF AVAILABLE IF APPROVED BY SHENTEL PROJECT MANAGER, AND MUST BE MADE PERMANENT WITH APPROVED ANCHORS ASAP.

PROJECT INFORMATION

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COUNTY:	GREENVILLE
APPROVER:	

SUBMITTAL INFORMATION

REV	DATE	DESCRIPTION	INIT
0	07/16/2024	PERMIT DRAWING	CENT




SHEET TITLE

GENERAL NOTES

GN-2

DRAWING SHEET
3 OF 20

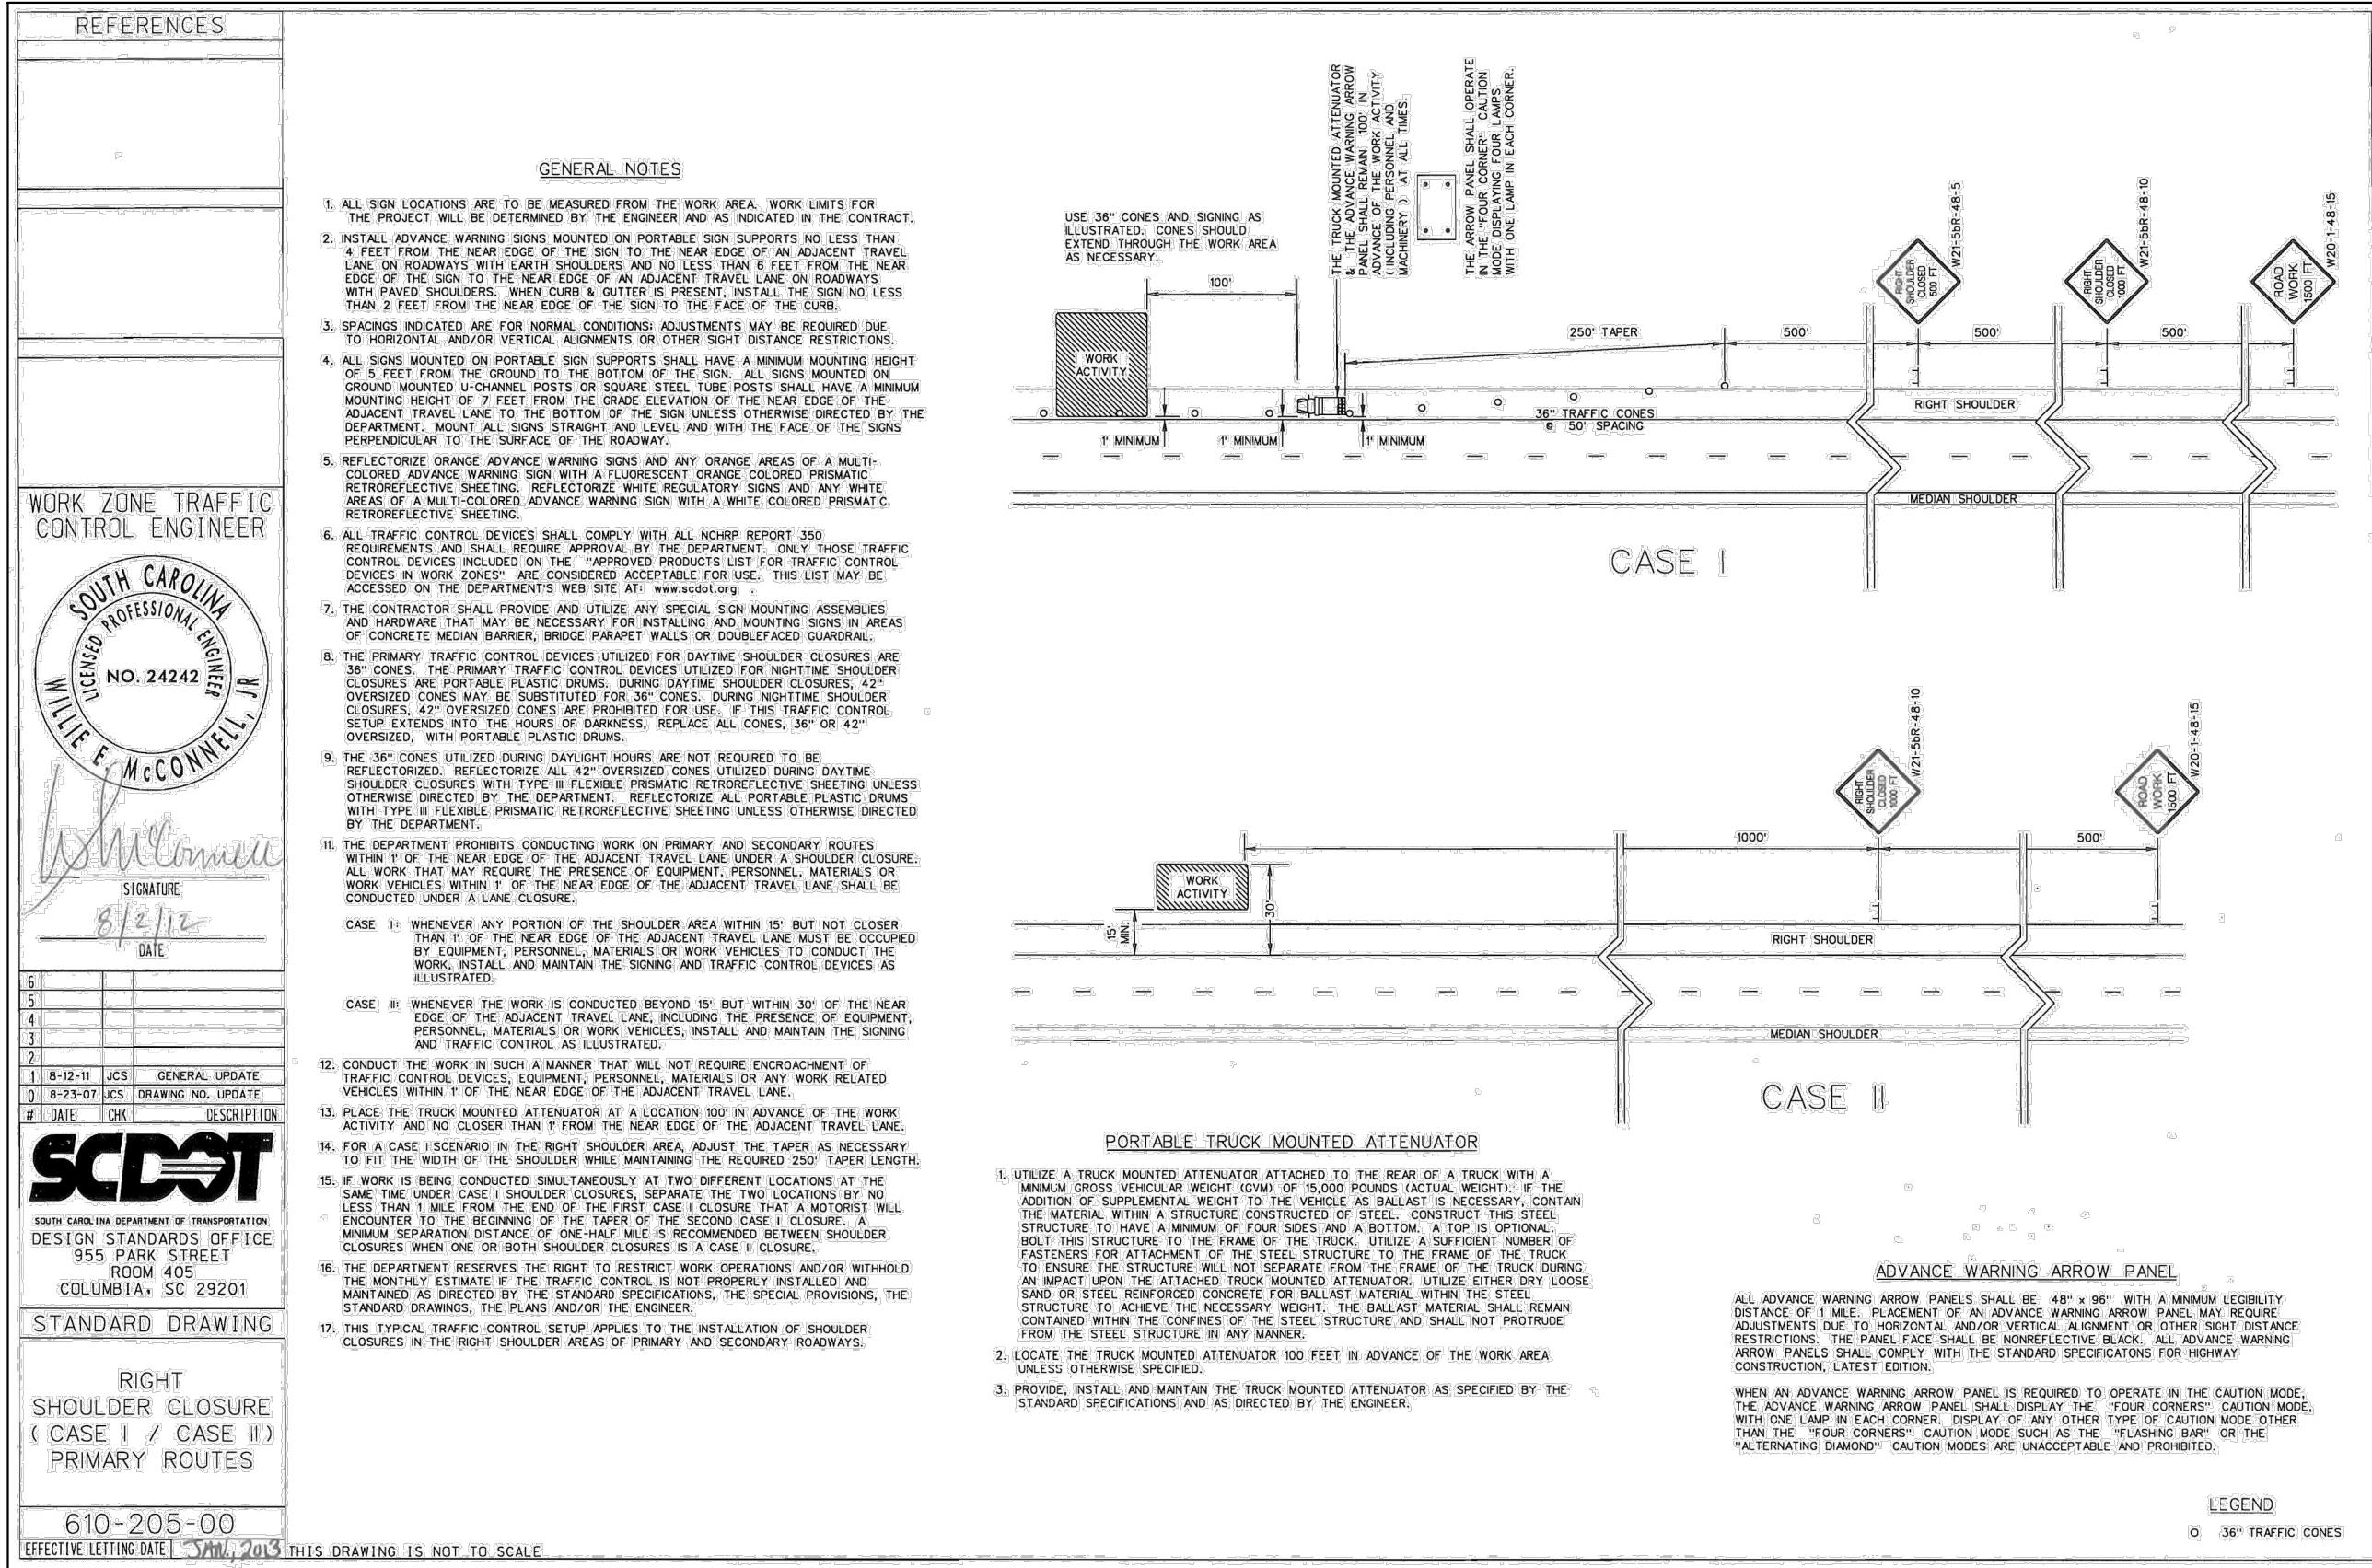

DRAWING 610-005-10 NOTES

1. SEE STANDARD DRAWING NO. 610-005-00 FOR ALL GENERAL NOTES AND REQUIREMENTS.

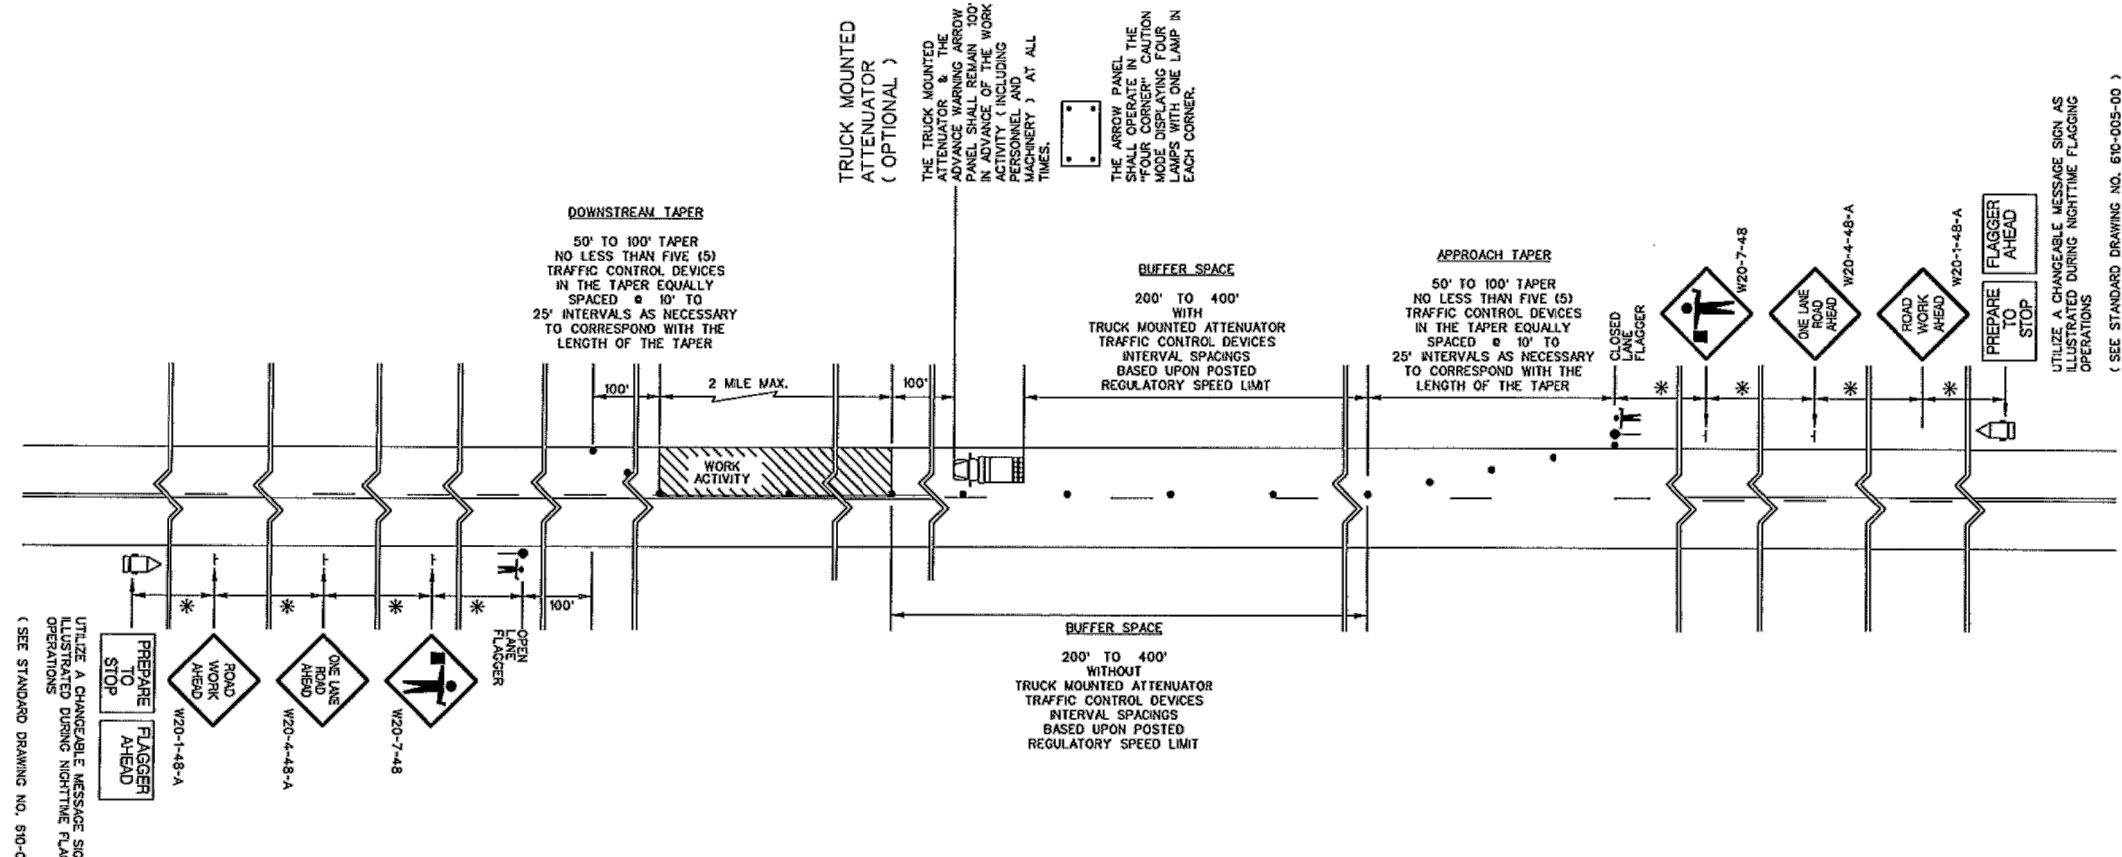


TABLE A

SIGN PLACEMENT INTERVALS	
SPEED LIMIT	*
# ≤ 35 MPH LOW SPEED	200
# 40 - 50 MPH INTERMEDIATE SPEED	350
# 55 MPH HIGH SPEED	500

* REGULATORY POSTED SPEED LIMIT PRIOR TO BEGINNING WORK

TABLE B

TRAFFIC CONTROL DEVICE SPACING INTERVALS WORK ACTIVITY / BUFFER SPACE AREAS	
SPEED LIMIT	SPACING INTERVALS
≤ 35 MPH	25 FEET
40 - 55 MPH	50 FEET

REFERENCES

WORK ZONE TRAFFIC CONTROL ENGINEER



SIGNATURE
7/27/15
DATE

6	
5	
4	
3	
2	
1	
0	1-15-15 JCS NEW DRAWING
#	DATE CHK DESCRIPTION

SCDOT

SOUTH CAROLINA DEPARTMENT OF TRANSPORTATION
DESIGN STANDARDS OFFICE
955 PARK STREET
ROOM 405
COLUMBIA, SC 29201

STANDARD DRAWING

FLAGGING OPERATIONS
TWO-LANE TWO-WAY
ROADWAYS
WITHOUT
INTERSECTIONS

610-005-10
EFFECTIVE LETTING DATE | JAN 2016

THIS DRAWING IS NOT TO SCALE

SHEET TITLE


TRAFFIC CONTROL PLAN

DRAWING SHEET

TC-2

5 OF 20



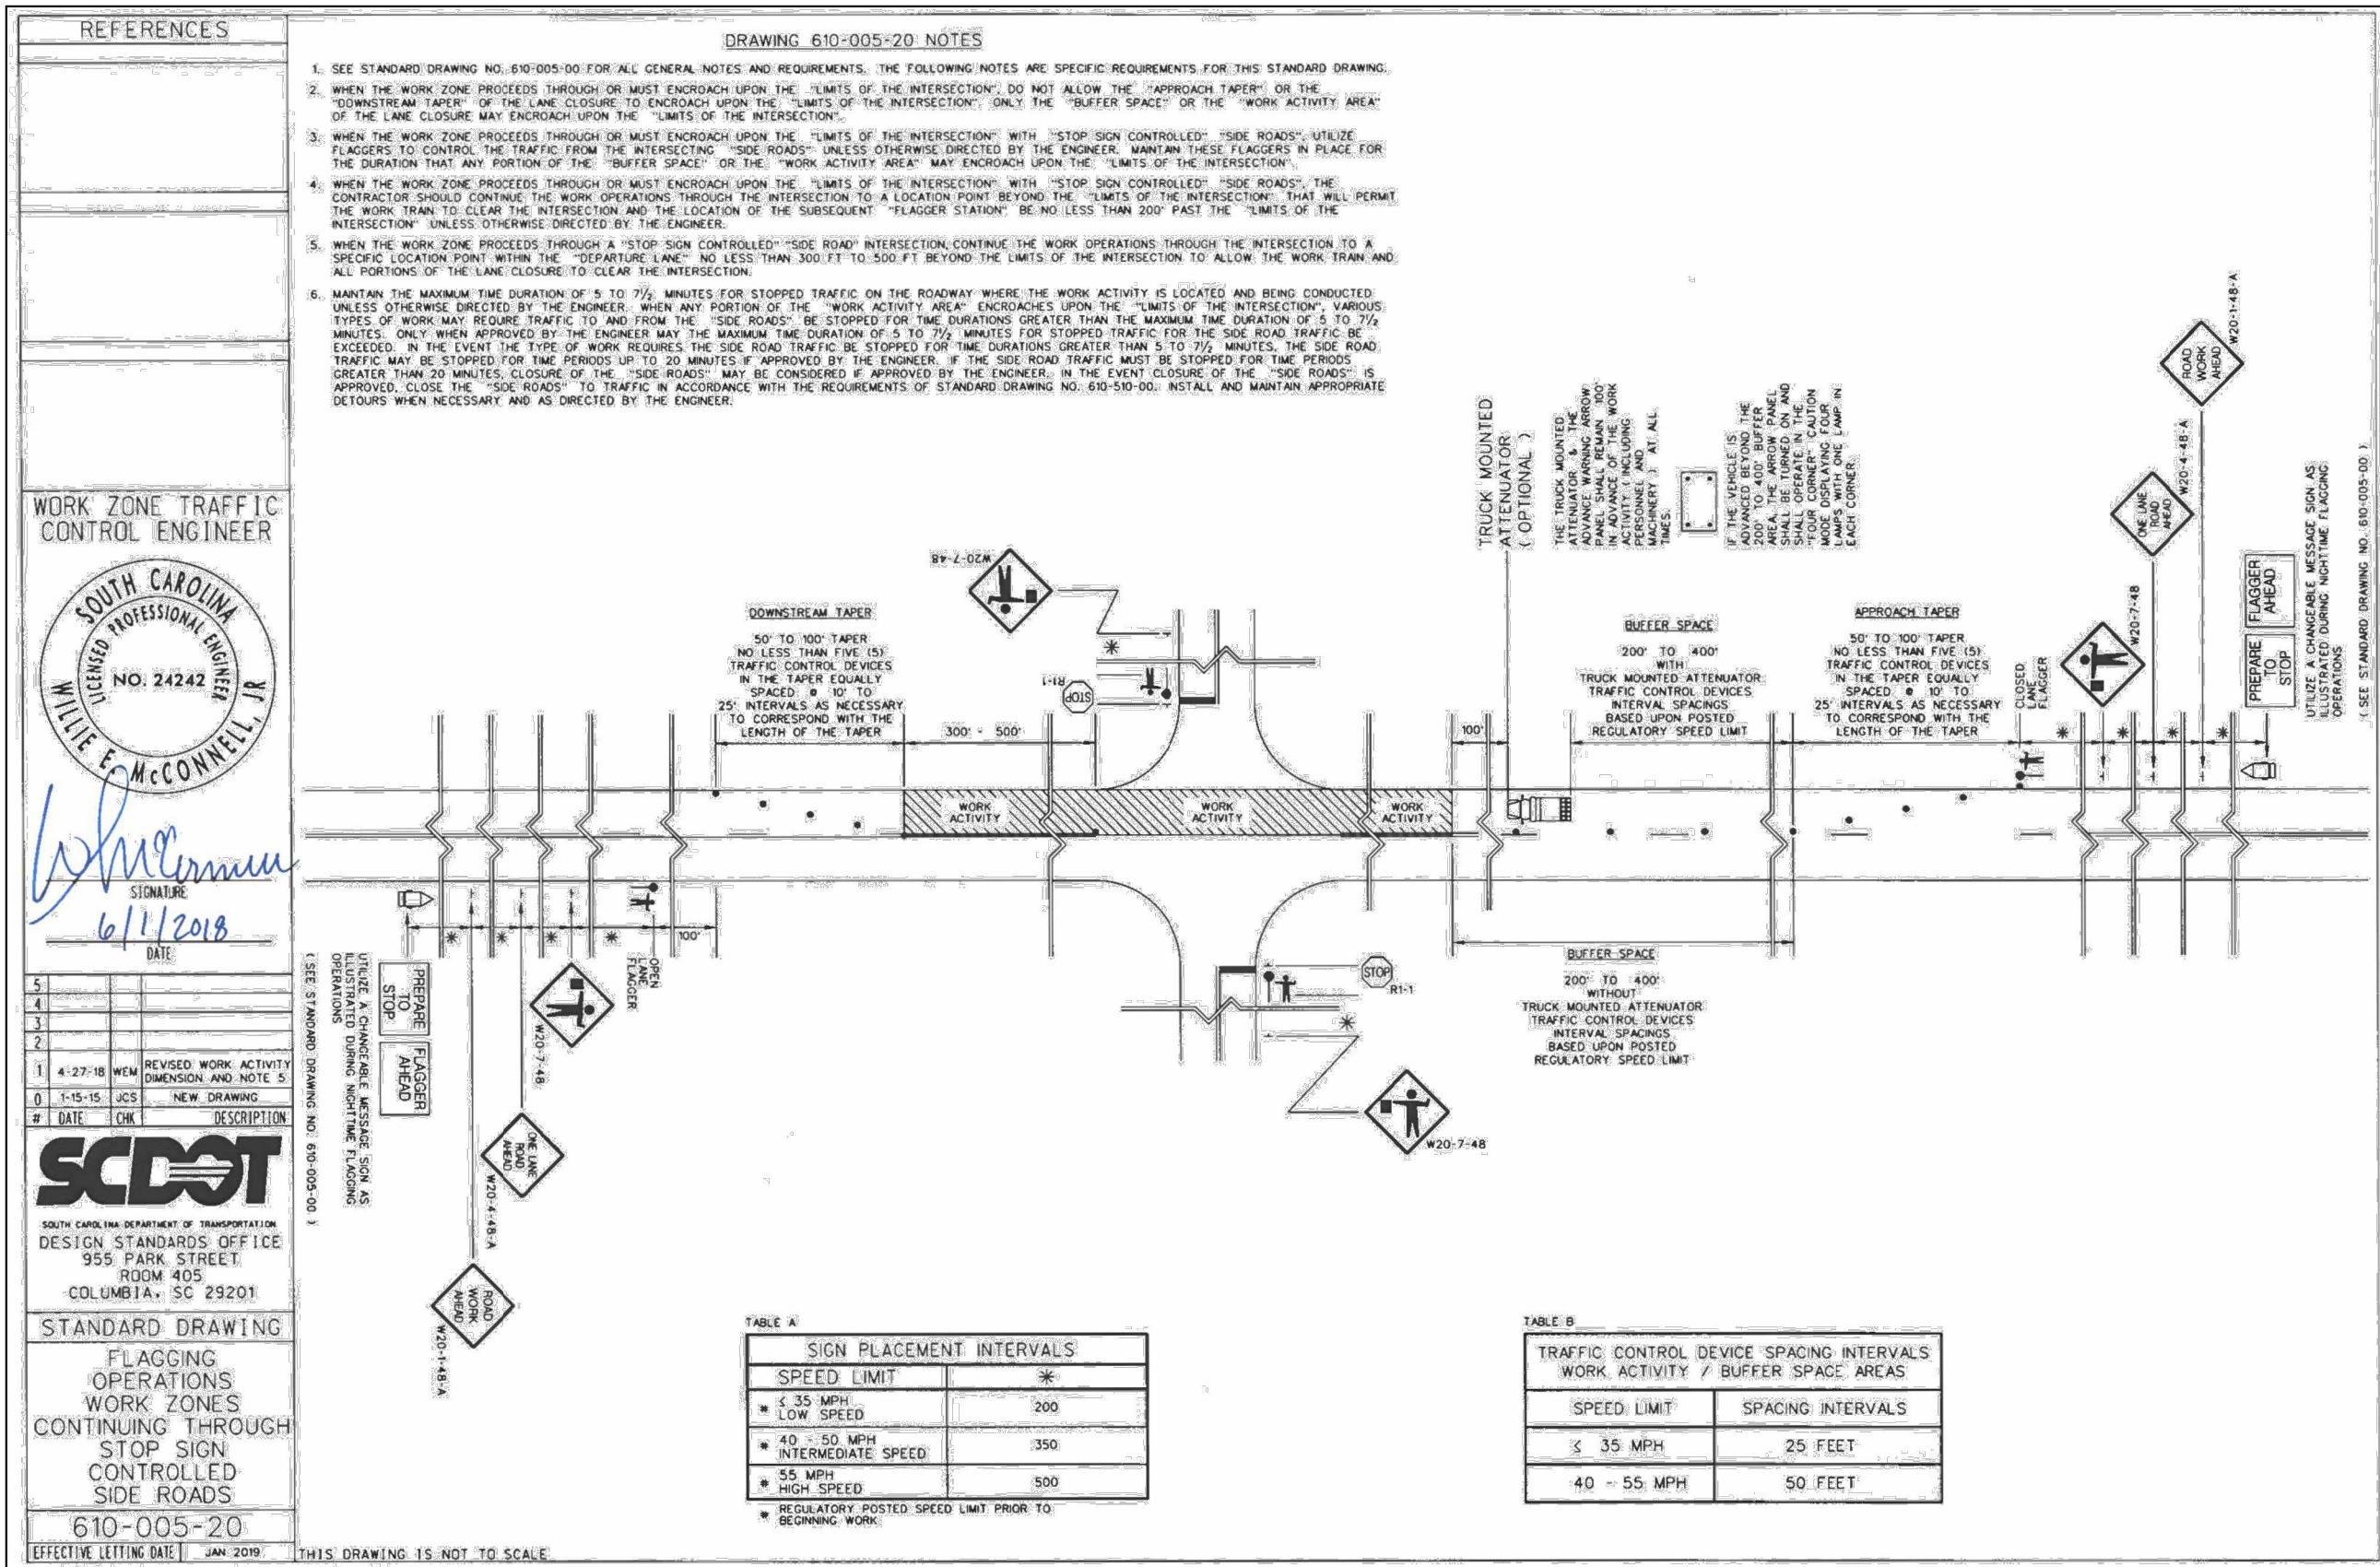

AppendixB: Pipelines

Figure6-Longitudinal Installation of UtilitiesinRoadway Shoulders

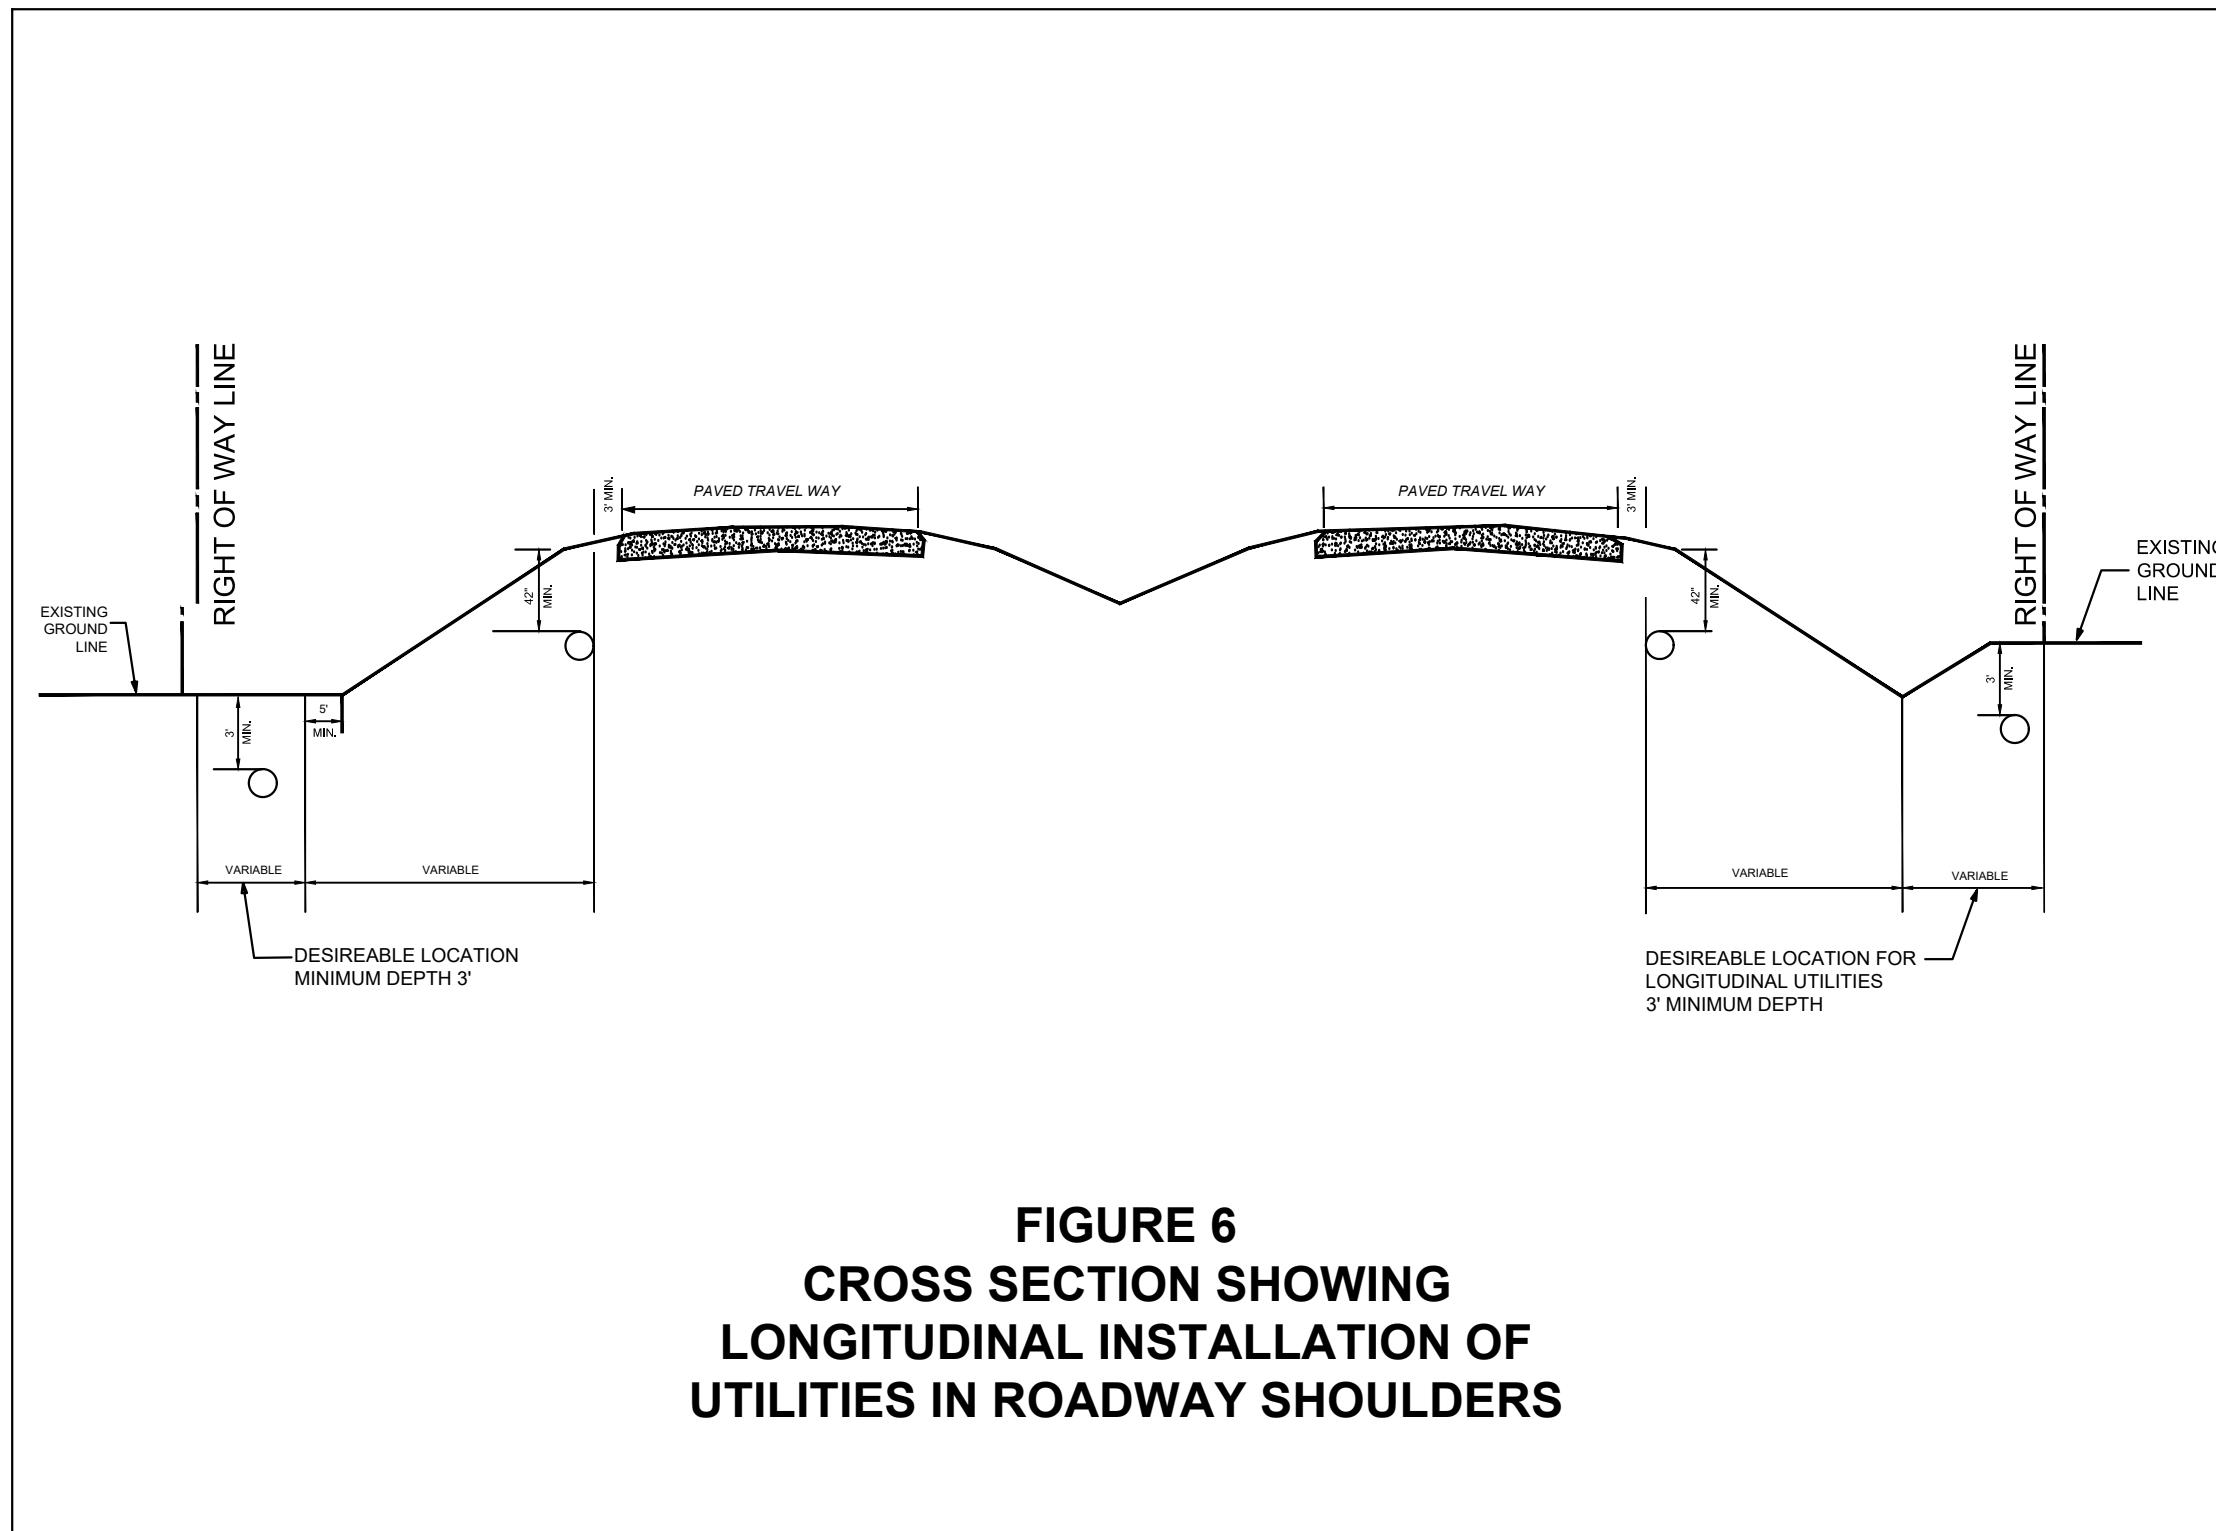


FIGURE 6
CROSS SECTION SHOWING
LONGITUDINAL INSTALLATION OF
UTILITIES IN ROADWAY SHOULDERS

1910

DIRECTIONAL BORE AND PLACE
228' OF (1) 1.25" HDPE CONDUIT
E/W (1) FUTURE DROPS

STA: 2+74-
NEW 11"X18"X18" FLOWER POT

SEE SHEET SP-2

40 MPH

REFER TO TCP DRAWING #610-205-00
REFER TO TCP DRAWING #610-005-20

BORE LINE DEPTH TO BE
A MINIMUM TRAVERSE OF
60" AND LONGITUDINAL
OF 48"

DIRECTIONAL BORE(WET)
ALL BURIED ROUTES

ALL CABLE PLACED IN
1.25" HDPE 2' OFF ROW

NO ASPHALT CUTS
SHOULD BE NEEDED FOR
THIS ROAD CROSSING

R/W 36 If total; 18 If
from center or back
of ditch(whichever
greater); adjust
placement
accordingly

VAC
VL

FEW'S BRIDGE RD (M0062)

1851

DIRECTIONAL BORE AND PLACE
267' OF (1) 1.25" HDPE CONDUIT

APPROXIMATE END OF
SCDOT (S-92) ROW AND
BEGINNING SCDOT (S-113) ROW

SEE RT_29_FDH_01 (E)
SCDOT PERMIT
FOR CONTINUATION

BEGIN PERMIT
STA: 0+00

1846

1840

GROCE MEADOW RD S-92

HOURS OF OPERATION:

WORKING HOURS
MON-FRI: 9AM-4PM

PERMIT NOTES



SCDOT ROW FILE: NOT FOUND
SHEET #

SHEET TITLE
PERMIT DRAWING

SHEET NUMBER
DRAWING SHEET
SP-1
8 OF 20

NOTE: LOCATE ALL
UTILITIES PRIOR TO
CONSTRUCTION.

NOTE: ALL EXISTING UTILITIES
PLACED ON PRINTS FOR
REFERENCE ONLY.
(NOT TO SCALE)



PROJECT INFORMATION

SUBMITTAL INFORMATION

HOURS OF OPERATION:

SITE NAME: RT_29_FDH_01

REV 0 DATE 07/16/2024 DESCRIPTION PERMIT DRAWING INIT CENT

SITE ADDRESS: 1390 GROCE MEADOW RD

COUNTY: GREENVILLE

APPROVER:

0' 25' 50'

SCALE: 1"=50'

R/W 36 If total; 18 If from center or back of ditch(whichever greater); adjust placement accordingly



PROJECT INFORMATION

SITE NAME:	RT_29_FDH_01
SITE ADDRESS:	1390 GROCE MEADOW RD
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APPROVER:	

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HOURS OF OPERATION:

WORKING HOURS
MON-FRI: 9AM-4PM




SHEET TITLE

DETAILED VIEW

SHEET NUMBER	DRAWING SHEET
SP-1A	9 OF 20


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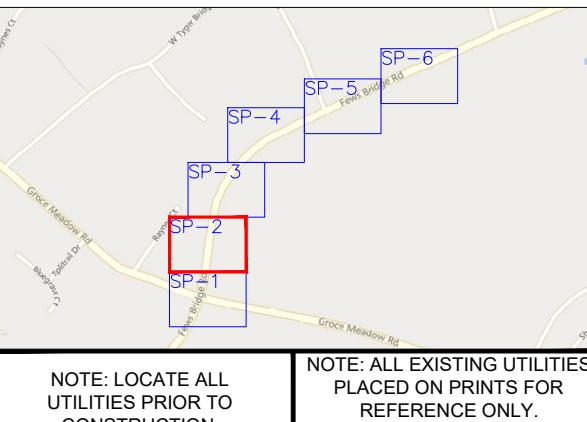
PERMIT NOTES

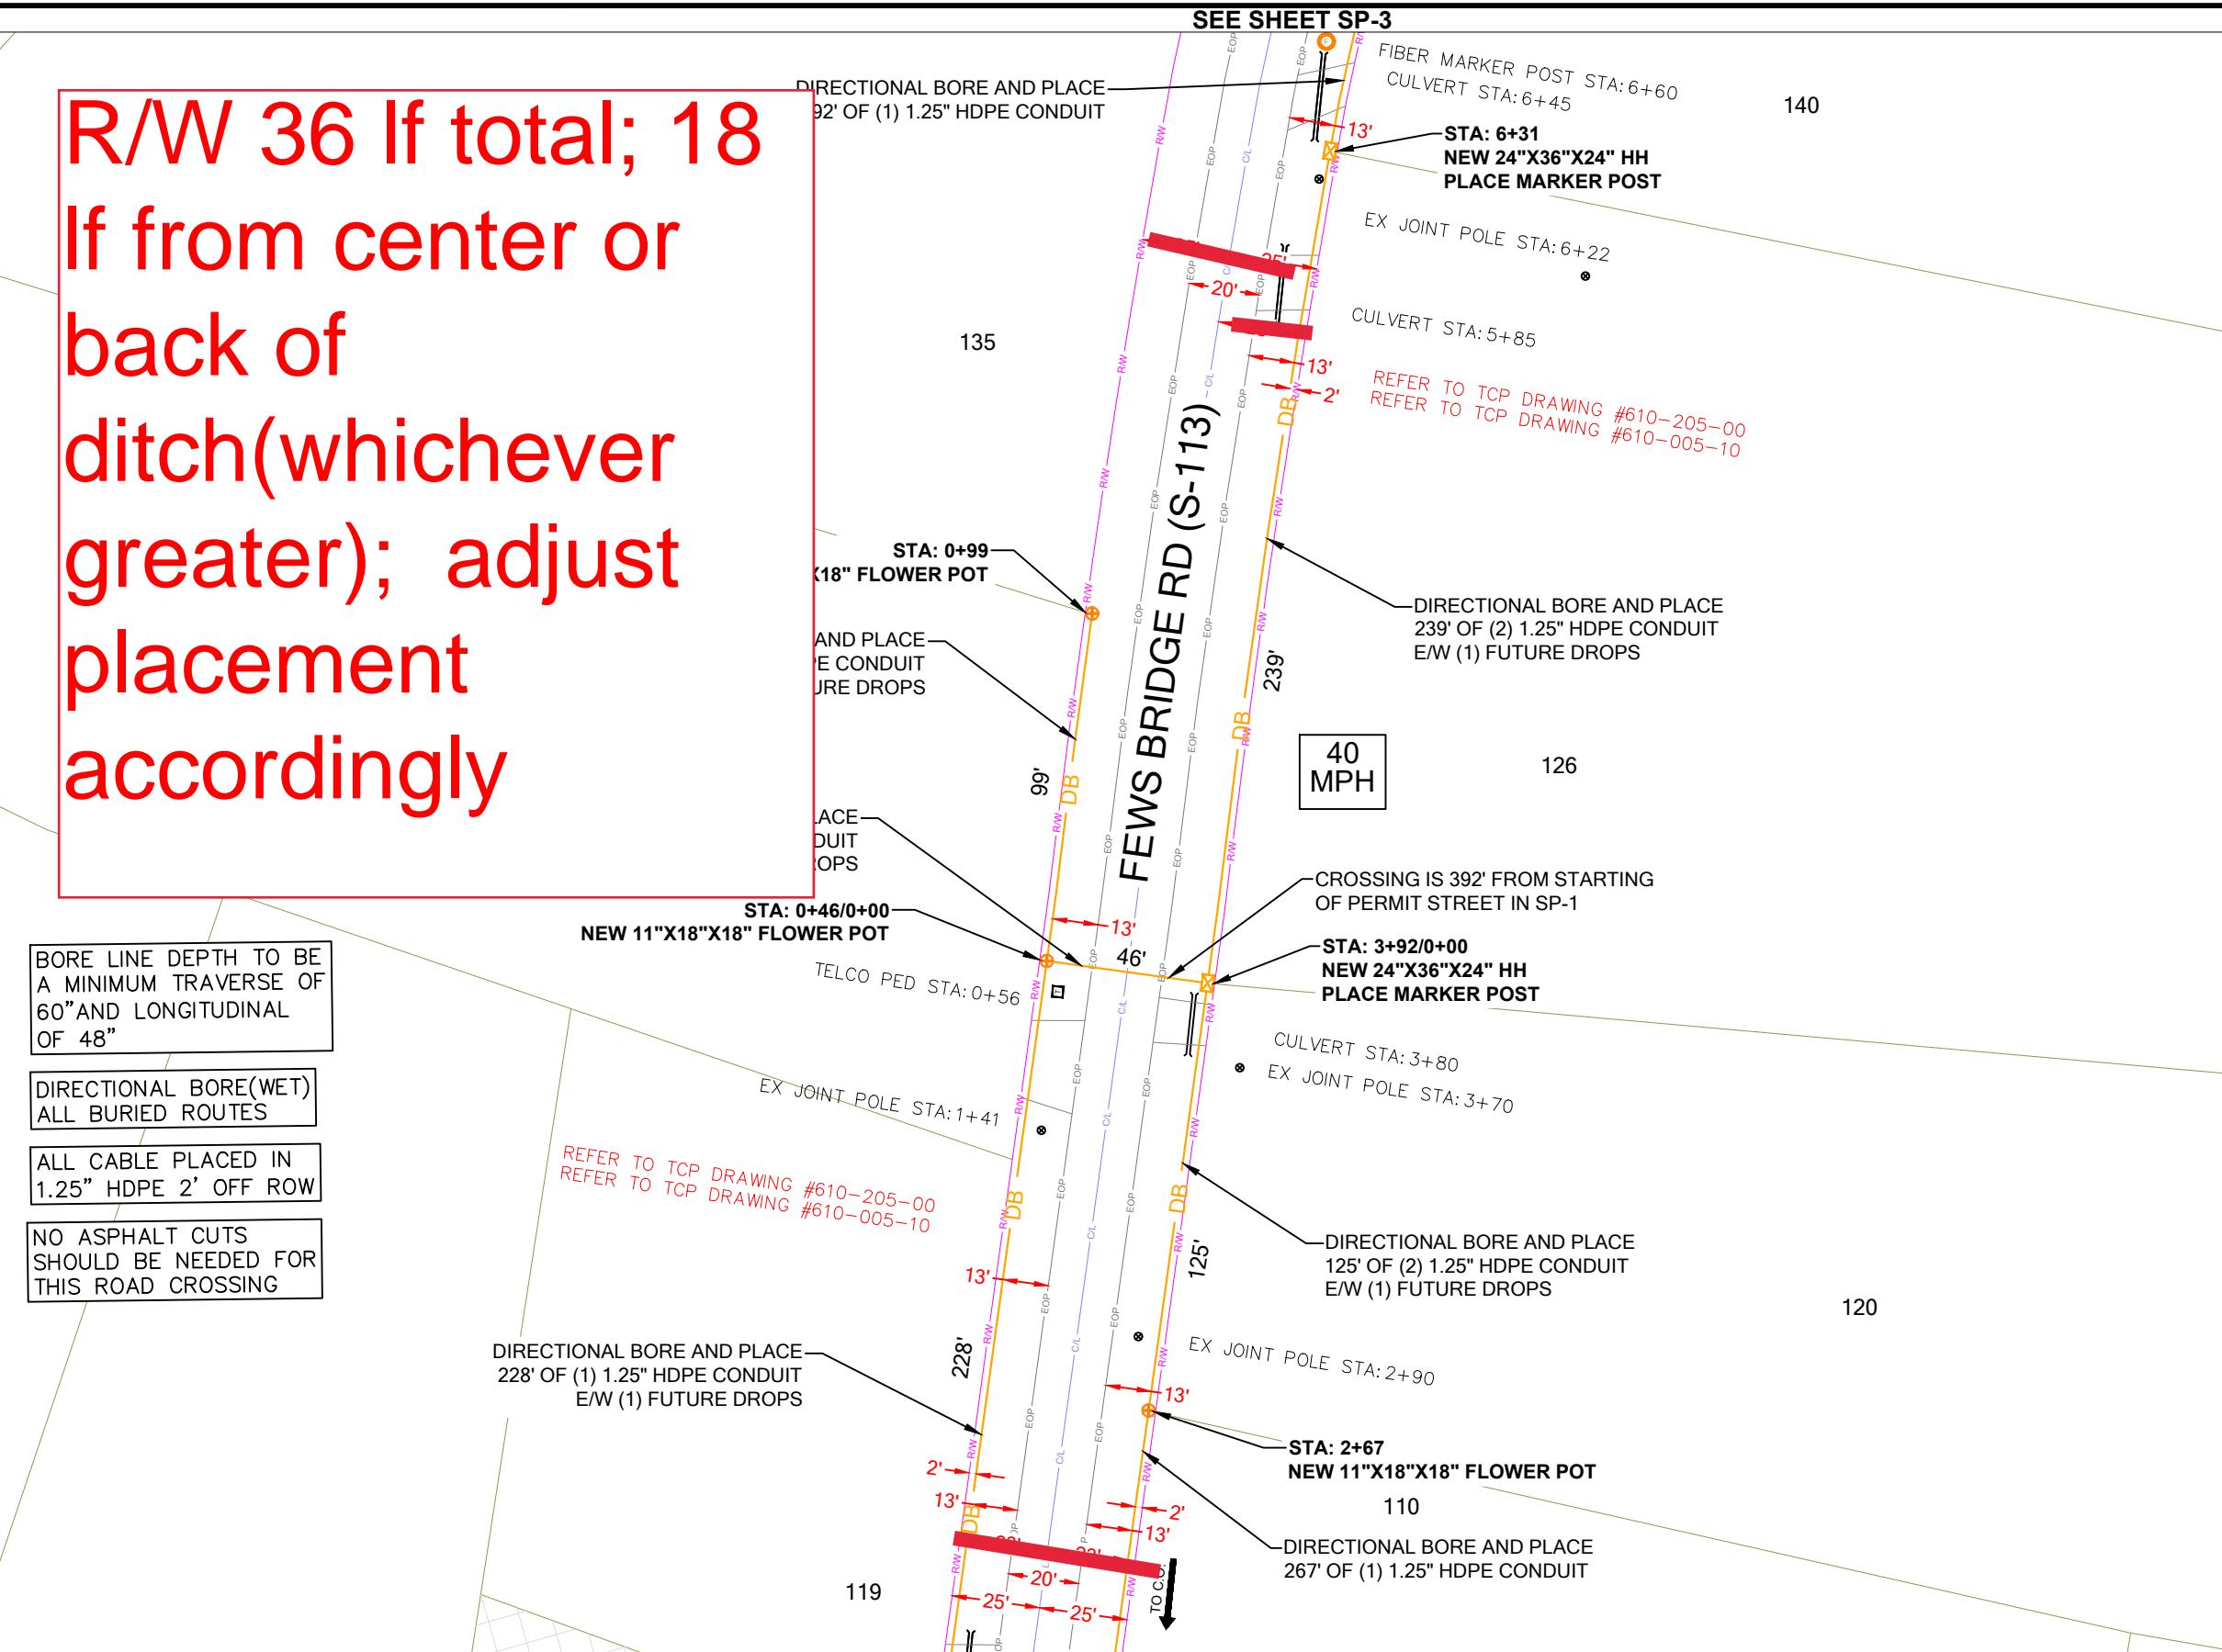

SCDOT ROW FILE: NOT FOUND
SHEET #



SHEET LAYOUT

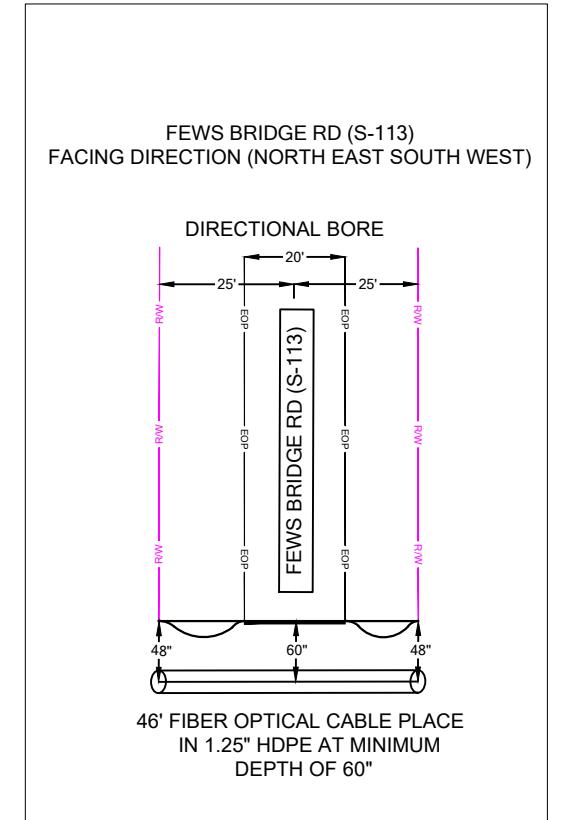

PROJECT INFORMATION			SUBMITTAL INFORMATION			
SITE NAME:	RT_29_FDH_01	REV	DATE	DESCRIPTION	INIT	
SITE ADDRESS:	1390 GROCE MEADOW RD	0	07/16/2024	PERMIT DRAWING	CENT	
COUNTY:	GREENVILLE					
APPROVER:						
	0' 25' 50'					
	SCALE: 1"=50'					

HOURS OF OPERATION:
WORKING HOURS
MON-FRI: 9AM-4PM

SHEET TITLE	PERMIT DRAWING
SHEET NUMBER	DRAWING SHEET
SP-2	10 OF 20

R/W 36 If total; 18 If from center or back of ditch(whichever greater); adjust placement accordingly



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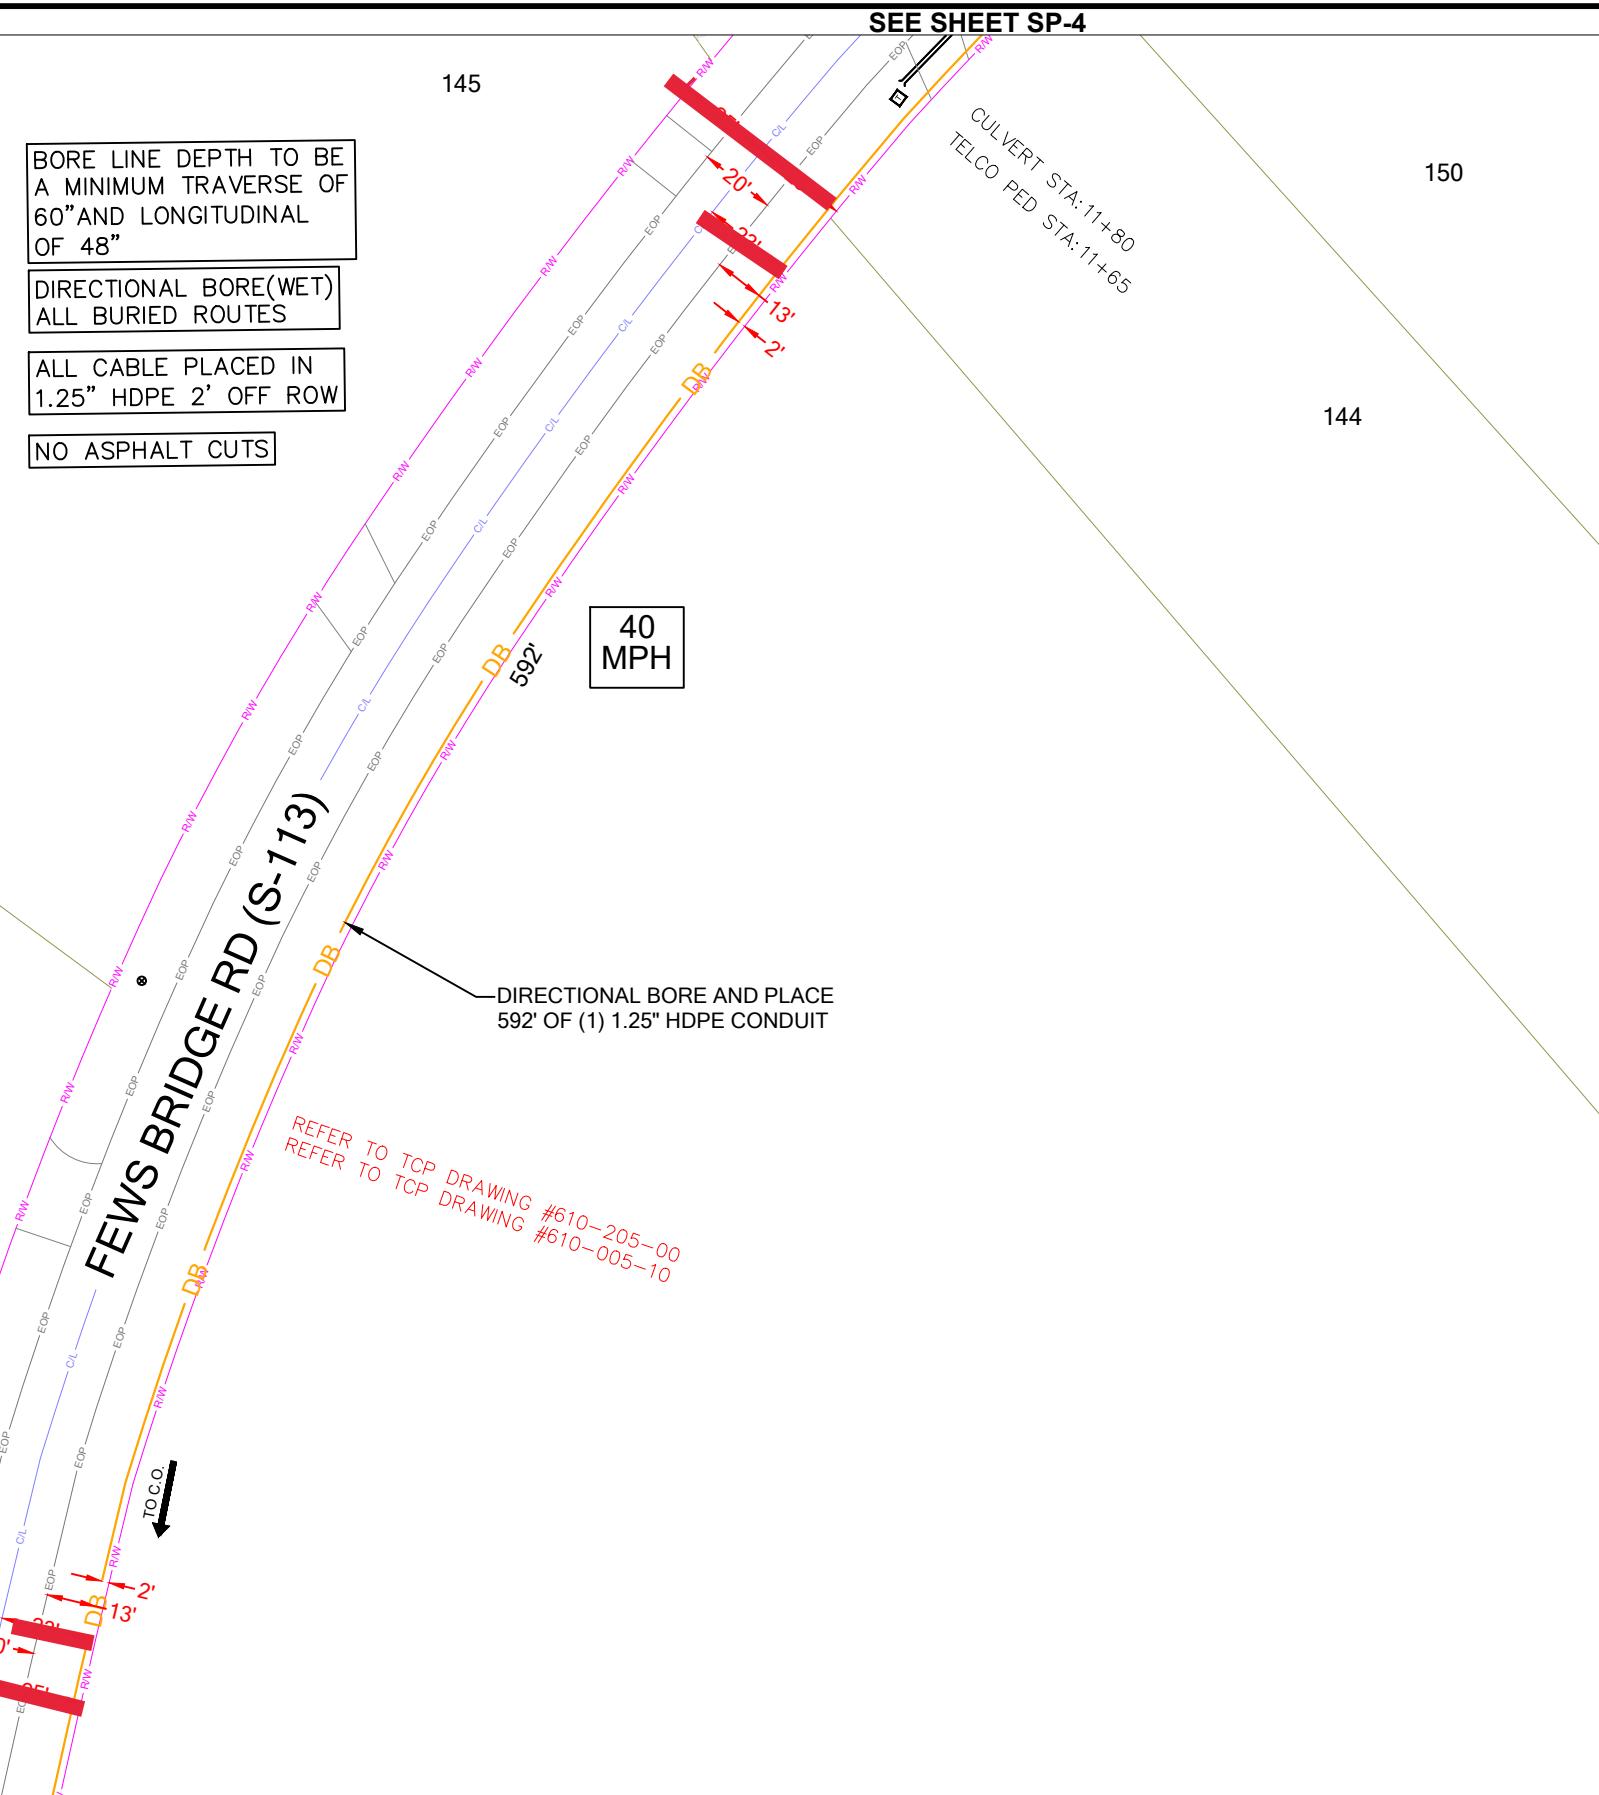
SHEET TITLE

DETAILED VIEW

SHEET NUMBER
SP-2A

DRAWING SHEET
11 OF 20

R/W 36 If total;
18 If from
center or back
of
ditch(whichever
greater); adjust
placement
accordingly



PERMIT NOTES



SCDOT ROW FILE: NOT FOUND
SHEET #

SHEET LAYOUT

NOTE: LOCATE ALL UTILITIES PRIOR TO CONSTRUCTION.

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WORKING HOURS
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SHEET TITLE

DETAILED VIEW


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SP-3A

DRAWING SHEET
13 OF 20


PERMIT NOTES




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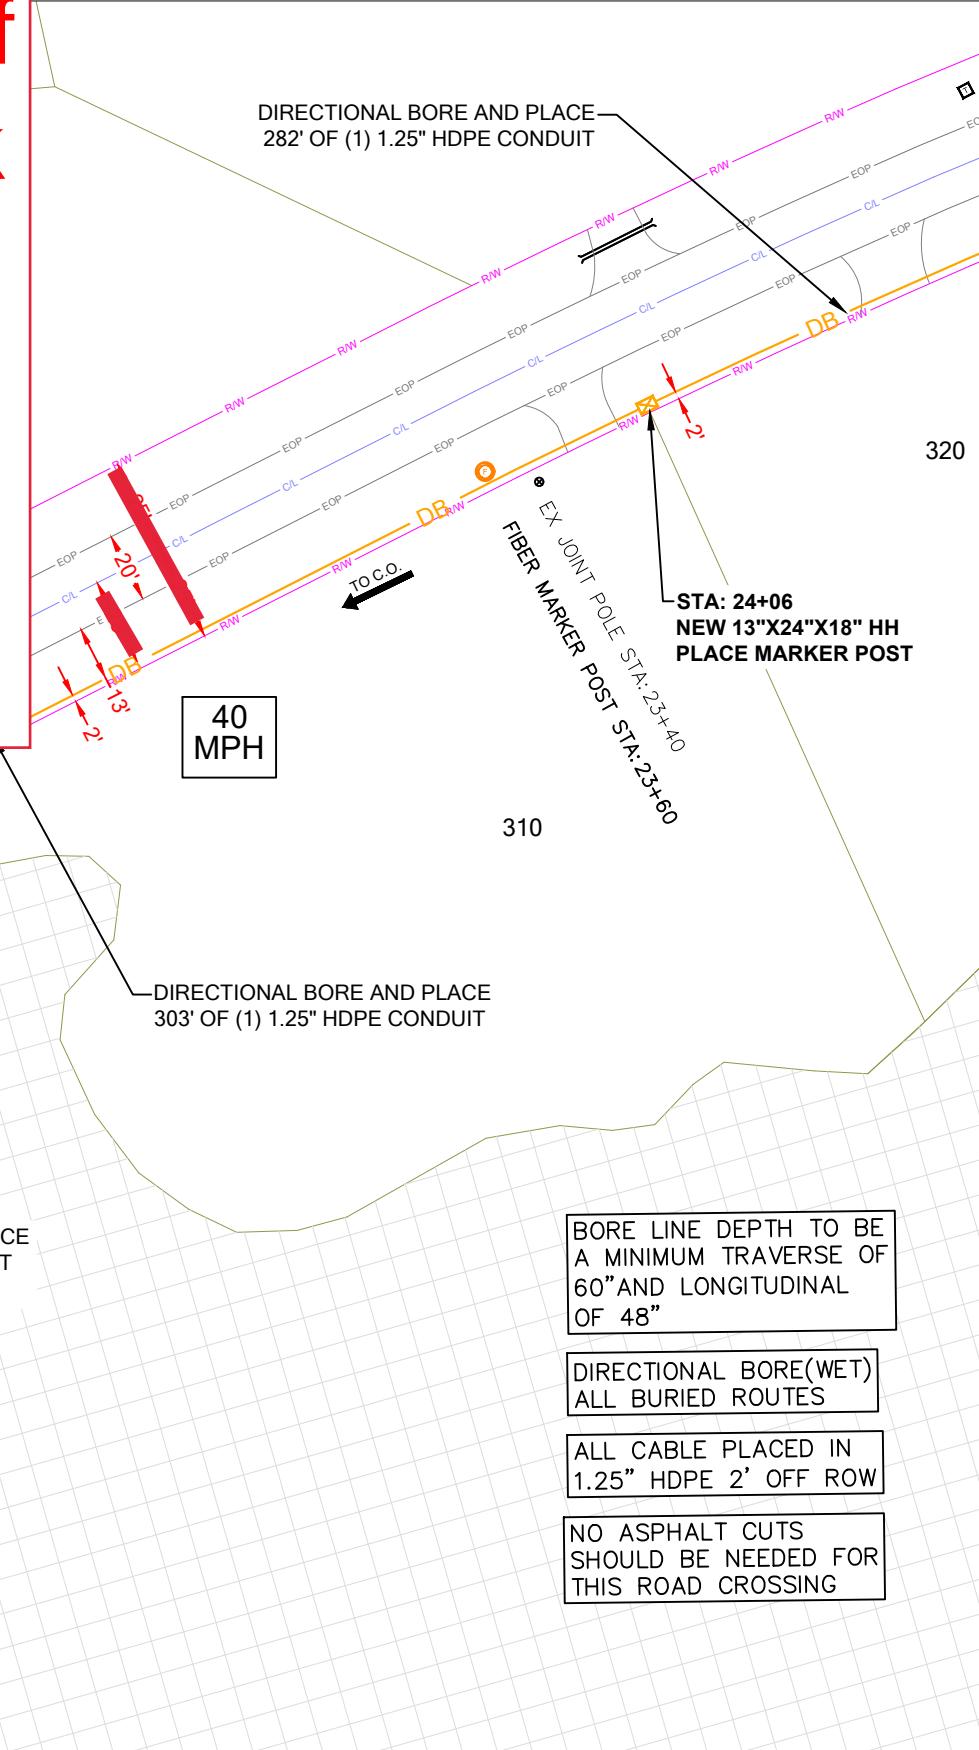
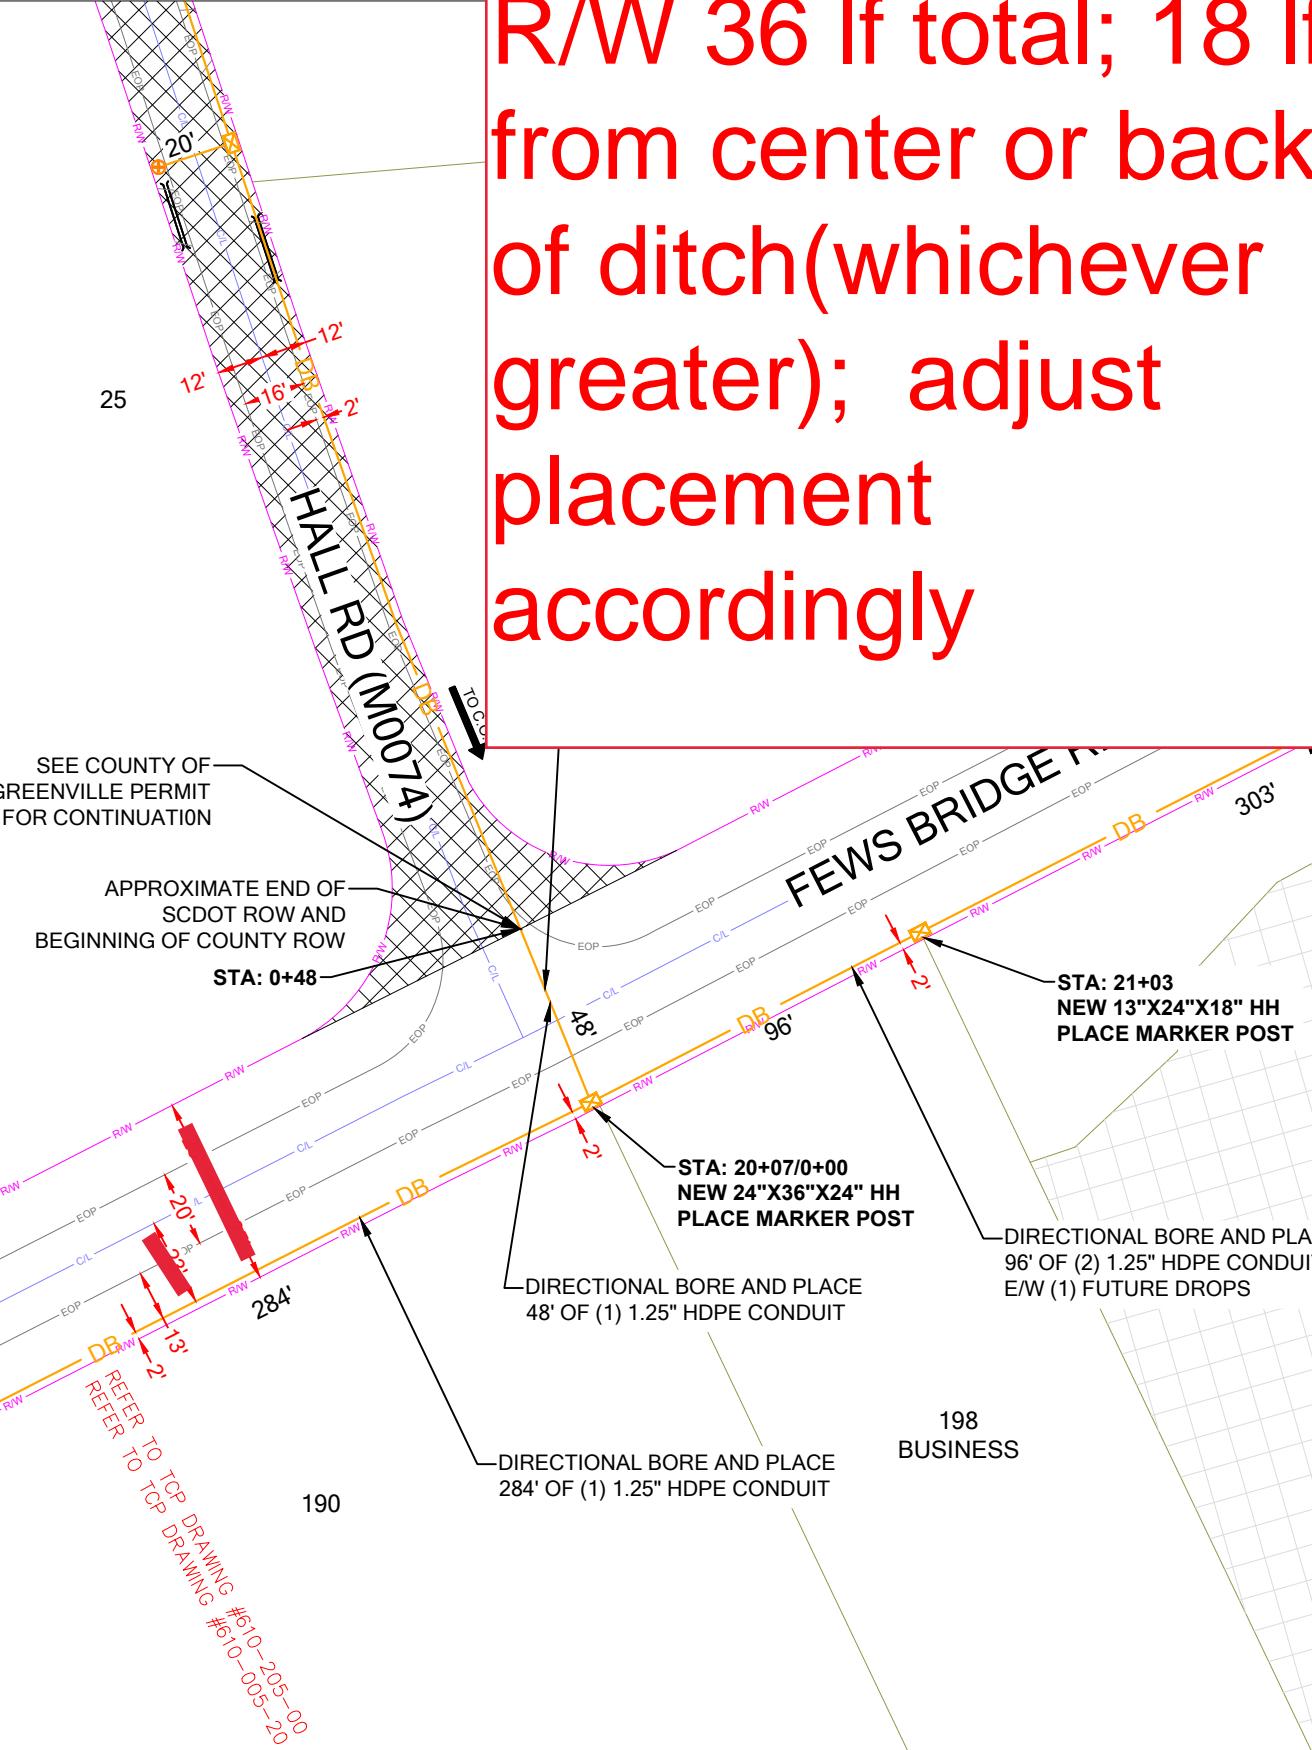
WORKING HOURS
MON-FRI: 9AM-4PM

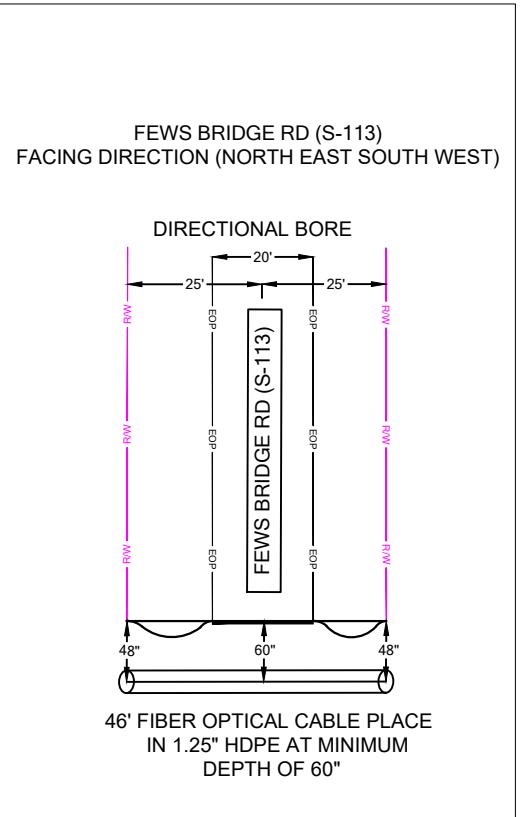

SHEET TITLE

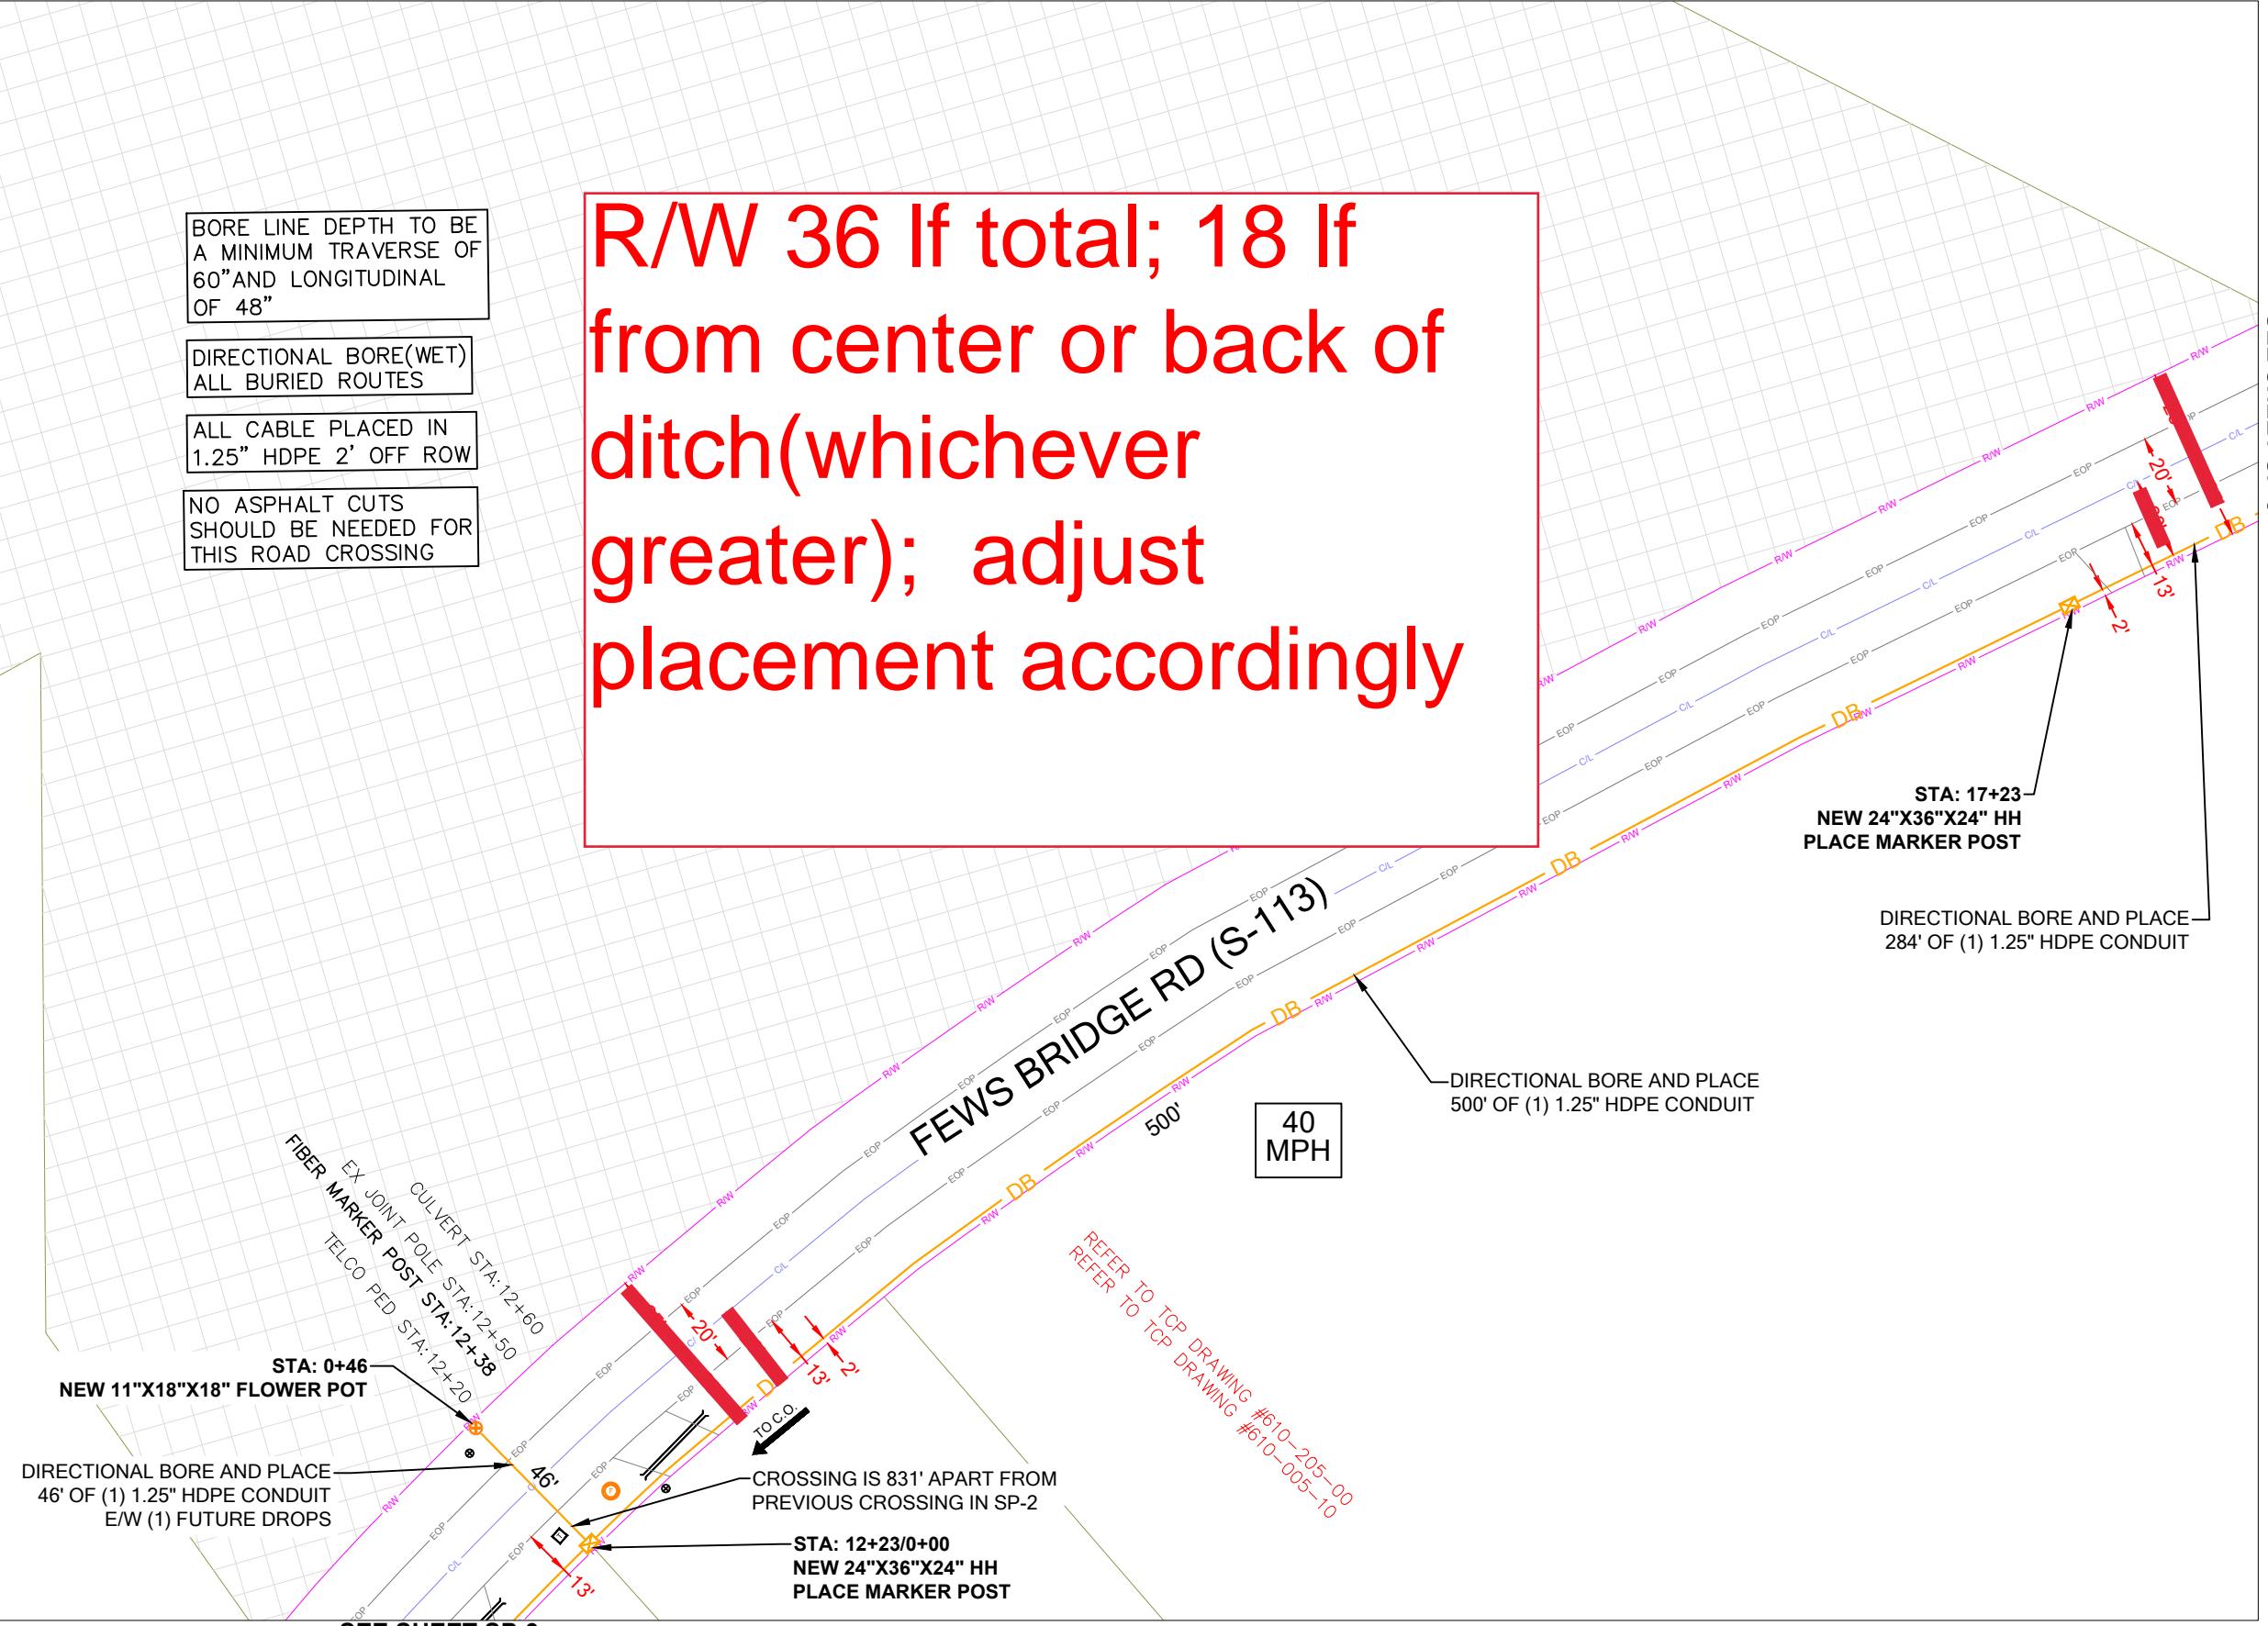DETAILED VIEW


SHEET NUMBER	DRAWING SHEET
SP-4A	15 OF 20

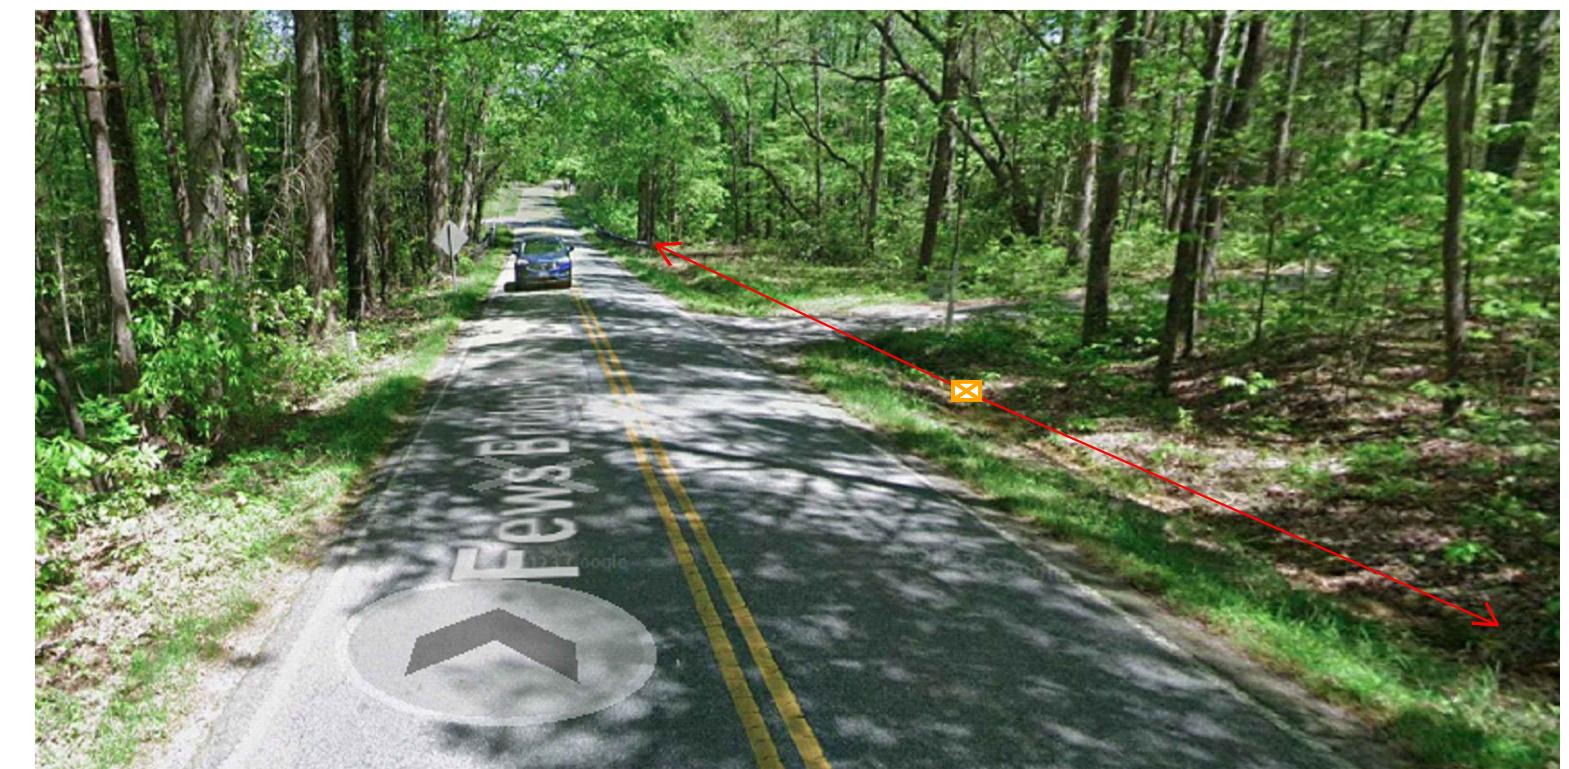

PERMIT NOTES



SCDOT ROW FILE: NOT FOUND
SHEET #

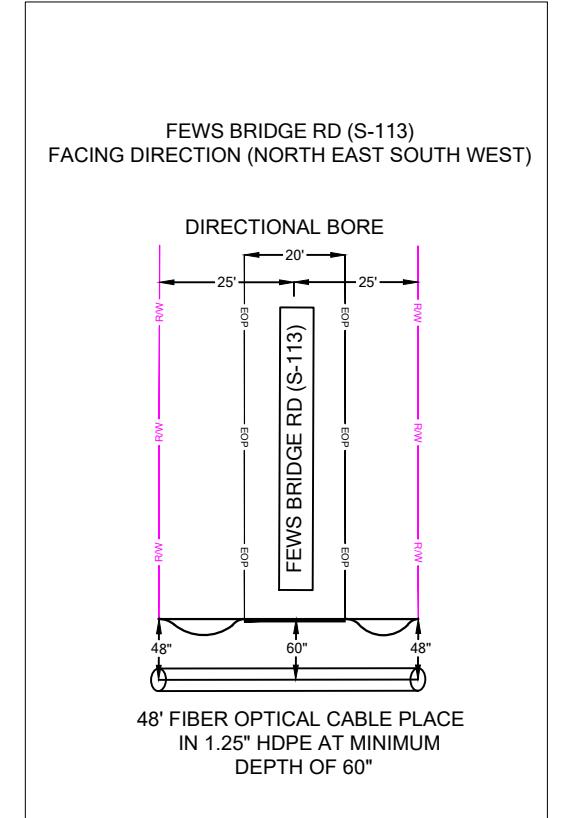

SHEET LAYOUT

NOTE: LOCATE ALL UTILITIES PRIOR TO CONSTRUCTION.

NOTE: ALL EXISTING UTILITIES PLACED ON PRINTS FOR REFERENCE ONLY. (NOT TO SCALE)



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0' 25' 50'
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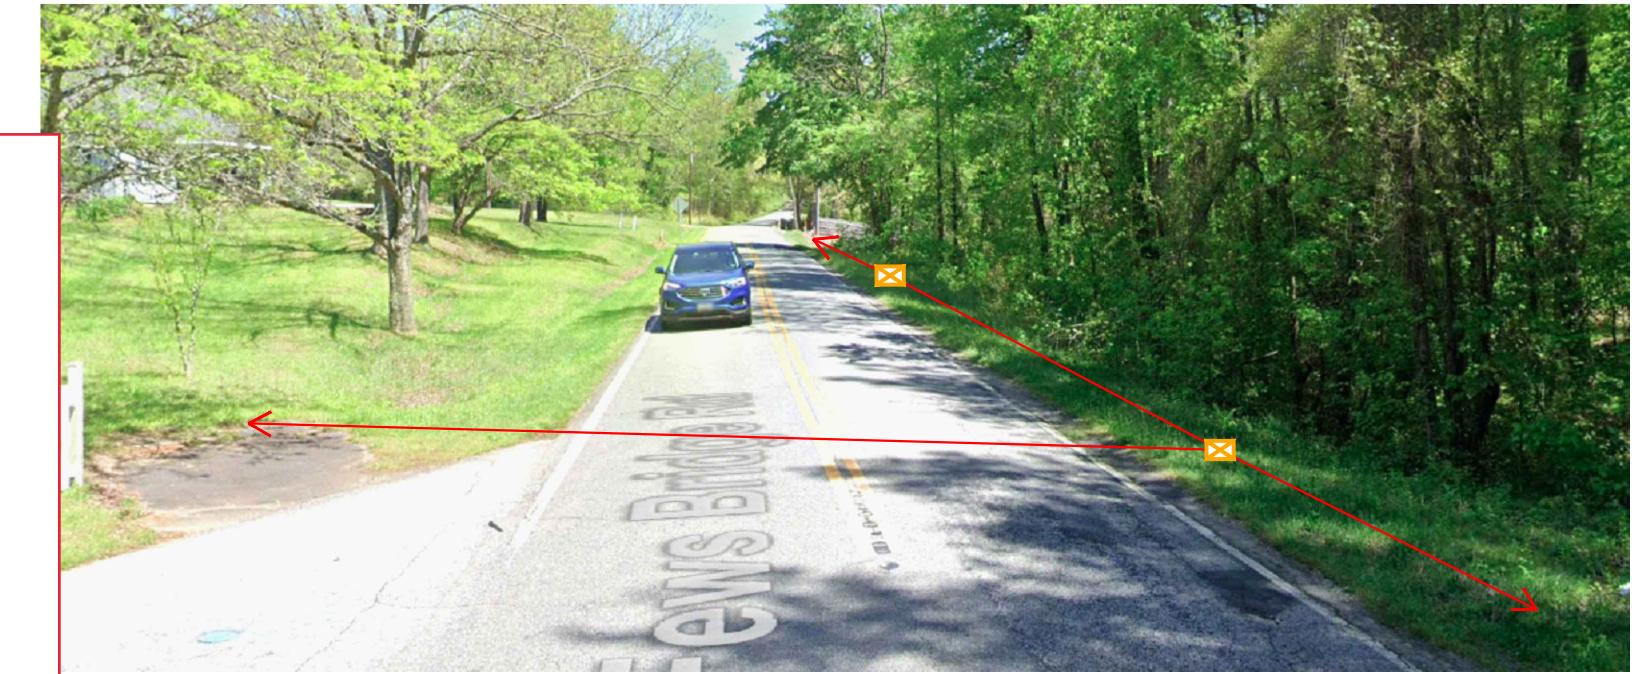
SHEET TITLE
PERMIT DRAWING

SHEET NUMBER
DRAWING SHEET

SP-5

16 OF 20

R/W 36 If total; 18 If from center or back of ditch(whichever greater); adjust placement accordingly



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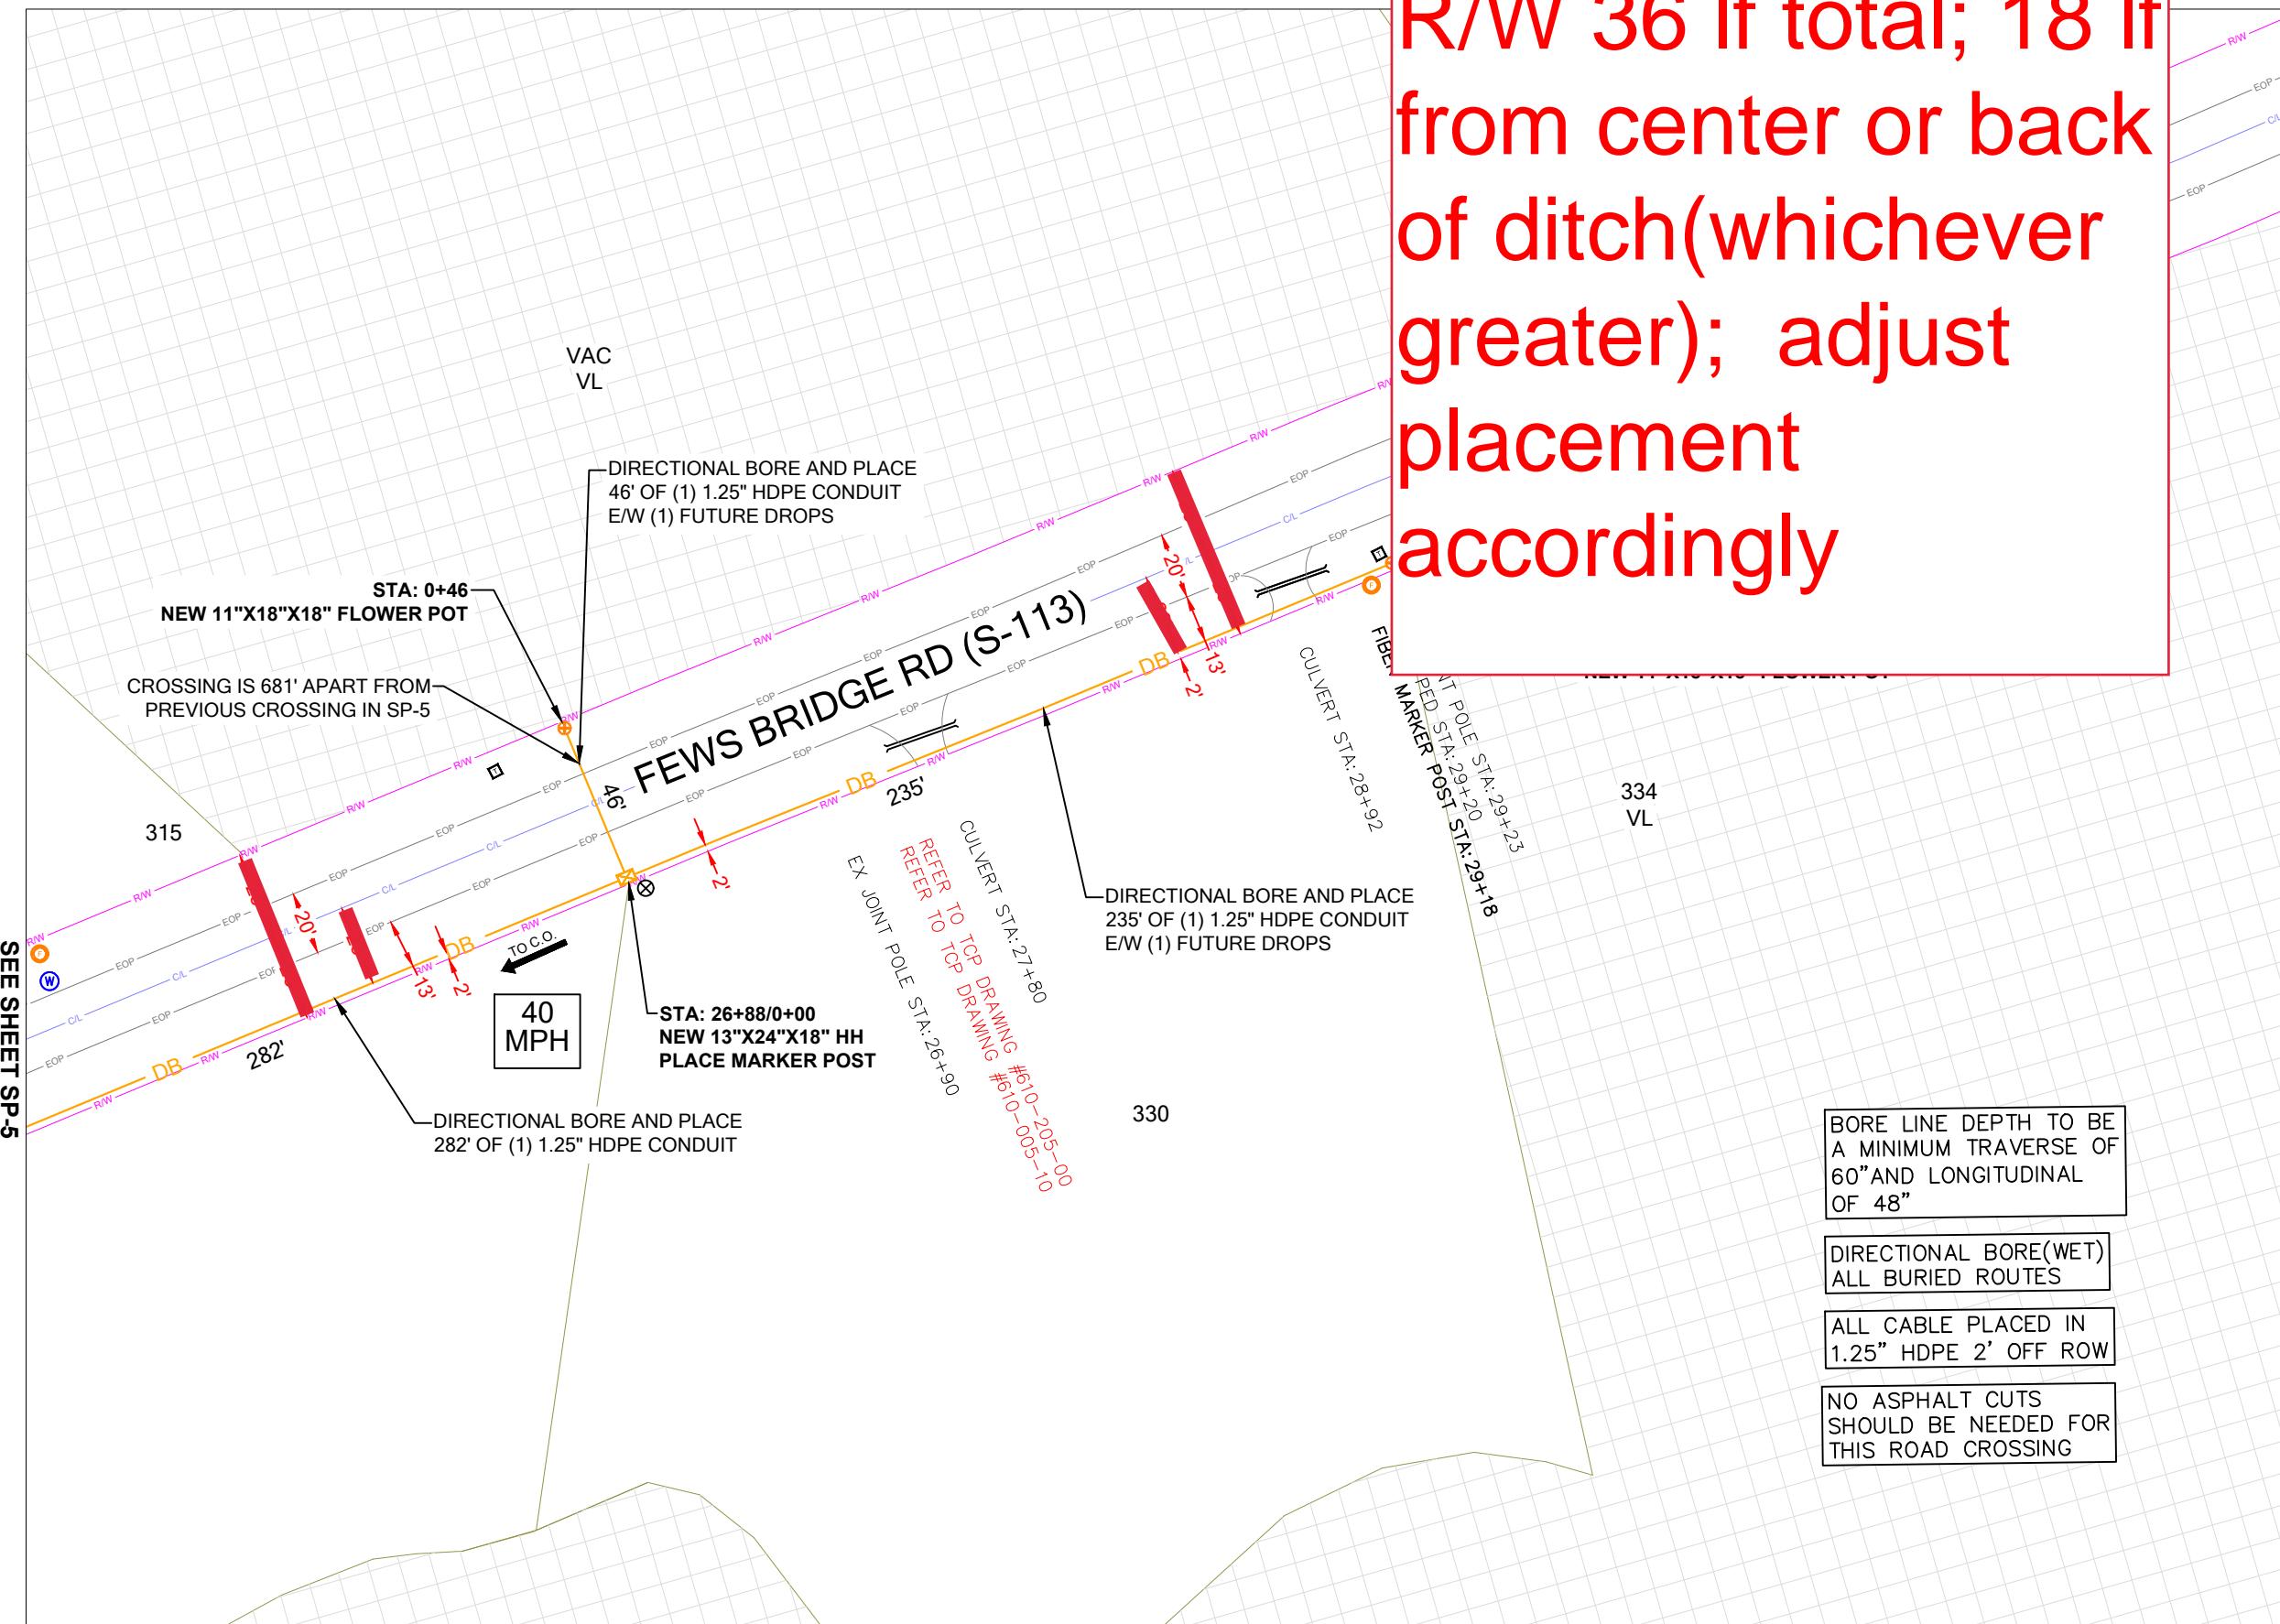
SHEET TITLE

DETAILED VIEW

SHEET NUMBER
SP-5A

DRAWING SHEET
17 OF 20


R/W 36 If total; 18 If from center or back of ditch(whichever greater); adjust placement accordingly




PERMIT NOTES



SCDOT ROW FILE: NOT FOUND
SHEET #

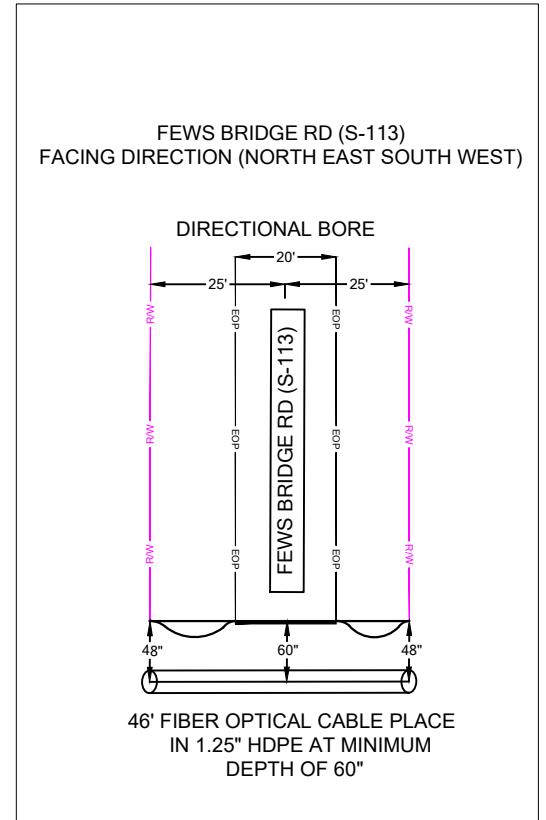

SHEET LAYOUT

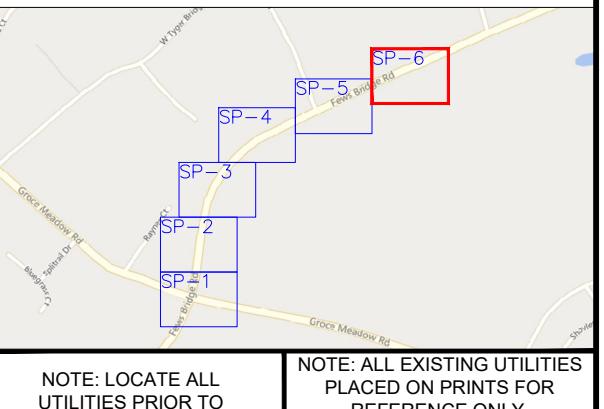

R/W 36 If total; 18 If from center or back of ditch(whichever greater); adjust placement accordingly



PROJECT INFORMATION

SITE NAME:	RT_29_FDH_01
SITE ADDRESS:	1390 GROCE MEADOW RD
COUNTY:	GREENVILLE
APPROVER:	

SUBMITTAL INFORMATION

REV	DATE	DESCRIPTION	INIT
0	07/16/2024	PERMIT DRAWING	CENT

HOURS OF OPERATION:

WORKING HOURS
MON-FRI: 9AM-4PM



SHEET TITLE

DETAILED VIEW

SHEET NUMBER
SP-6A

DRAWING SHEET
19 OF 20

STATE REFERENCE

FEWS BRIDGE RD S-113 - DOCKET NUMBER: NOT FOUND - PAGE NUMBER: NA



PREPARED BY: 110 SAMARITAN DR, SUITE 212
CUMMING, GA 30041. USA

PROJECT INFORMATION

SITE NAME: RT_29_FDH_01

SITE ADDRESS: 1390 GROCE MEADOW RD

COUNTY: GREENVILLE

APPROVER:

SUBMITTAL INFORMATION

REV DATE DESCRIPTION INIT

0 07/16/2024 PERMIT DRAWING CENT

HOURS OF OPERATION:

WORKING HOURS
MON-FRI: 9AM-4PM



SHEET TITLE

SCDOT ROW PLANS

SHEET NUMBER
S-REF

DRAWING SHEET
20 OF 20