INSTALLATION OF NEW ROOF MOUNTED 4.68kW PV SYSTEM

215-15 104TH AVE **QUEENS VILLAGE, NY 11429**













1. THE INSTALLATION CONTRACTOR IS RESPONSIBLE FOR INSTALLING ALL EQUIPMENT AND FOLLOWING ALL DIRECTIONS AND INSTRUCTIONS CONTAINED IN THE DRAWING PACKAGE AND INFORMATION RECEIVED FROM TRINITY

VICINITY MAP

- 2 THE INSTALLATION CONTRACTOR IS RESPONSIBLE FOR INSTALLING ALL EQUIPMENT AND FOLLOWING ALL DIRECTIONS AND INSTRUCTION CONTAINED IN THE COMPLETE MANUAL.
- 3. THE INSTALLATION CONTRACTOR IS RESPONSIBLE FOR READING AND UNDERSTANDING ALL DRAWINGS, COMPONENT AND INVERTER MANUALS PRIOR TO INSTALLATION, THE INSTALLATION CONTRACTOR IS ALSO REQUIRED TO HAVE ALL COMPONENT SWITCHES IN THE OFF POSITION AND FUSES REMOVED PRIOR TO THE INSTALLATION OF ALL FUSES BEARING SYSTEM COMPONENTS.
 4. ONCE THE PHOTOVOLTAIC MODULES ARE
- MOUNTED, THE INSTALLATION CONTRACTOR SHOULD HAVE A MINIMUM OF ONE ELECTRICIAN WHO HAS ATTENDED A SOLAR PHOTOVOLTAIC INSTALLATION COURSE ON SITE
- 5 FOR SAFETY IT IS RECOMMENDED BY THE MANUFACTURE THAT THE INSTALLATION CREW ALWAYS HAVE A MINIMUM OF TWO PERSONS WORKING TOGETHER AND THAT EACH OF THE INSTALLATION CREW MEMBERS BE TRAINED IN FIRST AID AND
- 6. THIS SOLAR PHOTOVOLTAIC SYSTEM IS TO BE INSTALLED FOLLOWING THE CONVENTIONS OF THE NATIONAL ELECTRIC CODE. ANY LOCAL CODE WHICH MAY SUPERSEDE THE NEC SHALL GOVERN.
- 7 ALL SYSTEM COMPONENTS TO BE INSTALLED WITH THIS SYSTEM ARE TO BE "UL" LISTED. ALL EQUIPMENT WILL BE NEMA 3R OUTDOOR RATED UNLESS INDOORS.

GENERAL NOTES CONTINUED

- THE DC VOLTAGE FROM THE PANELS IS ALWAYS PRESENT AT THE DC DISCONNECT ENCLOSURE AND THE DC TERMINALS OF THE INVERTER DURING DAYLIGHT HOURS. ALL PERSONS WORKING ON OR INVOLVED WITH THE PHOTOVOLTAIC SYSTEM ARE WARNED THAT THE SOLAR MODULES ARE **ENERGIZED WHENEVER THEY ARE** EXPOSED TO LIGHT.
- ALL PORTIONS OF THIS SOLAR PHOTOVOLTAIC SYSTEM SHALL BE MARKED CLEARLY IN ACCORDANCE WITH THE NATIONAL ELECTRIC CODE ARTICLE
- PRIOR TO THE INSTALLATION OF THIS PHOTOVOLTAIC SYSTEM, THE INSTALLATION CONTRACTOR SHALL ATTEND A PRE-INSTALLTION MEETING FOR THE REVIEW OF THE INSTALLATION PROCEDURES, SCHEDULES, SAFETY AND COORDINATION
- PRIOR TO THE SYSTEM START UP THE INSTALLATION CONTRACTOR SHALL ASSIST IN PERFORMING ALL INITIAL HARDWARE CHECKS AND DC WIRING CONDUCTIVITY CHECKS.
- FOR THE PROPER MAINTENANCE AND ISOLATION OF THE INVERTS REFER TO THE ISOLATION PROCEDURES IN THE OPERATION MANUAL.
- THE LOCATION OF PROPOSED ELECTRIC AND TELEPHONE UTILITIES ARE SUBJECT TO FINAL APPROVAL OF THE APPROPRIATE UTILITY COMPANIES AND OWNERS
- ALL MATERIALS. WORKMANSHIP AND CONSTRUCTION FOR THE SITE IMPROVEMENTS SHOWN HEREIN SHALL BE IN ACCORDANCE WITH:
 - A) CURRENT PREVAILING MUNICIPAL AND/OR COUNTY SPECIFICATIONS, STANDARDS AND REQUIREMENTS

GENERAL NOTES CONTINUED

- B) CURRENT PREVAILING UTILITY COMPANY SPECIFICATIONS, STANDARDS, AND REQUIREMENTS
- THIS SET OF PLANS HAVE BEEN PREPARED FOR THE PURPOSE OF MUNICIPAL AND AGENCY REVIEW AND APPROVAL THIS SET OF PLANS SHALL NOT BE UTILIZED AS CONSTRUCTION DRAWINGS UNTIL REVISED TO INDICATE "ISSUED FOR CONSTRUCTION".
- ALL INFORMATION SHOWN MUST BE CERTIFIED PRIOR TO USE FOR CONSTRUCTION ACTIVITIES.

- 1. PV INSTALLATION TO COMPLY WITH ARTICLE 690 OF THE NEC
- 2. PV INSTALLATION TO COMPLY WITH NYSERDA REQUIREMENTS. 3 PV INSTALLATION TO COMPLY WITH NEW
- YORK STAT STANDARDIZED

2008 NOTES

1. PV INSTALLATION TO COMPLY WITH NYC ELECTRIC CODE 2011.

PLAN NOTES

1 SCOPE OF WORK IS SOLEY FOR THE INSTALLATION OF THE SOLAR ELECTRONIC GENERATING SYSTEM, ALL OTHER WORK IS NOT TO BE RELIED UPON AS BEING APPROVED AND/OR PERMITTED BY THE DOB

SPECIAL INSPECTIONS: STABILITY

FIRE STOP PROGRESS INSPECTIONS: **ENERGY CODE** COMPLIANCE FINAL INSPECTION VISUAL AIR SEALING

SCALE: 1"=500'

1. CONSTRUCTION WORK WILL BE CONFINED TO THE ROOF / OUTSIDE & WILL NOT CREATE DUST, DIRT OR OTHER INCONVENIENCES TO NEIGHBORING

TENANT SAFETY NOTES

- PROPERTIES OR APARTMENT UNITS WITHIN THE BUILDING. 2. CONSTRUCTION WORK WILL NOT BLOCK HALLWAYS OR MEANS OF EGRESS FOR NEIGHBORING PROPERTIES OR TENANTS OF
- THE BUILDING. 3. CONSTRUCTION WORK WILL NOT INVOLVE INTERRUPTION OF HEATING, WATER OR ELECTRIC SERVICES TO NEIGHBORING PROPERTIES OR TENANTS OF THE BUILDING
- 4. CONSTRUCTION WORK WILL BE CONFINED TO NORMAL WORKING HOURS, 8AM - 5PM MONDAY THRU FRIDAY EXCEPT LEGAL HOLIDAYS.

A. TENANT EGRESS TO AND FROM THE BUILDING.

B. FIRE SAFETY, OR CREATE A FIRE HAZARD.

STAT AND FEDERAL DUMPING GROUNDS

THRU FRIDAY EXCEPT LEGAL HOLIDAYS

C. STRUCTURAL SAFETY OF THE BUILDING.

ABBREVIATIONS

SHFD

315'-0"

SHED

ALTERNATING CURRENT ALUMINUM AMP. FRAME ABOVE FINISHED FLOOR AFF AFG ABOVE FINISHED GRADE AMERICAN WIRE GAUGE CONDUIT (GENERIC TERM OF RACEWAY PROVIDE AS

SPECIFIED) COMBINER BOX CKT CIRCUIT CURRENT TRANSFORMER

CU COPPER DC DIRECT CURRENT DISCONNECT SWITCH DWG DRAWING

ELECTRICAL SYSTEM INSTALLER EC EMT ELECTRICAL METALLIC TUBING FS FU FUSIBLE SWITCH

FUSE GROUND GFI

GROUND FAULT INTERRUPTER FREQUENCY (CYCLES PER

ABBREVIATIONS CONTINUED

EXISTING 2 STOR

DWELLING

EXISTING

2 STORY

DWFLLING

100'-0"

TOP OF

PEAK: 26'-

EXISTING

2 STORY

DWFLLING

OPEN FRONT

DRIVEWAY

-RON-

JUNCTION BOX THOUSAND CIRCULAR MILS KILO-VOLT AMPERE kVA KILO-WATT kWH KILO-WATT HOUR MAIN CIRCUIT BREAKER MDP MAIN DISTRIBUTION PANEL

MLO MAIN LUG ONLY MOUNTED MTG MOUNTING NEUTRAL

NATIONAL ELECTRICAL CODE NIC NOT IN CONTRACT NO# NUMBER NOT TO SCALE

OVER CURRENT PROTECTION OCP POLE PB PULL BOX PHASE

SOLID NEUTRAL

POWER QTY QUANTITY RIGID GAI VANIZED STEEL

ABBREVIATIONS CONTINUED JSWBD SWITCHBOARD TYPICAL U.O.I. UNLESS OTHERWISE INDICATED WEATHERPROOF XFMR TRANSFORMER +72 MOUNT 72 INCHES TO BOTTOM OF ABOVE FINISHED FLOOR OR GRADE

T-001.00 - COVER SHEET S- 001.00 - ROOF LAYOUT S- 002 00 - FLEVATION DRAWING S- 003.00 - ELEVATION DRAWING S- 004.00 - ELEVATION DRAWING E-001.00 - ELECTRICAL 3-LINE

POLY-VINYL CHLORIDE CONDUIT DEPARTMENT OF BUILDING NOTES

NYC FC504 EXEMPT - PITCH GREATER THAN 5/12 BC 109.3.3 RCNY 5000-01 (H) (IA6) IIA6) 28-116.2.4.2 AND DIRECTIVE 14 OF 1975 RCNY 101-10

PLAN NOTES

1. SCOPE OF WORK IS SOLEY FOR THE INSTALLATION OF THE SOLAR ELECTRONIC GENERATING SYSTEM, ALL OTHER WORK IS NOT TO BE RELIED UPON AS BEING

APPROVED AND/OR PERMITTED BY THE DOE

ENERGY ANALYSIS FOR RESIDENTIAL PROPERTY TAX ABATEMENT

TENANT PROTECTION PLAN

APPLICATION TYPE: ALT-2 SCOPE OF WORK: INSTALL NEW ROOF MOUNTED SOLAR ELECTRICITY (PV-PHOTOVOLTAIC) GENERATING SYSTEM CERTIFY THAT ANY BUILDING CONSTRUCTION ASSOCIATED WITH THE INSTALLATION OF THE SOLAR ELECTRIC GENERATING SYSTEM. OTHER THAN THAT SHOWN IN THIS ENERGY ANALYSIS. HAS BEEN INCLUDED IN AN ASSOCIATED PLAN APPROVAL AND WORK PERMIT APPLICATION ROPOSED VALUE: RESCRIPTIVE VALUE DESCRIPTION: AND CITATION: DOCUMENTATION

SPECIAL PRECAUTION SHALL BE TAKEN BY THE CONTRACTOR SO THAT EQUIPMENT ON THIS

D. ACCUMULATION OF DUST. THE CONTRACTOR SHALL LEAVE THE WORK SITE BROOM CLEAN EACH

IN ACCORDANCE WITH ALL APPLICABLE REGULATIONS OF O.S.H.A SECTION 1901.1, INCLUDING

DAY. IN THE EVENT THAT ASBESTOS IS FOUND ON THE JOBSITE, ITS REMOVAL SHALL TAKE PLACE


THERE SHALL BE NO CREATION OF NOISE OUTSIDE THE NORMAL HOURS OF 8AM TO 5PM MONDAY

APPLICATION AND ITS INSTALLATION WILL NOT AFFECT THE FALLOWING

01 00 SOLAR PANEL PENETRATIONS AS WEATHERSTRIPPING OR OTHER NCHORAGE DETAILS AND PECTION OF OPENINGS AND PENETRATIONS IN THE RESCRIBED IN SECTION ECC. JII DING STRUCTURE BY MATERIALS IN ACCORDANCE BUILDING ENVELOPE TO VERIEY THAT THEY ARE PROPERLY TING TO STRUCTURAL 402.4.2 AND ECC TABLE 402.4.2 SEALED, IN ACCORDANCE WITH ECC TABLE 402.4.2, SECTION MEMBERS, AND SHOWN ON ECC 402.4 AND APPROVED DRAWINGS

NYC DEPT OF BUILDING APPROVAL STAMP

Engineer / License Holder:

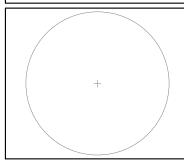

	Issued / Revisions		
P1	ISSUED TO TOWNSHIP FOR PERMIT	7/15/2015	
NO.	DESCRIPTION	DATE	

Project Title:

SHAKUR, TARAMANIE

TRINITY ACCT #: 2015-53431

Project Address:

215-15 104TH AVE **QUEENS VILLAGE, NY 11429**

Drawing Title:

COVER SHEET

Drawing Informatio	n	
DRAWING DATE:	7/15/2015	
DRAWN BY:	KJN	
REVISED BY:		

System Information:		
TOTAL SYSTEM SIZE:	4.68kW	
TOTAL MODULE COUNT:	18	
MODULES USED:	TRINA 260	
MODULE SPEC #:	TSM-260 PD05.08	
UTILITY COMPANY:	CON EDISON	
UTILITY ACCT #:	266440090800027	
UTILITY METER #:	2781231	
DEAL TYPE:	SUNNOVA	


DWG No:

T-001.00 **PAGE: 1 OF 5**




2211 Allenwood Road Wall, New Jersey 07719 www.Trinity-Solar.com

THE WORK PROPOSED IN THIS APPLICATION IS EXEMPT FROM THE ENERGY CONSERVATION CONSTRUCTION CODE OF NEW YORK CITY * TO THE BEST OF MY KNOWLEDGE, BELIEF AND PROFESSIONAL JUDGEMENT, THESE PLANS AND SPECIFICATIONS ARE IN COMPLIANCE WITH THE ENERGY CONSERVATION CONSTRUCTION CODE OF NEW YORK CITY 2010.

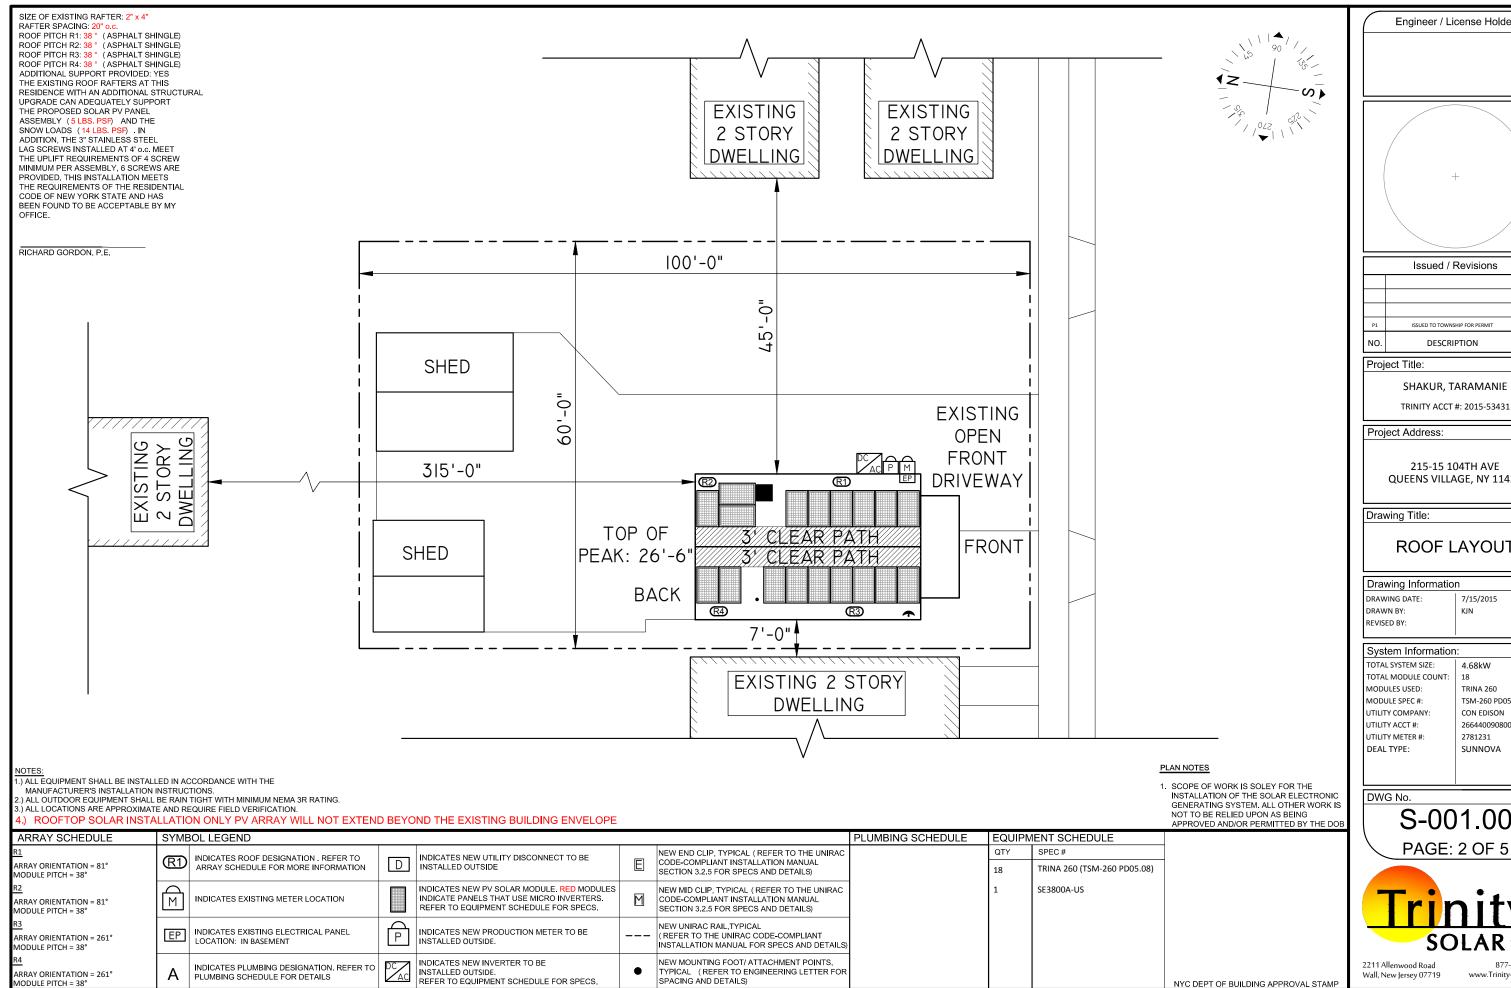

MODULE PITCH = 38°

Engineer / License Holder:

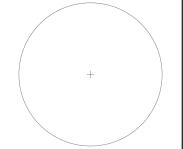

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SHAKUR, TARAMANIE

TRINITY ACCT #: 2015-53431

215-15 104TH AVE **QUEENS VILLAGE, NY 11429**

ROOF LAYOUT

Drawing Information		
DRAWING DATE:	7/15/2015	
DRAWN BY:	KJN	
REVISED BY:		


4.68kW TRINA 260 TSM-260 PD05.08 CON EDISON 266440090800027 2781231 SUNNOVA

S-001.00




Wall, New Jersey 07719

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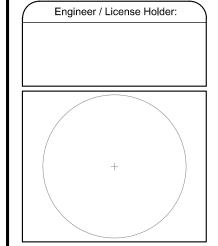


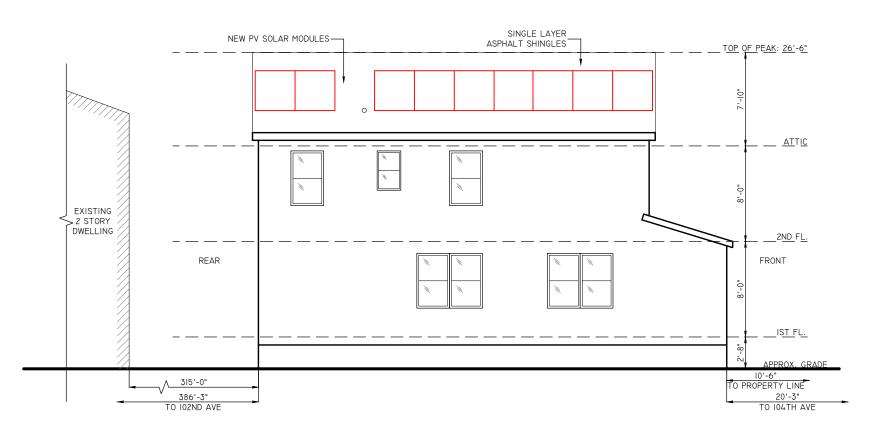WEST ELEVATION SCALE: 1/8"=1'-0"

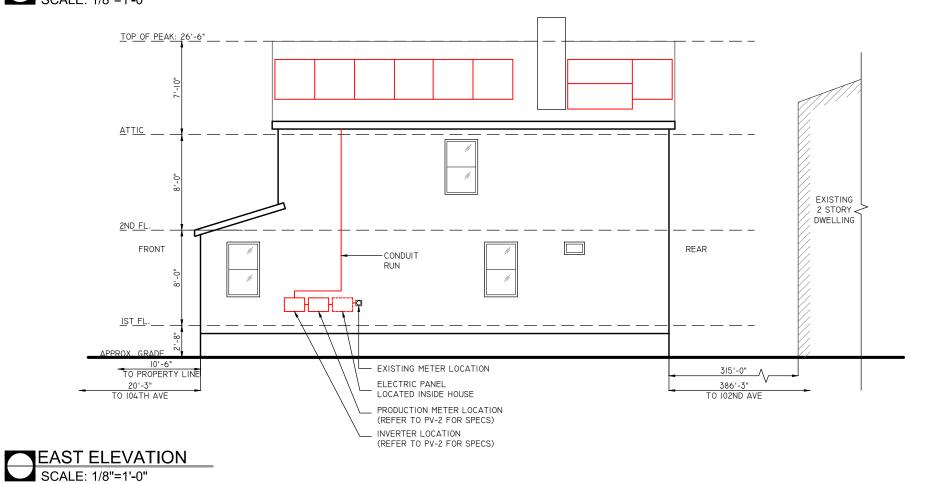

PLAN NOTES

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NO.	DESCRIPTION	DATE

Project Title:

SHAKUR, TARAMANIE

TRINITY ACCT #: 2015-53431

Project Address:

215-15 104TH AVE QUEENS VILLAGE, NY 11429

Drawing Title:

ELEVATION DRAWING

Drawing Information	
DRAWING DATE:	7/15/2015
DRAWN BY:	KJN
REVISED BY:	

System Information:		
TOTAL SYSTEM SIZE:	4.68kW	
TOTAL MODULE COUNT:	18	
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MODULE SPEC #:	TSM-260 PD05.08	
UTILITY COMPANY:	CON EDISON	
UTILITY ACCT #:	266440090800027	
UTILITY METER #:	2781231	
DEAL TYPE:	SUNNOVA	

DWG No.

S-002.00 PAGE: 3 OF 5



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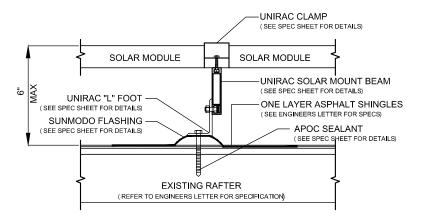
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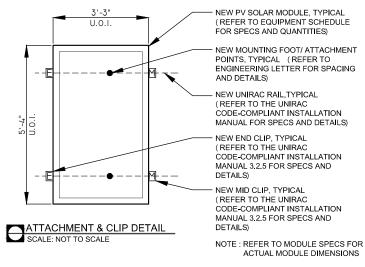
NYC DEPT OF BUILDING APPROVAL STAMP







PV MODULE ATTACHMENT ON ASPHALT SHINGLE ROOF SCALE: NOT TO SCALE



PLAN NOTES

 SCOPE OF WORK IS SOLEY FOR THE
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Issued / Revisions		
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NO.	DESCRIPTION	DATE

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TRINITY ACCT #: 2015-53431

Project Address:

215-15 104TH AVE QUEENS VILLAGE, NY 11429

Drawing Title:

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DWG No. S-003.00


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NYC DEPT OF BUILDING APPROVAL STAMP



ARRAY CIRCUIT WIRING NOTES

COMPLIES WITH 2011 NEC

- 1.) LOWEST EXPECTED AMBIENT TEMPERATURE BASED ON ASHRAE MINIMUM MEAN EXTREME DRY BULB TEMPERATURE FOR ASHRAE LOCATION MOST SIMILAR TO INSTALLATION LOCATION. LOWEST EXPECTED AMBIENT
- 2.) HIGHEST CONTINUOUS AMBIENT TEMPERATURE BASED ON ASHRAE HIGHEST MONTH 2% DRY BULB TEMPERATURE FOR ASHRAE LOCATION MOST SIMILAR TO INSTALLATION LOCATION. HIGHEST CONTINUOUS TEMP =
- 3.) 2005 ASHRAE FUNDAMENTALS 2% DESIGN TEMPERATURES DO NOT EXCEED 47°C IN THE UNITED STATES (PALM SPRINGS, CA IS 44.1°C). FOR LESS THAN 9 CURRENT-CARRYING CONDUCTORS IN A ROOF-MOUNTED SUNLIT CONDUIT AT LEAST 0.5" ABOVE ROOF AND USING THE OUTDOOR DESIGN TEMPERATURE OF 47°C OR LESS (ALL OF UNITED STATES),
- 4.) PHOTOVOLTAIC POWER SYSTEMS SHALL BE PERMITTED TO OPERATE WITH UNGROUNDED PHOTOVOLTAIC SOURCE AND OUTPUT CIRCUIT AS PER
- 5.) ALL EQUIPMENT INSTALLED OUTDOORS SHALL HAVE A NEMA 3 RATING.

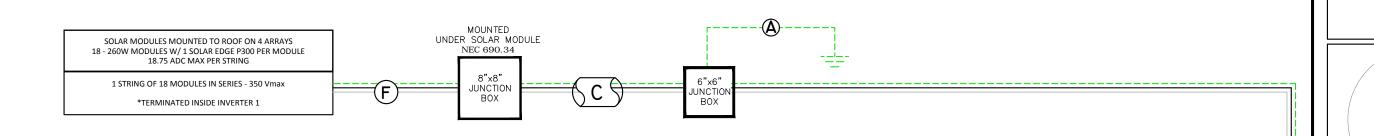CALCULATIONS FOR CURRENT CARRYING

CONDUCTORS
REQUIRED CONDUCTOR AMPACITY PER STRING [NEC 690.8(B) (1)]: (15.00*1.25)1 = 18.75A

AWG #10, DERATED AMPACITY AMBIENT TEMP: 55°C, TEMP DERATING FACTOR: .76
RACEWAY DERATING = 2 CCC: 1.00 (40*.76)1.00 = 30.40A

30.40A ≥ 18.75A, THEREFORE WIRE SIZE IS VALID


TOTAL AC REQUIRED CONDUCTOR AMPACITY 16.00A*1.25 = 20.00A

AWG #10, DERATED AMPACITY
AMBIENT TEMP: 30°C, TEMP DERATING: 1.0
RACEWAY DERATING ≤ 3 CCC: N/A 40A*1.0 = 40A

40A 20.00A, THEREFORE AC WIRE SIZE IS VALID

CALCULATION FOR PV OVERCURRENT PROTECTION TOTAL INVERTER CURRENT: 16.00A 16.00A*1.25 = 20.00A

--> 20A OVERCURRENT PROTECTION IS VALID

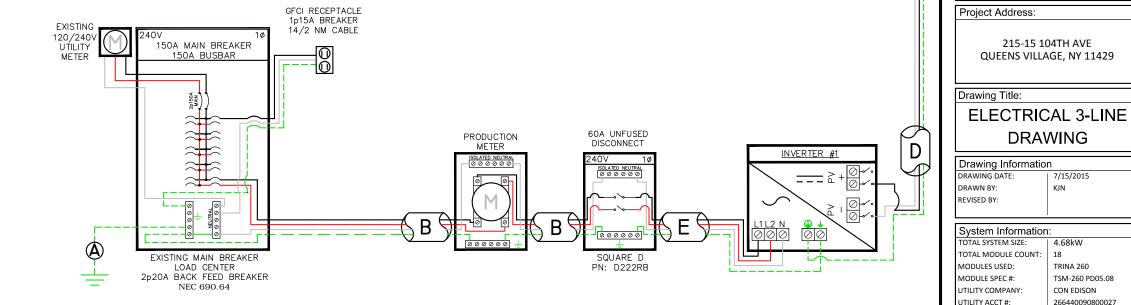

PV MODULE SPECIFICATIONS	
TRINA 260 (TSM-260 PD05.08)	
lmp	8.5
Vmp	30.6
Voc	38.2
Isc	9

INVERTER #1 - SE3800A-US				
DC			AC	
Imp	13	Pout	3800	
Vmp	350	lout	16	
Voc	500	Imax	20	
Isc	15	Vnom	240	

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NYC DEPT OF BUILDING APPROVAL STAMP

Α	#6 THWN-2 GEC TO EXISTING GROUND ROD	
В	3/4" EMT W/ 3-#10 THWN-2, 1-#10 THWN-2 GROUND	
С	3/4" EMT W/ 2-#10 THWN-2, 1-#8 THWN-2 GROUND	
D	3/4" EMT W/ 2-#10 THWN-2, 1-#8 THWN-2 GROUND	
Е	3/4" EMT W/ 3-#10 THWN-2, 1-#10 THWN-2 GROUND	
F	#12 PV WIRE W/ #8 BARE COPPER BOND TO MODULES AND RAILS	

E-001.00

PAGE: 5 OF 5

Engineer / License Holder:

Issued / Revisions

DESCRIPTION

SHAKUR, TARAMANIE TRINITY ACCT #: 2015-53431

215-15 104TH AVE

QUEENS VILLAGE, NY 11429

DRAWING

7/15/2015

TRINA 260

CON EDISON

2781231

SUNNOVA

TSM-260 PD05.08

266440090800027

Project Title:

DATE

2211 Allenwood Road Wall, New Jersey 07719

UTILITY METER #:

DEAL TYPE:

DWG No.

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