

# **INSTALLATION OF NEW ROOF MOUNTED PV SOLAR SYSTEM**

23 N EDO COURT STATES ISLAND, NY 10309



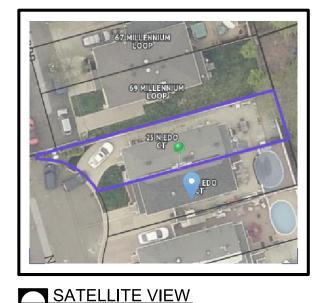

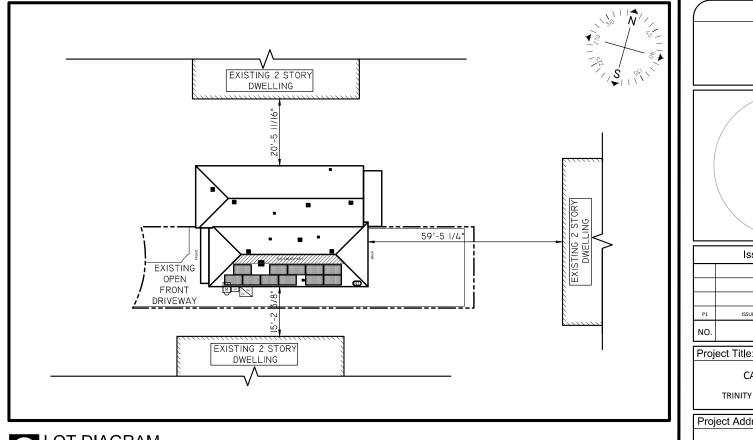



**GENERAL NOTES** 

- 1. THE INSTALLATION CONTRACTOR IS RESPONSIBLE FOR INSTALLING ALL FOLIPMENT AND FOLLOWING ALL DIRECTIONS AND INSTRUCTIONS CONTAINED IN THE DRAWING PACKAGE AND INFORMATION RECEIVED FROM TRINITY
- 2 THE INSTALLATION CONTRACTOR IS RESPONSIBLE FOR INSTALLING ALL EQUIPMENT AND FOLLOWING ALL DIRECTIONS AND INSTRUCTION CONTAINED IN THE COMPLETE MANUAL.
- 3. THE INSTALLATION CONTRACTOR IS RESPONSIBLE FOR READING AND UNDERSTANDING ALL DRAWINGS, COMPONENT AND INVERTER MANUALS PRIOR TO INSTALLATION. THE INSTALLATION CONTRACTOR IS ALSO REQUIRED TO HAVE ALL COMPONENT SWITCHES IN THE OFF POSITION AND FUSES REMOVED PRIOR TO THE INSTALLATION OF ALL FUSE BEARING SYSTEM COMPONENTS.
  4. ONCE THE PHOTOVOLTAIC MODULES ARE
- MOUNTED, THE INSTALLATION CONTRACTOR SHOULD HAVE A MINIMUM OF ONE ELECTRICIAN WHO HAS ATTENDED A SOLAR PHOTOVOLTAIC INSTALLATION COURSE ON SITE.
- 5 FOR SAFETY IT IS RECOMMENDED THAT THE INSTALLATION CREW ALWAYS HAVE A MINIMUM OF TWO PERSONS WORKING TOGETHER AND THAT EACH OF THE INSTALLATION CREW MEMBERS BE TRAINED IN FIRST AID AND CPR.
- 6 THIS SOLAR PHOTOVOLTAIC SYSTEM IS TO BE INSTALLED FOLLOWING THE CONVENTIONS OF THE NATIONAL ELECTRICAL CODE. ANY LOCAL CODE WHICH MAY SUPERSEDE THE NEC SHALL
- 7 ALL SYSTEM COMPONENTS TO BE INSTALLED WITH THIS SYSTEM ARE TO BE "UL" LISTED. ALL EQUIPMENT WILL BE NEMA 3R OUTDOOR RATED UNLESS INDOORS.

### GENERAL NOTES CONTINUED

- THE DC VOLTAGE FROM THE PANELS IS ALWAYS PRESENT AT THE DC DISCONNECT ENCLOSURE AND THE DC TERMINALS OF THE INVERTER DURING DAYLIGHT HOURS. ALL PERSONS WORKING ON OR INVOLVED WITH THE PHOTOVOLTAIC SYSTEM ARE WARNED THAT THE SOLAR MODULES ARE ENERGIZED WHENEVER THEY ARE EXPOSED TO LIGHT.
- ALL PORTIONS OF THIS SOLAR PHOTOVOLTAIC SYSTEM SHALL BE MARKED CLEARLY IN ACCORDANCE WITH THE NATIONAL ELECTRICAL CODE ARTICLE 690 & 705.
- PRIOR TO THE INSTALLATION OF THIS PHOTOVOLTAIC SYSTEM, THE INSTALLATION CONTRACTOR SHALL ATTEND A PRE-INSTALLTION MEETING. FOR THE REVIEW OF THE INSTALLATION PROCEDURES, SCHEDULES, SAFETY AND COORDINATION
- PRIOR TO THE SYSTEM START UP THE INSTALLATION CONTRACTOR SHALL ASSIST IN PERFORMING ALL INITIAL HARDWARE CHECKS AND DC WIRING CONDUCTIVITY CHECKS.
- FOR THE PROPER MAINTENANCE AND ISOLATION OF THE INVERTERS REFER TO THE ISOLATION PROCEDURES IN THE OPERATION MANUAL.
- THE LOCATION OF PROPOSED ELECTRIC AND TELEPHONE UTILITIES ARE SUBJECT TO FINAL APPROVAL OF THE APPROPRIATE UTILITY COMPANIES AND OWNERS
- ALL MATERIALS. WORKMANSHIP AND CONSTRUCTION FOR THE SITE IMPROVEMENTS SHOWN HEREIN SHALL BE IN ACCORDANCE WITH:
  - **ENERGY CODE** A) CURRENT PREVAILING MUNICIPAL COMPLIANCE AND/OR COUNTY SPECIFICATIONS, STANDARDS AND REQUIREMENTS

### GENERAL NOTES CONTINUED

- B) CURRENT PREVAILING UTILITY COMPANY SPECIFICATIONS, STANDARDS, AND REQUIREMENTS
- THIS SET OF PLANS HAVE BEEN PREPARED FOR THE PURPOSE OF MUNICIPAL AND AGENCY REVIEW AND APPROVAL THIS SET OF PLANS SHALL NOT BE UTILIZED AS CONSTRUCTION DRAWINGS UNTIL REVISED TO INDICATE "ISSUED FOR CONSTRUCTION".
- ALL INFORMATION SHOWN MUST BE CERTIFIED PRIOR TO USE FOR CONSTRUCTION ACTIVITIES.

- 1. PV INSTALLATION TO COMPLY WITH ARTICLE 690 OF THE NEC
- 2. PV INSTALLATION TO COMPLY WITH NYSERDA REQUIREMENTS.
- 3 PV INSTALLATION TO COMPLY WITH NEW YORK STAT STANDARDIZED

1. PV INSTALLATION TO COMPLY WITH NYC ELECTRIC CODE 2011.

### PLAN NOTES

1 SCOPE OF WORK IS SOLEY FOR THE INSTALLATION OF THE SOLAR ELECTRONIC GENERATING SYSTEM, ALL OTHER WORK IS NOT TO BE RELIED UPON AS BEING APPROVED AND/OR PERMITTED BY THE DOB

## SPECIAL INSPECTIONS: STABILITY

FIRE STOP PROGRESS INSPECTIONS: FINAL INSPECTION VISUAL AIR SEALING

# SCALE: 1"=350'

### TENANT SAFETY NOTES

- 1. CONSTRUCTION WORK WILL BE CONFINED TO THE ROOF / OUTSIDE & WILL NOT CREATE DUST, DIRT OR OTHER INCONVENIENCES TO NEIGHBORING PROPERTIES OR APARTMENT UNITS WITHIN THE BUILDING.
- 2. CONSTRUCTION WORK WILL NOT BLOCK HALLWAYS OR MEANS OF EGRESS FOR NEIGHBORING PROPERTIES OR TENANTS OF THE BUILDING.
- 3. CONSTRUCTION WORK WILL NOT INVOLVE INTERRUPTION OF HEATING, WATER OR ELECTRIC SERVICES TO NEIGHBORING PROPERTIES OR TENANTS OF THE BUILDING
- 4. CONSTRUCTION WORK WILL BE CONFINED TO NORMAL WORKING HOURS, 8AM - 5PM MONDAY THRU FRIDAY EXCEPT LEGAL HOLIDAYS.

A. TENANT EGRESS TO AND FROM THE BUILDING.

B. FIRE SAFETY, OR CREATE A FIRE HAZARD.

STAT AND FEDERAL DUMPING GROUNDS

THRU FRIDAY EXCEPT LEGAL HOLIDAYS

ROPOSED VALUE:

AND ECC TABLE R402.4.2

ESCRIBED IN SECTION ECC

PENETRATIONS AS

R402.4.2

UILDING STRUCTURE BY

DI TING TO STRUCTURAL

MFMBERS, AND SHOWN ON

C. STRUCTURAL SAFETY OF THE BUILDING.

TENANT PROTECTION PLAN

## **ABBREVIATIONS**

ALUMINUM AMP. FRAME ABOVE FINISHED FLOOR AFF AFG ABOVE FINISHED GRADE AMERICAN WIRE GAUGE CONDUIT (GENERIC TERM OF RACEWAY PROVIDE AS

SPECIFIED) COMBINER BOX CKT CIRCUIT CURRENT TRANSFORMER

ALTERNATING CURRENT

CU COPPER DC DISC DIRECT CURRENT DISCONNECT SWITCH DWG DRAWING

ELECTRICAL SYSTEM INSTALLER EC EMT ELECTRICAL METALLIC TUBING FS FU FUSIBLE SWITCH

FUSE GROUND GFI

> DOCUMENTATION 001 00 SOLAR PANEL

NCHORAGE DETAILS AND

SPECIAL PRECAUTION SHALL BE TAKEN BY THE CONTRACTOR SO THAT EQUIPMENT ON THIS

D. ACCUMULATION OF DUST. THE CONTRACTOR SHALL LEAVE THE WORK SITE BROOM CLEAN EACH

IN ACCORDANCE WITH ALL APPLICABLE REGULATIONS OF O.S.H.A SECTION 1901.1, INCLUDING

DAY. IN THE EVENT THAT ASBESTOS IS FOUND ON THE JOBSITE, ITS REMOVAL SHALL TAKE PLACE

THERE SHALL BE NO CREATION OF NOISE OUTSIDE THE NORMAL HOURS OF 8AM TO 5PM MONDAY

APPLICATION TYPE: ALT-2 SCOPE OF WORK: INSTALL NEW ROOF MOUNTED SOLAR ELECTRICITY (PV-PHOTOVOLTAIC) GENERATING SYSTEM

THAT SHOWN IN THIS ENERGY ANALYSIS. HAS BEEN INCLUDED IN AN ASSOCIATED PLAN APPROVAL AND WORK PERMIT APPLICATION

RESCRIPTIVE VALUE

WEATHERSTRIPPING OR OTHER

MATERIALS IN ACCORDANCE

AND CITATION:

CERTIFY THAT ANY BUILDING CONSTRUCTION ASSOCIATED WITH THE INSTALLATION OF THE SOLAR ELECTRIC GENERATING SYSTEM. OTHER THAN

APPLICATION AND ITS INSTALLATION WILL NOT AFFECT THE FALLOWING

GROUND FAULT INTERRUPTER FREQUENCY (CYCLES PER

DESCRIPTION:

PECTION OF OPENINGS AND PENETRATIONS IN THE

CC R402.4 AND APPROVED DRAWINGS

BUILDING ENVELOPE TO VERIEY THAT THEY ARE PROPERL

SEALED, IN ACCORDANCE WITH ECC TABLE R402.4.2, SECTION

## ABBREVIATIONS CONTINUED

JUNCTION BOX THOUSAND CIRCULAR MILS KILO-VOLT AMPERE kVA KILO-WATT kWH KILO-WATT HOUR MAIN CIRCUIT BREAKER

MDP MAIN DISTRIBUTION PANEL MLO MAIN LUG ONLY MOUNTED MTG MOUNTING NEUTRAL NATIONAL ELECTRICAL CODE

NIC NOT IN CONTRACT NO# NUMBER NOT TO SCALE OCP OVER CURRENT PROTECTION POLE

PB PULL BOX PHASE POLY-VINYL CHLORIDE CONDUIT POWER

QTY QUANTITY RIGID GALVANIZED STEEL

## ABBREVIATIONS CONTINUED

JSWBD SWITCHBOARD U.O.I. UNLESS OTHERWISE INDICATED WEATHERPROOF XFMR TRANSFORMER +72 MOUNT 72 INCHES TO BOTTOM OF ABOVE FINISHED FLOOR OR GRADE

DRAWING

NYC FC504 EXEMPT - PITCH GREATER THAN 5/12 BC 109.3.3 RCNY 5000-01 (H) (IA6) IIA6) 28-116.2.4.2 AND DIRECTIVE 14 OF 1975

### PLAN NOTES

1. SCOPE OF WORK IS SOLEY FOR THE NOT TO BE RELIED UPON AS BEING

T-001.00 - COVER SHEET S- 001.00 - ROOF LAYOUT S- 002.00 - ELEVATION DRAWING S- 003.00 - ELEVATION DRAWING S- 004.00 - ELEVATION DRAWING E- 001.00 - ELECTRICAL 3-LINE

### DEPARTMENT OF BUILDING NOTES

INSTALLATION OF THE SOLAR ELECTRONIC GENERATING SYSTEM, ALL OTHER WORK IS APPROVED AND/OR PERMITTED BY THE DOE

DWG No: T-001.00



**PAGE: 1 OF 5** 

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ISSUED TO TOWNSHIP FOR PERMIT

DESCRIPTION

CAPPELLO, JAIME TRINITY ACCT #: 2017-11-210166

23 N EDO COURT

STATES ISLAND, NY 10309

40.546396,-74.215245

**COVER SHEET** 

1/23/2018

3.245kW

HANWHA 295

CON EDISON

SUNRUN

O.PEAK-BLK G4.1 295

7011 806 0230 0032

3kW

Project Address:

Drawing Title:

DRAWING DATE

DC SYSTEM SIZE

AC SYSTEM SIZE:

MODULES USED:

MODULE SPEC #:

UTILITY COMPANY:

UTILITY METER #

UTILITY ACCT #:

DEAL TYPE:

DRAWN BY

REVISED BY

Drawing Information

System Information:


TOTAL MODULE COUNT

DATE

NYC DEPT OF BUILDING APPROVAL STAMP

2211 Allenwood Road Wall, New Jersey 07719 www.Trinity-Solar.com

THE WORK PROPOSED IN THIS APPLICATION IS COMPLIANT WITH THE ENERGY CONSERVATION CONSTRUCTION CODE OF NEW YORK CITY TO THE BEST OF MY KNOWLEDGE, BELIEF AND PROFESSIONAL JUDGEMENT, THESE PLANS AND SPECIFICATIONS ARE IN COMPLIANCE WITH THE ENERGY CONSERVATION CONSTRUCTION CODE OF NEW YORK CITY 2010

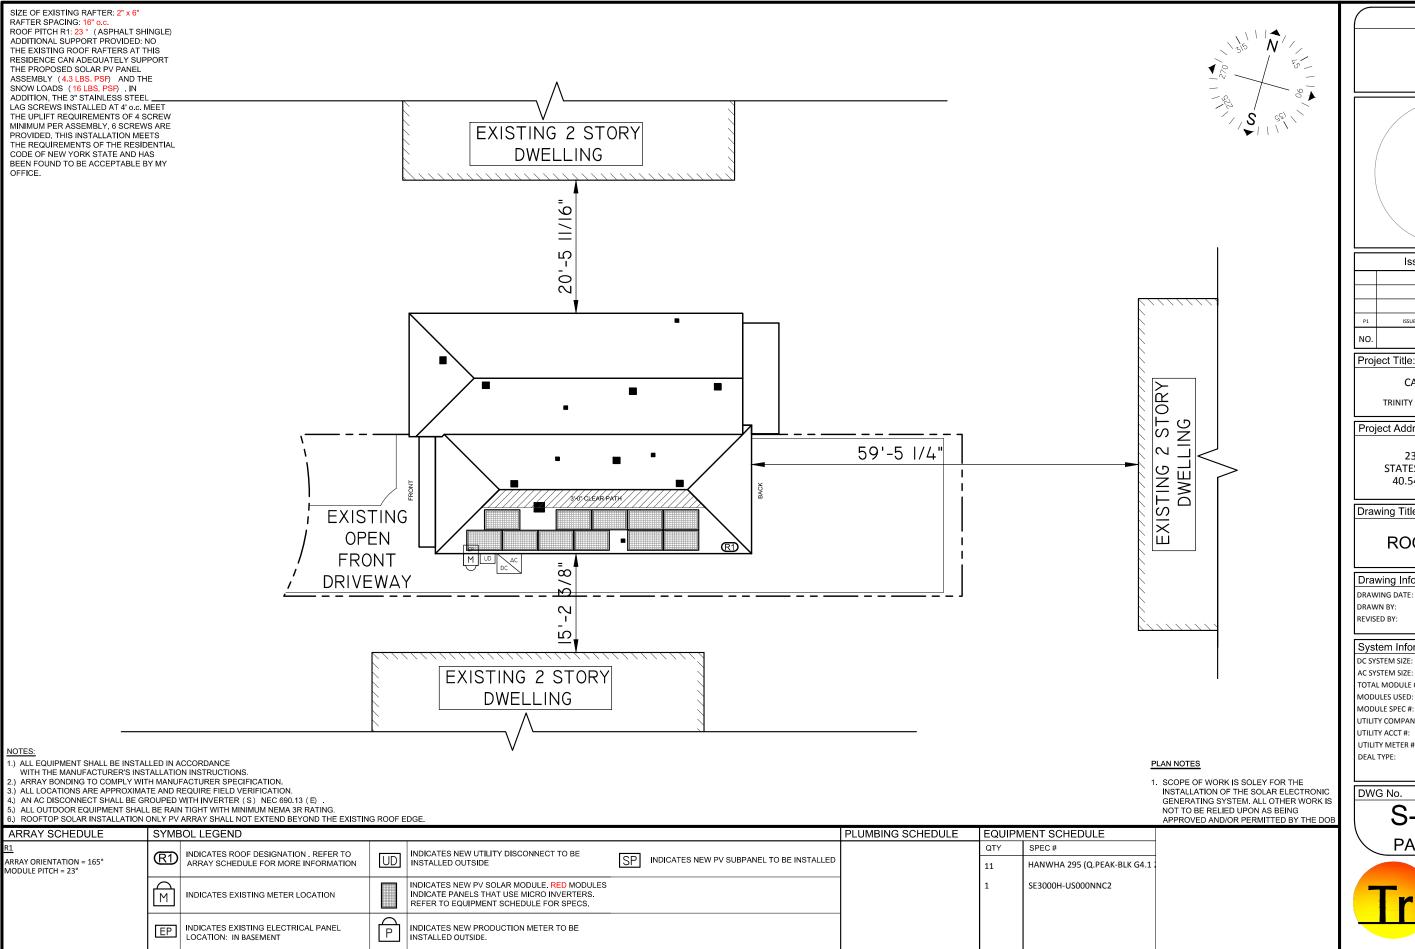


INDICATES NEW INVERTER TO BE

REFER TO EQUIPMENT SCHEDULE FOR SPECS.

INSTALLED OUTSIDE

D INDICATES NEW MAIN DISCONNECT

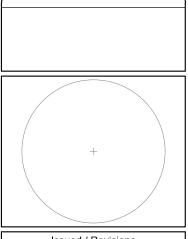

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CAPPELLO, JAIME

TRINITY ACCT #: 2017-11-210166

### Project Address:

23 N EDO COURT STATES ISLAND, NY 10309 40.546396,-74.215245

## Drawing Title:

## **ROOF LAYOUT**

Drawing Information		
DRAWING DATE:	1/23/2018	
DRAWN BY:	JC	
REVISED BY:		

### System Information: DC SYSTEM SIZE:

AC SYSTEM SIZE: TOTAL MODULE COUNT: MODULES USED: MODULE SPEC #: UTILITY COMPANY: UTILITY ACCT #: UTILITY METER #:

HANWHA 295 Q.PEAK-BLK G4.1 295 CON EDISON 7011 806 0230 0032 9077378 SUNRUN

3.245kW

S-001.00 PAGE: 2 OF 5





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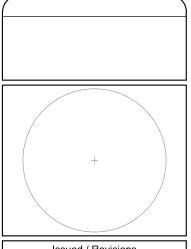




# EAST ELEVATION SCALE: 1/8"=1'-0"

### PLAN NOTES

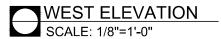SCOPE OF WORK IS SOLEY FOR THE
 INSTALLATION OF THE SOLAR ELECTRONIC
 GENERATING SYSTEM. ALL OTHER WORK IS
 NOT TO BE RELIED UPON AS BEING
 APPROVED AND/OR PERMITTED BY THE DOB

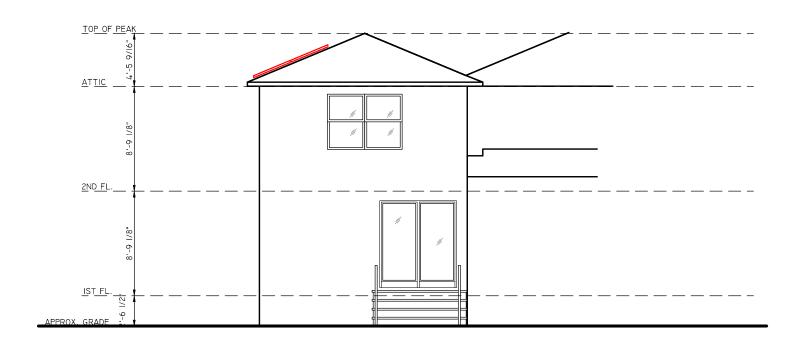

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P1	ISSUED TO TOWNSHIP FOR PERMIT	1/23/2018
NO.	DESCRIPTION	DATE

## Project Title:

CAPPELLO, JAIME

TRINITY ACCT #: 2017-11-210166

### Project Address:

23 N EDO COURT STATES ISLAND, NY 10309 40.546396,-74.215245

Drawing Title:

## **ELEVATION DRAWING**

Drawing Information		
DRAWING DATE:	1/23/2018	
DRAWN BY:	JC	
REVISED BY:		

### System Information: DC SYSTEM SIZE: 3.245kW AC SYSTEM SIZE: 3kW TOTAL MODULE COUNT: MODULES USED: HANWHA 295 MODULE SPEC #: Q.PEAK-BLK G4.1 295 UTILITY COMPANY: CON EDISON UTILITY ACCT #: 7011 806 0230 0032 UTILITY METER #: 9077378 DEAL TYPE: SUNRUN

DWG No.


S-002.00 PAGE: 3 OF 5



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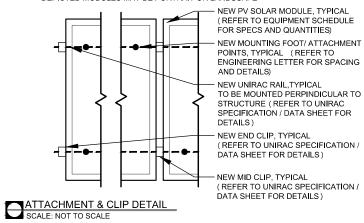
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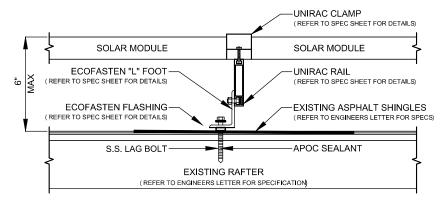
### ZR 23-62 (m) - PANEL PLACEMENT COMPLIES WITH ALL SECTIONS OF ZR 23-62 (m)



SOUTH ELEVATION
SCALE: 1/8"=1'-0"

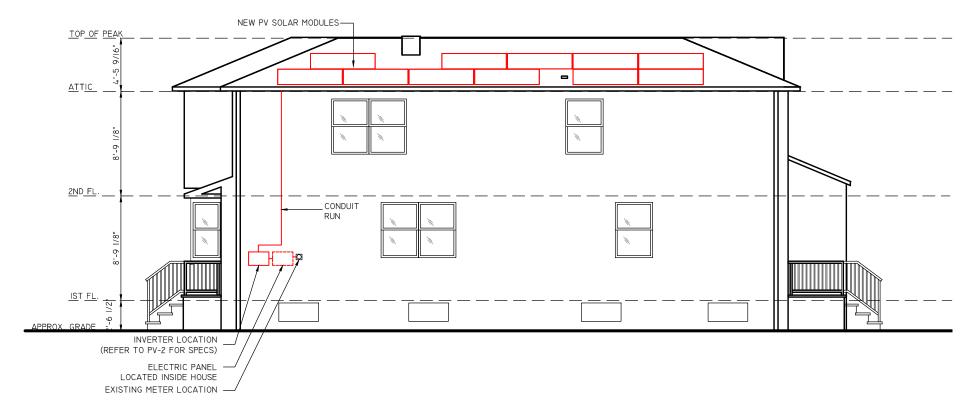NOTES: \*REFER TO MODULE SPECS FOR MODULE DIMENSIONS \*DEPICTED MODULES MAY BE PORTRAIT OR LANDSCAPE





PV MODULE ATTACHMENT ON ASPHALT SHINGLE ROOF SCALE: NOT TO SCALE

## PLAN NOTES

 SCOPE OF WORK IS SOLEY FOR THE INSTALLATION OF THE SOLAR ELECTRONIC GENERATING SYSTEM. ALL OTHER WORK IS NOT TO BE RELIED UPON AS BEING APPROVED AND/OR PERMITTED BY THE DOB +

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NO.	DESCRIPTION	DATE	

### Project Title:

CAPPELLO, JAIME

TRINITY ACCT #: 2017-11-210166

### Project Address:

23 N EDO COURT STATES ISLAND, NY 10309 40.546396,-74.215245

Drawing Title:

## ELEVATION DRAWING

Drawing Information		
DRAWING DATE:	1/23/2018	
DRAWN BY:	JC	
REVISED BY:		

System Information:		
DC SYSTEM SIZE:	3.245kW	
AC SYSTEM SIZE:	3kW	
TOTAL MODULE COUNT:	11	
MODULES USED:	HANWHA 295	
MODULE SPEC #:	Q.PEAK-BLK G4.1 295	
UTILITY COMPANY:	CON EDISON	
UTILITY ACCT #:	7011 806 0230 0032	
UTILITY METER #:	9077378	
DEAL TYPE:	SUNRUN	

S-003.00 PAGE: 4 OF 5



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NYC DEPT OF BUILDING APPROVAL STAMP

ARRAY CIRCUIT WIRING NOTES
1.) LICENSED ELECTRICIAN ASSUMES ALL RESPONSIBILITY FOR DETERMINING ONSITE CONDITIONS AND **EXECUTING INSTALLATION IN ACCORDANCE WITH NEC** 

2.) LOWEST EXPECTED AMBIENT TEMPERATURE BASED ON ASHRAE MINIMUM MEAN EXTREME DRY BULB TEMPERATURE FOR ASHRAE LOCATION MOST SIMILAR TO INSTALLATION LOCATION. LOWEST EXPECTED AMBIENT

3.) HIGHEST CONTINUOUS AMBIENT TEMPERATURE BASED ON ASHRAE HIGHEST MONTH 2% DRY BULB TEMPERATURE FOR ASHRAE LOCATION MOST SIMILAR TO INSTALLATION LOCATION. HIGHEST CONTINUOUS TEMP =

4.) 2005 ASHRAE FUNDAMENTALS 2% DESIGN TEMPERATURES DO NOT EXCEED 47°C IN THE UNITED STATES (PALM SPRINGS, CA IS 44.1°C). FOR LESS THAN 9 CURRENT-CARRYING CONDUCTORS IN A ROOF-MOUNTED SUNLIT CONDUIT AT LEAST 0.5" ABOVE ROOF AND USING THE OUTDOOR DESIGN TEMPERATURE OF 47°C OR LESS (ALL OF UNITED STATES)

5.) PV SYSTEM CIRCUITS INSTALLED ON OR IN BUILDINGS SHALL INCLUDE A RAPID SHUTDOWN FUNCTION THAT CONTROLS SPECIFIC CONDUCTORS IN ACCORDANCE WITH NEC 690.12(1) THROUGH (5)

5.) PHOTOVOLTAIC POWER SYSTEMS SHALL BE PERMITTED TO OPERATE WITH UNGROUNDED PHOTOVOLTAIC SOURCE AND OUTPUT CIRCUIT AS PER NEC 690.35

7.) UNGROUNDED DC CIRCUIT CONDUCTORS SHALL BE IDENTIFIED WITH THE FOLLOWING OUTER FINISH: POSITIVE CONDUCTORS = RED NEGATIVE CONDUCTORS = BLACK NEC 210.5(C)(2)

8.) ARRAY AND SUB ARRAY CONDUCTORS SHALL BE #10 PV WIRE TYPE RHW-2 OR EQUIVELANT AND SHALL BE PROTECTED BY CONDUIT WHERE EXPOSED TO DIRECT SUNLIGHT. SUB ARRAY CONDUIT LONGER THAN 24" SHALL CONTAIN ≤ 20 CURRENT CARYING CONDUCTORS AND WHERE EXPOSED TO DIRECT SUNLIGHT SHALL CONTAIN ≤ 9 CURRENT CARRYING CONDUCTORS.

9.) ALL WIRE LENGTHS SHALL BE LESS THAN 100' UNLESS OTHERWISE NOTED

10.) FLEXIBLE CONDUIT SHALL NOT BE INSTALLED ON ROOFTOP AND SHALL BE LIMITED TO 12" IF USED OUTDOORS

11.)OVERCURRENT PROTECTION FOR CONDUCTORS CONNECTED TO THE SUPPLY SIDE OF A SERVICE SHALL BE LOCATED WITHIN 10' OF THE POINT OF CONNECTION NEC

12.) WHERE TWO SOURCES FEED A BUSSBAR, ONE A UTILITY AND THE OTHER AN INVERTER, PV BACKFEED BREAKER(S) SHALL BE LOCATED OPPOSITE FROM UTILITY NEC 705.12(D)(2)(3)(b)

13.) ALL SOLAR SYSTEM LOAD CENTERS TO CONTAIN ONLY GENERATION CIRCUITS AND NO UNUSED POSITIONS OR

14.) ALL EQUIPMENT INSTALLED OUTDOORS SHALL HAVE A **NEMA 3R** RATING

CALCULATIONS FOR CURRENT CARRYING CONDUCTORS REQUIRED CONDUCTOR AMPACITY PER STRING [NEC 690.8(B)(1)]: (15.00\*1.25)1 = 18.75A

AWG #10, DERATED AMPACITY AMBIENT TEMP: 33°C, TEMP DERATING FACTOR: .96 RACEWAY DERATING = 2 CCC: 1.00 (40\*.96)1.00 = 38.40A

38.40A <sup>></sup> 18.75A, THEREFORE WIRE SIZE IS VALID

TOTAL AC REQUIRED CONDUCTOR AMPACITY 12.50A\*1.25 = 15.63A

AWG #10, DERATED AMPACITY AMBIENT TEMP: 30°C, TEMP DERATING: 1.0 RACEWAY DERATING 5 3 CCC: N/A 40A\*1.0 = 40A

40A - 15.63A, THEREFORE AC WIRE SIZE IS VALID

CALCULATION FOR PV OVERCURRENT PROTECTION TOTAL INVERTER CURRENT: 12.50A


12 50A\*1 25 = 15 63A

--> 20A OVERCURRENT PROTECTION IS VALID

SOLAR MODULES MOUNTED TO ROOF ON 1 ARRAY 11 - 295W MODULES W/ 1 SOLAR EDGE P300 PER MODULE

1 STRING OF 11 MODULES IN SERIES - 350 Vmax

\*TERMINATED INSIDE INVERTER 1

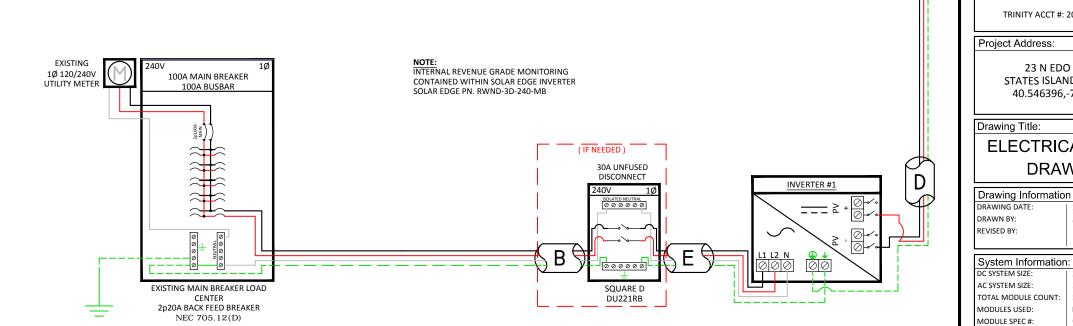

PV MODULE SPECIFICATIONS		
HANWHA 295 (Q.PEAK-BLK G4.1 295)		
lmp	9.17	
Vmp	32.19	
Voc	39.48	
Isc	9.7	

IN'	VERTER #1 - S	E3000H-US000	NNC2
DC		,	AC
Imp	8.5	Pout	3000
Vmp	380	Imax	12.5
Voc	480	OCPDmin	15.625
Isc	15	Vnom	240

FC 504.4.7 - ALL CONDUITS AND PIPING INSTALLATIONS SHALL BE COLOR-CODED WITH CONTINUOUS, DURABLE, AND WEATHERPROOF REFLECTIVE TO MEET OR EXCEED NEC AND LOCAL AHID REQUIREMENTS OR LUMINESCENT MARKINGS AS FOLLOWS, AND FOR CONDUIT AND PIPING INSTALLED AFTER JULY 1, 2014, SHALL BE CONTINUOUSLY LABELED IN AN APPROVED MANNER TO INDICATES ITS CONTENTS:

JUNCTION

BOX

HIGH VOLTAGE WIRING - RED
 LOW VOLTAGE WIRING - ORANGE

3. NATURAL GAS PIPING - YELLOW

FC 512.4.2 - INDOOR AND OUTDOOR DIRECT CURRENT CONDUIT, ENCLOSURE,  ${\tt RACEWAYS, CABLE \ ASSEMBLIES, JUNCTION \ BOXES, COMBINER}$ BOXES, AND MAIN SERVICE AND OTHER DISCONNECTS SHALL HAVE DURABLE, RETOREFLECTIVE, AND, IF OUTDOORS, WEATHERPROOF MARKINGS, IN WHITE CAPITAL LETTERS WITH A HEIGHT OF NOT LESS THAN \$ INCH (9.5 MM) ON A RED BACKGROUND, READING "WARNING: PHOTOVOLTAIC POWER SOURCE."

			l
	Α	#6 THWN-2 GEC TO EXISTING GROUND ROD	lr
	В	3/4" CONDUIT W/ 3-#10 THWN-2, 1-#10 THWN-2 GROUND	
	С	3/4" CONDUIT W/ 2-#10 THWN-2, 1-#10 THWN-2 GROUND	
	D	3/4" CONDUIT W/ 2-#10 THWN-2, 1-#10 THWN-2 GROUND	
	Е	3/4" CONDUIT W/ 2-#10 THWN-2, 1-#10 THWN-2, 1-#10 THWN-2 GROUND	
;	F	#10 PV WIRE (FREE AIR) W/ #6 BARE COPPER BOND TO ARRAY	

### PLAN NOTES



E-001.00

PAGE: 5 OF 5

Issued / Revisions

DESCRIPTION

CAPPELLO, JAIME

TRINITY ACCT #: 2017-11-210166

23 N EDO COURT

STATES ISLAND, NY 10309

40.546396,-74.215245

**ELECTRICAL 3-LINE** 

DRAWING

1/23/2018

HANWHA 295

CON FDISON

9077378

SUNRUN

Q.PEAK-BLK G4.1 295

7011 806 0230 0032

Project Title:

DC SYSTEM SIZE

AC SYSTEM SIZE:

MODULES USED:

UTILITY COMPANY:

UTILITY ACCT #:

UTILITY METER #:

DEAL TYPE:

TOTAL MODULE COUNT:

DATE

2211 Allenwood Road Wall, New Jersey 07719

DWG No.

 SCOPE OF WORK IS SOLEY FOR THE
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NYC DEPT OF BUILDING APPROVAL STAMP

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