INSTALLATION OF NEW ROOF MOUNTED PV SOLAR SYSTEM

426 S 4TH AVENUE **MOUNT VERNON, NY 10550**











GENERAL NOTES

- 1. THE INSTALLATION CONTRACTOR IS RESPONSIBLE FOR INSTALLING ALL EQUIPMENT AND FOLLOWING ALL DIRECTIONS AND INSTRUCTIONS CONTAINED IN THE DRAWING PACKAGE AND INFORMATION RECEIVED FROM TRINITY
- 2 THE INSTALLATION CONTRACTOR IS RESPONSIBLE FOR INSTALLING ALL EQUIPMENT AND FOLLOWING ALL DIRECTIONS AND INSTRUCTION CONTAINED IN THE COMPLETE MANUAL.
- 3. THE INSTALLATION CONTRACTOR IS RESPONSIBLE FOR READING AND UNDERSTANDING ALL DRAWINGS, COMPONENT AND INVERTER MANUALS PRIOR TO INSTALLATION. THE INSTALLATION CONTRACTOR IS ALSO REQUIRED TO HAVE ALL COMPONENT SWITCHES IN THE OFF POSITION AND FUSES REMOVED PRIOR TO THE INSTALLATION OF ALL FUSES BEARING SYSTEM COMPONENTS.
 4. ONCE THE PHOTOVOLTAIC MODULES ARE
- MOUNTED, THE INSTALLATION CONTRACTOR SHOULD HAVE A MINIMUM OF ONE ELECTRICIAN WHO HAS ATTENDED A SOLAR PHOTOVOLTAIC INSTALLATION COURSE ON SITE.
- 5 FOR SAFETY IT IS RECOMMENDED THAT THE INSTALLATION CREW ALWAYS HAVE A MINIMUM OF TWO PERSONS WORKING TOGETHER AND THAT EACH OF THE INSTALLATION CREW MEMBERS BE TRAINED IN FIRST AID AND CPR.
- 6 THIS SOLAR PHOTOVOLTAIC SYSTEM IS TO BE INSTALLED FOLLOWING THE CONVENTIONS OF THE NATIONAL ELECTRICAL CODE. ANY LOCAL CODE WHICH MAY SUPERSEDE THE NEC SHALL
- 7 ALL SYSTEM COMPONENTS TO BE INSTALLED WITH THIS SYSTEM ARE TO BE "UL" LISTED. ALL EQUIPMENT WILL BE NEMA 3R OUTDOOR RATED UNLESS INDOORS.



- THE DC VOLTAGE FROM THE PANELS IS ALWAYS PRESENT AT THE DC DISCONNECT ENCLOSURE AND THE DC TERMINALS OF THE INVERTER DURING DAYLIGHT HOURS. ALL PERSONS WORKING ON OR INVOLVED WITH THE PHOTOVOLTAIC SYSTEM ARE WARNED THAT THE SOLAR MODULES ARE ENERGIZED WHENEVER THEY ARE
- EXPOSED TO LIGHT. ALL PORTIONS OF THIS SOLAR PHOTOVOLTAIC SYSTEM SHALL BE MARKED CLEARLY IN ACCORDANCE WITH THE NATIONAL ELECTRICAL CODE ARTICLE 690 & 705.
- PRIOR TO THE INSTALLATION OF THIS PHOTOVOLTAIC SYSTEM, THE INSTALLATION CONTRACTOR SHALL ATTEND A PRE-INSTALLTION MEETING. FOR THE REVIEW OF THE INSTALLATION PROCEDURES, SCHEDULES, SAFETY AND COORDINATION
- PRIOR TO THE SYSTEM START UP THE INSTALLATION CONTRACTOR SHALL ASSIST IN PERFORMING ALL INITIAL HARDWARE CHECKS AND DC WIRING CONDUCTIVITY CHECKS.
- FOR THE PROPER MAINTENANCE AND ISOLATION OF THE INVERTERS REFER TO THE ISOLATION PROCEDURES IN THE OPERATION MANUAL.
- THE LOCATION OF PROPOSED ELECTRIC AND TELEPHONE UTILITIES ARE SUBJECT TO FINAL APPROVAL OF THE APPROPRIATE UTILITY COMPANIES AND **OWNERS**
- ALL MATERIALS. WORKMANSHIP AND CONSTRUCTION FOR THE SITE IMPROVEMENTS SHOWN HEREIN SHALL BE IN ACCORDANCE WITH:
 - **ENERGY CODE** A) CURRENT PREVAILING MUNICIPAL COMPLIANCE AND/OR COUNTY SPECIFICATIONS, STANDARDS AND REQUIREMENTS

GENERAL NOTES CONTINUED

- B) CURRENT PREVAILING UTILITY COMPANY SPECIFICATIONS, STANDARDS, AND REQUIREMENTS
- THIS SET OF PLANS HAVE BEEN PREPARED FOR THE PURPOSE OF MUNICIPAL AND AGENCY REVIEW AND APPROVAL THIS SET OF PLANS SHALL NOT BE UTILIZED AS CONSTRUCTION DRAWINGS UNTIL REVISED TO INDICATE "ISSUED FOR CONSTRUCTION".
- ALL INFORMATION SHOWN MUST BE CERTIFIED PRIOR TO USE FOR CONSTRUCTION ACTIVITIES.

SATELLITE VIEW

- 1. PV INSTALLATION TO COMPLY WITH ARTICLE 690 OF THE NEC
- 2. PV INSTALLATION TO COMPLY WITH NYSERDA REQUIREMENTS.
- 3 PV INSTALLATION TO COMPLY WITH NEW YORK STAT STANDARDIZED

1. PV INSTALLATION TO COMPLY WITH NYC ELECTRIC CODE 2011.

PLAN NOTES

1 SCOPE OF WORK IS SOLEY FOR THE INSTALLATION OF THE SOLAR ELECTRONIC GENERATING SYSTEM, ALL OTHER WORK IS NOT TO BE RELIED UPON AS BEING APPROVED AND/OR PERMITTED BY THE DOB

SPECIAL INSPECTIONS: STABILITY

FIRE STOP PROGRESS INSPECTIONS: FINAL INSPECTION VISUAL AIR SEALING

LOT DIAGRAM SCALE: 1"=400'

TENANT SAFETY NOTES

- 1. CONSTRUCTION WORK WILL BE CONFINED TO THE ROOF / OUTSIDE & WILL NOT CREATE DUST, DIRT OR OTHER INCONVENIENCES TO NEIGHBORING PROPERTIES OR APARTMENT UNITS WITHIN THE BUILDING.
- 2. CONSTRUCTION WORK WILL NOT BLOCK HALLWAYS OR MEANS OF EGRESS FOR NEIGHBORING PROPERTIES OR TENANTS OF THE BUILDING.
- 3. CONSTRUCTION WORK WILL NOT INVOLVE INTERRUPTION OF HEATING, WATER OR ELECTRIC SERVICES TO NEIGHBORING PROPERTIES OR TENANTS OF THE BUILDING
- 4. CONSTRUCTION WORK WILL BE CONFINED TO NORMAL WORKING HOURS, 8AM - 5PM MONDAY THRU FRIDAY EXCEPT LEGAL HOLIDAYS.

ABBREVIATIONS

81'-2 3/4'

AL	ALUMINUM
AF	AMP. FRAME
AFF	ABOVE FINISHED FLOO
AFG	ABOVE FINISHED GRA
AWG	AMERICAN WIRE GAUG
С	CONDUIT (GENERIC 1
	RACEWAY, PROVIDE A

SPECIFIED) COMBINER BOX CKT CIRCUIT

DC DISC DWG

APPLICATION AND ITS INSTALLATION WILL NOT AFFECT THE FALLOWING

D. ACCUMULATION OF DUST. THE CONTRACTOR SHALL LEAVE THE WORK SITE BROOM CLEAN EACH

IN ACCORDANCE WITH ALL APPLICABLE REGULATIONS OF O.S.H.A SECTION 1901.1, INCLUDING

DAY. IN THE EVENT THAT ASBESTOS IS FOUND ON THE JOBSITE, ITS REMOVAL SHALL TAKE PLACE

THERE SHALL BE NO CREATION OF NOISE OUTSIDE THE NORMAL HOURS OF 8AM TO 5PM MONDAY

APPLICATION TYPE: ALT-2 SCOPE OF WORK: INSTALL NEW ROOF MOUNTED SOLAR ELECTRICITY (PV-PHOTOVOLTAIC) GENERATING SYSTEM

THAT SHOWN IN THIS ENERGY ANALYSIS. HAS BEEN INCLUDED IN AN ASSOCIATED PLAN APPROVAL AND WORK PERMIT APPLICATION

RESCRIPTIVE VALUE

WEATHERSTRIPPING OR OTHER

MATERIALS IN ACCORDANCE

AND CITATION:

CERTIFY THAT ANY BUILDING CONSTRUCTION ASSOCIATED WITH THE INSTALLATION OF THE SOLAR ELECTRIC GENERATING SYSTEM. OTHER THAN

A. TENANT EGRESS TO AND FROM THE BUILDING.

B. FIRE SAFETY, OR CREATE A FIRE HAZARD.

STAT AND FEDERAL DUMPING GROUNDS

THRU FRIDAY EXCEPT LEGAL HOLIDAYS

ROPOSED VALUE:

RESCRIBED IN SECTION ECC.

402.4.2 AND ECC TABLE 402.4.2

PENETRATIONS AS

JII DING STRUCTURE BY

MFMBERS, AND SHOWN ON

LTING TO STRUCTURAL

C. STRUCTURAL SAFETY OF THE BUILDING.

TENANT PROTECTION PLAN

ALTERNATING CURRENT kVA KILO-WATT kWH

DESCRIPTION:

PECTION OF OPENINGS AND PENETRATIONS IN THE

ECC 402.4 AND APPROVED DRAWINGS

BUILDING ENVELOPE TO VERIEY THAT THEY ARE PROPERLY

SEALED, IN ACCORDANCE WITH ECC TABLE 402.4.2, SECTION

EXISTING OPE FRONT DRIVEWAY

TERM OF

CURRENT TRANSFORMER CU COPPER

DIRECT CURRENT DISCONNECT SWITCH DRAWING ELECTRICAL SYSTEM INSTALLER EC EMT ELECTRICAL METALLIC TUBING

FS FU FUSIBLE SWITCH FUSE GROUND

DOCUMENTATION: 001 00 SOLAR PANEL

NCHORAGE DETAILS AND

GFI GROUND FAULT INTERRUPTER FREQUENCY (CYCLES PER

SPECIAL PRECAUTION SHALL BE TAKEN BY THE CONTRACTOR SO THAT EQUIPMENT ON THIS

ABBREVIATIONS CONTINUED

DWELLING

EXISTING 2 STORY

DWELLING

JUNCTION BOX THOUSAND CIRCULAR MILS KILO-VOLT AMPERE KILO-WATT HOUR MAIN CIRCUIT BREAKER +72

MDP MAIN DISTRIBUTION PANEL MLO MAIN LUG ONLY MOUNTED MTG MOUNTING NEUTRAL

NATIONAL ELECTRICAL CODE NOT IN CONTRACT NO# NUMBER NOT TO SCALE OVER CURRENT PROTECTION OCP

POLE PB PULL BOX PHASE

POLY-VINYL CHLORIDE CONDUIT POWER QTY QUANTITY

RIGID GALVANIZED STEEL

ABBREVIATIONS CONTINUED

JSWBD SWITCHBOARD TYPICAL U.O.I. UNLESS OTHERWISE INDICATED WEATHERPROOF XFMR TRANSFORMER MOUNT 72 INCHES TO BOTTOM OF ABOVE FINISHED FLOOR OR GRADE

DRAWING INDEX T-001.00 - COVER SHEET S- 001.00 - ROOF LAYOUT S- 002.00 - ELEVATION DRAWING S- 003.00 - ELEVATION DRAWING S- 004 00 - TOPOGRAPHIC MAP S- 005.00 - FRONT OF HOUSE PHOTO W/ PANEL LOCATION E-001.00 - ELECTRICAL 3-LINE DRAWING

DEPARTMENT OF BUILDING NOTES

NYC FC504 EXEMPT - PITCH GREATER THAN 5/12 BC 109.3.3 RCNY 5000-01 (H) (IA6) IIA6) 28-116.2.4.2 AND DIRECTIVE 14 OF 1975

PLAN NOTES

1. SCOPE OF WORK IS SOLEY FOR THE INSTALLATION OF THE SOLAR ELECTRONIC GENERATING SYSTEM, ALL OTHER WORK IS NOT TO BE RELIED UPON AS BEING APPROVED AND/OR PERMITTED BY THE DOE

Issued / Revisions

Engineer / License Holder:

MODULE TYPE CHANGE ISSUED TO TOWNSHIP FOR PERMIT DATE DESCRIPTION

Project Title:

CROOKS, COSMO

TRINITY ACCT #: 2016-11-106369

Project Address:

426 S 4TH AVENUE MOUNT VERNON, NY 10550

Drawing Title:

COVER SHEET

Drawing Information DRAWING DATE 12/30/2016 DRAWN BY JES REVISED BY:

System Information:					
DC SYSTEM SIZE:	2.85kW				
AC SYSTEM SIZE:	3kW				
TOTAL MODULE COUNT:	10				
MODULES USED:	TRINA 285				
MODULE SPEC #:	TSM-285 DD05A.05				
UTILITY COMPANY:	CON EDISON				
UTILITY ACCT #:	5222 010 4960 4005				
UTILITY METER #:	7756131				
DEAL TYPE:	CASH				

DWG No:

T-001.00 **PAGE: 1 OF 7**



2211 Allenwood Road


NYC DEPT OF BUILDING APPROVAL STAMP



Wall, New Jersey 07719

www.Trinity-Solar.com

THE WORK PROPOSED IN THIS APPLICATION IS COMPLIANT WITH THE ENERGY CONSERVATION CONSTRUCTION CODE OF NEW YORK CITY TO THE BEST OF MY KNOWLEDGE, BELIEF AND PROFESSIONAL JUDGEMENT, THESE PLANS AND SPECIFICATIONS ARE IN COMPLIANCE WITH THE ENERGY CONSERVATION CONSTRUCTION CODE OF NEW YORK CITY 2010

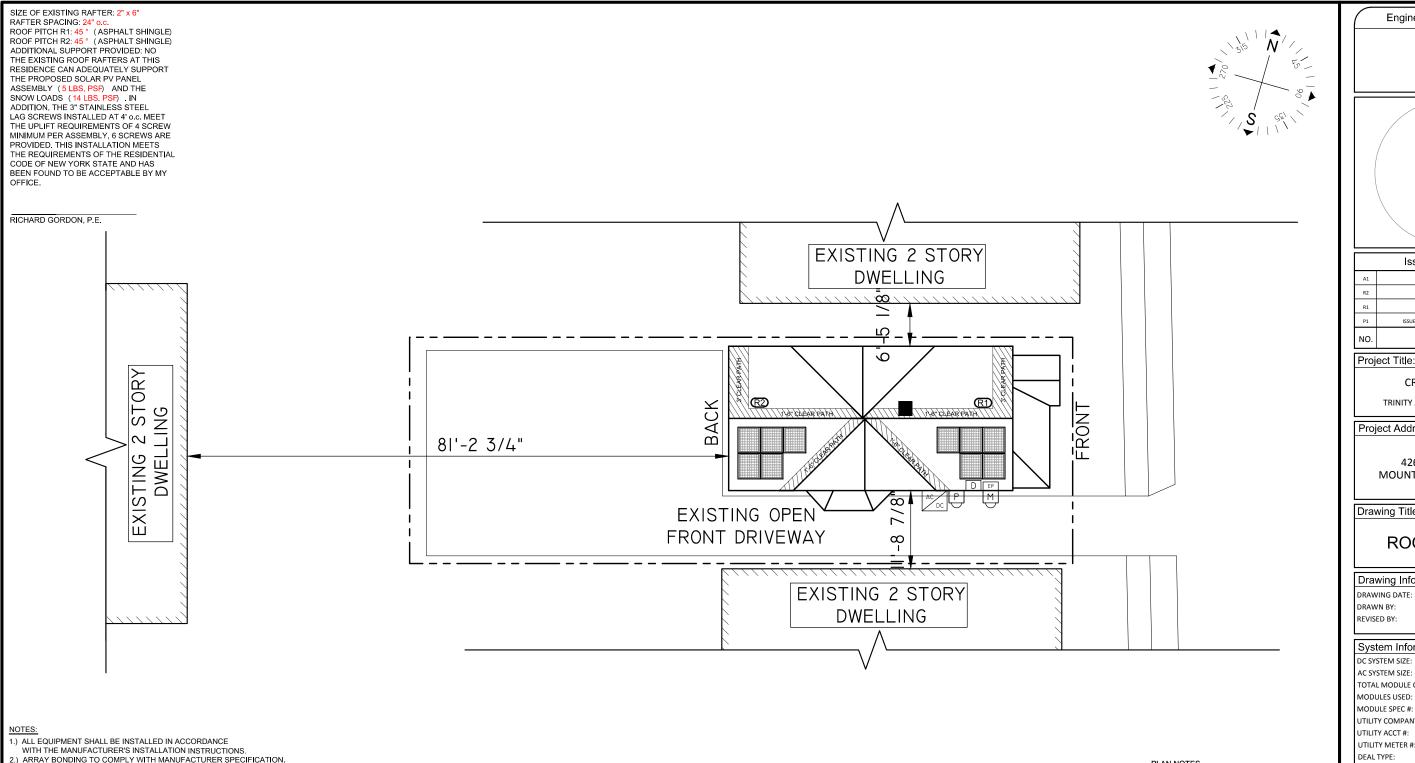

- 3.) ALL LOCATIONS ARE APPROXIMATE AND REQUIRE FIELD VERIFICATION.
- 4.) AN AC DISCONNECT SHALL BE GROUPED WITH INVERTER (S) NEC 690.13 (E) .
 5.) ALL OUTDOOR EQUIPMENT SHALL BE RAIN TIGHT WITH MINIMUM NEMA 3R RATING.
- 6.) OVERCURRENT PROTECTION FOR CONDUCTORS CONNECTED TO THE SUPPLY SIDE OF A SERVICE SHALL BE LOCATED WITHIN 10' OF THE POINT OF CONNECTION NEC 705.31.
- ROOFTOP SOLAR INSTALLATION ONLY PV ARRAY WILL NOT EXTEND BEYOND THE EXISTING BUILDING ENVELOPE.

PLAN NOTES

 SCOPE OF WOR INSTALLATION OF GENERATING STATES NOT TO BE REL

RK IS SOLEY FOR THE OF THE SOLAR ELECTRONIC SYSTEM. ALL OTHER WORK IS LIED UPON AS BEING ID/OR PERMITTED BY THE DOB	DWG



S-001.00

PAGE: 2 OF 7

Engineer / License Holder:

Issued / Revisions

MODULE TYPE CHANGE

MODULE TYPE CHANGE ISSUED TO TOWNSHIP FOR PERMIT DESCRIPTION

CROOKS, COSMO TRINITY ACCT #: 2016-11-106369

426 S 4TH AVENUE

MOUNT VERNON, NY 10550

ROOF LAYOUT

12/30/2016

JES

2.85kW

TRINA 285

CON EDISON

7756131

CASH

TSM-285 DD05A.05

5222 010 4960 4005

NO.

Project Address:

Drawing Title:

DRAWING DATE

DRAWN BY:

REVISED BY:

AC SYSTEM SIZE: TOTAL MODULE COUNT: MODULES USED:

MODULE SPEC #:

UTILITY ACCT #:

DEAL TYPE:

UTILITY COMPANY:

UTILITY METER #:

Drawing Information

System Information: DC SYSTEM SIZE:


DATE

2211 Allenwood Road Wall, New Jersey 07719

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ARRAY SCHEDULE	SYME	BOL LEGEND			P	LUMBING SCHEDULE	EQUIP	MENT SCHEDULE	
<u>R1</u>		INDICATES BOOF DESIGNATION REFER TO		INDICATES NEW UTILITY DISCONNECT TO BE			QTY	SPEC#	
ARRAY ORIENTATION = 164° MODULE PITCH = 45°		INDICATES ROOF DESIGNATION . REFER TO ARRAY SCHEDULE FOR MORE INFORMATION	UD	INSTALLED OUTSIDE			10	TRINA 285 (TSM-285 DD05A.05)	
R2 ARRAY ORIENTATION = 164° MODULE PITCH = 45°	M	INDICATES EXISTING METER LOCATION		INDICATES NEW PV SOLAR MODULE. RED MODULES INDICATE PANELS THAT USE MICRO INVERTERS. REFER TO EQUIPMENT SCHEDULE FOR SPECS.			1	SE3000A-US	
	EP	INDICATES EXISTING ELECTRICAL PANEL LOCATION: IN BASEMENT	P	INDICATES NEW PRODUCTION METER TO BE INSTALLED OUTSIDE.					
	D	INDICATES NEW MAIN DISCONNECT	DC AC	INDICATES NEW INVERTER TO BE INSTALLED OUTSIDE. REFER TO EQUIPMENT SCHEDULE FOR SPECS.					NYC DEPT OF BUILDING APPROVAL STAMP




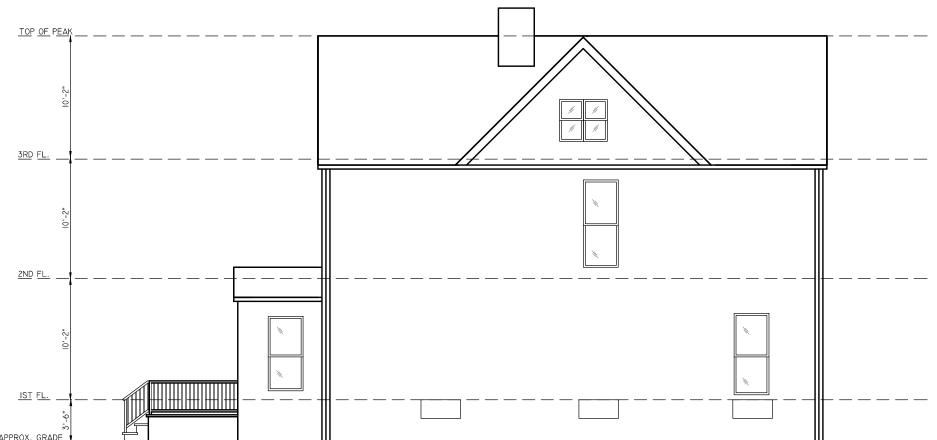

NORTH ELEVATION

SCALE: 1/8"=1'-0"

Engineer / License Holder:

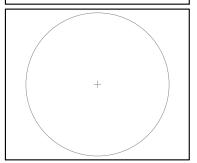

Issued / Revisions				
A1	AS BUILT	6/21/2017		
R2	MODULE TYPE CHANGE	2/16/2017		
R1	MODULE TYPE CHANGE	1/27/2017		
P1	ISSUED TO TOWNSHIP FOR PERMIT	12/30/2016		
NO.	DESCRIPTION	DATE		

Project Title:

CROOKS, COSMO

TRINITY ACCT #: 2016-11-106369

Project Address:

426 S 4TH AVENUE MOUNT VERNON, NY 10550

Drawing Title:

ELEVATION DRAWING

Drawing Informa	Drawing Information		
DRAWING DATE:	12/30/2016		
DRAWN BY:	1C		
REVISED BY:	JES		

System Information: DC SYSTEM SIZE: 2.85kW AC SYSTEM SIZE: TOTAL MODULE COUNT: MODULES USED: TRINA 285 MODULE SPEC #: TSM-285 DD05A.05 UTILITY COMPANY: CON EDISON UTILITY ACCT #: 5222 010 4960 4005 UTILITY METER #: 7756131 DEAL TYPE: CASH

DWG No.

S-002.00 PAGE: 3 OF 7






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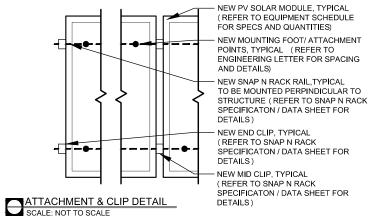
PLAN NOTES


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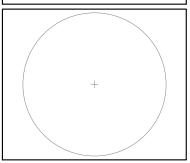
NOTES: *REFER TO MODULE SPECS FOR ACTUAL MODULE DIMENSIONS *DEPICTED MODULES MAY BE PORTRAIT OR LANDSCAPE





PV MODULE ATTACHMENT ON ASPHALT SHINGLE ROOF SCALE: NOT TO SCALE

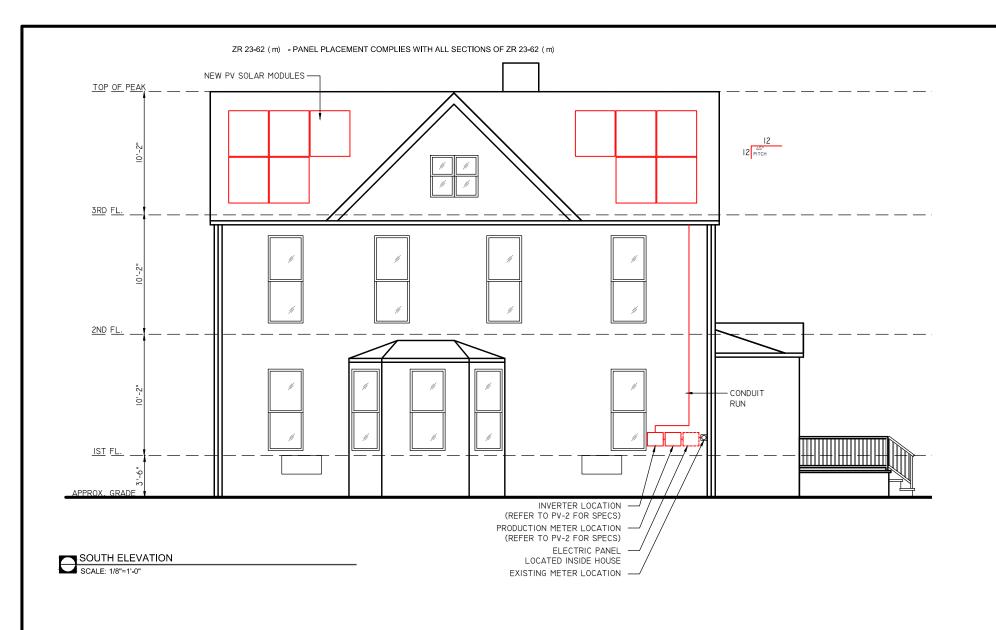Engineer / License Holder:

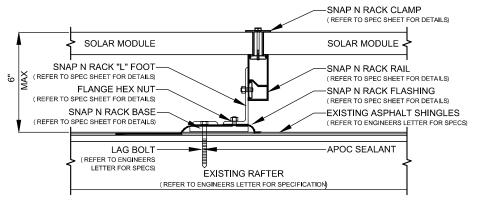

Issued / Revisions			
A1	AS BUILT	6/21/2017	
R2	MODULE TYPE CHANGE	2/16/2017	
R1	MODULE TYPE CHANGE	1/27/2017	
P1	ISSUED TO TOWNSHIP FOR PERMIT	12/30/2016	
NO.	DESCRIPTION	DATE	

Project Title:

CROOKS, COSMO

TRINITY ACCT #: 2016-11-106369

Project Address:

426 S 4TH AVENUE MOUNT VERNON, NY 10550

Drawing Title:

ELEVATION DRAWING

Drawing Information				
DRAWING DATE:	12/30/2016			
DRAWN BY:	JC			
REVISED BY:	JES			

System Information:					
DC SYSTEM SIZE:	2.85kW				
AC SYSTEM SIZE:	3kW				
TOTAL MODULE COUNT:	10				
MODULES USED:	TRINA 285				
MODULE SPEC #:	TSM-285 DD05A.05				
UTILITY COMPANY:	CON EDISON				
UTILITY ACCT #:	5222 010 4960 4005				
UTILITY METER #:	7756131				
DEAL TYPE:	CASH				

DWG No.

S-003.00 PAGE: 4 OF 7



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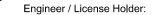
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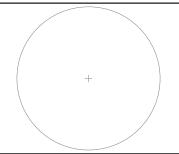
PLAN NOTES

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NYC DEPT OF BUILDING APPROVAL STAMP







Issued / Revisions			
A1	AS BUILT	6/21/2017	
R2	MODULE TYPE CHANGE	2/16/2017	
R1	MODULE TYPE CHANGE	1/27/2017	
P1	ISSUED TO TOWNSHIP FOR PERMIT	12/30/2016	
NO.	DESCRIPTION	DATE	

Project Title:

CROOKS, COSMO

TRINITY ACCT #: 2016-11-106369

Project Address:

426 S 4TH AVENUE MOUNT VERNON, NY 10550

Drawing Title:

TOPOGRAPHIC MAP

System Information:

DC SYSTEM SIZE: 2.85kW

AC SYSTEM SIZE: 3kW

TOTAL MODULE COUNT: 10

MODULES USED: TRINA 285

MODULE SPEC #: TSM-285 DD05A.05

UTILITY COMPANY: CON EDISON

UTILITY ACCT #: 5222 010 4960 4005

UTILITY METER #: 7756131

DEAL TYPE: CASH

DWG No.

S-004.00


PAGE: 5 OF 7



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	Issued / Revisions	
A1	AS BUILT	6/21/2017
R2	MODULE TYPE CHANGE	2/16/2017
R1	MODULE TYPE CHANGE	1/27/2017
P1	ISSUED TO TOWNSHIP FOR PERMIT	12/30/2016
NO.	DESCRIPTION	DATE

Project Title:

CROOKS, COSMO

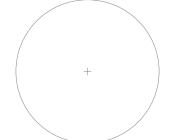TRINITY ACCT #: 2016-11-106369

Project Address:

426 S 4TH AVENUE MOUNT VERNON, NY 10550

Drawing Title:

FRONT OF HOUSE

Drawing Information		
DRAWING DATE:	12/30/2016	
DRAWN BY:	JC	
REVISED BY:	JES	

System Information:

DC SYSTEM SIZE: 2.85kW
AC SYSTEM SIZE: 3kW
TOTAL MODULE COUNT: 10
MODULES USED: TRINA 285
MODULE SPEC #: TSM-285 DD05A.05
UTILITY COMPANY: CON EDISON
UTILITY ACCT #: 5222 010 4960 4005
UTILITY METER #: 7756131
DEAL TYPE: CASH

DWG No.

S-005.00 PAGE: 6 OF 7



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ARRAY CIRCUIT WIRING NOTES 1.) LICENSED ELECTRICIAN ASSUMES ALL RESPONSIBILITY FOR DETERMINING ONSITE CONDITIONS AND EXECUTING INSTALLATION IN ACCORDANCE WITH NEC

2.) LOWEST EXPECTED AMBIENT TEMPERATURE BASED ON ASHRAE MINIMUM MEAN EXTREME DRY BULB TEMPERATURE FOR ASHRAE LOCATION MOST SIMILAR TO INSTALLATION LOCATION. LOWEST EXPECTED AMBIENT

3.) HIGHEST CONTINUOUS AMBIENT TEMPERATURE BASED ON ASHRAE HIGHEST MONTH 2% DRY BULB TEMPERATURE FOR ASHRAE LOCATION MOST SIMILAR TO INSTALLATION LOCATION. HIGHEST CONTINUOUS TEMP

4.) 2005 ASHRAE FUNDAMENTALS 2% DESIGN TEMPERATURES DO NOT EXCEED 47°C IN THE UNITED STATES (PALM SPRINGS, CA IS 44.1°C). FOR LESS THAN 9 CURRENT-CARRYING CONDUCTORS IN A ROOF-MOUNTED SUNLIT CONDUIT AT LEAST 0.5" ABOVE ROOF AND USING THE OUTDOOR DESIGN TEMPERATURE OF 47°C OR LESS (ALL OF UNITED STATES)

5.) PHOTOVOLTAIC POWER SYSTEMS SHALL BE PERMITTED TO OPERATE WITH UNGROUNDED PHOTOVOLTAIC SOURCE AND OUTPUT CIRCUIT AS PER NEC 690.35

6.) ALL EQUIPMENT INSTALLED OUTDOORS SHALL HAVE A **NEMA 3R** RATING

7.) ALL SOLAR SYSTEM LOAD CENTERS TO CONTAIN ONLY GENERATION CIRCUITS AND NO UNUSED POSITIONS OR

8.) PV SYSTEM CIRCUITS INSTALLED ON OR IN BUILDINGS SHALL INCLUDE A RAPID SHUTDOWN FUNCTION THAT CONTROLS SPECIFIC CONDUCTORS IN ACCORDANCE WITH NEC 690.12(1) THROUGH (5)

9.) ALL WIRE LENGTHS SHALL BE LESS THAN 100' UNLESS OTHERWISE NOTED

10.) ALL PV WIRE SHALL BE PROTECTED BY CONDUIT WHERE EXPOSED TO SUNLIGHT

11.) FLEXIBLE CONDUIT SHALL NOT BE INSTALLED ON ROOFTOP AND SHALL BE LIMITED TO 12" IF USED OUTDOORS

12.) WHERE TWO SOURCES FEED A BUSSBAR, ONE A UTILITY AND THE OTHER AN INVERTER, PV BACKFEED BREAKER(S) SHALL BE LOCATED OPPOSITE FROM UTILITY NEC 705.12(D)(2)(3)(b)

13.) UNGROUNDED DC CIRCUIT CONDUCTORS SHALL BE IDENTIFIED WITH THE FOLLOWING OUTER FINISH: POSITIVE CONDUCTORS = RED NEGATIVE CONDUCTORS = BLACK NEC 210.5(C)(2)

CALCULATIONS FOR CURRENT CARRYING CONDUCTORS
REQUIRED CONDUCTOR AMPACITY PER STRING [NEC 690.8(B)(1)]: (15.00*1.25)1 = 18.75A

AWG #10, DERATED AMPACITY AMBIENT TEMP: 33°C, TEMP DERATING FACTOR: .96 RACEWAY DERATING = 2 CCC: 1.00 (40*.96)1.00 = 38.40A

38.40A - 18.75A, THEREFORE WIRE SIZE IS VALID

TOTAL AC REQUIRED CONDUCTOR AMPACITY 12.50A*1.25 = 15.63A

AWG #10, DERATED AMPACITY AMBIENT TEMP: 30°C, TEMP DERATING: 1.0 RACEWAY DERATING < 3 CCC: N/A 40A*1.0 = 40A

40A - 15.63A, THEREFORE AC WIRE SIZE IS VALID

CALCULATION FOR PV OVERCURRENT PROTECTION TOTAL INVERTER CURRENT: 12.50A


12.50A*1.25 = 15.63A

--> 20A OVERCURRENT PROTECTION IS VALID

SOLAR MODULES MOUNTED TO ROOF ON 2 ARRAYS 10 - 285W MODULES W/ 1 SOLAR EDGE P300 PER MODULE 15 ADC MAX PER STRING

1 STRING OF 10 MODULES IN SERIES - 350 Vmax

*TERMINATED INSIDE INVERTER 1

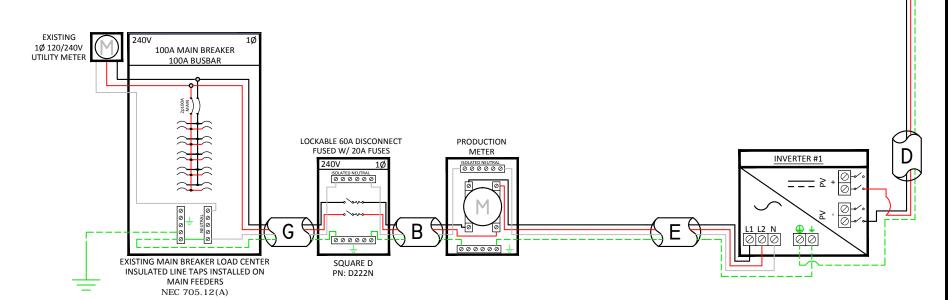

PV WIODULE SPECIFICATIONS	
TRINA 285 (TSM-285 DD05A.05)	
Imp	8.97
Vmp	31.8
Voc	39.3
Isc	9.45

DV MODI II E SDECIEICATIONS

	INVERTER #1	- SE3000A-US	
DC		AC	
Imp	8.14	Pout	3000
Vmp	350	Imax	12.5
Voc	500	OCPDmin	15.625
Isc	15	Vnom	240

FC 504.4.7 - ALL CONDUITS AND PIPING INSTALLATIONS SHALL BE COLOR-CODED WITH CONTINUOUS, DURABLE, AND WEATHERPROOF REFLECTIVE TO MEET OR EXCEED NEC AND LOCAL AHID REQUIREMENTS OR LUMINESCENT MARKINGS AS FOLLOWS, AND FOR CONDUIT AND PIPING INSTALLED AFTER JULY 1, 2014, SHALL BE CONTINUOUSLY LABELED IN AN APPROVED MANNER TO INDICATES ITS CONTENTS:

HIGH VOLTAGE WIRING - RED
 LOW VOLTAGE WIRING - ORANGE

3. NATURAL GAS PIPING - YELLOW

(F)

JUNCTION

BOX

FC 512.4.2 - INDOOR AND OUTDOOR DIRECT CURRENT CONDUIT, ENCLOSURE, RACEWAYS, CABLE ASSEMBLIES, JUNCTION BOXES, COMBINER BOXES, AND MAIN SERVICE AND OTHER DISCONNECTS SHALL HAVE DURABLE, RETOREFLECTIVE, AND, IF OUTDOORS, WEATHERPROOF MARKINGS, IN WHITE CAPITAL LETTERS WITH A HEIGHT OF NOT LESS THAN \$ INCH (9.5 MM) ON A RED BACKGROUND, READING "WARNING: PHOTOVOLTAIC POWER SOURCE."

	Α	#6 THWN-2 GEC TO EXISTING GROUND ROD	
	В	3/4" CONDUIT W/ 3-#10 THWN-2, 1-#10 THWN-2 GROUND	
	С	3/4" CONDUIT W/ 2-#10 THWN-2, 1-#10 THWN-2 GROUND	
	D	3/4" CONDUIT W/ 2-#10 THWN-2, 1-#10 THWN-2 GROUND	
ss	E	3/4" CONDUIT W/ 3-#10 THWN-2, 1-#10 THWN-2 GROUND	
	F	#10 PV WIRE (FREE AIR) W/ #6 BARE COPPER BOND TO ARRAY	
	G	3/4" CONDUIT W/ 3-#6 THWN-2, 1-#8 THWN-2 GROUND	
			٠.

PLAN NOTES

 SCOPE OF WORK IS SOLEY FOR THE
 INSTALLATION OF THE SOLAR ELECTRONIC GENERATING SYSTEM. ALL OTHER WORK IS NOT TO BE RELIED UPON AS BEING

DWG No. APPROVED AND/OR PERMITTED BY THE DOE



E-001.00

PAGE: 7 OF 7

2211 Allenwood Road Wall, New Jersey 07719 www.Trinity-Solar.com

NYC DEPT OF BUILDING APPROVAL STAMP

Engineer / License Holder:

	Issued / Revisions	
A1	AS BUILT	6/21/2017
R2	MODULE TYPE CHANGE	2/16/2017
R1	MODULE TYPE CHANGE	1/27/2017
P1	ISSUED TO TOWNSHIP FOR PERMIT	12/30/2016
NO.	DESCRIPTION	DATE

Project Title:

CROOKS, COSMO

TRINITY ACCT #: 2016-11-106369

Project Address:

426 S 4TH AVENUE MOUNT VERNON, NY 10550

Drawing Title:

ELECTRICAL 3-LINE DRAWING

Drawing Information		
DRAWING DATE:	12/30/2016	
DRAWN BY:	JC	
REVISED BY:	JES	

System Information:			
DC SYSTEM SIZE:	2.85kW		
AC SYSTEM SIZE:	3kW		
TOTAL MODULE COUNT:	10		
MODULES USED:	TRINA 285		
MODULE SPEC #:	TSM-285 DD05A.05		
UTILITY COMPANY:	CON EDISON		
UTILITY ACCT #:	5222 010 4960 4005		
UTILITY METER #:	7756131		
DEAL TYPE:	CASH		