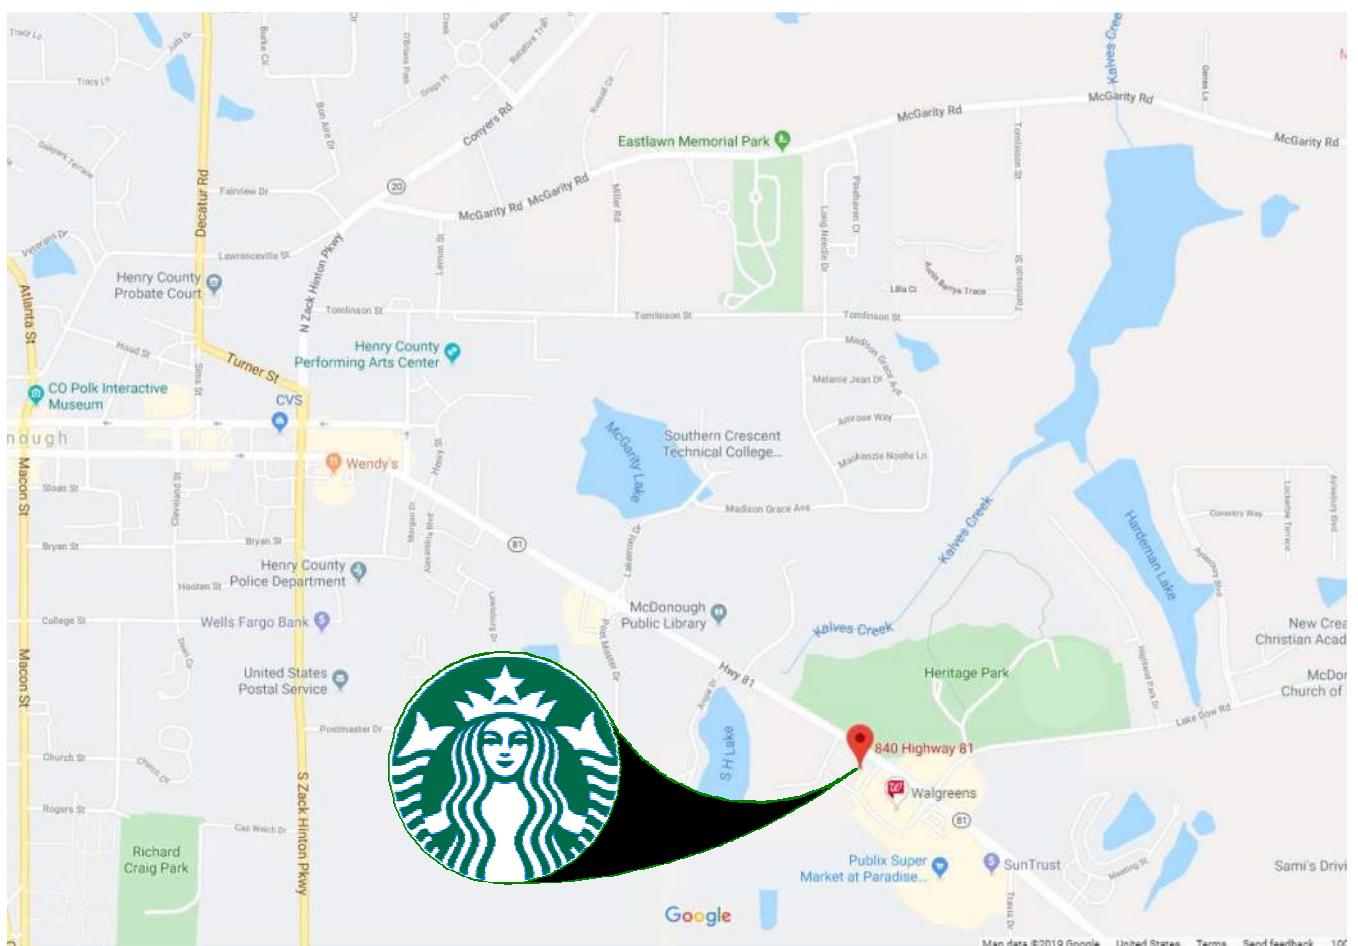
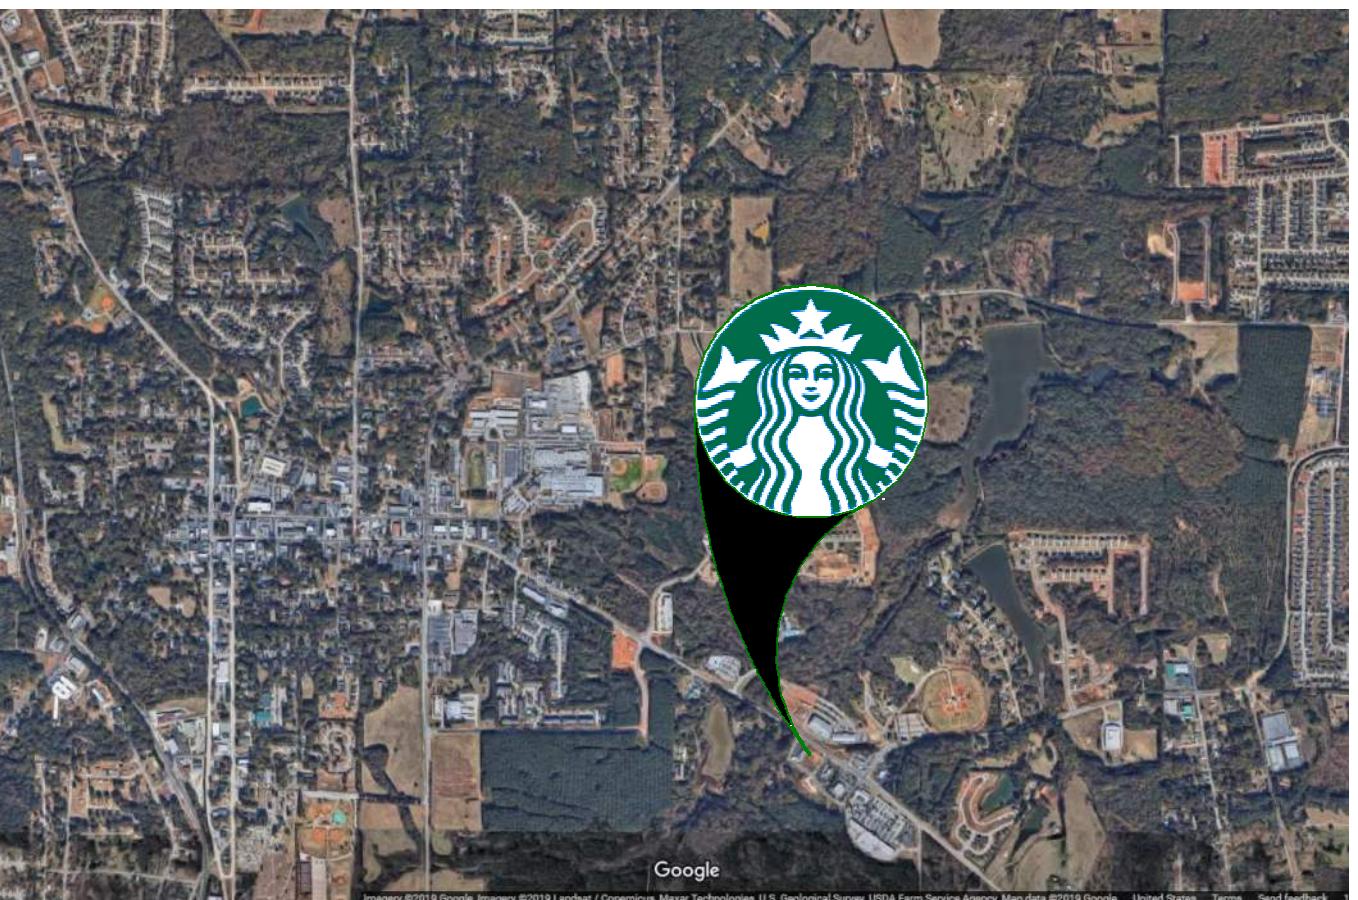
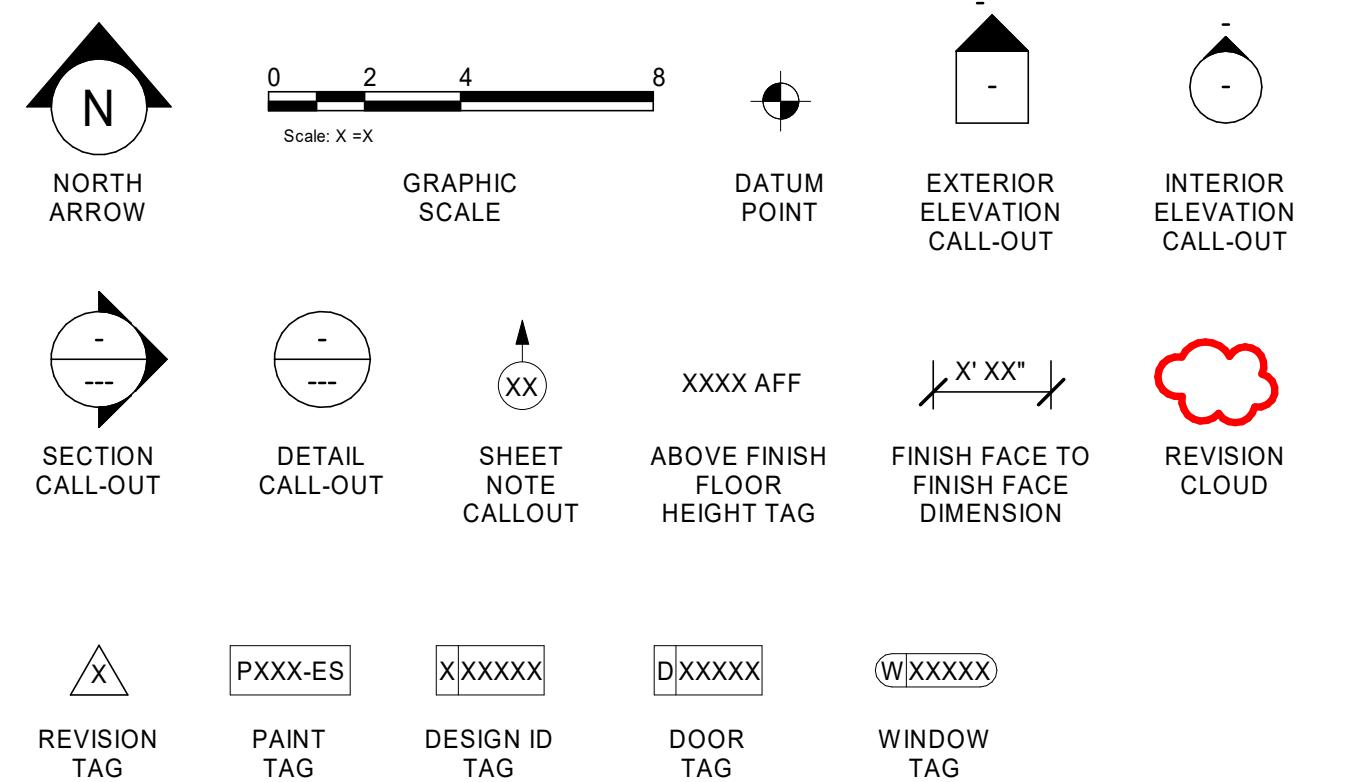


ABBREVIATIONS

A/C	AIR CONDITIONING
ACT	ACOUSTICAL CEILING TILE
ADJ	ADJUSTABLE
AFF	ABOVE FINISHED FLOOR
AMP	AMPERE
ARCH	ARCHITECT
BOH	BACK OF HOUSE
CAB	CABINET
CL	CENTER LINE
CLG	CEILING
CM	STARBUCKS
CTR	CONSTRUCTION MANAGER
CX	CENTER
CXA	COMMISSIONING
DEG	DEGREE
DET	DETAIL
DIA	DIAMETER
DIM	DIMENSION
DM	STARBUCKS
DN	DESIGN MANAGER
EA	EACH
EL	ELEVATION
EQ	EQUAL
EXIST	EXISTING
EXT	EXTERIOR
FF&E	FURNITURE, FIXTURE, AND EQUIPMENT
FLR	FLOOR
FOH	FRONT OF HOUSE
FOIC	FURNISHED BY OWNER, INSTALLED BY CONTRACTOR
FOIO	FURNISHED BY OWNER INSTALLED BY OWNER
FT	FOOT/FEET
G	GROUND
GC	GENERAL CONTRACTOR
GWB	GYPSUM WALLBOARD
HC	HOLLOW CORE
HDW	HARDWARE
HM	HOLLOW METAL
HORIZ	HORIZONTAL
HR	HOUR
HT	HEIGHT
HVAC	HEATING, VENTILATING AND AIR CONDITIONING
I.D.	INSIDE DIAMETER
LEED	LEADERSHIP IN ENERGY AND ENVIRONMENTAL DESIGN
LL	LANDLORD
LV	LOW VOLTAGE
MAX	MAXIMUM
MEP	MECHANICAL, ELECTRICAL AND PLUMBING
MFR	MANUFACTURER
MIN	MINIMUM
NIC	NOT IN CONTRACT
NLT	NIGHT LIGHT
NTS	NOT TO SCALE
OC	ON CENTER
O.D.	OUTSIDE DIAMETER
PLC	PLACE
R	RADIUS
REF	REFERENCE
REQD	REQUIRED
REV	REVISION
RND	ROUND
SB	STARBUCKS
SC	SOLID CORE
SF	SQUARE FEET
SHT	SHEET
SIM	SIMILAR
SPEC	SPECIFICATION
SQ	SQUARE
TEMP	TEMPORARY
TYP	TYPICAL
UC	UNDER COUNTER
UNO	UNLESS NOTED OTHERWISE
VERT	VERTICAL
VIF	VERIFY IN FIELD

RESPONSIBILITY LEGEND

GC	GENERAL CONTRACTOR
LL	LANDLORD
SB	STARBUCKS

VICINITY PLAN**AERIAL MAP****ARCHITECTURAL SYMBOL LEGEND****PROJECT CONTACTS**

MAILING ADDRESS:	STARBUCKS COFFEE COMPANY 2401 UTAH AVENUE SOUTH MS STOP: S-SD10 SEATTLE, WASHINGTON 98134 (206) 318-1575
DESIGN MANAGER:	ROMINA VIGNOLO STARBUCKS COFFEE COMPANY 95 MERRICK WAY, SUITE 650 CORAL GABLES, FL 33134 (305) 529-5359
CONSTRUCTION MANAGER:	LARRY WESTHOLM STARBUCKS COFFEE COMPANY 2987 CLAIRMONT ROAD #300 ATLANTA, GA 30329
LANDLORD:	MERG HOFFMAN MERGANZER ENTERPRISES, INC 4402 GILMORE ROAD SE SMYRNA, GA 30080 (770) 778-8793
ARCHITECT OF RECORD:	GPD GROUP, PROFESSIONAL CORPORATION 520 S. MAIN STREET, SUITE 2531 AKRON, OH 44311 (330) 572-3561
MEP CONSULTANT OF RECORD:	GPD GROUP, PROFESSIONAL CORPORATION 520 S. MAIN STREET, SUITE 2531 AKRON, OH 44311 (330) 572-3561
STRUCTURAL CONSULTANT:	GPD GROUP, PROFESSIONAL CORPORATION 520 S. MAIN STREET, SUITE 2531 AKRON, OH 44311 (330) 572-3561

SCOPE OF WORK

INTERIOR TENANT IMPROVEMENT OF EXISTING STANDALONE SHELL BUILDING W/ DRIVE THRU.

SCOPE OF WORK TO INCLUDE PARTITIONS, FINISHES, FURNITURE, FIXTURES, EQUIPMENT, CASEWORK, LIGHTING, ETC.

SIGNAGE UNDER SEPARATE PERMIT BY OTHERS.

GENERAL NOTES

- THE DRAWINGS AND PROJECT MANUAL TOGETHER CONSTITUTE THE CONTRACT DOCUMENTS FOR CONSTRUCTION. ALL GENERAL REQUIREMENTS ARE TO BE MET AND ALL MATERIALS, FINISHES AND SYSTEMS ARE TO BE INSTALLED AND PERFORM PER SPECIFICATIONS UNLESS OTHERWISE NOTED.
- GENERAL CONTRACTOR SHALL VISIT THE SITE, REVIEW THE BUILDING SHELL DRAWINGS AS SUBMITTED BY THE LANDLORD OR STARBUCKS AND BECOME THOROUGHLY FAMILIAR WITH THE SITE CONDITIONS PRIOR TO CONSTRUCTION.
- GENERAL CONTRACTOR SHALL CONSULT WITH STARBUCKS CONSTRUCTION MANAGER TO RESOLVE ANY CHANGES, OMISSIONS OR PLAN DISCREPANCIES PRIOR TO CONSTRUCTION.
- ALL WORK SHALL BE PERFORMED IN STRICT COMPLIANCE WITH LOCAL, COUNTY, STATE AND FEDERAL CODES AND ORDINANCES.
- GENERAL CONTRACTOR SHALL VERIFY THE LOCATION OF ALL UTILITIES.
- GENERAL CONTRACTOR TO VERIFY ALL DIMENSIONS, INCLUDING CLEARANCES REQUIRED BY OTHER TRADES AND NOTIFY STARBUCKS CONSTRUCTION MANAGER OF ANY DISCREPANCIES PRIOR TO PROCEEDING WITH THE WORK. ALL DIMENSIONS ARE TO THE FACE OF THE FINISHED SURFACE UNLESS NOTED OTHERWISE. ALL DIMENSIONS TO BE TAKEN FROM DESIGNATED DATUM POINT. DO NOT SCALE DRAWINGS.
- GENERAL CONTRACTOR SHALL PATCH AND REPAIR ALL EXISTING WALLS, FLOORS, CEILINGS, OR OTHER SURFACES IDENTIFIED TO REMAIN THAT MAY BECOME DAMAGED DURING THE COURSE OF THE WORK.
- THE GENERAL CONTRACTOR IS RESPONSIBLE FOR OBTAINING PERMITS FOR FIRE PROTECTION, PLUMBING, MECHANICAL, AND ELECTRICAL SYSTEMS PRIOR TO INSTALLATION OF SUCH SYSTEMS.
- GENERAL CONTRACTOR SHALL RETAIN ONE SET OF PERMIT PLANS ON-SITE TO DOCUMENT ALL CHANGES MADE DURING CONSTRUCTION. THE RECORD DRAWINGS SHALL BE ISSUED TO THE OWNER AT PROJECT CLOSE-OUT AS DESCRIBED IN THE GENERAL REQUIREMENTS OF THE PROJECT MANUAL.
- GENERAL CONTRACTOR IS RESPONSIBLE FOR COORDINATING DELIVERY OF MATERIALS FROM STARBUCKS CONTRACTED THIRD PARTY LOGISTICS DISTRIBUTION SERVICES AND VENDOR DIRECT SHIPMENTS. SEE THE PROJECT MANUAL FOR ADDITIONAL INFORMATION.
- RESPONSIBILITY FOR SUPPLY AND DELIVERY OF MATERIALS AND EQUIPMENT IS IDENTIFIED IN THE DRAWING SCHEDULE SHEETS UNDER THE COLUMN LABELED "RESPONSIBILITY".
- FOR THE PURPOSE OF THE DOCUMENTS, TO "INSTALL" SHALL MEAN TO PROVIDE ALL FASTENERS, MISCELLANEOUS HARDWARE, BLOCKING, ELECTRICAL CONNECTIONS, PLUMBING CONNECTIONS AND OTHER ITEMS REQUIRED FOR A COMPLETE AND OPERATIONAL INSTALLATION, UNLESS OTHERWISE NOTED.
- ALL ITEM SUBSTITUTIONS MUST BE APPROVED BY THE STARBUCKS CONSTRUCTION MANAGER.

INDEX OF SHEETS

LEGEND:	
X - SHEET ISSUED	
R - SHEET ISSUED FOR REFERENCE AND COORDINATION ONLY	
SEE TITLEBLOCK FOR REVISION ISSUE DATE(S)	
SHEET	SHEET TITLE
BID SET	
PERMIT SET	
REVISION 1	
REVISION 2	
REVISION 3	
REVISION 4	




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STARBUCKS TEMPLATE VERSION: I2019-07-26

GPD GROUP
Professional Corporation
520 SOUTH MAIN ST, SUITE 2531
AKRON, OH 44311
P: 330-572-2100 F: 330-572-2101
GPD PROJECT NO: 2019261.12



PROJECT NAME:
HWY 81 & LAKE DOW

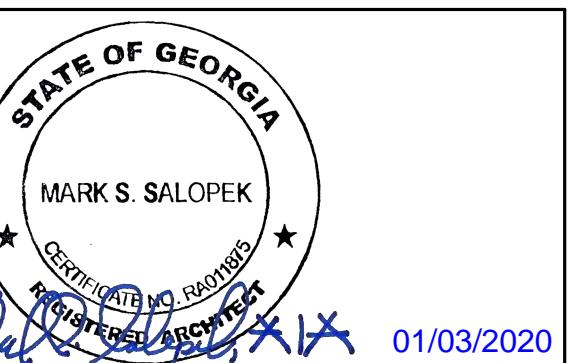PROJECT ADDRESS:
850 HWY 81
MCDONOUGH, GA 30252

STORE #: 59695
PROJECT #: 85535-001
ISSUE DATE: 12/03/2019
DESIGN MANAGER: RV
PRODUCTION DESIGNER: TW
CHECKED BY: GPD GROUP

Revision Schedule			
Rev	Date	By	Description

SHEET TITLE:
GENERAL INFORMATION

SCALE: AS SHOWN

SHEET NUMBER:
G001



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Revision Schedule

Rev	Date	By	Description

SHEET TITLE:
**LIFE SAFETY AND
ACCESSIBILITY PLAN**
SCALE: AS SHOWN

SHEET NUMBER:
G003

EGRESS CALCULATION	
EXIT WIDTH REQUIRED - 66 OCC X .15	= 9.9 IN.
EXIT WIDTH PROVIDED	= 108 IN.
EXITS	= 72 IN. PRIMARY ENTRY, 36 IN. SECONDARY ENTRY, 42 IN. WORKROOM
# EXITS REQUIRED	= 02
# EXITS PROVIDED	= 03
MAXIMUM ALLOWABLE TRAVEL DISTANCE	= 39 FT.
MAXIMUM TRAVEL DISTANCE PROVIDED	= 22 FT.
MINIMUM EXIT SEPARATION	= 7' - 10" (MAXIMUM DIAGONAL) / 2 = 39' - 0"
EXIT SEPARATION PROVIDED	= 20' - 9"

INDOOR SEATING			
TYPE	DESCRIPTION	NUMBER OF ITEMS	TOTAL SEATS
18064 SEAT	TABLE TOP, SQUARE	04	08
18319 SEAT	TABLE TOP, ROUND	04	04
18064 SEAT	COMMUNITY TABLE (ADA)	01	10
18787 SEAT	BANQUETTE (BENCH) SEATING	02	04
18130 + 17611 SEAT	LOUNGE SEATING	06	08

OUTDOOR SEATING			
TYPE	DESCRIPTION	NUMBER OF ITEMS	TOTAL SEATS
17852 SEAT	TABLE TOP, SQUARE (ADA)	1	02
17852 SEAT	TABLE TOP, SQUARE	06	12
18474 SEAT	LOUNGE SEATING	04	04

PLUMBING FIXTURE CALCULATION

CHAPTER 29-29023 (FOR REFERENCE ONLY)

OCCUPANCY	MALE	FEMALE	TOTAL	WATERCLOSETS	URINALS	LAVATORIES	WATER FOUNTAIN
	33 OCC	33 OCC	66 OCC				
FIXTURES	ADD EQUATION PER AHJ	N/A	ADD EQUATION PER AHJ	ADD EQUATION PER AHJ	N/A	1 LAV PER M	1 LAV PER F
REQUIRED:	1 WC PER M	1 WC PER F			N/A	1 LAV PER M	1 LAV PER F
PROVIDED:	1 WC PER M	1 WC PER F			N/A	1 LAV PER M	1 LAV PER F


OCCUPANCY NOTES

OCCUPANCY CLASSIFICATION: A-2

TOTAL OCCUPANTS: 66

OCCUPANCY	
CAFE: 900 SQ. FT. / 15 SQ. FT. / OCC	60 OCC
BACKBAR: 407 SQ. FT. / 200 SQ. FT. / OCC	03 OCC
WORKROOM: 485 SQ. FT. / 300 SQ. FT. / OCC	02 OCC
UNOCCUPIED: 165 SQ. FT. / 300 SQ. FT. / OCC	01 OCC
TOTAL OCC LOAD:	66 OCC

LEGEND

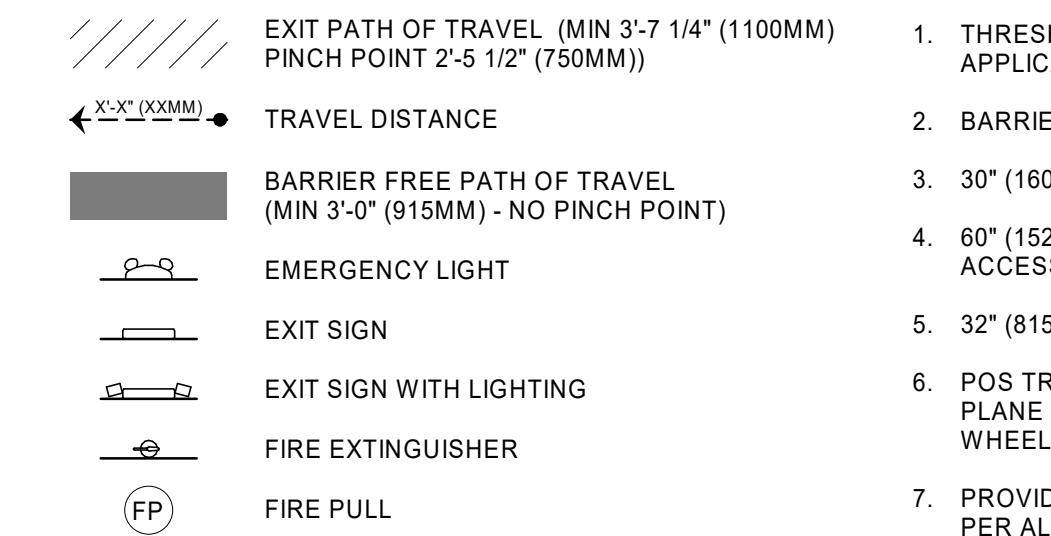

ROOM SCHEDULE


NAME	AREA
BACKBAR	407 SF
CAFE	900 SF
MEN'S RESTROOM	49 SF
RESTROOM VESTIBULE	68 SF
WOMEN'S RESTROOM	49 SF
WORKROOM	485 SF
GRAND TOTAL	1958 SF

KEYED NOTES

1. THRESHOLDS TO BE BARRIER FREE COMPLIANT PER ALL APPLICABLE CODES
2. BARRIER-FREE PATH OF TRAVEL.
3. 30" (160 MM) X 48" (1220 MM) CLEAR FOR WHEELCHAIR ACCESS.
4. 60" (1525 MM) DIAMETER MINIMUM TURN RADIUS FOR WHEELCHAIR ACCESS.
5. 32" (815 MM) MINIMUM CLEAR AT RESTROOM DOOR.
6. POS TRANSACTION PLANE, CONDIMENTS CART TOP AND HAND-OFF PLANE ARE 34 INCHES (860 MM) ABOVE THE FINISHED FLOOR FOR WHEELCHAIR ACCESSIBILITY.
7. PROVIDE BARRIER-FREE SIGNAGE AT ACCESSIBLE RESTROOMS PER ALL APPLICABLE CODES.
8. PROVIDE TACTILE "EXIT" SIGNAGE.
9. PROVIDE INTERNATIONAL SYMBOL OF ACCESSIBILITY SIGN WHERE REQUIRED BY APPLICABLE LAWS OR CODES.

MEANS OF EGRESS NOTES


- A. EVERY ROOM OR SPACE THAT IS ASSEMBLY OCCUPANCY SHALL HAVE THE OCCUPANT LOAD OF THE ROOM OR SPACE POSTED IN A CONSPICUOUS PLACE, NEAR THE MAIN EXIT ACCESS DOORWAY. POSTED SIGNS SHALL BE OF AN APPROVED LEGIBLE PERMANENT DESIGN AND SHALL BE MAINTAINED BY THE OWNER AUTHORIZED AGENT. (1004.3)
- B. EGRESS SHALL NOT PASS THROUGH KITCHENS, STORAGE ROOMS, CLOSETS OR SIMILAR SPACES. (1014.2)
- C. PANIC AND FIRE EXIT HARDWARE, WHERE INSTALLED ON DOORS IN THIS BUILDING SHALL SATISFY THE FOLLOWING (1008.1.10):
 - 1) THE ACTUATION PORTION OF THE RELEASING DEVICE SHALL EXTEND AT LEAST ONE-HALF OF THE DOOR LEAF WIDTH.
 - 2) THE MAXIMUM UNLATCHING FORCE DOES NOT EXCEED 15 POUNDS (6.8 KG).
 - 3) PIVOTED OR BALANCED DOORS SHALL BE OF THE PUSH-PAD TYPE WHERE PANIC HARDWARE IS REQUIRED AND THE PAD SHALL NOT EXTEND ACROSS MORE THAN ONE-HALF OF THE DOOR WIDTH, MEASURED FROM THE LATCH SIDE.
 - 4) PANIC HARDWARE LISTED IN ACCORDANCE WITH UL 305.
 - 5) FIRE EXIT HARDWARE LISTED IN ACCORDANCE WITH UL 10C AND UL 305.
- D. STRUCTURAL ELEMENTS, FIXTURES OR FURNISHINGS SHALL NOT PROJECT HORIZONTALLY FROM EITHER SIDE MORE THAN 4 INCHES (100 MM) OVER ANY WALKING SURFACE BETWEEN 27 INCHES (685 MM) AND 80 INCHES (2030 MM) ABOVE THE WALKING SURFACE. EXCEPTION: HANDRAILS SERVING STAIRS AND RAMPS ARE PERMITTED TO PROTRUDE 4 1/2 INCHES (115 MM) FROM THE WALL. (1003.3)
- E. THE PATH OF EGRESS TRAVEL EXITS AND WITHIN EXITS IN THIS BUILDING SHALL BE IDENTIFIED BY EXIT SIGNS CONFORMING TO THE REQUIREMENTS OF SECTION 1011 AND AS NOTED BELOW:
 - 1) EXIT SIGNS SHALL BE READILY VISIBLE FROM ANY DIRECTION OF EGRESS TRAVEL.
 - 2) EXIT SIGNS SHALL BE LOCATED AS NECESSARY TO CLEARLY INDICATE THE DIRECTION OF EGRESS TRAVEL.
 - 3) NO POINT IN A CORRIDOR SHALL BE MORE THAN 100 FT (30.5 M) OR THE LISTED VIEWING DISTANCE FOR THE SIGN, WHICHEVER IS LESS, FROM THE NEAREST VISIBLE EXIT SIGN.
 - 4) WHERE KEY OPERATED LOCKING DEVICES ARE USED, POST A SIGN ON OR ADJACENT TO THE REQUIRED MAIN EXIT DOOR WITH 1 INCH (25 MM) LETTERING STATING THAT "THIS DOOR TO REMAIN UNLOCKED WHEN BUILDING IS OCCUPIED". (1008.1.9)
 - 5) EGRESS DOORS OR GATES SHALL BE OPENABLE FROM THE EGFRSS SIDE WITHOUT THE USE OF A KEY, SPECIAL KNOWLEDGE OR EFFORT. DOOR HANDLES, PULLS, LATCHES, LOCKS AND OTHER OPERATING DEVICES SHALL BE INSTALLED 42 INCHES (860 MM) TO 48 INCHES (1220 MM) ABOVE THE FINISHED DOOR. MANUALLY OPERATED FLUSH BOLTS OR SURFACE BOLTS ARE NOT PERMITTED. THE UNLATCHING OF ANY DOOR OR LEAF SHALL NOT REQUIRE MORE THAN ONE OPERATION. (1008.1.9)
 - 6) LANDINGS SHALL BE PROVIDED ON EACH SIDE OF DOORS AND SUCH LANDING SHALL BE AT THE SAME ELEVATION ON EACH SIDE OF THE DOOR. LANDINGS SHALL HAVE A WIDTH NOT LESS THAN THE WIDTH OF THE DOOR AND LENGTH MEASURED IN THE DIRECTION OF TRAVEL OF NOT LESS THAN 44 INCHES (1110 MM). (1008.1.5, 1008.1.6)

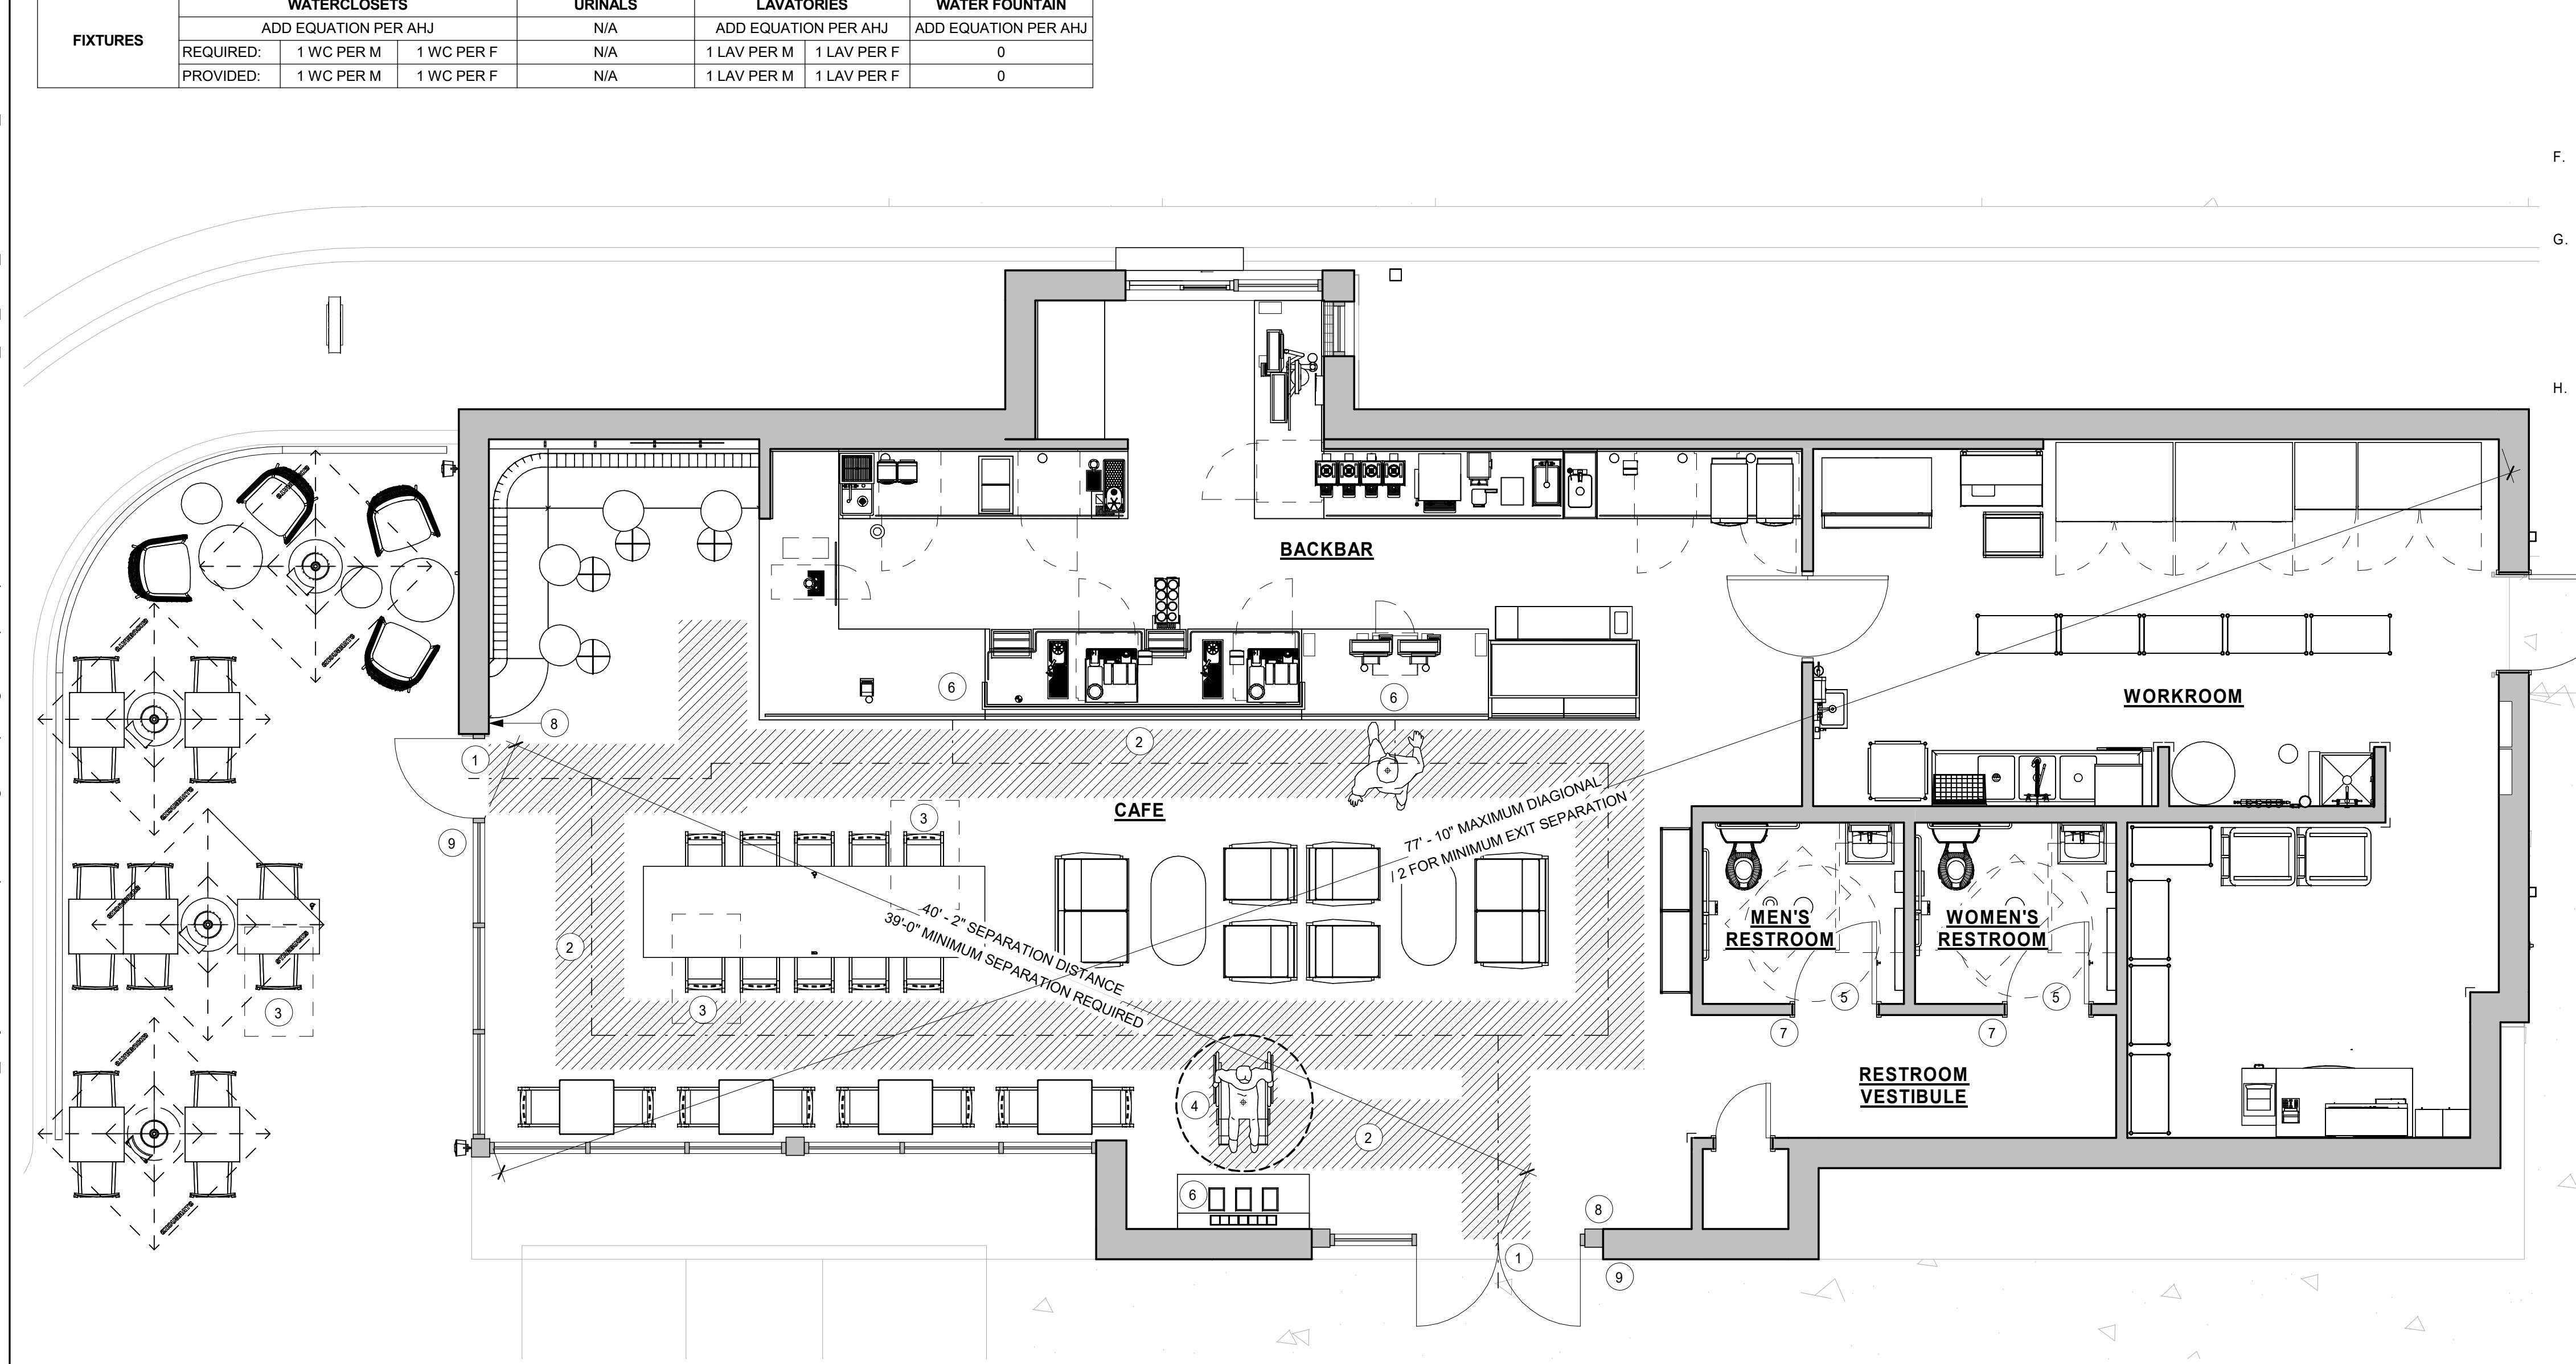

SITE SCHEDULE - "Y"					
DESIGN ID	COUNT	DESCRIPTION	FURN. BY	INST. BY	COMMENTS
EXTERIOR MENU					
14116	1	MENU BOARD - DT DIGITAL ORDER SCREEN - FLAT BLACK MT0028	SB	GC	
14118	1	MENU BOARD - DT 3 PANEL FREESTANDING - 72X65IN 1830X1650MM - FLAT BLACK MT0028	SB	GC	
14120	1	MENU BOARD - DT PRE MENU FREESTANDING - 36X65IN 915X1650MM - FLAT BLACK MT0028	SB	GC	
15700	1	MENU BOARD - DT DIGITAL ORDER SCREEN CONTROL BOX	SB	GC	
OTHER					
10042	2	BIKE RACK HOOP	LL	LL	
10163	1	DT WINDOW SHELF - 56IN 1420MM - OBSIDIAN PAPERSTONE	SB	GC	
14095	1	DT WAYFINDING GRAPHIC EXIT ARROW - WHITE	LL	LL	
14101	1	DT WAYFINDING GRAPHIC ENTRY ARROW - GREEN	LL	LL	
14103	3	BOLLARD NONILLUMINATED SQUARE - FLAT BLACK MT0028	LL	LL	
14163	1	DT ORDER POINT CANOPY FREESTANDING - FLAT BLACK MT0028	SB	GC	
14323	4	DT WAYFINDING GRAPHIC DIRECTIONAL DOUBLE ARROW - GREEN	LL	GC	REFERENCE PAINT 20512 FOR SPECIFICATIONS
14324	6	DT WAYFINDING GRAPHIC DIRECTIONAL DOUBLE ARROW - WHITE	LL	GC	REFERENCE PAINT 20511 FOR SPECIFICATIONS
UMBRELLA					
12147	4	UMBRELLA - BASE 95LB 43KG - FLAT BLACK MT0028	SB	GC	
20073	4	UMBRELLA - WITHOUT VALANCE - 6FT 183CM - GREEN CANVAS WITH WORDMARK F0056	SB	GC	

EXTERIOR SIGNAGE SCHEDULE - "S"					
DESIGN ID	COUNT	DESCRIPTION	FURN. BY	INST. BY	COMMENTS
SIGNAGE - DISK					
13164	2	SIGN - DISK SF ILLUMINATED FLUSH MOUNTED EVOLVED - 60IN 1525MM	SB	GC	
SIGNAGE - DRIVE THRU					
14091	1	SIGN - DT DIRECTIONAL EXIT SIGN ILLUMINATED ARROW SERIES - 46IN 1170MM	SB	GC	
14099	1	SIGN - DRIVE THRU ILLUMINATED ARROW SERIES FLUSH MOUNTED - RH - 48IN 1220MM	SB	GC	
14106	1	SIGN - DT CLEARANCE BAR ARROW SERIES FREESTANDING	SB	GC	
14327	3	SIGN - DT DIRECTIONAL ILLUMINATED ARROW SERIES - 46IN 1170MM	SB	GC	
18497	1	SIGN - WORDMARK STARBUCKS FLUSH MOUNTED - 18IN 455MM	SB	GC	WHITE LETTERS
SIGNAGE - WORDMARK					

LEGEND

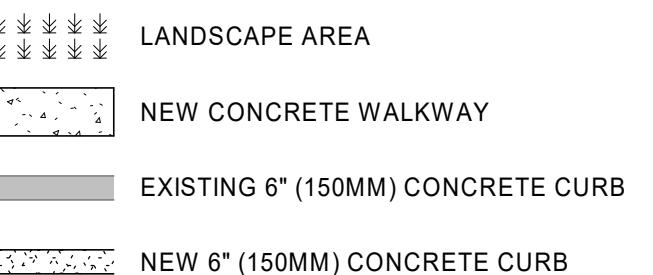

GENERAL NOTES

- A. REFER TO EXTERIOR ELEVATIONS ON SHEET A201 FOR BUILDING SIGNAGE LOCATION AND DESIGN ID. REFER TO ELECTRICAL PLANS FOR ELECTRICAL REQUIREMENTS.
- B. LANDSCAPING TO BE PROVIDED PER ZONING CODE AND SUSTAINABILITY REQUIREMENTS.
- C. DRIVE-THRU EQUIPMENT INCLUDING VEHICLE DETECTION LOOP, WIRELESS COMMUNICATION AND MONITORS SHALL BE COORDINATED BY STARBUCKS CONSTRUCTION MANAGER. REFER TO ELECTRICAL DRAWINGS FOR ADDITIONAL REQUIREMENTS.
- D. PROVIDE 6" (150MM) THICK CONCRETE PAVING THE LENGTH OF THE DRIVE-THRU LANE, EXTENT TO INCLUDE DRIVE-THRU ENTRY POINT THROUGH WINDOW STANDING PAD.
- E. GENERAL CONTRACTOR TO APPLY CONCRETE SEALER TO ALL EXTERIOR CONCRETE PATIO AND WALKWAY SURFACES.
- F. GENERAL CONTRACTOR TO VERIFY ALL EXISTING ELEVATIONS AND BUILDING CONDITIONS IN FIELD PRIOR TO START OF CONSTRUCTION.
- G. PROVIDE DETECTABLE WARNING (IF APPLICABLE PER LOCAL CODE) AT TRANSITION FROM SIDEWALK TO DRIVE AISLE.
- H. ACCESSIBLE PARKING SPACES AND ACCESS AISLES SHALL HAVE SURFACE SLOPE NOT TO EXCEED 2% IN ALL DIRECTIONS.
- I. REFER TO ELECTRICAL DRAWINGS FOR SITE RELATED ELECTRICAL WORK.
- J. SCRAPE AND REPAINT ALL EXISTING PAINTED SITE FEATURES, INCLUDING, BUT NOT LIMITED TO CURBS, BOLLARDS, RAILINGS AND SITE LIGHTING BASES.
- K. SEE SHEET A002 FOR ARCHITECTURAL SITE DETAILS.



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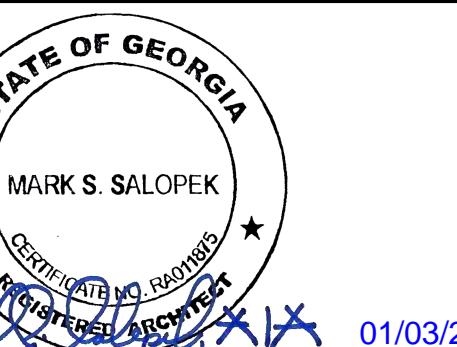
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ISSUE DATE:

12/03/2019

DESIGN MANAGER:

RV

PRODUCTION DESIGNER:

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CHECKED BY:

GPD GROUP

Revision Schedule

Rev Date By Description

SHEET TITLE:


ARCHITECTURAL SITE

PLAN

SCALE: AS SHOWN

SHEET NUMBER:

A001

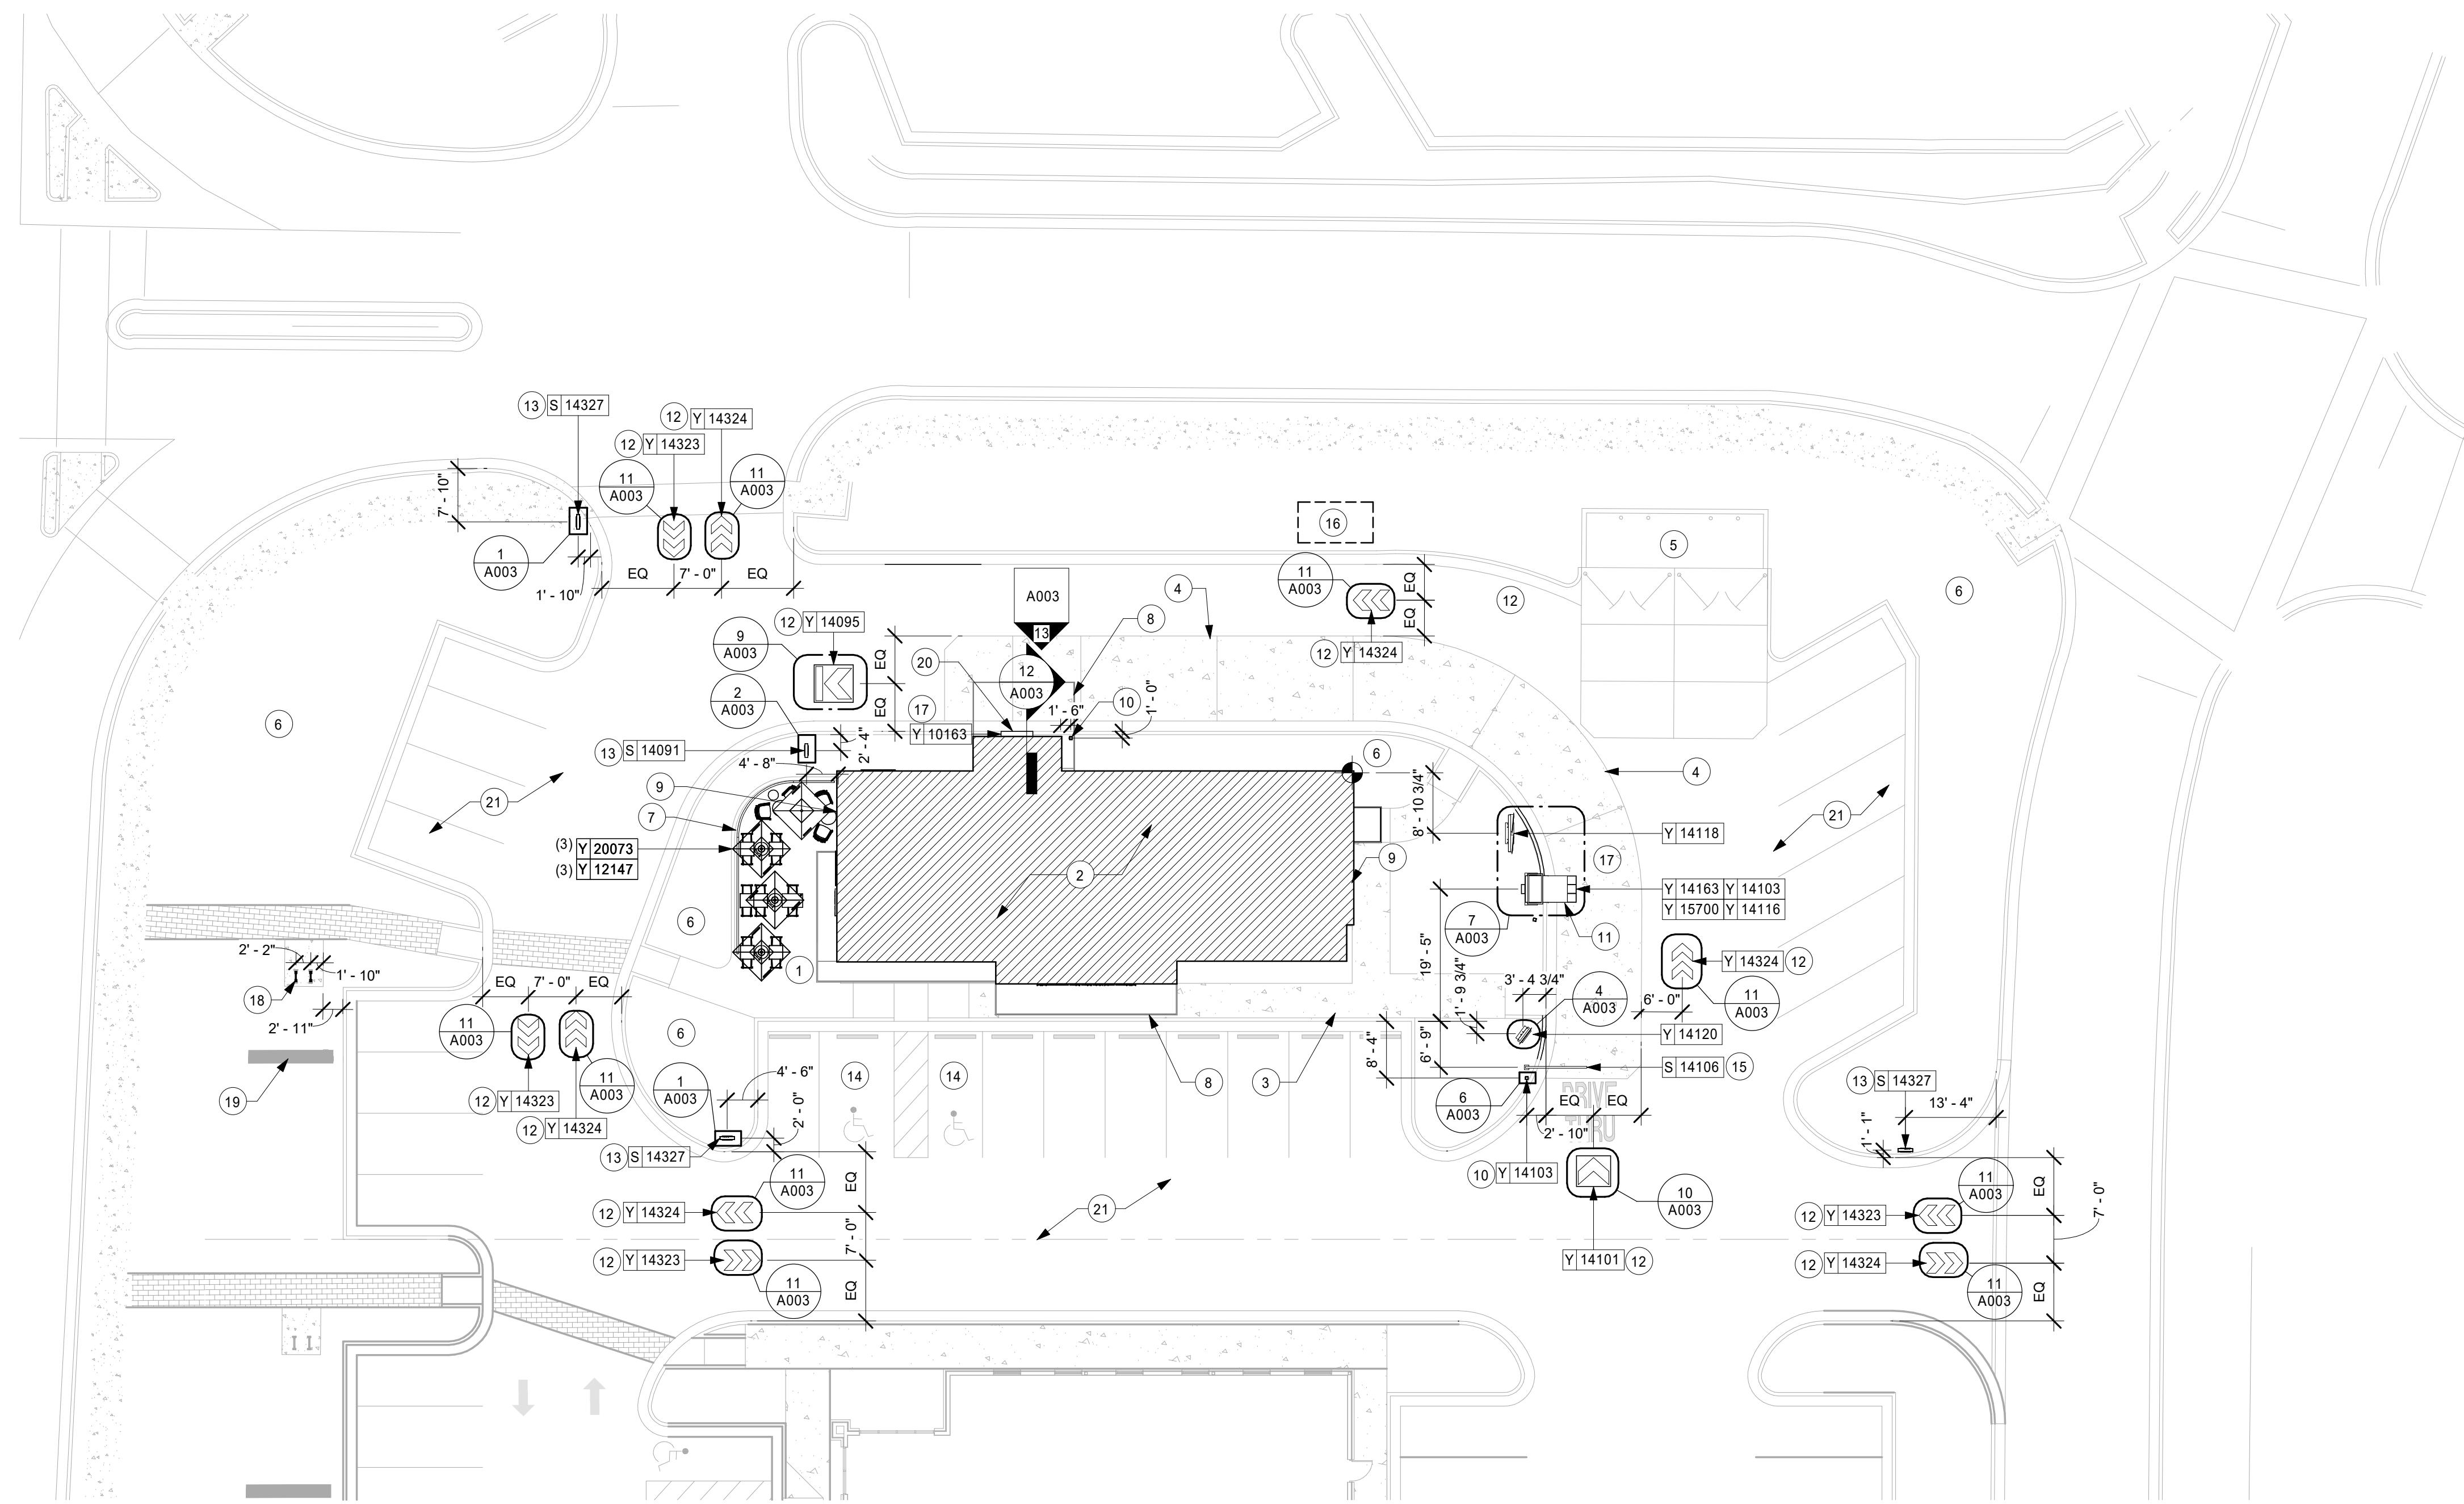


1ST FLOOR - SITE PLAN

Scale: 1/16" = 1'-0"

0 8' 16' 32'

Scale: 1/16" = 1'-0"

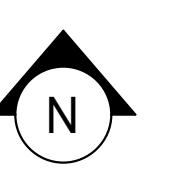



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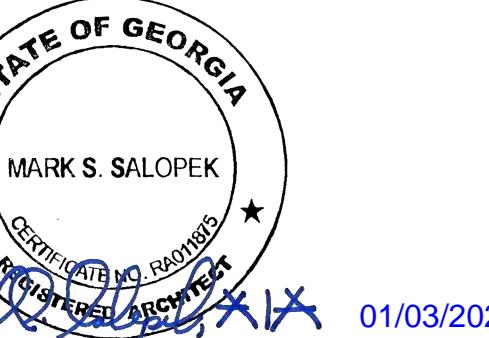
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STARBUCKS TEMPLATE VERSION: i2019-07-26



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P: 330-572-2100 F: 330-572-2101

GPD PROJECT NO: 2019261.12



01/03/2020



PROJECT NAME:
HWY 81 & LAKE DOW

PROJECT ADDRESS:
850 HWY 81
MCDONOUGH, GA 30252

STORE #: 59695
PROJECT #: 85535-001
ISSUE DATE: 12/03/2019
DESIGN MANAGER: RV
PRODUCTION DESIGNER: TW
CHECKED BY: GPD GROUP

Revision Schedule			
Rev	Date	By	Description

SHEET TITLE:
RAILING DETAILS
SCALE: AS SHOWN
SHEET NUMBER:
A005

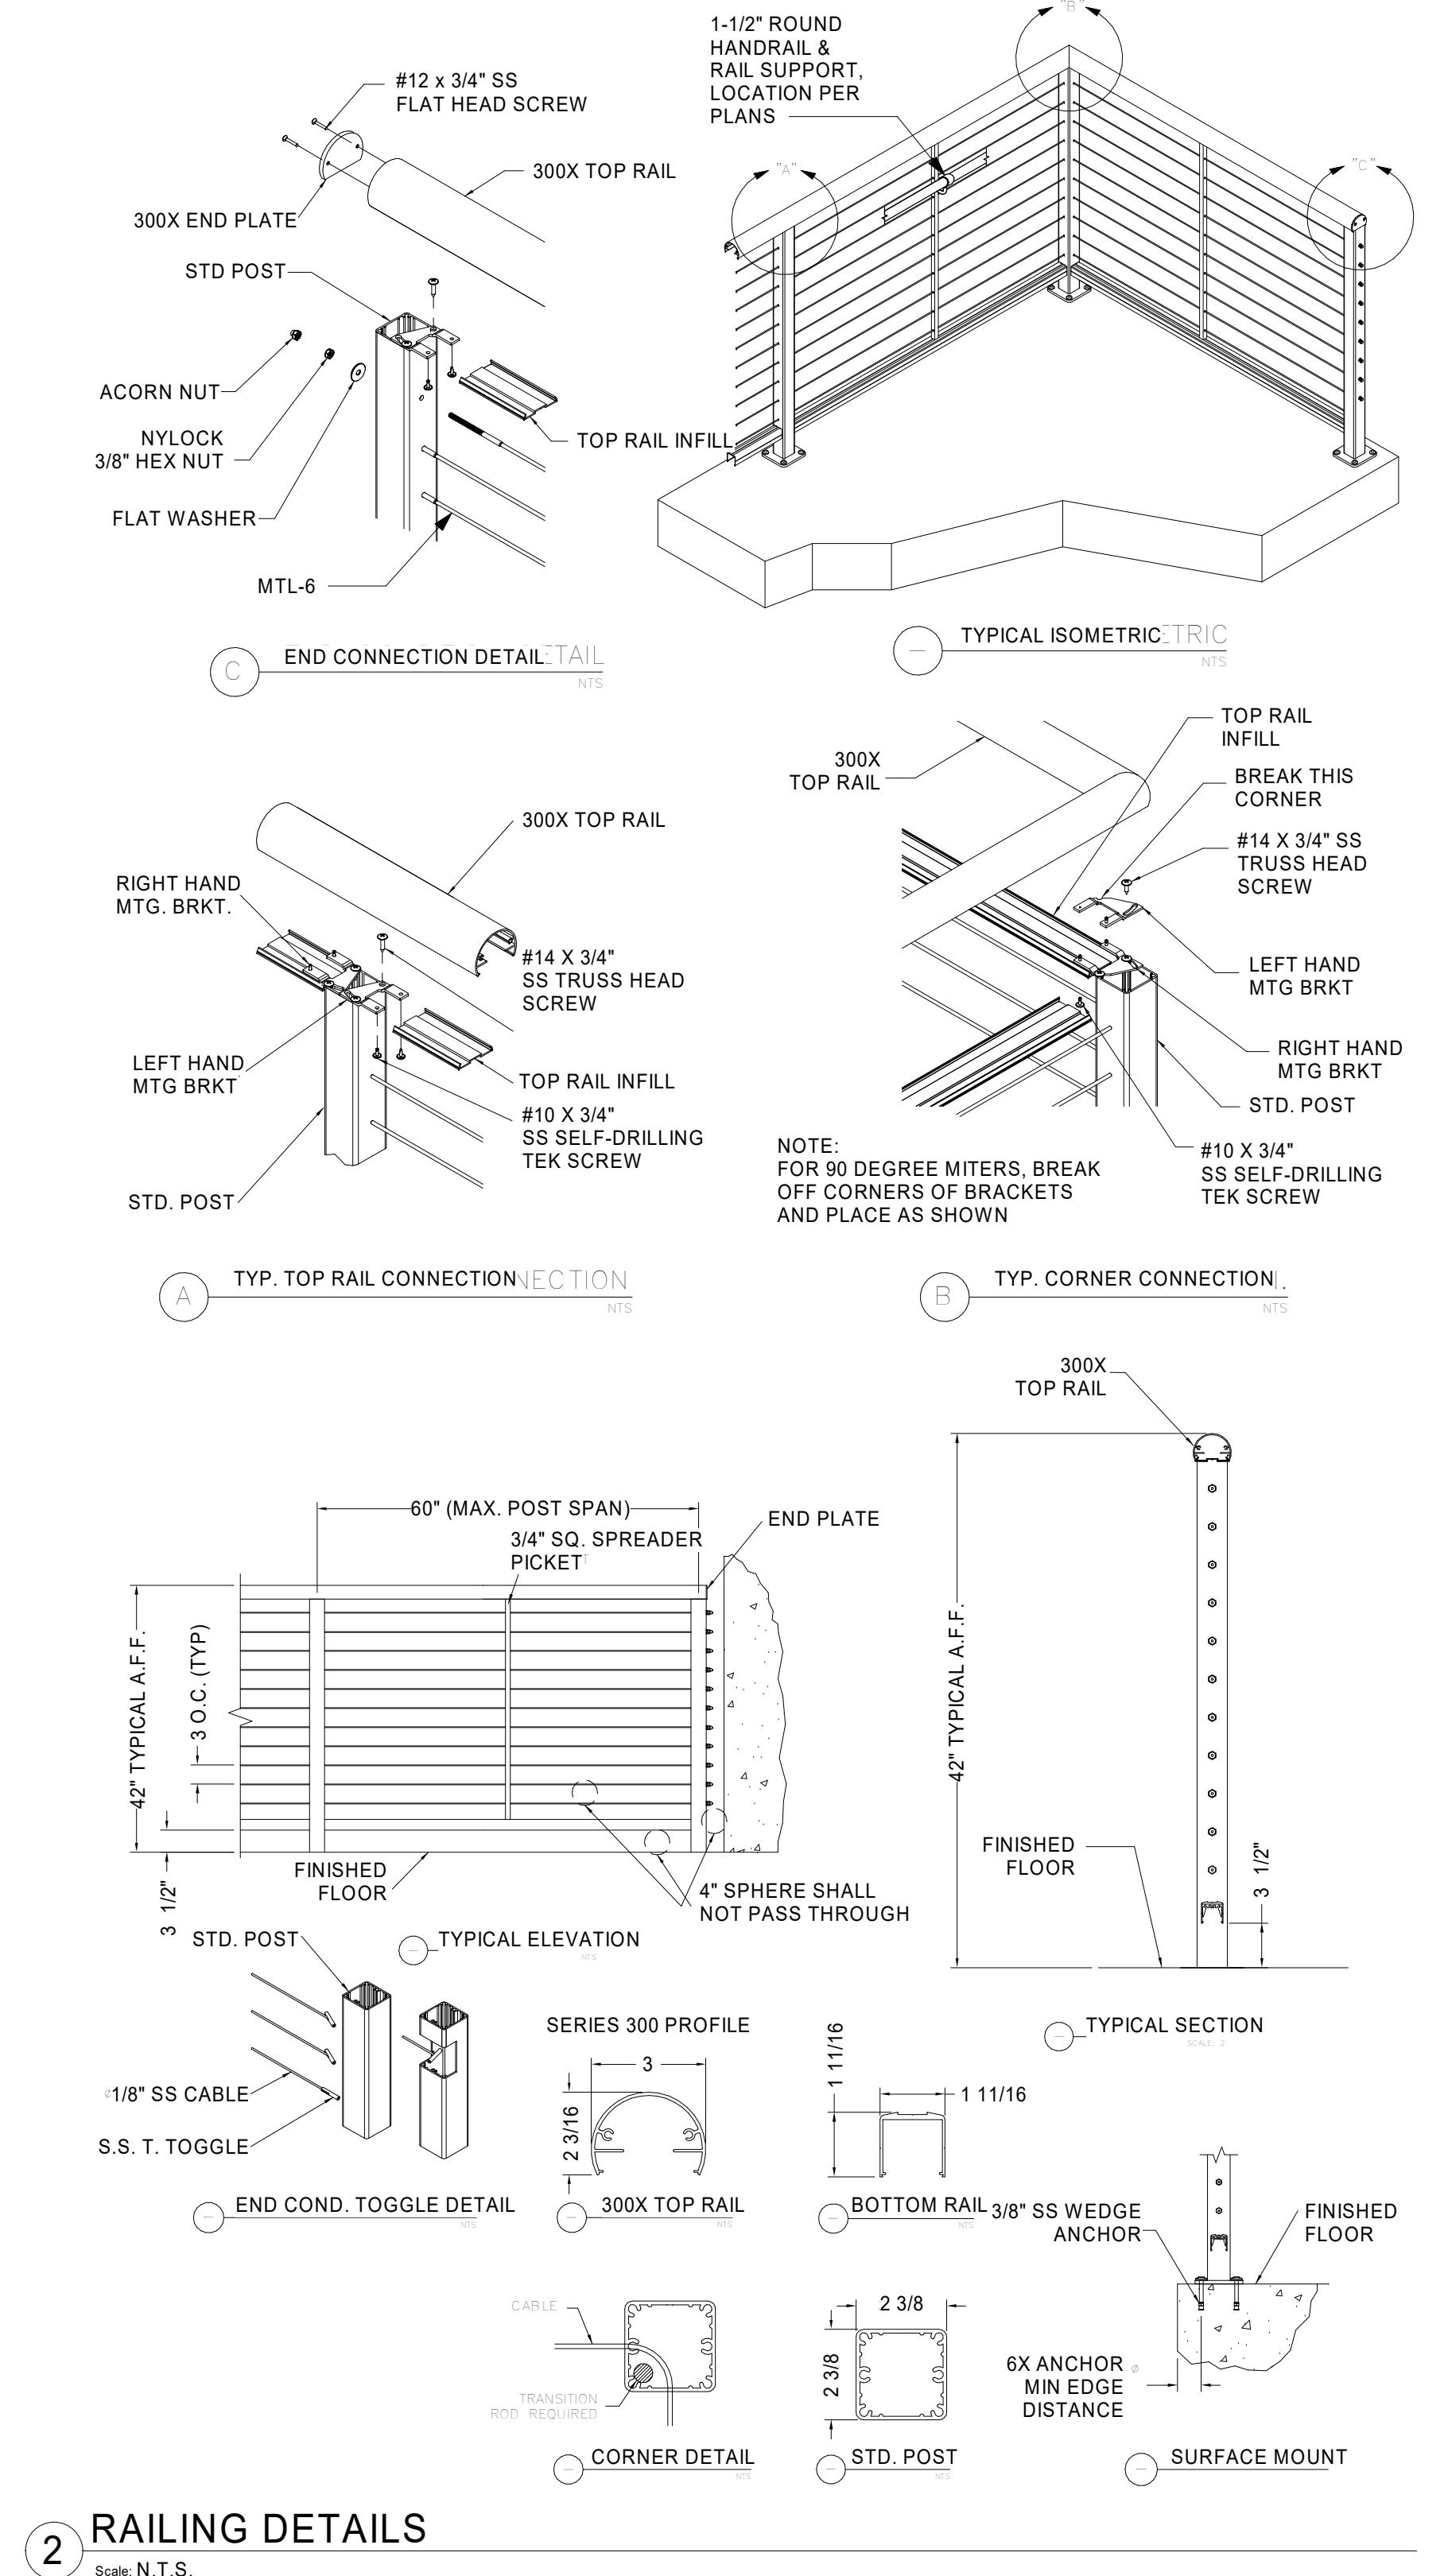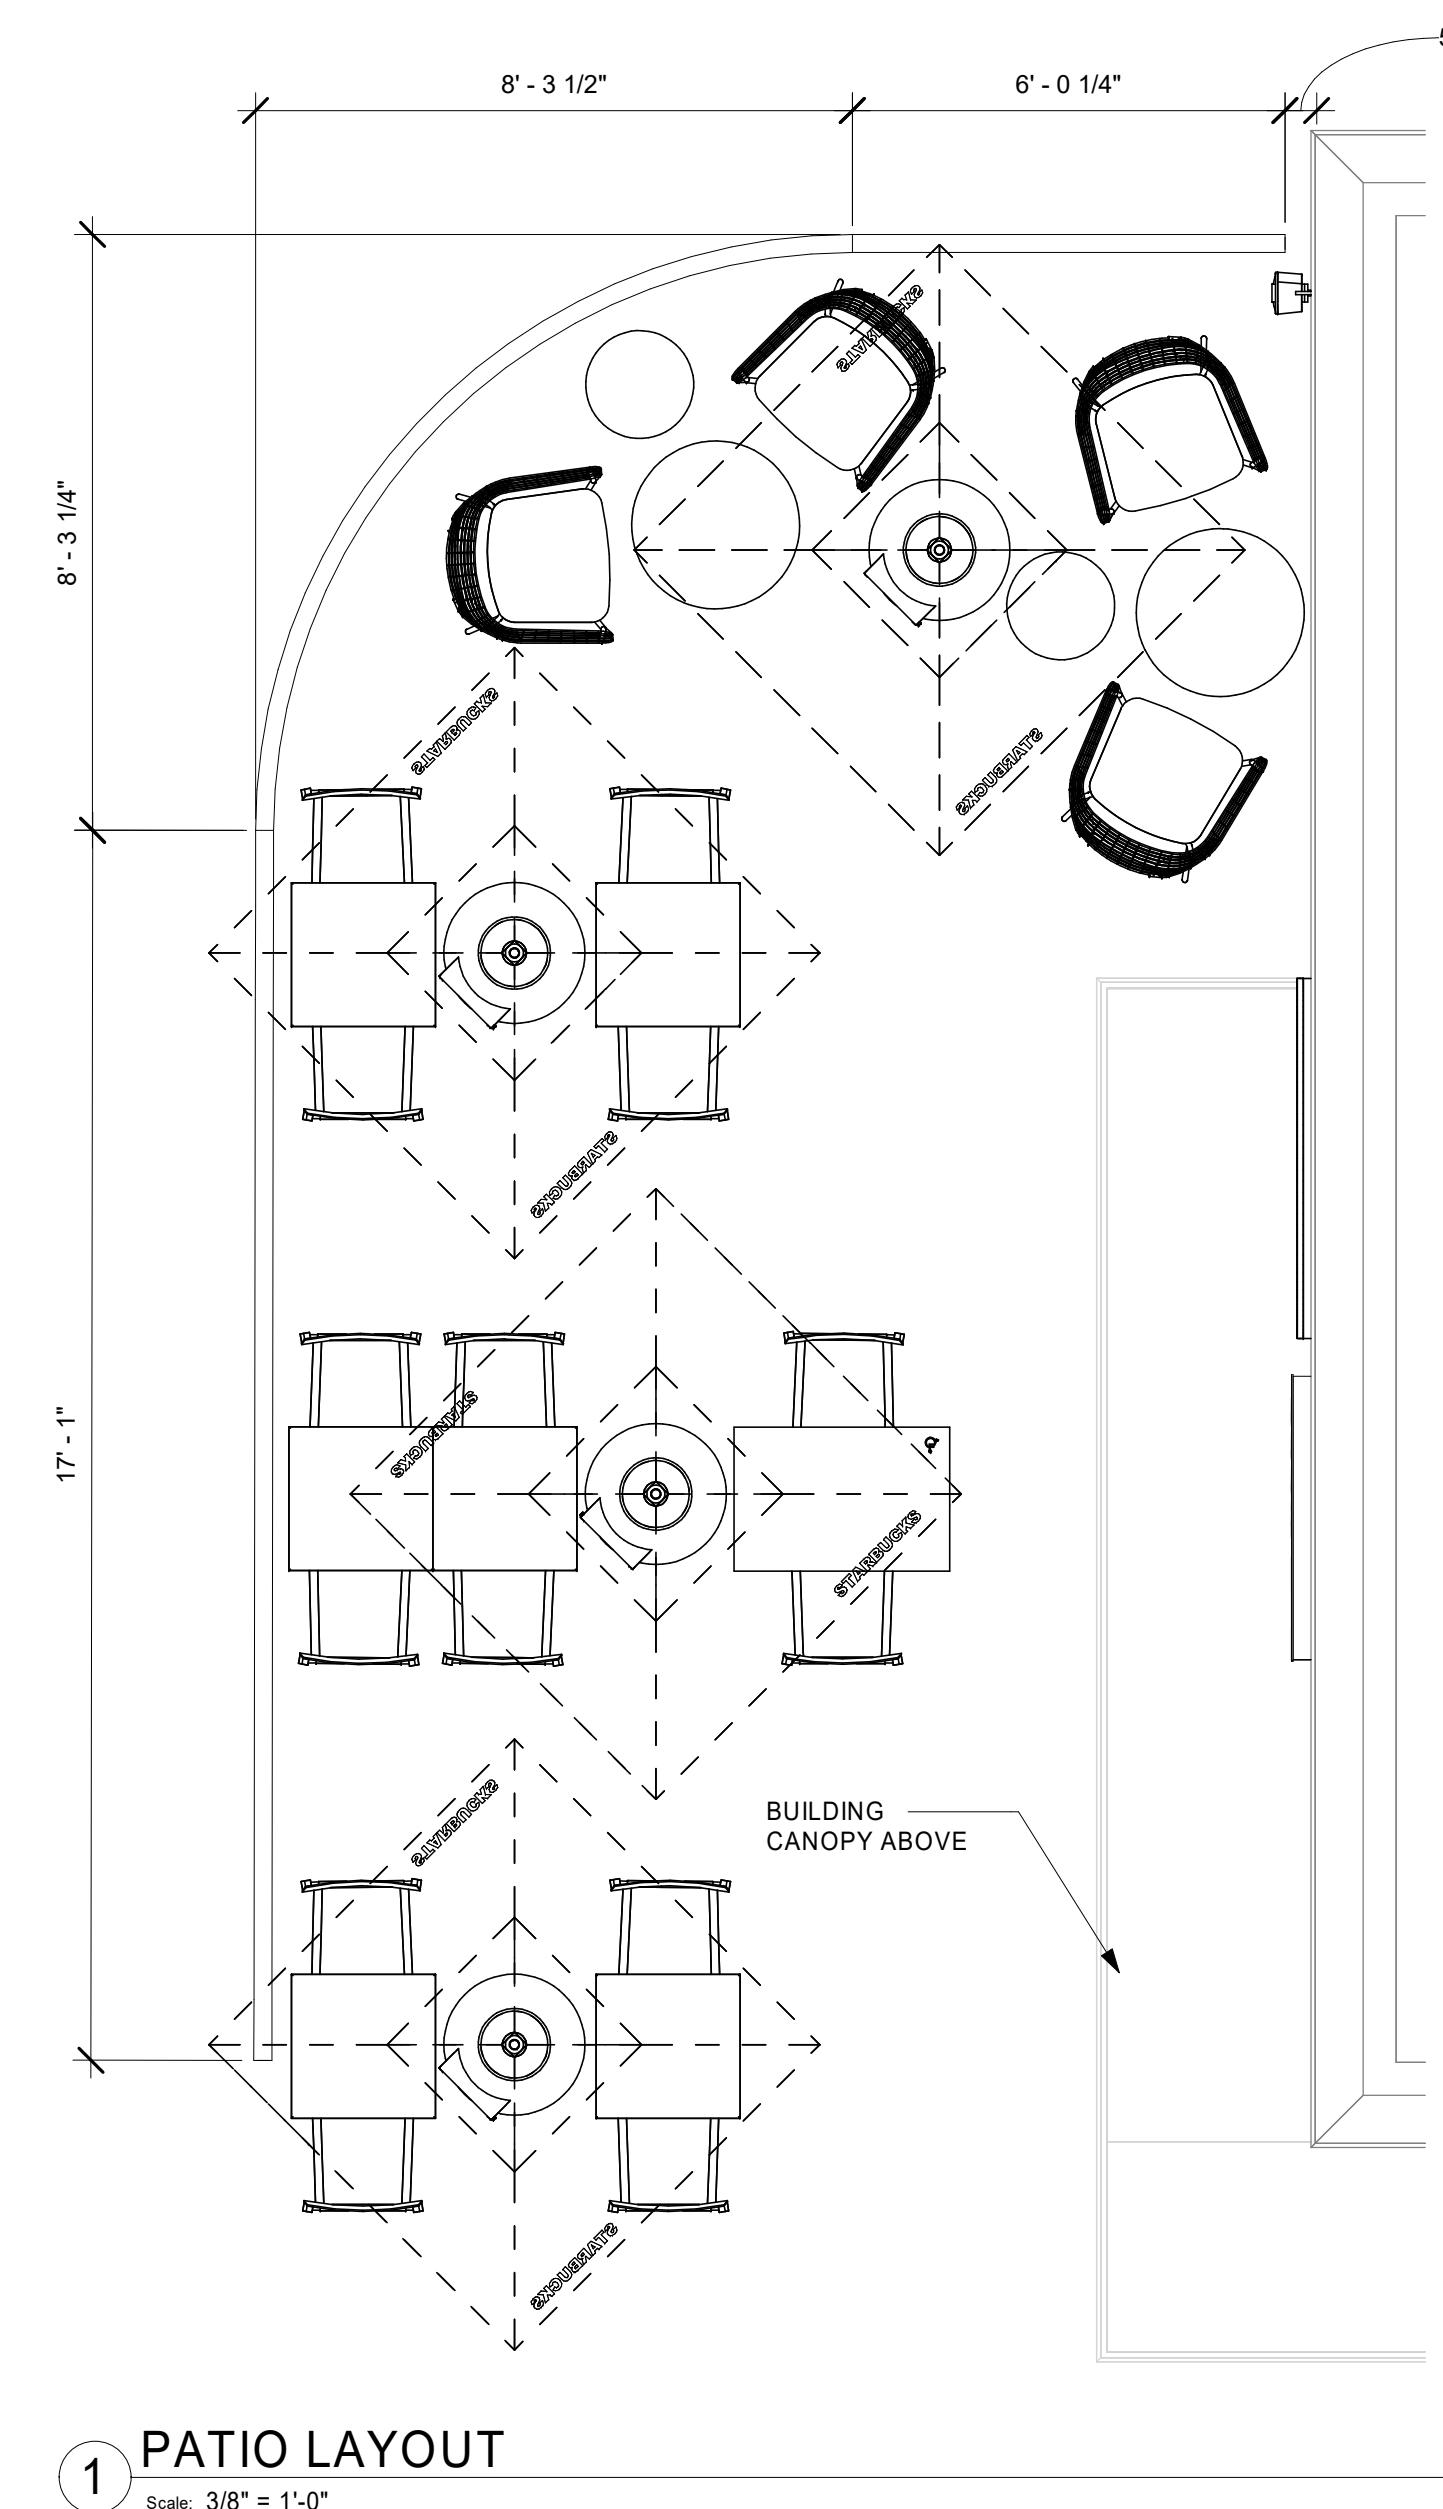



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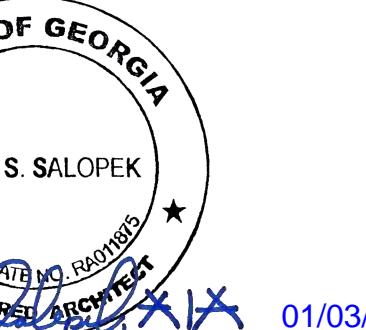
STARBUCKS TEMPLATE VERSION: i2019-07-26



Professional Corporation

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GPD PROJECT NO: 2019261.12



MARK S. SALOPEK
CERTIFIED ARCHITECT
01/03/2020

PROJECT NAME:
HWY 81 & LAKE DOW

PROJECT ADDRESS:
850 HWY 81
MCDONOUGH, GA 30252

STORE #: 59695
PROJECT #: 85535-001
ISSUE DATE: 12/03/2019
DESIGN MANAGER: RV
PRODUCTION DESIGNER: TW
CHECKED BY: GPD GROUP

Revision Schedule			
Rev	Date	By	Description

SHEET TITLE:
BUILDING FLOOR PLAN
SCALE: AS SHOWN
SHEET NUMBER:
A101

INTERIOR NEW WALL SCHEDULE			
TAG	DESCRIPTION	INSULATION	NOTES
3-F-A	3 5/8" 20 GA STUDS @ 16" O.C.	ACOUSTIC	FULL HT. WALL. SEE PLAN FOR WALL SHEATHING.
3-F-N	3 5/8" 20 GA STUDS @ 16" O.C.	NONE	FULL HT. WALL. SEE PLAN FOR WALL SHEATHING.
3-P-N	3 5/8" 16 GA STUDS @ 16" O.C.	NONE	PARTIAL HT. WALL WI/RCKW RIGID CONNECTORS AT FLOOR. SEE ELEVATIONS FOR WALL HT. SEE PLAN FOR WALL SHEATHING.
3-T-N	3 5/8" 20 GA STUDS @ 16" O.C.	NONE	TERMINATE 6" ABOVE CEILING. PROVIDE 45 DEGREE METAL STUD BRACING AT 48" O.C. FROM STUD WALL TO STRUCTURE ABOVE. SEE PLAN FOR WALL SHEATHING.
4-F-A	6" 20 GA STUDS @ 16" O.C.	ACOUSTIC	FULL HT. WALL. SEE PLAN FOR WALL SHEATHING.

WALL BLOCKING KEY

SYMBOL	ITEM	WEIGHT	HEIGHT A.F.F.	APPROX. WIDTH
A	WORKROOM HAND SINK	128 LBS (58 KG)	36" TO 40" (915MM TO 1015MM)	30" (760MM) BEHIND SINK
B	SHELVES ABOVE COMPARTMENT SINK	200 LBS (91 KG)	48" TO 76" (1220MM TO 1930MM)	96" (2440MM) CENTERED ABOVE COMPARTMENT SINK
C	UPPER WIRE SHELVES			BLOCKING SPECIFICATION TO BE PROVIDED BY VENDOR
D	SHELVES AT MANAGER'S DESK	300 LBS (136 KG)	32" TO 96" (810MM TO 2440MM)	48" (1220MM) 3/4 (19MM) ACX PLYWOOD, CENTERED ON SHELVES
E	EQUIPMENT RACK AT MANAGER'S DESK	300 LBS (136 KG)	44" TO 96" (1120MM TO 2440MM)	28" (710MM) 3/4 (19MM) ACX PLYWOOD, CENTERED ON RACK
F	METRO SHELVES			BLOCKING SPECIFICATION TO BE PROVIDED BY VENDOR. IN-WALL BLOCKING PREFERRED. HOWEVER EXISTING FRP FINISHED WALL MAY RECEIVE SURFACE MOUNTED, PAINTED WHITE.
G	RESTROOM GRAB BARS	200 LBS (91 KG)	30" TO 36" (760MM TO 915MM)	60" (1525MM) AROUND WATER CLOSET
H	RESTROOM HAND SINK			COMMERCIAL INSTALLATION REQUIRES CONCEALED ARM CARRIER. REFER TO MFR'S SPECIFICATION.
I	ALL ARTWORK, FIXTURES, ACCESSORIES AND CASEWORK FABRICATIONS NOT OTHERWISE NOTED	TBD BY VENDOR (VARIES)		GC TO PROVIDE WALL BLOCKING AS REQUIRED FOR ALL ITEMS FOR A COMPLETE AND SECURE INSTALLATION. EXTEND BLOCKING 6" (205MM) BEYOND ON EACH SIDE OF EACH ITEM AT WALL AND CEILING WHERE ARTWORK IS ATTACHED. SEE DETAILS
J	DIAPER CHANGING STATION	250 LBS (113 KG)	40 1/2" TO 46 1/2" (1030MM TO 1180MM)	32" (810MM) BEHIND STATION
K	UPPER CBE SHELVING			BLOCKING SPECIFICATION FOR CBE METAL SHELVES. REFER TO VENDOR'S SPECIFICATION AND DETAILS.
L	WATER FILTRATION SYSTEM	TBD BY VENDOR		COORDINATE LOCATION AND EXTENT WITH PENTAIR

WALL SHEATHING KEY


SYMBOL	DESCRIPTION
▲	INDICATES SHEATHING TRANSITION
Ⓐ	5/8" GYP. WALL BOARD (FULL WALL HEIGHT)
Ⓑ	5/8" CEMENTITIOUS BACKER BOARD (TERMEDIATE AT FINISH TRANSITION AS SHOWN ON INTERIOR ELEVATION W/ 5/8" GYP. WALL BOARD ABOVE (FULL WALL HEIGHT)).
Ⓒ	5/8" TYPE "X" BOARD (FULL WALL HEIGHT).
Ⓓ	5/8" GYP. WALL BOARD (PARTIAL WALL HEIGHT)

KEYED NOTES

- STRUCTURAL COLUMN. SEE STRUCTURAL.
- INSTALL NEW CONCRETE SLAB OVER VAPOR BARRIER OVER EXISTING COMPACTED FILL. IF APPLICABLE: REFER TO STRUCTURAL FOR CONNECTION OF NEW SLAB TO EXISTING.
- OUTLINE OF BAR PER CASEWORK MANUFACTURER.
- ELECTRICAL PANEL LOCATIONS. MAINTAIN MINIMUM CLEARANCE AS REQUIRED BY CODE.
- ALIGN FACE OF FINISHED WALL.
- OUTLINE OF SOFFIT ABOVE.
- OUTLINE OF AWNING ABOVE.
- FUR OUT INTERIOR FACE OF WALL.

GENERAL NOTES

- GENERAL CONTRACTOR TO VERIFY ALL DIMENSIONS AND NOTIFY STARBUCKS CONSTRUCTION MANAGER OF ANY DISCREPANCIES PRIOR TO CONSTRUCTION. ALL DIMENSIONS TO BE TAKEN FROM DESIGNATED DATUM POINT.
- GENERAL CONTRACTOR TO PROVIDE FIRE TREATED WOOD STUD BLOCKING, OR EQUIVALENT TO SUPPORT ANY WALL ATTACHMENT AND/OR SIGNAGE.
- IF EXISTING EXTERIOR ENTRANCE THRESHOLD EXCEEDS MINIMUM BARRIER FREE PROVISION OF THE CODE, REMOVE AND REPLACE WITH ACCESSIBLE THRESHOLD. RAISED THRESHOLDS AND FLOOR LEVEL CHANGES AT ACCESSIBLE DOORWAYS TO BE VELED WITH A SLOPE NO GREATER THAN 1:12.
- ALL DIMENSIONS ARE TO FINISHED FACE UNLESS SHOWN OR NOTED OTHERWISE.
- INSTALL MOISTURE RESISTANT GREEN BOARD ON BACKBAR WALL PER PROJECT MANUAL.
- ALL DOORS SHALL BE 32" (815MM) MINIMUM CLEAR OPENING WHEN OPENED TO 90 DEGREE POSITION UNLESS OTHERWISE NOTED.
- SEE SHEET A601 FOR EXTERIOR DOOR AND WINDOW SCHEDULES.
- STARBUCKS VENDOR TO PROVIDE DOOR HARDWARE COMPONENTS AND GC TO INSTALL.
- VERIFY ALL EXISTING DOORS, HARDWARE AND FRAMES MEET STARBUCKS AND/OR CODE REQUIREMENTS.
- PROVIDE FIRE EXTINGUISHERS AS NOTED ON THE APPROVED PLANS FROM THE CITY.
- SEE STRUCTURAL FOR KNEE WALL BRACING.
- SEE SHEET A501 FOR BUILDING DETAILS.
- REFER TO SHEET I104 FOR FLOOR FINISHES.

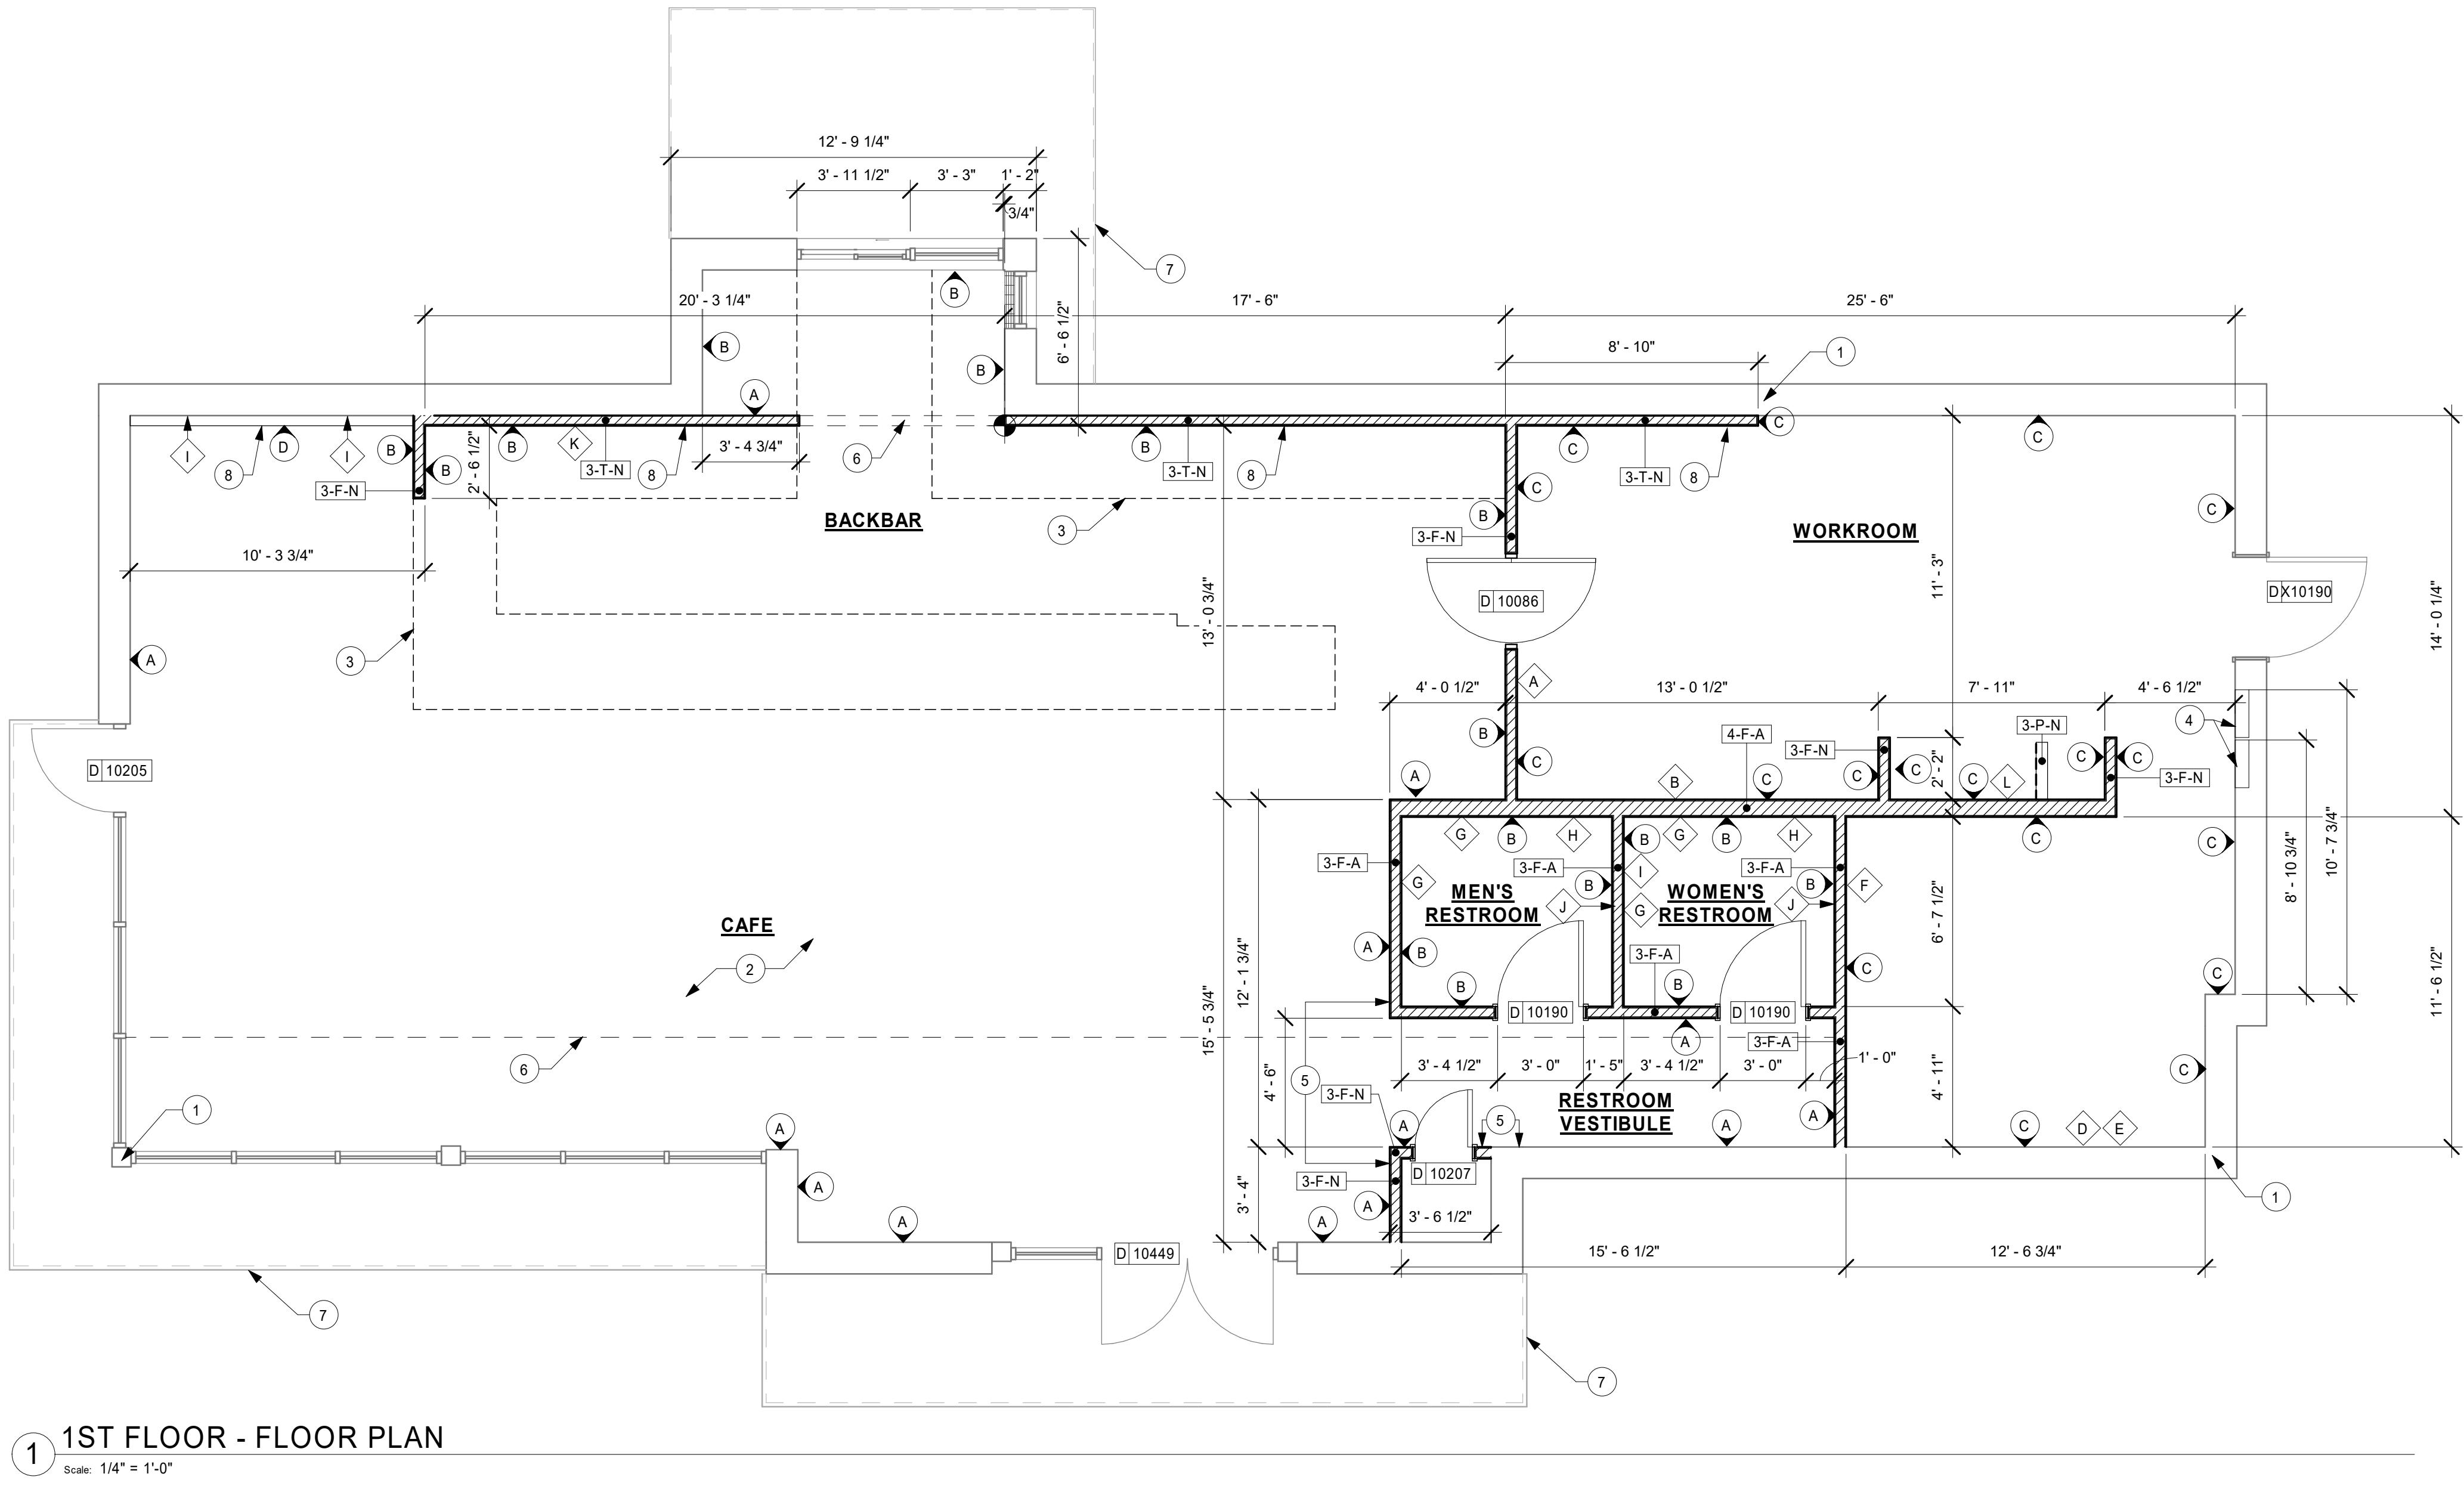




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STARBUCKS TEMPLATE VERSION: i2019-07-26

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GPD PROJECT NO: 2019261.12



PROJECT NAME:
HWY 81 & LAKE DOW

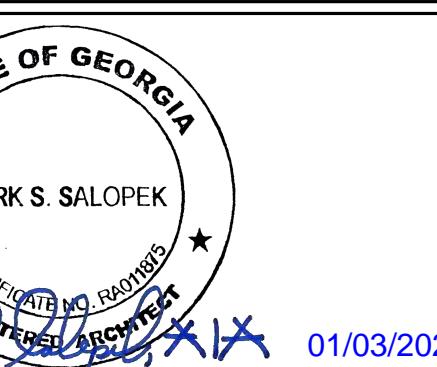PROJECT ADDRESS:
850 HWY 81
MCDONOUGH, GA 30252

STORE #: 59695
PROJECT #: 85535-001
ISSUE DATE: 12/03/2019
DESIGN MANAGER: RV
PRODUCTION DESIGNER: TW
CHECKED BY: GPD GROUP

Revision Schedule			
Rev	Date	By	Description

SHEET TITLE:
BUILDING FLOOR PENETRATION PLAN

SCALE: AS SHOWN

SHEET NUMBER:
A102

KEYED NOTES

1. OUTLINE OF ENGINE CASEWORK
2. FLOOR CLEANOUT LOCATION. SEE PLUMBING FOR ADDITIONAL INFORMATION
3. FLOOR SINK LOCATION. SEE SHEET P101.
4. FLOOR DRAIN LOCATION. SEE SHEET P101.
5. FLOOR ELECTRICAL OUTLET. SEE SHEET E101.
6. WASTE DRAIN FOR MOP SINK.
7. WASTE DRAIN FOR TOILET.
8. LOCATION OF ELECTRICAL PANELS, SEE ELECTRICAL FOR ADDITIONAL INFORMATION.
9. DATUM POINT FOR ENGINE LAYOUT.
10. DATUM POINT FOR BOH AND RESTROOMS LAYOUT.


GENERAL NOTES

- A. ALL STUB-UP DIMENSIONS ARE RELATIVE TO FINISHED WALL LOCATIONS (SHOWN AS OUTLINES ON THIS PLAN). REFER TO FLOOR PLAN FOR WALL PLACEMENT.
- B. FLOOR SINK: REFER TO CUT SHEETS FOR COMPONENT SPECIFICATIONS AND CUTOUT REQUIREMENTS.
- C. WASTE LINE PENETRATIONS: REFER TO PLUMBING PLANS FOR INDIVIDUAL LINE LOCATIONS.
- D. STUB-UP PENETRATIONS: REFER TO ELECTRICAL AND PLUMBING PLANS FOR INDIVIDUAL STUB-UP LOCATIONS.
- E. TOILET FLOOR PENETRATION: REFER TO CUT SHEETS FOR STUB-UP LOCATION RELATIVE TO FINISHED WALL.
- F. PENETRATION TO BE LOCATED ON CENTERLINE OF WALL OR AS REQUIRED PER CONDITIONS.
- G. TRENCHING OUTLINE FOR GUIDELINE USE ONLY. GENERAL CONTRACTOR TO COORDINATE WITH SPECIFIC TRADES AND SITE CONDITIONS TO DETERMINE ACTUAL LAYOUT.
- H. REFER TO SHEET I101 FOR FLOOR FINISHES.

LEGEND

- EXISTING WALL
- CONCRETE LEAVE-OUT
- DATUM POINT

STARBUCKS TEMPLATE VERSION: i2019-07-26

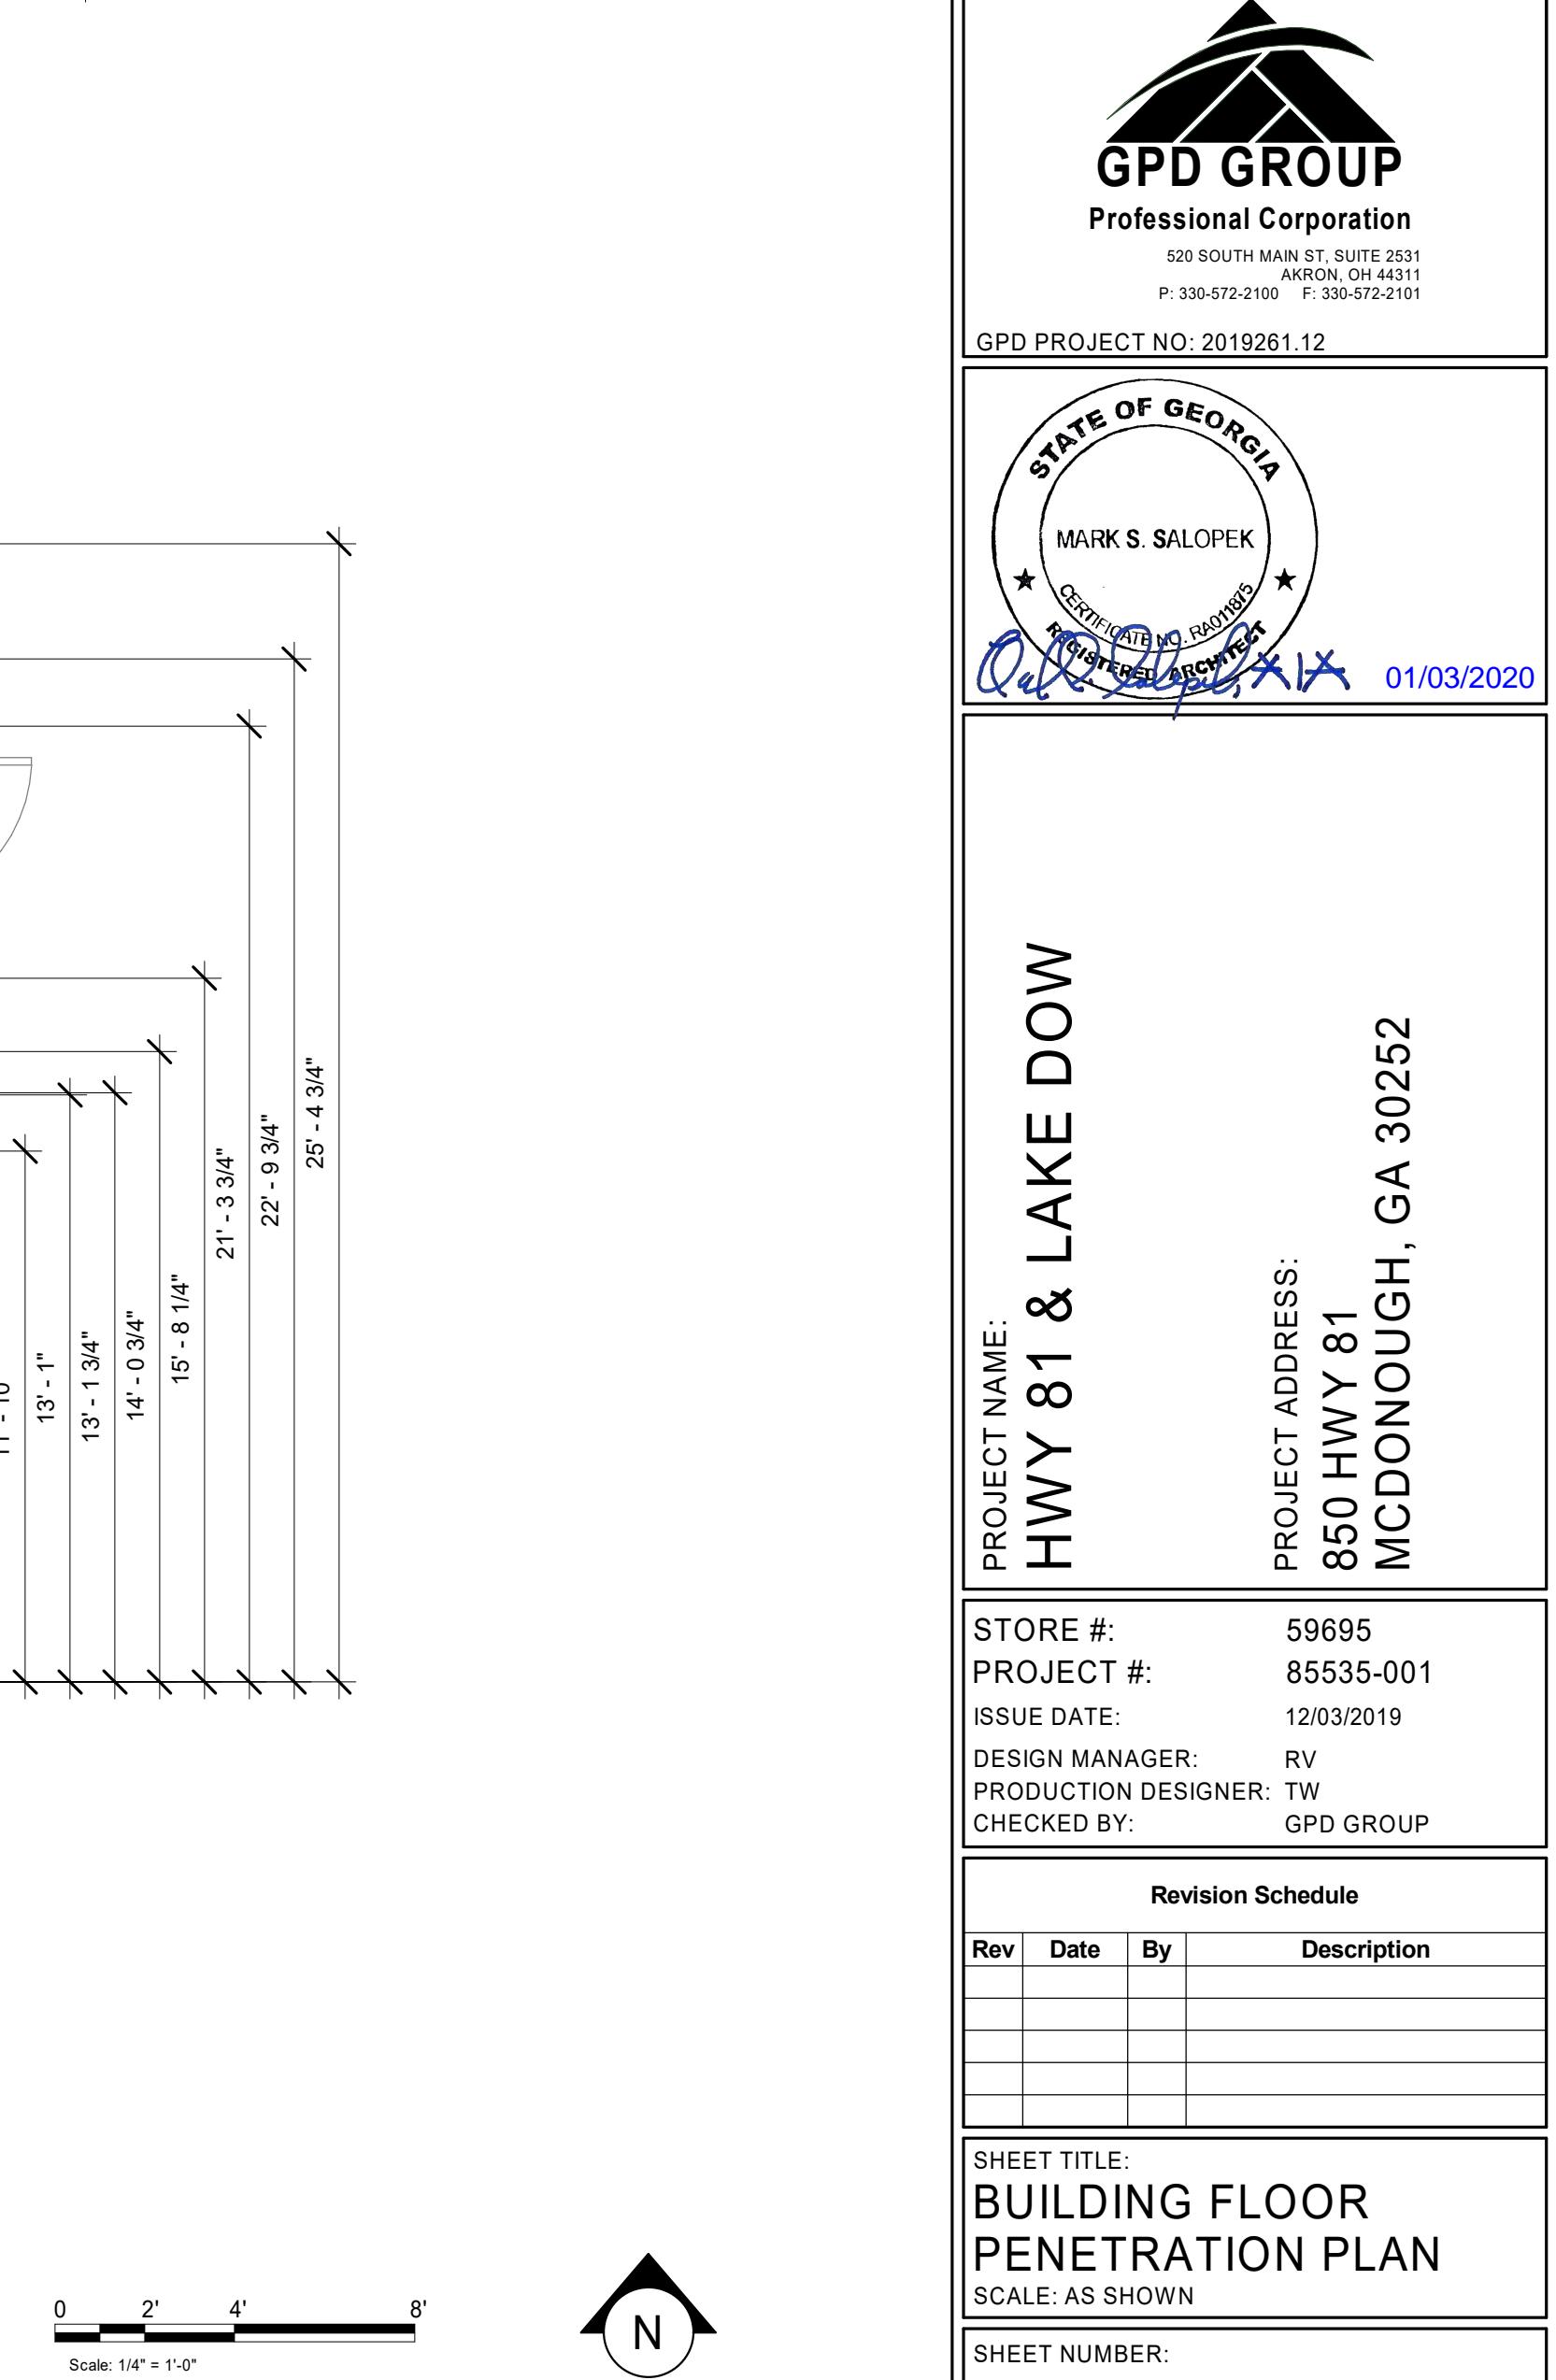

1 1ST FLOOR - FLOOR PENETRATION PLAN

Scale: 1/4" = 1'-0"



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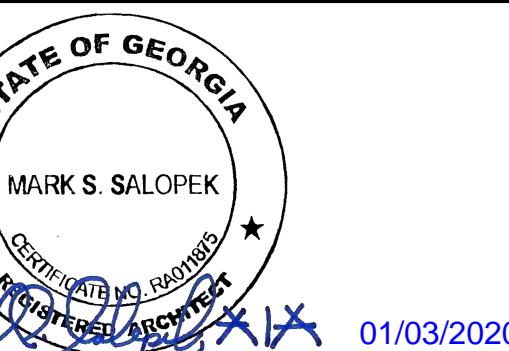
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GPD PROJECT NO: 2019261.12



MARK S. SALOPEK
CERTIFIED AND SWORN TO
01/03/2020

PROJECT NAME:
HWY 81 & LAKE DOW

PROJECT ADDRESS:
850 HWY 81
MCDONOUGH, GA 30252

STORE #: 59695
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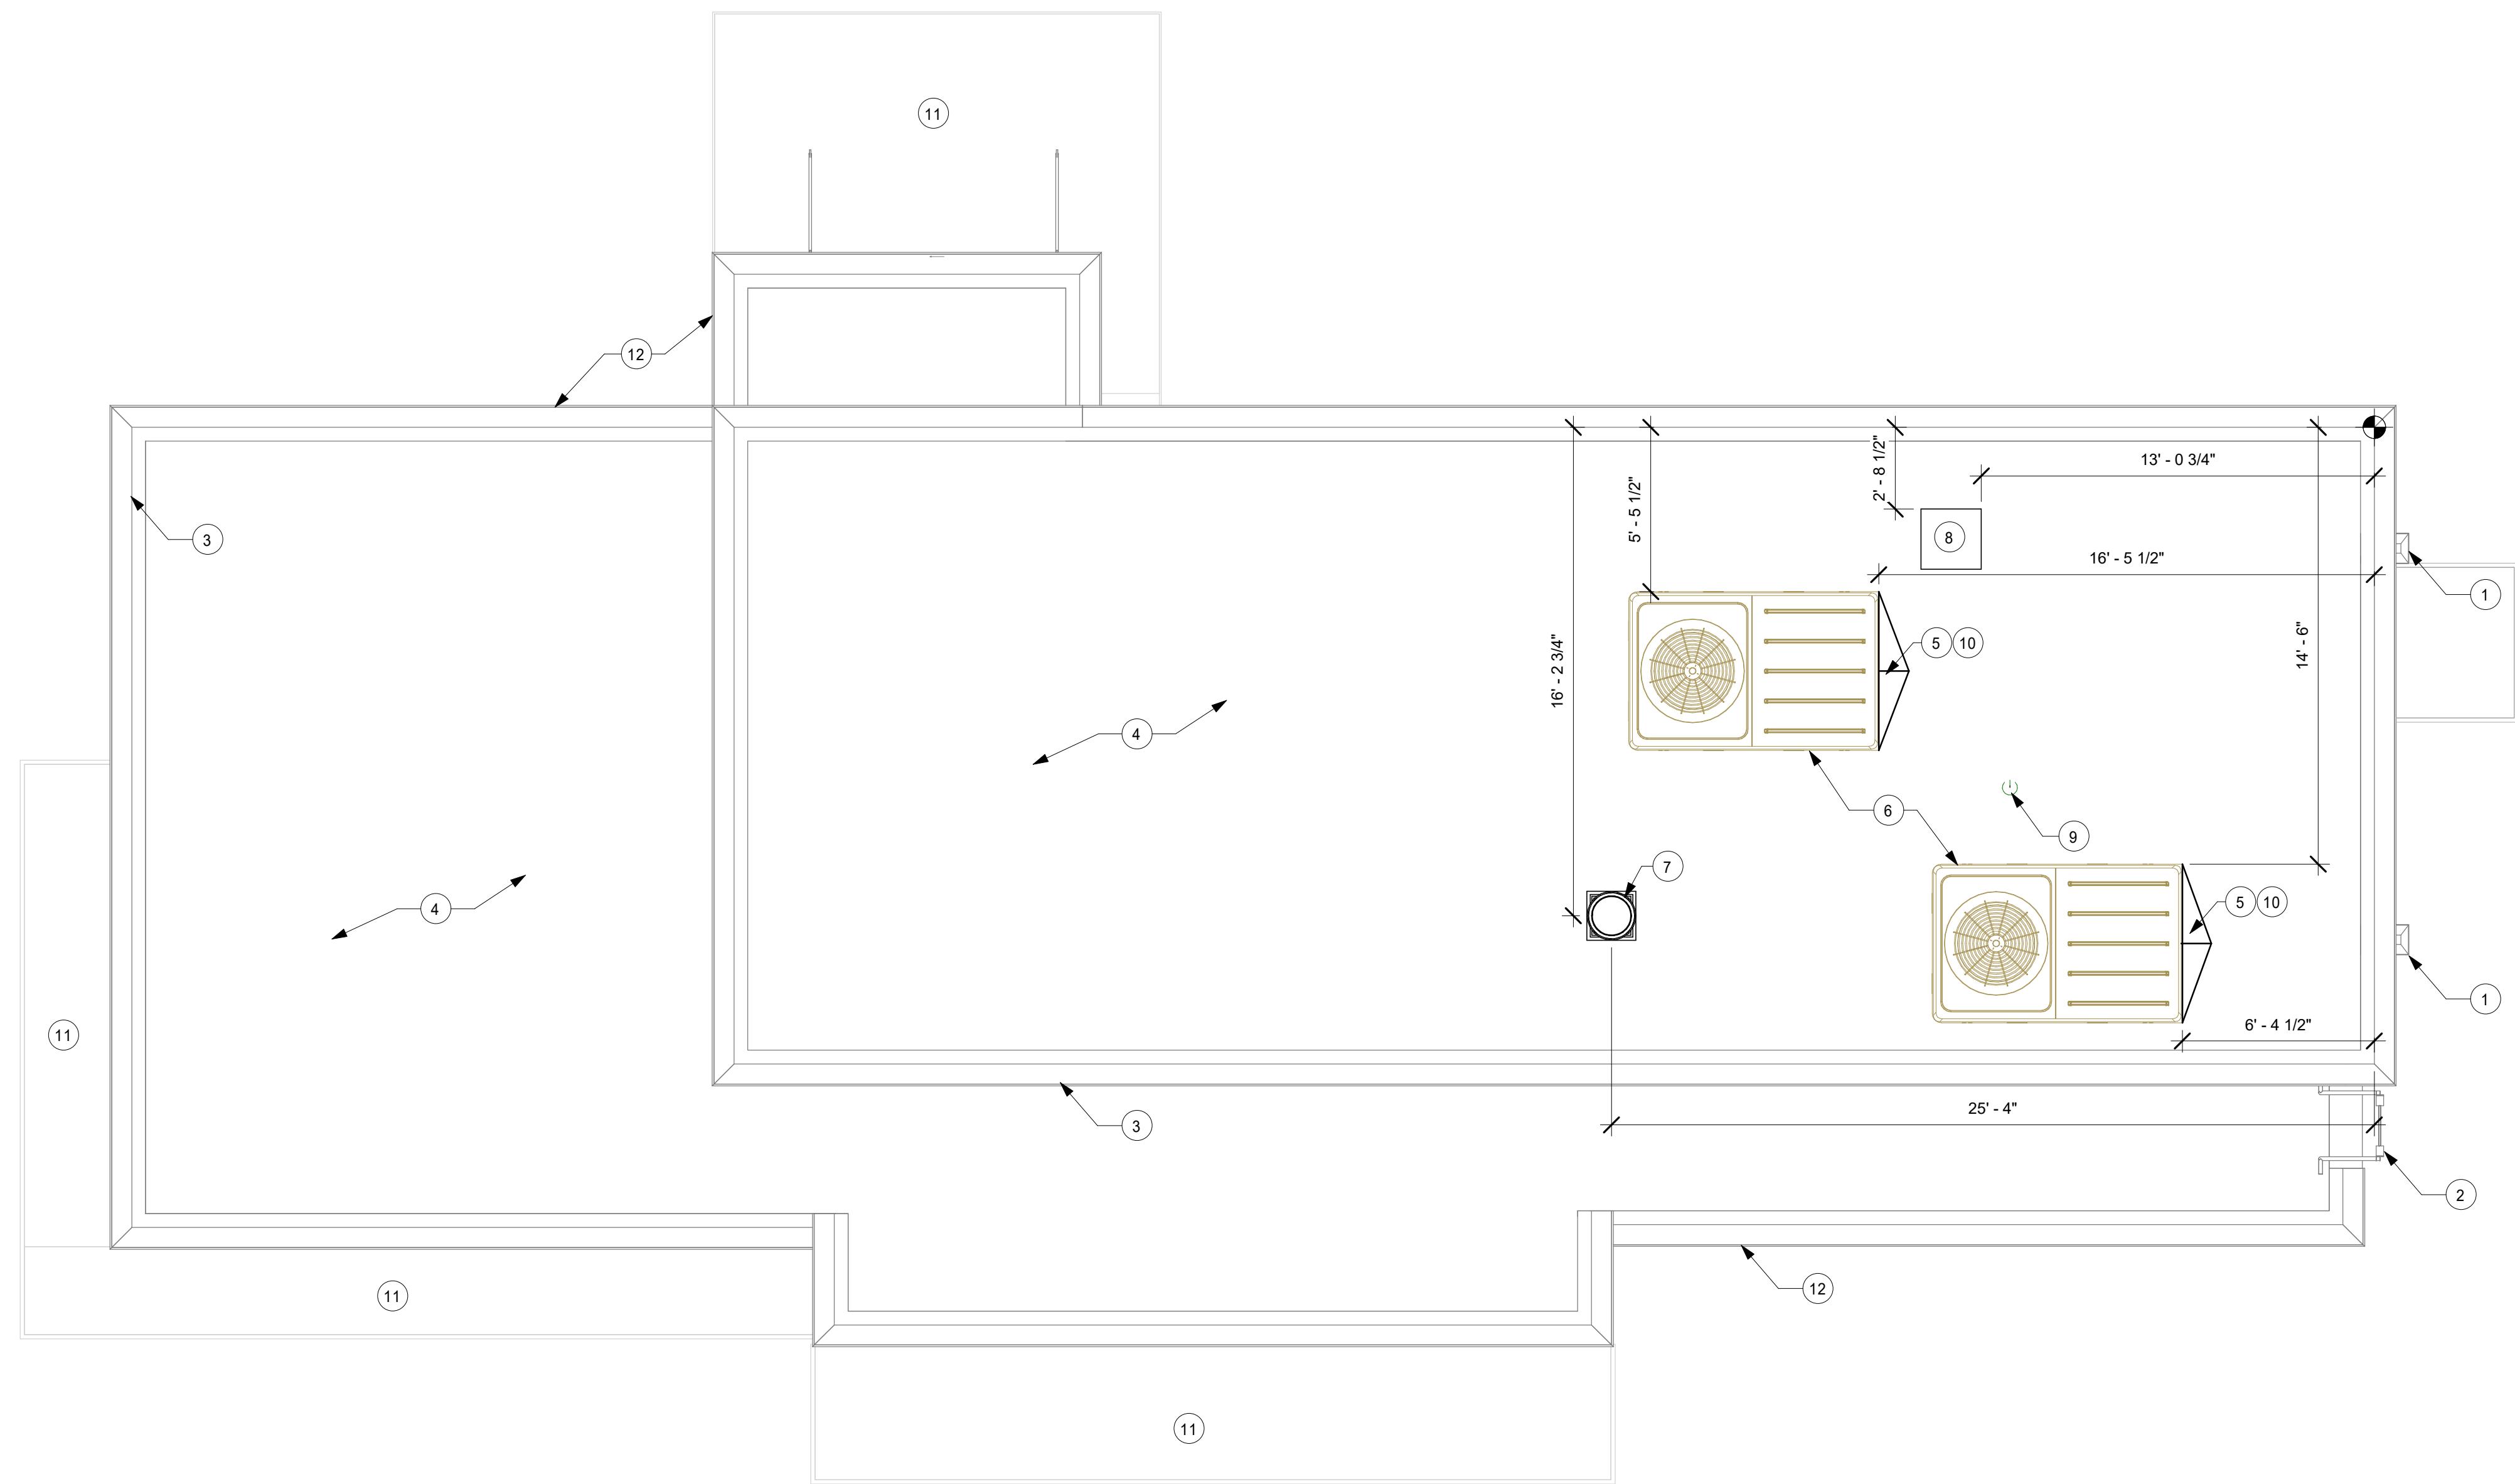
Revision Schedule

Rev	Date	By	Description

SHEET TITLE:
BUILDING ROOF PLAN

SCALE: AS SHOWN

SHEET NUMBER:
A103



1 1ST FLOOR - ROOF PLAN
Scale: 1/4" = 1'-0"

0 2' 4' 8'
Scale: 1/4" = 1'-0"





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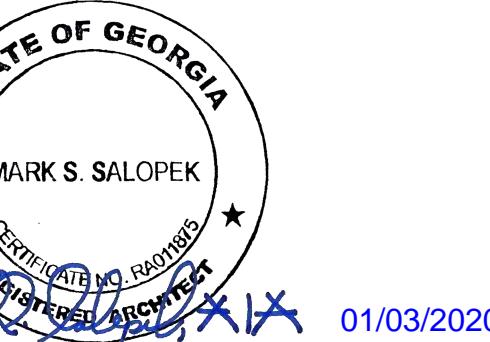
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01/03/2020

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Revision Schedule

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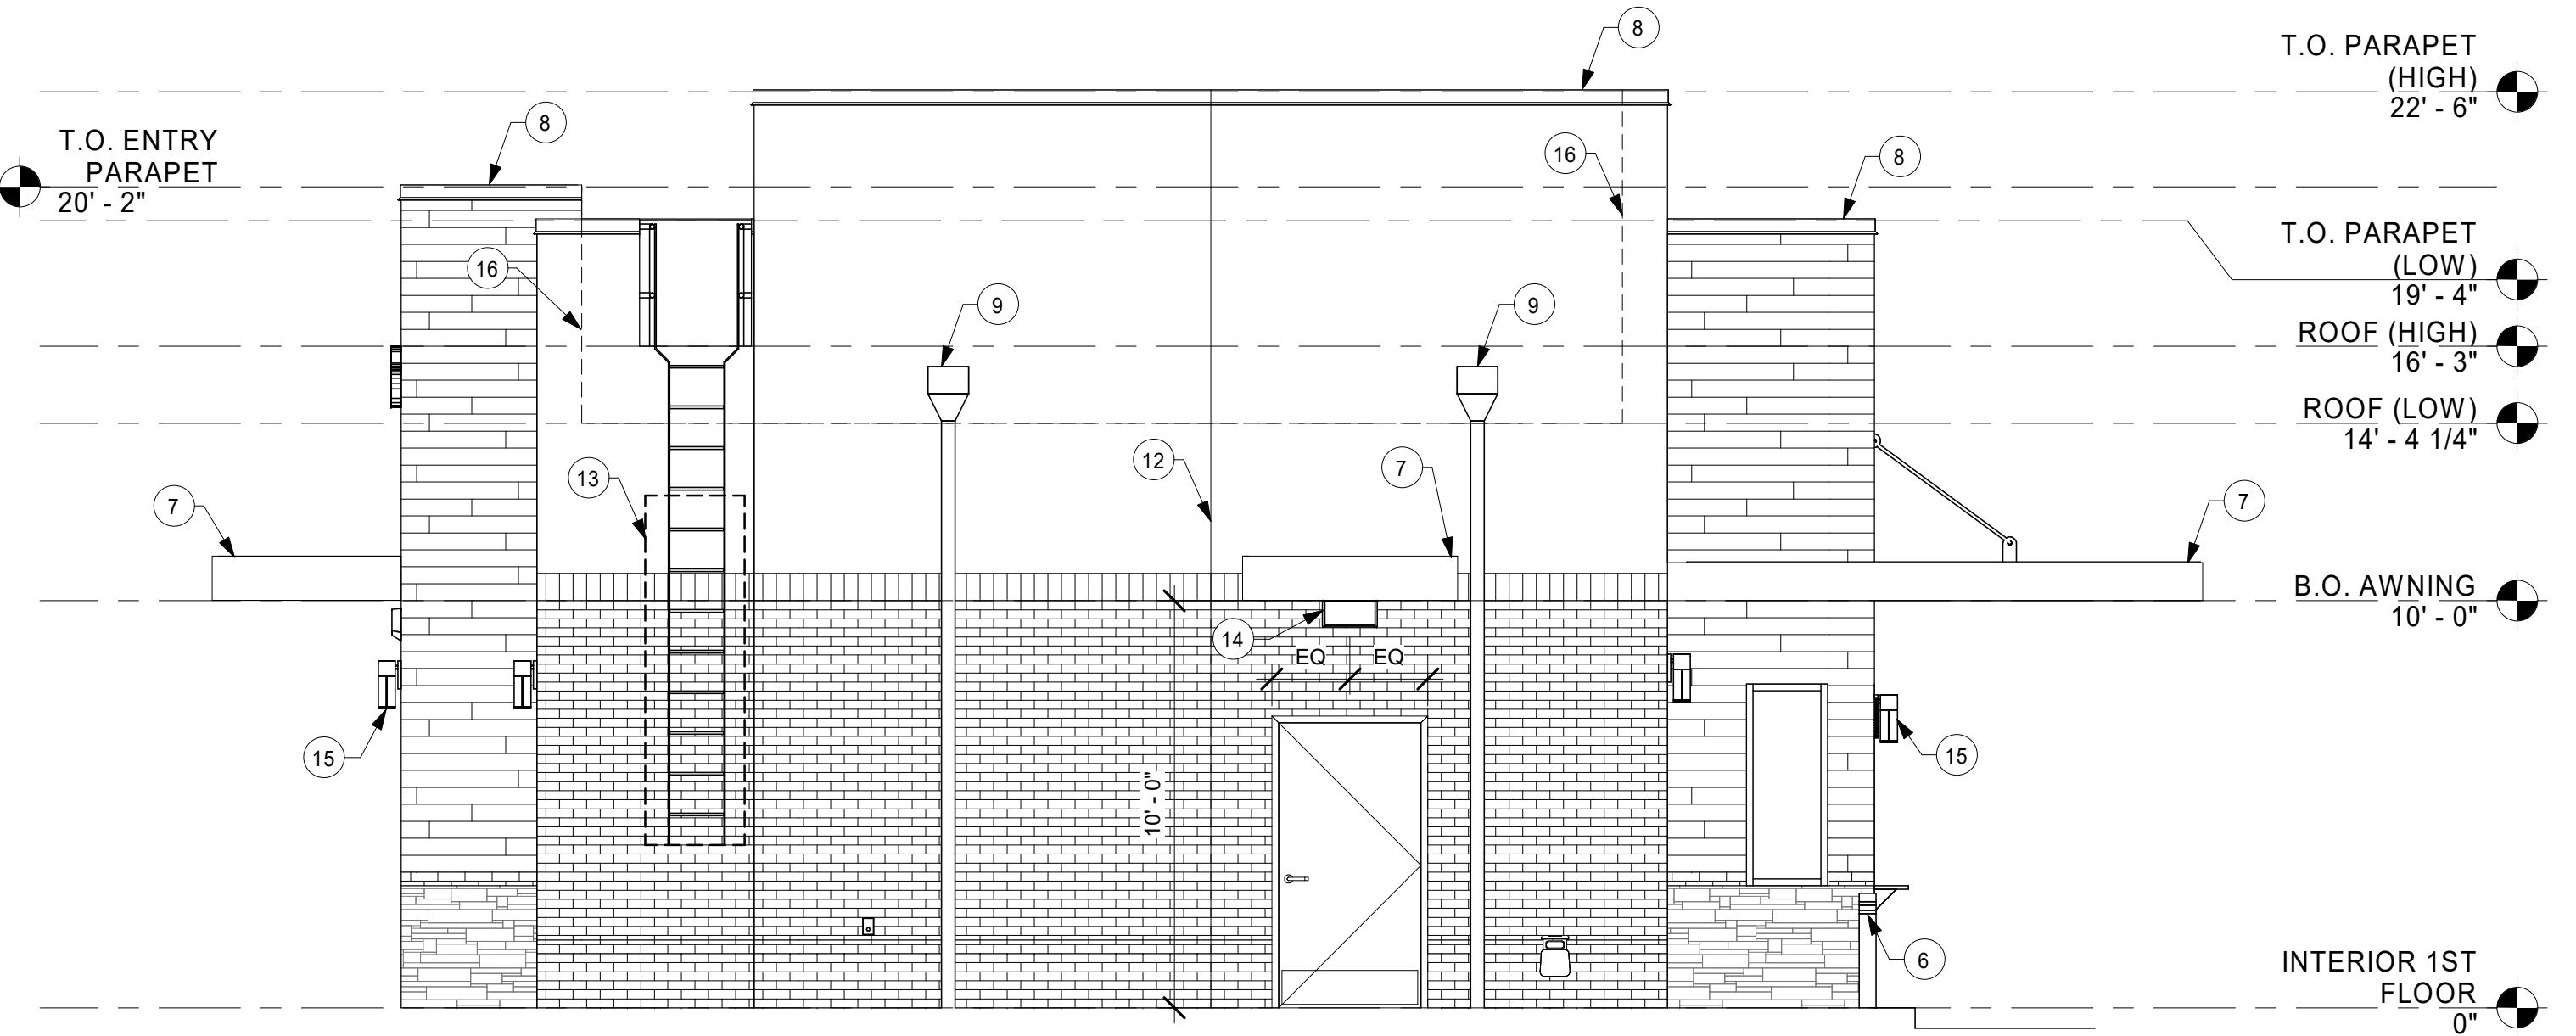
SHEET TITLE:
BUILDING EXTERIOR ELEVATIONS
SCALE: AS SHOWN

SHEET NUMBER:

A201

SIGNAGE TO BE SUBMITTED UNDER SEPARATE PERMIT BY OTHERS - SHOWN FOR REFERENCE ONLY.

DIMENSIONS OF BUILDING SHELL FOR REFERENCE ONLY



2 SOUTH ELEVATION


Scale: 1/4" = 1'-0"

KEYED NOTES

1. GC TO PROVIDE J-BOX W/ PULL STRING FOR FUTURE BUILDING SIGNAGE.
2. GC TO PROVIDE SIGNAGE DISCONNECT.
3. 3/4" MARINE GRADE PLYWOOD BLOCKING FOR EXTERIOR SIGNAGE, EXTEND BLOCKING 8" (205MM) MIN. BEYOND EDGE OF SIGNAGE.
4. FURNISH AND INSTALL TENANT SPECIFIED DRIVE THRU SERVICE WINDOW WITH ALL CONNECTIONS.
5. FURNISH AND INSTALL AIR CURTAIN AND FLY FAN AT DRIVE THRU WINDOW.
6. FURNISH AND INSTALL STARBUCKS 5" (130 MM) NONILLUMINATED BOLLARD. SEE DETAIL SHEET A003
7. NEW AWNING W/ ENCLOSED SIDES. GC TO PROVIDE IN-WALL BLOCKING AS NECESSARY FOR INSTALLATION.
8. EXISTING PRE-FINISHED METAL COPING.
9. EXISTING ROOF SCUPPER AND OVERFLOW.
10. FURNISH AND INSTALL SPEAKER AT 9'-6" A.F.F.
11. EXTERIOR PATIO AND SEATING. SEE FF & E PLAN (SHEET I-101) FOR PATIO LAYOUT
12. EXISTING CONTROL JOINT
13. GC TO PROVIDE BLOCKING TO ENSURE EXISTING LADDER IS SECURED TO WALL
14. EXISTING WALL PACK BY LANDLORD.
15. EXISTING EXTERIOR WALL SCONCE TYP.
16. OUTLINE OF ROOF BEYOND

GENERAL NOTES

- A. GENERAL CONTRACTOR TO COORDINATE AND SCHEDULE SIGNAGE INSTALLATION WITH THE SIGNAGE CONTRACTOR PROVIDING A MINIMUM SCHEDULING NOTICE OF 4 WEEKS AND 1 WEEK PRIOR TO SCHEDULED DATE OF INSTALLATION. CONSTRUCTION MANAGER TO PROVIDE GENERAL CONTRACTOR WITH SIGNAGE CONTRACTOR CONTACT INFORMATION.
- B. GENERAL CONTRACTOR SHALL COORDINATE WITH ELECTRICAL CONTRACTOR TO FURNISH AND INSTALL ELECTRICAL CIRCUITS INCLUDING ALL CONDUIT, WIRE, CONNECTIONS AND BREAKER AT PANEL BOARD NECESSARY TO SERVE SIGNAGE.
- C. GENERAL CONTRACTOR TO PROVIDE FIRE TREATED WOOD STUD BLOCKING OR EQUIVALENT TO SUPPORT SIGNAGE.
- D. SIGNAGE CONTRACTOR SHALL VERIFY SIZE AND LOCATION OF ANY AND ALL ALLOWABLE MONUMENT OR POLE SIGNAGE AND PROVIDE SHOP DRAWING(S) PRIOR TO FABRICATION TO THE STARBUCKS DESIGNER FOR APPROVAL.
- E. SIGNAGE CONTRACTOR TO INSTALL SIGNAGE IN COMPLIANCE WITH LOCAL CODES AND OBTAIN PERMIT.
- F. SIGNAGE CONTRACTOR TO SUPPLY SHOP DRAWINGS TO CONSTRUCTION MANAGER AND TO THE GENERAL CONTRACTOR AS NEEDED. GENERAL CONTRACTOR TO NOTIFY CONSTRUCTION MANAGER IMMEDIATELY IF SHOP DRAWINGS OR INSTALLATION IS IN DISCREPANCY WITH ARCHITECTURAL DRAWINGS.
- G. GENERAL CONTRACTOR TO CLEAN, PATCH AND REPAIR EXISTING EXTERIOR AS REQUIRED.

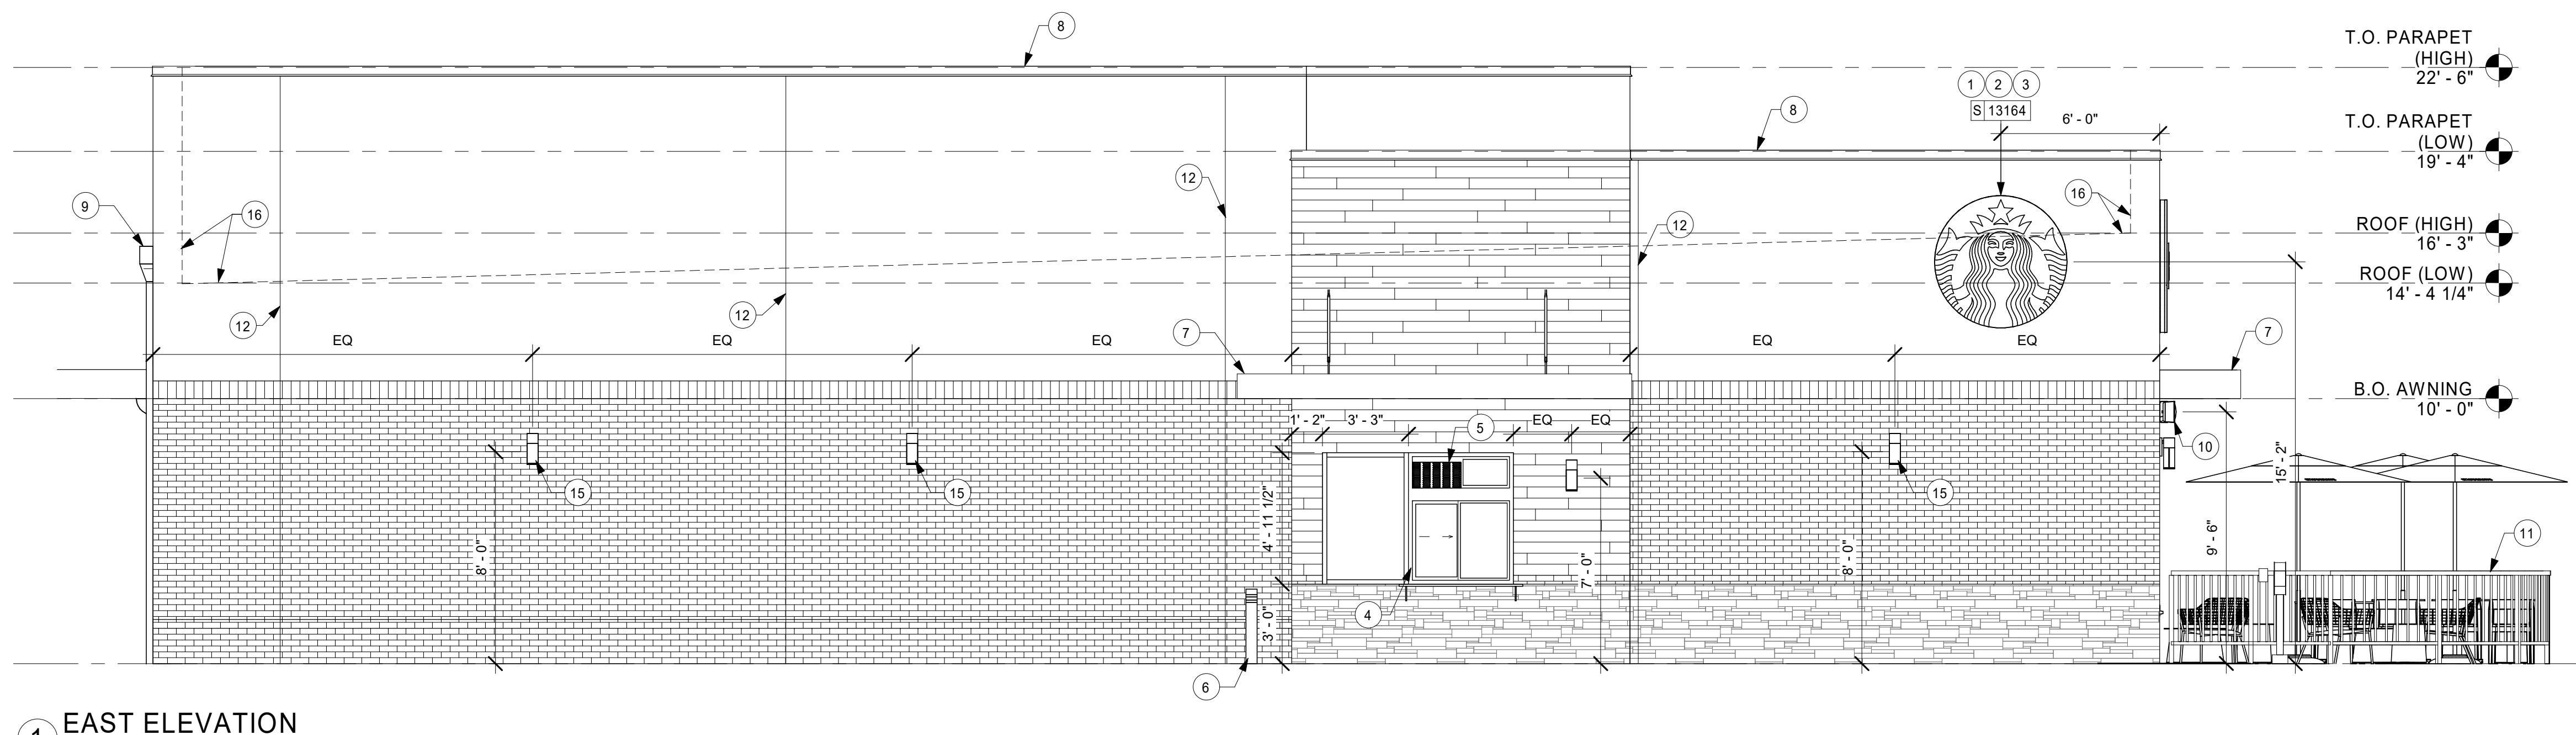

1 EAST ELEVATION

Scale: 1/4" = 1'-0"

0 2' 4' 8'
Scale: 1/4" = 1'-0"



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STATE OF GEORGIA
MARK S. SALOPEK
CERTIFIED AND SIGNED
01/03/2020

PROJECT NAME:
HWY 81 & LAKE DOW

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850 HWY 81
MCDONOUGH, GA 30252

STORE #: 59695
PROJECT #: 85535-001
ISSUE DATE: 12/03/2019
DESIGN MANAGER: RV
PRODUCTION DESIGNER: TW
CHECKED BY: GPD GROUP

Revision Schedule

Rev	Date	By	Description

SHEET TITLE:
BUILDING EXTERIOR ELEVATIONS
SCALE: AS SHOWN


SHEET NUMBER:
A202

KEYED NOTES

1. PROVIDE 3" (75MM) HIGH BLACK ACRYLIC STORE ADDRESS ON GLAZING OR PER LOCAL JURISDICTIONAL CODE REQUIREMENTS.
2. GC TO PROVIDE J-BOX W/ PULL STRING FOR FUTURE BUILDING SIGNAGE.
3. GC TO PROVIDE SIGNAGE DISCONNECT.
4. 3/4" MARINE GRADE PLYWOOD BLOCKING FOR EXTERIOR SIGNAGE. EXTEND BLOCKING 8" (205MM) MIN. BEYOND EDGE OF SIGNAGE.
5. FURNISH AND INSTALL SPEAKER AT 9'-6" A.F.F.
6. NEW AWNING W/ ENCLOSED SIDES. GC TO PROVIDE IN-WALL BLOCKING AS NECESSARY FOR INSTALLATION.
7. EXISTING PRE-FINISHED METAL COPING.
8. OUTLINE OF EXISTING ROOF BEYOND.
10. EXTERIOR PATIO AND SEATING. SEE FF & E PLAN (SHEET I-101) FOR PATIO LAYOUT
11. EXISTING EXTERIOR WALL SCONCE TYP.
12. OUTLINE OF ROOF BEYOND


GENERAL NOTES

- A. GENERAL CONTRACTOR TO COORDINATE AND SCHEDULE SIGNAGE INSTALLATION WITH THE SIGNAGE CONTRACTOR PROVIDING A MINIMUM SCHEDULING NOTICE OF 4 WEEKS AND 1 WEEK PRIOR TO SCHEDULED DATE OF INSTALLATION. CONSTRUCTION MANAGER TO PROVIDE GENERAL CONTRACTOR WITH SIGNAGE CONTRACTOR CONTACT INFORMATION.
- B. GENERAL CONTRACTOR SHALL COORDINATE WITH ELECTRICAL CONTRACTOR TO FURNISH AND INSTALL ELECTRICAL CIRCUITS INCLUDING ALL CONDUIT, WIRE, CONNECTIONS AND BREAKER AT PANEL BOARD NECESSARY TO SERVE SIGNAGE.
- C. GENERAL CONTRACTOR TO PROVIDE FIRE TREATED WOOD STUD BLOCKING OR EQUIVALENT TO SUPPORT SIGNAGE.
- D. SIGNAGE CONTRACTOR SHALL VERIFY SIZE AND LOCATION OF ANY AND ALL ALLOWABLE MONUMENT OR POLE SIGNAGE AND PROVIDE SHOP DRAWING(S) PRIOR TO FABRICATION TO THE STARBUCKS DESIGNER FOR APPROVAL.
- E. SIGNAGE CONTRACTOR TO INSTALL SIGNAGE IN COMPLIANCE WITH LOCAL CODES AND OBTAIN PERMIT.
- F. SIGNAGE CONTRACTOR TO SUPPLY SHOP DRAWINGS TO CONSTRUCTION MANAGER AND TO THE GENERAL CONTRACTOR AS NEEDED. GENERAL CONTRACTOR TO NOTIFY CONSTRUCTION MANAGER IMMEDIATELY IF SHOP DRAWINGS OR INSTALLATION IS IN DISCREPANCY WITH ARCHITECTURAL DRAWINGS.
- G. GENERAL CONTRACTOR TO CLEAN, PATCH AND REPAIR EXISTING EXTERIOR AS REQUIRED.

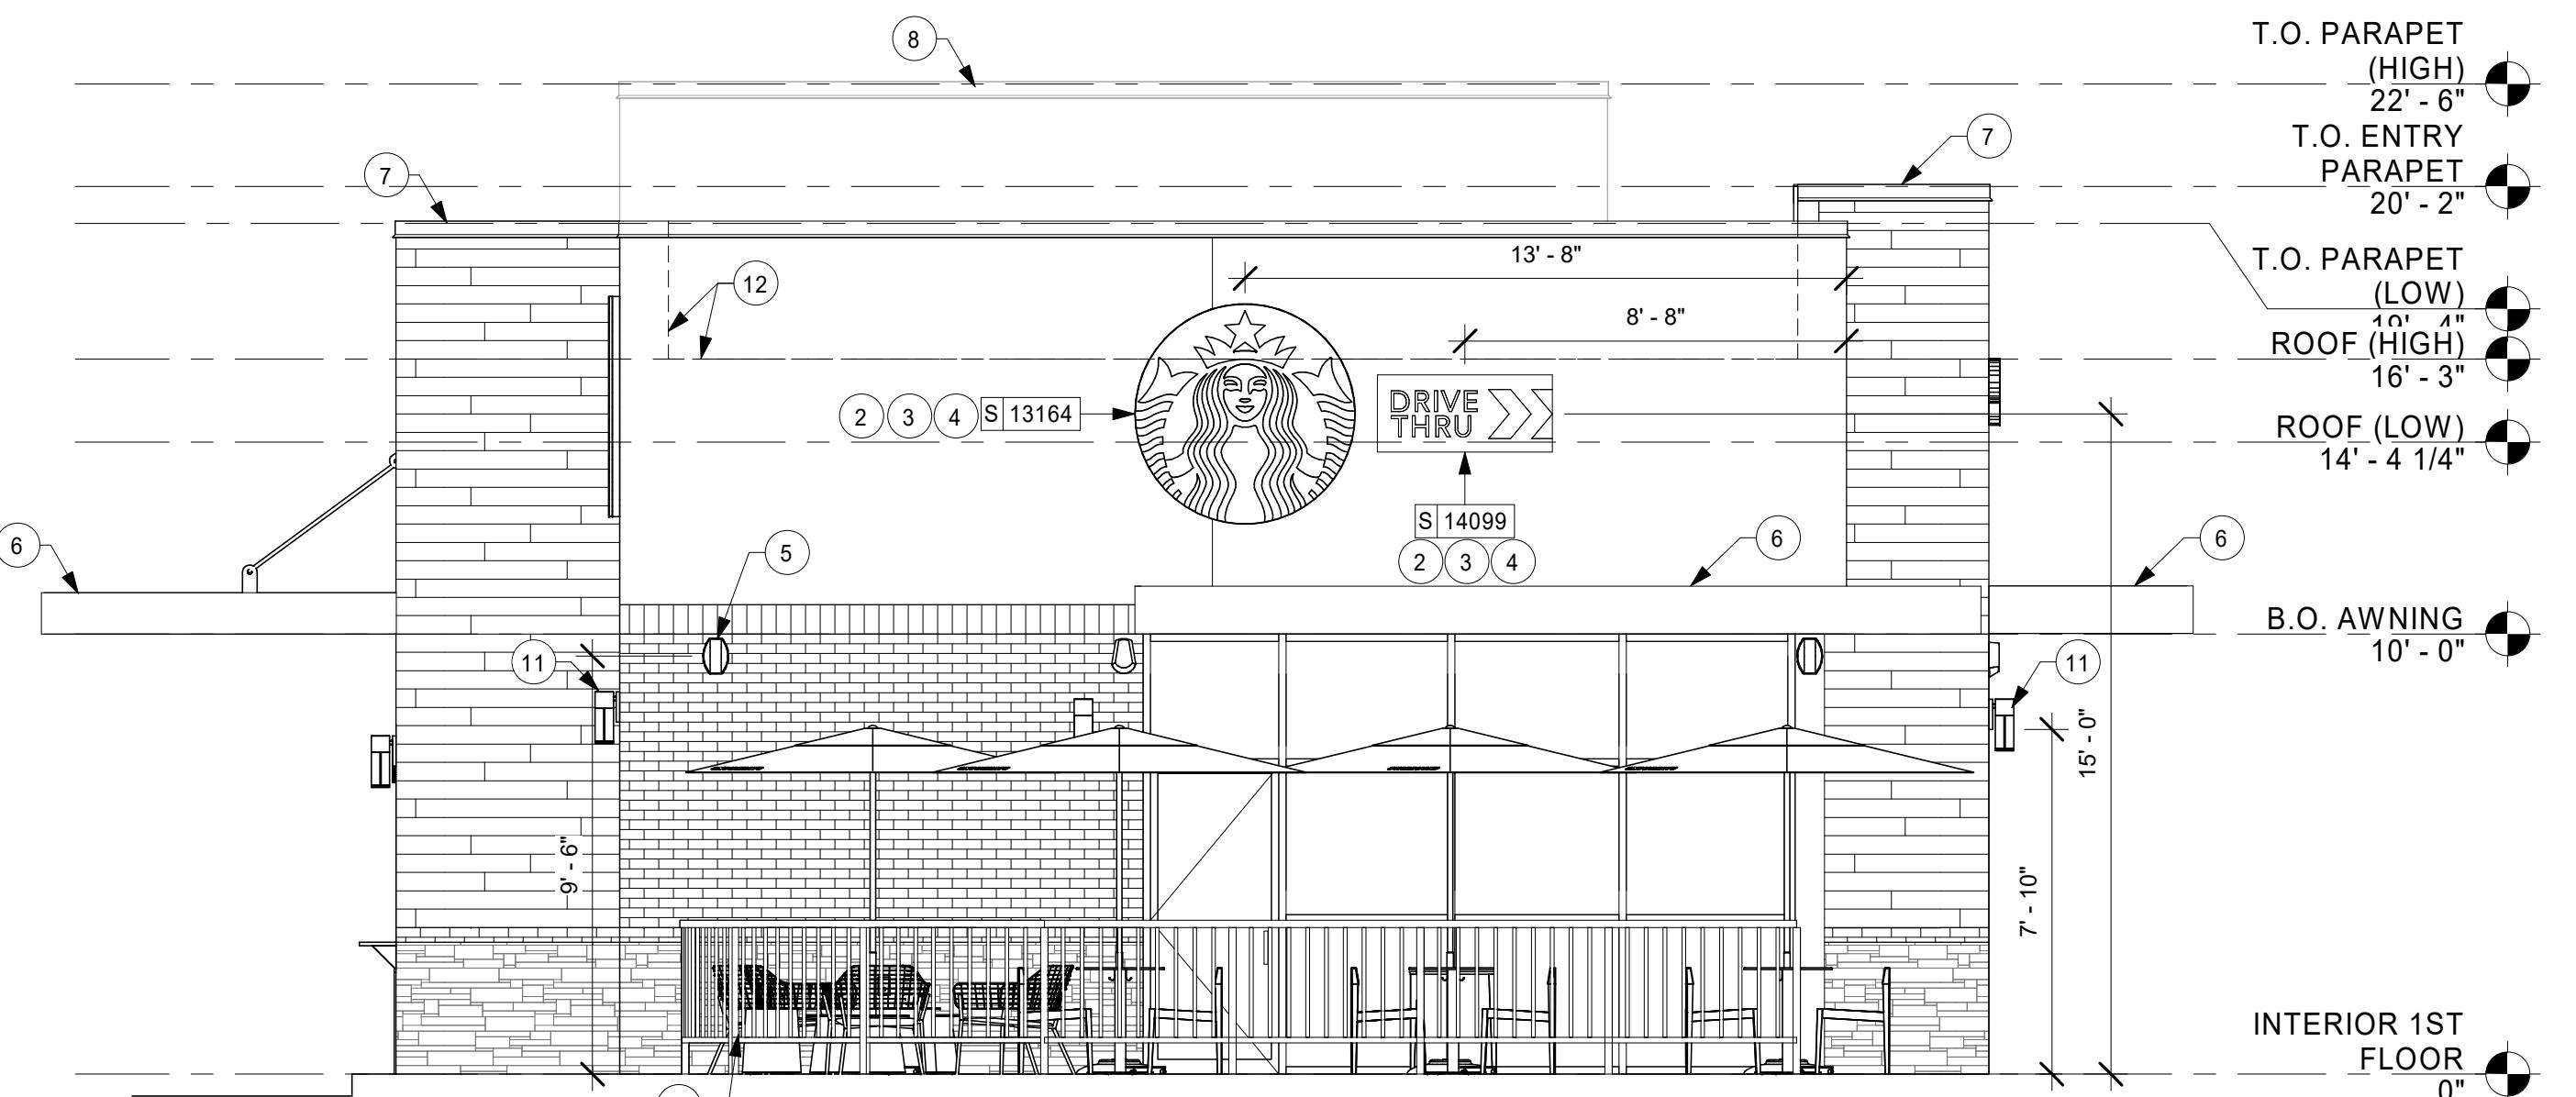

2 NORTH ELEVATION

Scale: 1/4" = 1'-0"

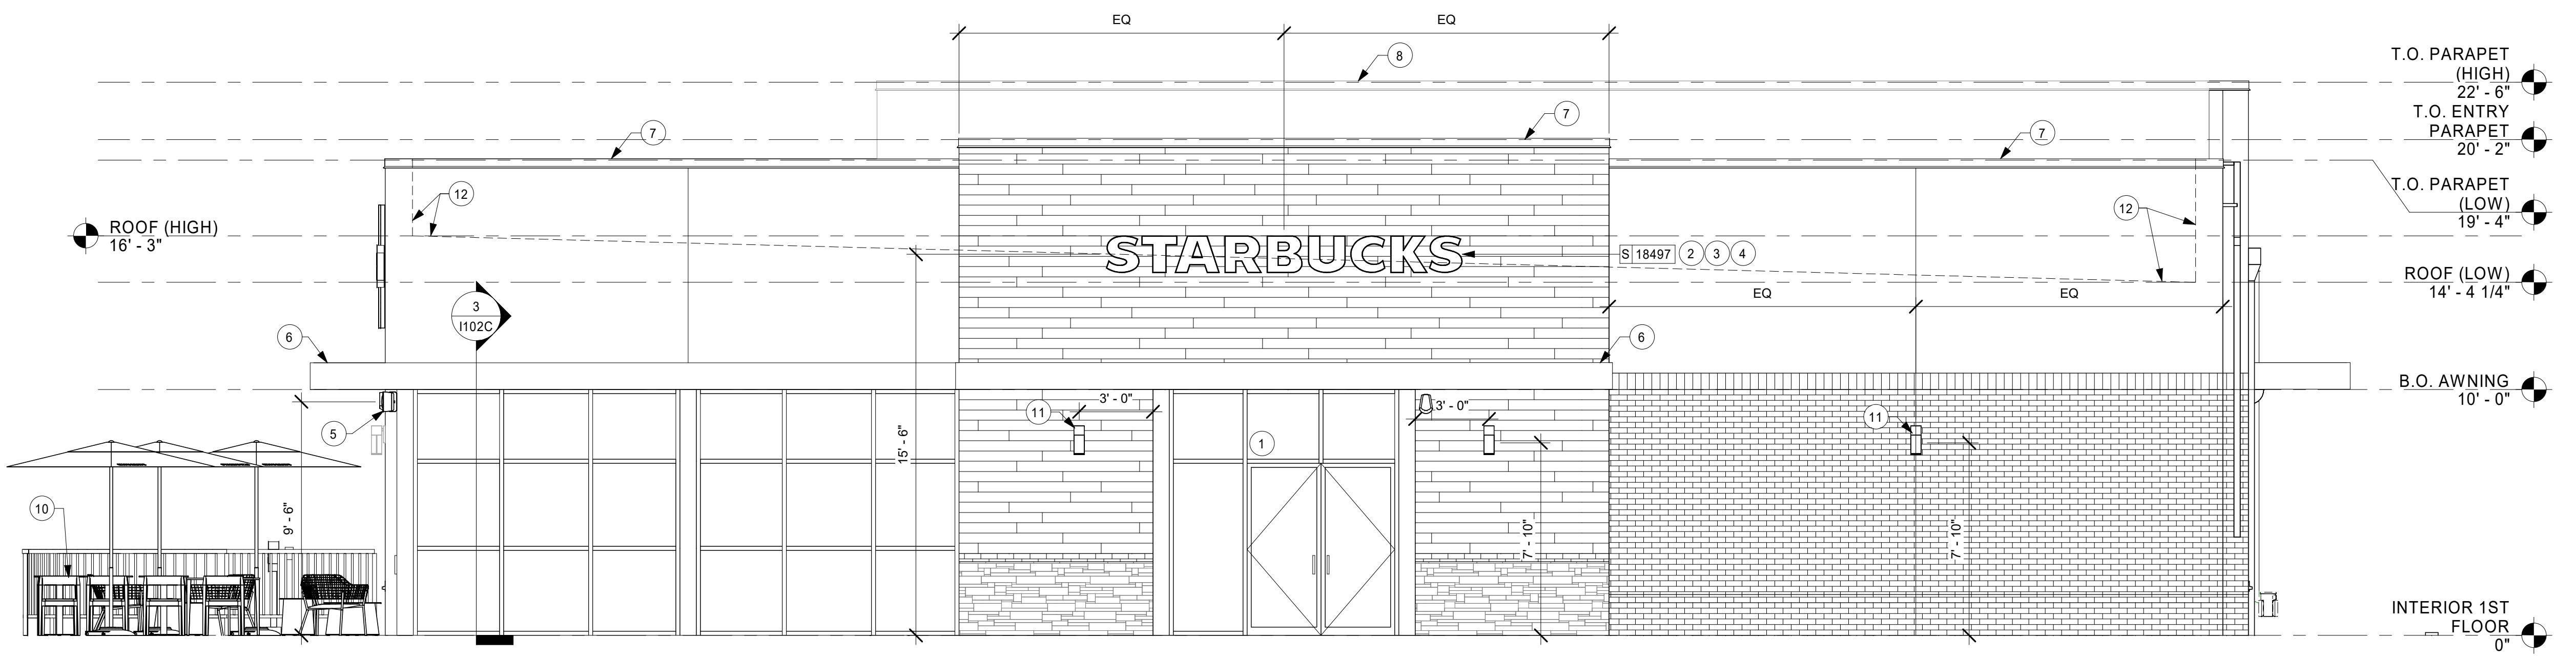


1 WEST ELEVATION

Scale: 1/4" = 1'-0"

EXTERIOR DOOR SCHEDULE - "D"						
DESIGN ID	COUNT	DESCRIPTION	FURN. BY	INST. BY	HARDWARE TYPE	COMMENTS
DOOR						
10205	1	DOOR - STOREFRONT METAL FRAME SINGLE - TYPE B	LL	LL	2-A	
10449	1	DOOR - STOREFRONT METAL FRAME DOUBLE - TYPE A	LL	LL	3-A	
X10190	1	DOOR - SINGLE FLUSH - 42IN	LL	LL	12	

EXTERIOR DOOR LEGEND

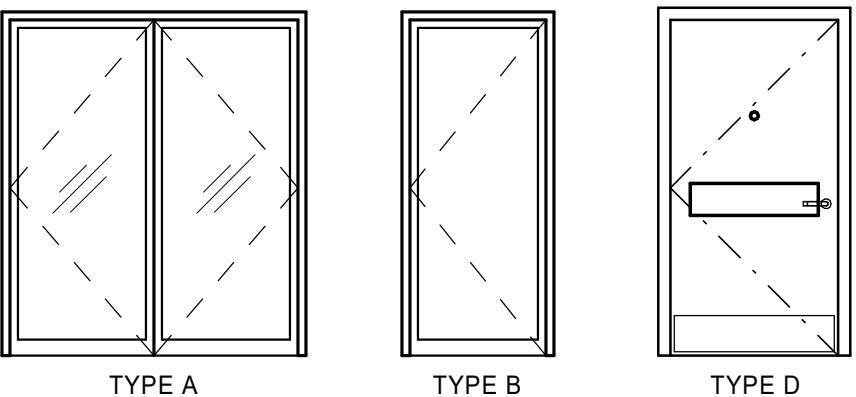

INTERIOR DOOR SCHEDULE - "D"						
DESIGN ID	COUNT	DESCRIPTION	FURN. BY	INST. BY	Type Mark	HARDWARE TYPE
DOOR						
10086	1	DOOR - SINGLE IMPACT DOUBLE ACTING - 36IN 915MM	SB	GC	TYPE F 11	WILSONART-CRYSTAL D388-60 MATTE FINISH. FRAME: SW 7646 (SG) FIRST STAR
10190	2	DOOR - SINGLE FLUSH - 36IN	SB	GC	TYPE E 7	FRAME: SW 7020 (SG) BLACK FOX
10207	1	DOOR - SINGLE FLUSH - 24IN	SB	GC	TYPE E 9	DOOR AND FRAME: SW 7020 (SG) BLACK FOX

GENERAL NOTES


- A. STARBUCKS VENDOR TO PROVIDE DOOR HARDWARE COMPONENTS. GC TO INSTALL.
- B. SEE SHEET A101 FOR TAGGED LOCATION OF EXTERIOR DOORS AND WINDOWS.
- C. EGRESS SHALL NOT PASS THROUGH KITCHENS, STORAGE ROOMS, CLOSETS OR SIMILAR SPACES. (1014.2)
- D. PANIC AND FIRE EXIT HARDWARE, WHERE INSTALLED ON DOORS IN THIS BUILDING SHALL SATISFY THE FOLLOWING (1008.1.10):
 - a) THE ACTUATION PORTION OF THE RELEASING DEVICE SHALL EXTEND AT LEAST ONE-HALF OF THE DOOR LEAF WIDTH.
 - b) THE MAXIMUM UNLATCHING FORCE DOES NOT EXCEED 15 POUNDS (6.8 KG).
 - c) PIVOTED OR BALANCED DOORS SHALL BE OF THE PUSH-PAD TYPE WHERE PANIC HARDWARE IS REQUIRED AND THE PAD SHALL NOT EXTEND ACROSS MORE THAN ONE-HALF OF THE DOOR WIDTH, MEASURED FROM THE LATCH SIDE.
 - d) PANIC HARDWARE LISTED IN ACCORDANCE WITH UL 305.
 - e) FIRE EXIT HARDWARE LISTED IN ACCORDANCE WITH UL 10C AND UL 305.



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STARBUCKS TEMPLATE VERSION: i2019-07-26



PROJECT NAME:
HWY 81 & LAKE DOW

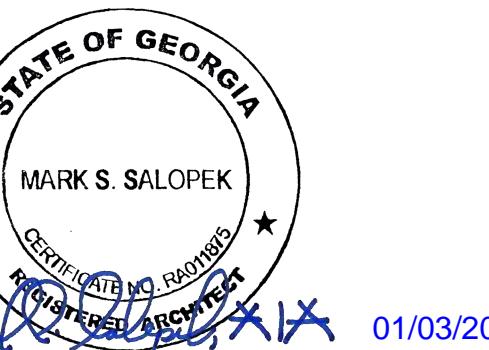PROJECT ADDRESS:
850 HWY 81
MCDONOUGH, GA 30252

STORE #: 59695
PROJECT #: 85535-001
ISSUE DATE: 12/03/2019
DESIGN MANAGER: RV
PRODUCTION DESIGNER: TW
CHECKED BY: GPD GROUP

Revision Schedule			
Rev	Date	By	Description

SHEET TITLE:
WINDOW AND DOOR SCHEDULES & DETAILS
SCALE: AS SHOWN

SHEET NUMBER:


A602

DOOR HARDWARE SET NO. 2-A - For new single aluminum secondary entry/exit door (50 or more occupancy)				
No.	Item	Description	Manufacturer	Finish
3	Hanging Devices	TH2314/MPB91	McKinney	630
1	Securing Devices	CD35A-NL-OP Panic Device	Von Duprin	628/630
2	Securing Devices	C607 7-Pin Core Combined "A" Keyway	Falcon Lock	626
1	Securing Devices	KB609-2 Cut Control Key "A" Keyway	Falcon Lock	---
9	Securing Devices	KB632-2 Cut User Key "A" Keyway	Falcon Lock	---
1	Securing Devices	C953 7-Pin Rim Cylinder Housing	Falcon Lock	626
1	Securing Devices	C987 7-Pin Mortise Cylinder Housing w/AR Cam	Falcon Lock	626
1	Securing Devices	A08794-003 Adjustable Ring, Mortise Cyl. 5.16-13/32	Falcon Lock	626
1	Operating Trim	108 Door Pull Handle	Rockwood	630
1	Closing Devices	8916 Door Closer 8916 AF89P	Dorma	689
1	Stops and Holders	473 Door Stop w/ Hook	Rockwood	626
1	Threshold	325 Half Saddle Threshold	National Guard	---
1	Sign	Vinyl Sign: "THIS DOOR MUST REMAIN UNLOCKED WHEN BUILDING IS OCCUPIED"	Seton	---

DOOR HARDWARE SET NO. 3-A - For pair aluminum main entry/exit doors (300 or less occupancy)				
No.	Item	Description	Manufacturer	Finish
6	Hanging Devices	TH2314/MPB91	McKinney	630
1	Securing Devices (active leaf)	MS1850S Deadbolt	Adams Rite	626
1	Securing Devices (inactive...)	MS1880 Two-Point Flushbolt	Adams Rite	626
2	Securing Devices (active leaf)	C607 7-Pin Core Combined "A" Keyway	Falcon Lock	626
1	Securing Devices (active leaf)	KB609-2 Cut Control Key "A" Keyway	Falcon Lock	---
9	Securing Devices (active leaf)	KB632-2 Cut User Key "A" Keyway	Falcon Lock	---
2	Securing Devices (active leaf)	C987 7-Pin Mortise Cylinder Housing w/AR Cam	Falcon Lock	626
2	Securing Devices (active leaf)	A08794-003 Adjustable Ring, Mortise Cyl. 5.16-13/32	Falcon Lock	626
2	Operating Trim	108 Door Pull Handle	Rockwood	630
2	Operating Trim	48 Push Bar x 31	Rockwood	630
2	Closing Devices	8916 Door Closer 8916 AF89P AL	Dorma	689
2	Stops and Holders	473 Door Stop w/ Hook	Rockwood	626
2	Accessories	Door Sweep 18062CNB36	Pemko	A
1	Threshold	325 Half Saddle Threshold	National Guard	---
1	Sign	Vinyl Sign: "THIS DOOR MUST REMAIN UNLOCKED WHEN BUILDING IS OCCUPIED"	Seton	---

DOOR HARDWARE SET NO. 12 - For secondary 36" wide service door				
No.	Item	Description	Manufacturer	Finish
3	Hanging Devices	TH2314/MPB91 Hinge MacPro Bearing 4.5 x 4.5	McKinney	630
1	Securing Devices	C607 7-Pin Core Combined "A" Keyway	Falcon Lock	626
1	Securing Deices	I/O 2000L-03IC Auto Locking Door Alarm, IC: No CTR Includes Mortise Cylinder	Sur-Lock	---
1	Closing Devices	8916 Door Closer 8916 AF89P	Dorma	689
1	Protective Trim Units	K1050 B4E Kickplate 8" x 34"	Rockwood	630
1	Accessories	137NA Weather Strip 17" 36" x 84"	National Guard	A
1	Accessories	Door Sweep 18062CNB36	Pemko	A
1	Miscellaneous Items	DS/1000 Door Scope	Security...	Silver
1	Miscellaneous Items	MCV309NWHGL Door Bell	Nutone	As Selected

INTERIOR DOOR LEGEND

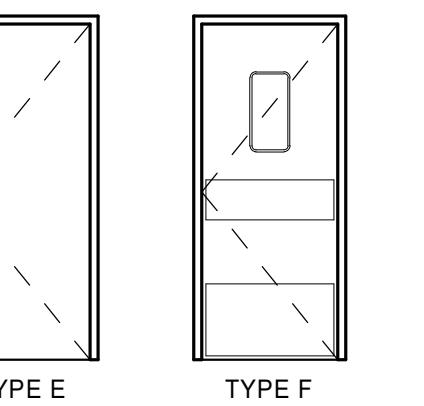

DOOR HARDWARE SET NO. 7 - For restroom door with lever and keyed lock

No.	Item	Description	Manufacturer	Finish
3	Hanging Devices	TA2714/MPB79 Hinge MacPro Bearing 4.5 x 4.5	McKinney	626
1	Securing Devices	B-PB5405LN Lever Storeroom LC B-PB5405LN-693-497 1-3/4	Yale Lock	626
1	Securing Devices	C607 7-Pin Core Combined "A" Keyway	Falcon Lock	626
1	Closing Devices	8916 Door Closer 8916 AF89P	Dorma	689
2	Protective Trim Units	K1050 B4E Kickplate 8" x 34" each site 32D	Rockwood	630
3	Accessories	GJ64 Rubber Silencer	Glynn Johnson	Gray
1	Stops and Holders	473 Door Stop w/ Hook 26D	Rockwood	626

DOOR HARDWARE SET NO. 9 - For utility/closet door with lever passage and no lock

No.	Item	Description	Manufacturer	Finish
3	Hanging Devices	TA2714/MPB79 Hinge MacPro Bearing 4.5 x 4.5	McKinney	626
1	Securing Devices	PB5401LN Lever Passage PB5401LN-69		



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SEATTLE, WASHINGTON 98134
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HEALTH DEPT. FINISH SCHEDULE

BAR:

FLOOR: CERAMIC TILE
WALL: WALL TILE, BACKSPLASH, WITH 6" COVE TILE BASE
CEILING: GYPSUM CEILING

CAFE:

FLOOR: CERAMIC TILE WITH WALK OFF MATS
WALL: VINYL WALL COVERING, STOREFRONT,
PAINTED GYPSUM WALL BOARD WITH 6" COVE TILE BASE
CEILING: GYPSUM CEILING & EXPOSED STRUCTURE

WORKROOM:

FLOOR: CERAMIC TILE
WALL: FRP AND WITH 6" COVE TILE BASE
CEILING: ACOUSTICAL TILE CEILING

RESTROOMS:

FLOOR: CERAMIC TILE
WALL: WALL TILE
CEILING: GYPSUM CEILING

HEALTH DEPT. PLAN NOTES

A. GENERAL CONTRACTOR TO SCHEDULE WITH LOCAL REFRIGERATION CONTRACTOR TO CONDUCT INITIAL FOOD CASE START-UP AND TESTING. FOR APPROVED CONTRACTOR, CONTACT VENDOR.

B. THE SPACE IS SERVED BY THE MUNICIPAL WATER AND SEWER SYSTEM UNLESS OTHERWISE NOTED.

C. ALL EQUIPMENT AND INSTALLATION WILL MEET NATIONAL SANITATION FOUNDATION STANDARDS OR EQUIVALENT.

D. EQUIPMENT UNITS SHALL CONTAIN NO EXPOSED THREADS, EMBELLISHMENTS OR OVERHANGING EDGES THAT SERVE AS PLACES FOR ACCUMULATION OF DUST, DIRT AND DEBRIS.

E. WARMING OVEN(S) SHOWN FOR PERMITTING PURPOSES. INSTALLATION AT STORE OPENING TO BE VERIFIED BY STARBUCKS CONSTRUCTION REPRESENTATIVE.

F. EACH HAND WASHING SINK WILL HAVE A SINGLE SERVICE TOWEL AND SOAP DISPENSER, AND ALL HAND SINKS TO HAVE A COMBINATION FAUCET OR PREMIXING FAUCET.

G. SEE SHEETS I-6001 & I-6002 FOR SCHEDULES.

KEYED NOTES

1. INSTALL EXTERIOR FURNITURE THROUGHOUT AS SHOWN.
2. INSTALL CAFE FURNITURE THROUGHOUT AS SHOWN.
3. COMMUNITY TABLE. SEE FURNITURE SCHEDULE.
4. COMMUNITY BOARD. SEE INTERIOR FINISH ELEVATIONS.
5. CONDIMENTS CART. SEE INTERIOR FINISH ELEVATIONS.
6. MERCHANDISE DISPLAY. SEE DETAILS X/50X FOR MORE INFORMATION. ALIGN FRONT OF MERC. BAYS WITH STOREFRONT DOOR FRAME. CENTER MERC. BAYS WITH CENTERLINE OF WALL BEHIND.
7. DO NOT BLOCK FOOD CASE INTAKE/EXHAUST.
8. SAFE LOCATED AT POS CABINET. SEE ELECTRICAL FOR ADDITIONAL INFORMATION.
9. HAND SINK W/ INTEGRAL SPLASH GUARD.
10. INSTALL CORNER GUARD AS INDICATED. SEE INTERIOR FINISH ELEVATIONS.
11. LOCATION OF SWITCH GEAR AND THERMOSTAT CONTROLS.
12. LOCATION OF FIRE EXTINGUISHER.
13. SECURE LOCKERS TO WALL.
14. VENDOR TO INSTALL WATER FILTRATION SYSTEM PER MANUFACTURER'S REQUIREMENTS. G.C. TO PROVIDE PLUMBING AND ELECTRICAL REQUIREMENTS.
15. WATER HEATER. SEE PLUMBING DRAWINGS.
16. G.C. TO REVERSE HINGE ON U.C. REFRIGERATOR TO LEFT HAND SWING AS SHOWN.
17. MANAGERS DESK. SEE MANAGER'S DESK/EQUIPMENT RACK/ELECTRICAL DETAIL FOR ADDITIONAL INFORMATION.
18. LOCATION OF ELECTRICAL PANELS


GENERAL NOTES

- A. GENERAL CONTRACTOR TO SCHEDULE WITH LOCAL REFRIGERATION CONTRACTOR TO CONDUCT INITIAL FOOD CASE START-UP AND TESTING. FOR LIST OF APPROVED START UP CONTRACTORS, CONTACT PROJECT CONSTRUCTION REPRESENTATIVE.
- B. THE SITE IS SERVED BY THE MUNICIPAL WATER AND SEWER SYSTEM UNLESS OTHERWISE NOTED.
- C. ALL FOOD STORAGE SHALL BE 6" (150mm) A.F.F.
- D. ALL WOOD SURFACES (DOORS, TRIM, SHELVES, CABINETS) SHALL BE SEALED.
- E. ALL EQUIPMENT AND INSTALLATION WILL MEET NATIONAL SANITATION FOUNDATION STANDARDS OR EQUIVALENT.
- F. ALL EQUIPMENT AND CABINETRY WILL BE FLUSH MOUNTED TO COUNTERS, WALLS OR FLOORS, OR BE RAISED TO ALLOW FOR CLEANING.
- G. CONFIRM ALL NECESSARY EQUIPMENT CLEARANCES PER PRODUCT CUT SHEET (E.G. ICE MACHINE).
- H. FOR LOCATION OF COUNTERTOP EQUIPMENT, REFER TO CASEWORK ELECTRICAL DETAILS.
- I. EQUIPMENT UNITS SHALL CONTAIN NO EXPOSED THREADS, EMBELLISHMENTS OR OVERHANGING EDGES THAT SERVE AS PLACES FOR ACCUMULATION OF DUST, DIRT AND DEBRIS.
- J. WARMING OVEN(S) SHOWN FOR PERMITTING PURPOSES. INSTALLATION AT STORE OPENING TO BE VERIFIED BY STARBUCKS CONSTRUCTION REPRESENTATIVE.
- K. EACH HAND WASHING SINK WILL HAVE A SINGLE SERVICE TOWEL AND SOAP DISPENSER, AND ALL HAND SINKS TO HAVE A COMBINATION FAUCET OR PREMIXING FAUCET.
- L. FOR PLUMBING FIXTURES, REFER TO THE PLUMBING DESIGN PLAN, FOR DATA DEVICE SCHEDULE, REFER TO THE ELECTRICAL DESIGN PLAN.
- M. SEE ELEVATIONS FOR DISTRIBUTION OF CUP DISPENSERS.
- N. PROVIDE FIRE EXTINGUISHERS AS NOTED ON THE APPROVED PLANS FROM THE LOCAL JURISDICTION.
- O. GENERAL CONTRACTOR TO COORDINATE NEWSPAPER FIXTURE ORDERING. CONTACT TRIAD MANUFACTURING BY EMAIL (starbucks@triadmfg.com) OR BY PHONE (314-381-5280 X1111) TO ARRANGE SHIPMENT OF THE FIXTURE. ALLOW (5) DAY LEAD-TIME.

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STARBUCKS TEMPLATE VERSION: I2019-07-26

GPD GROUP
Professional Corporation
520 SOUTH MAIN ST, SUITE 2501
AKRON, OH 44311
P: 330-572-2100 F: 330-572-2101
GPD PROJECT NO: 2019261.12

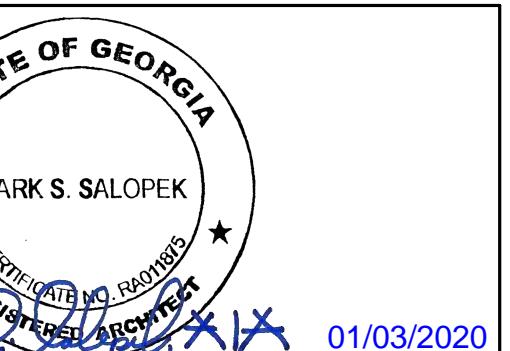

PROJECT NAME:
HWY 81 & LAKE DOW

PROJECT ADDRESS:
850 HWY 81
MCDONOUGH, GA 30252

STORE #: 59695
PROJECT #: 85535-001
ISSUE DATE: 12/03/2019
DESIGN MANAGER: RV
PRODUCTION DESIGNER: TW
CHECKED BY: GPD GROUP


Revision Schedule			
Rev	Date	By	Description

SHEET TITLE:
FF & E PLAN

SCALE: AS SHOWN

SHEET NUMBER:

1101

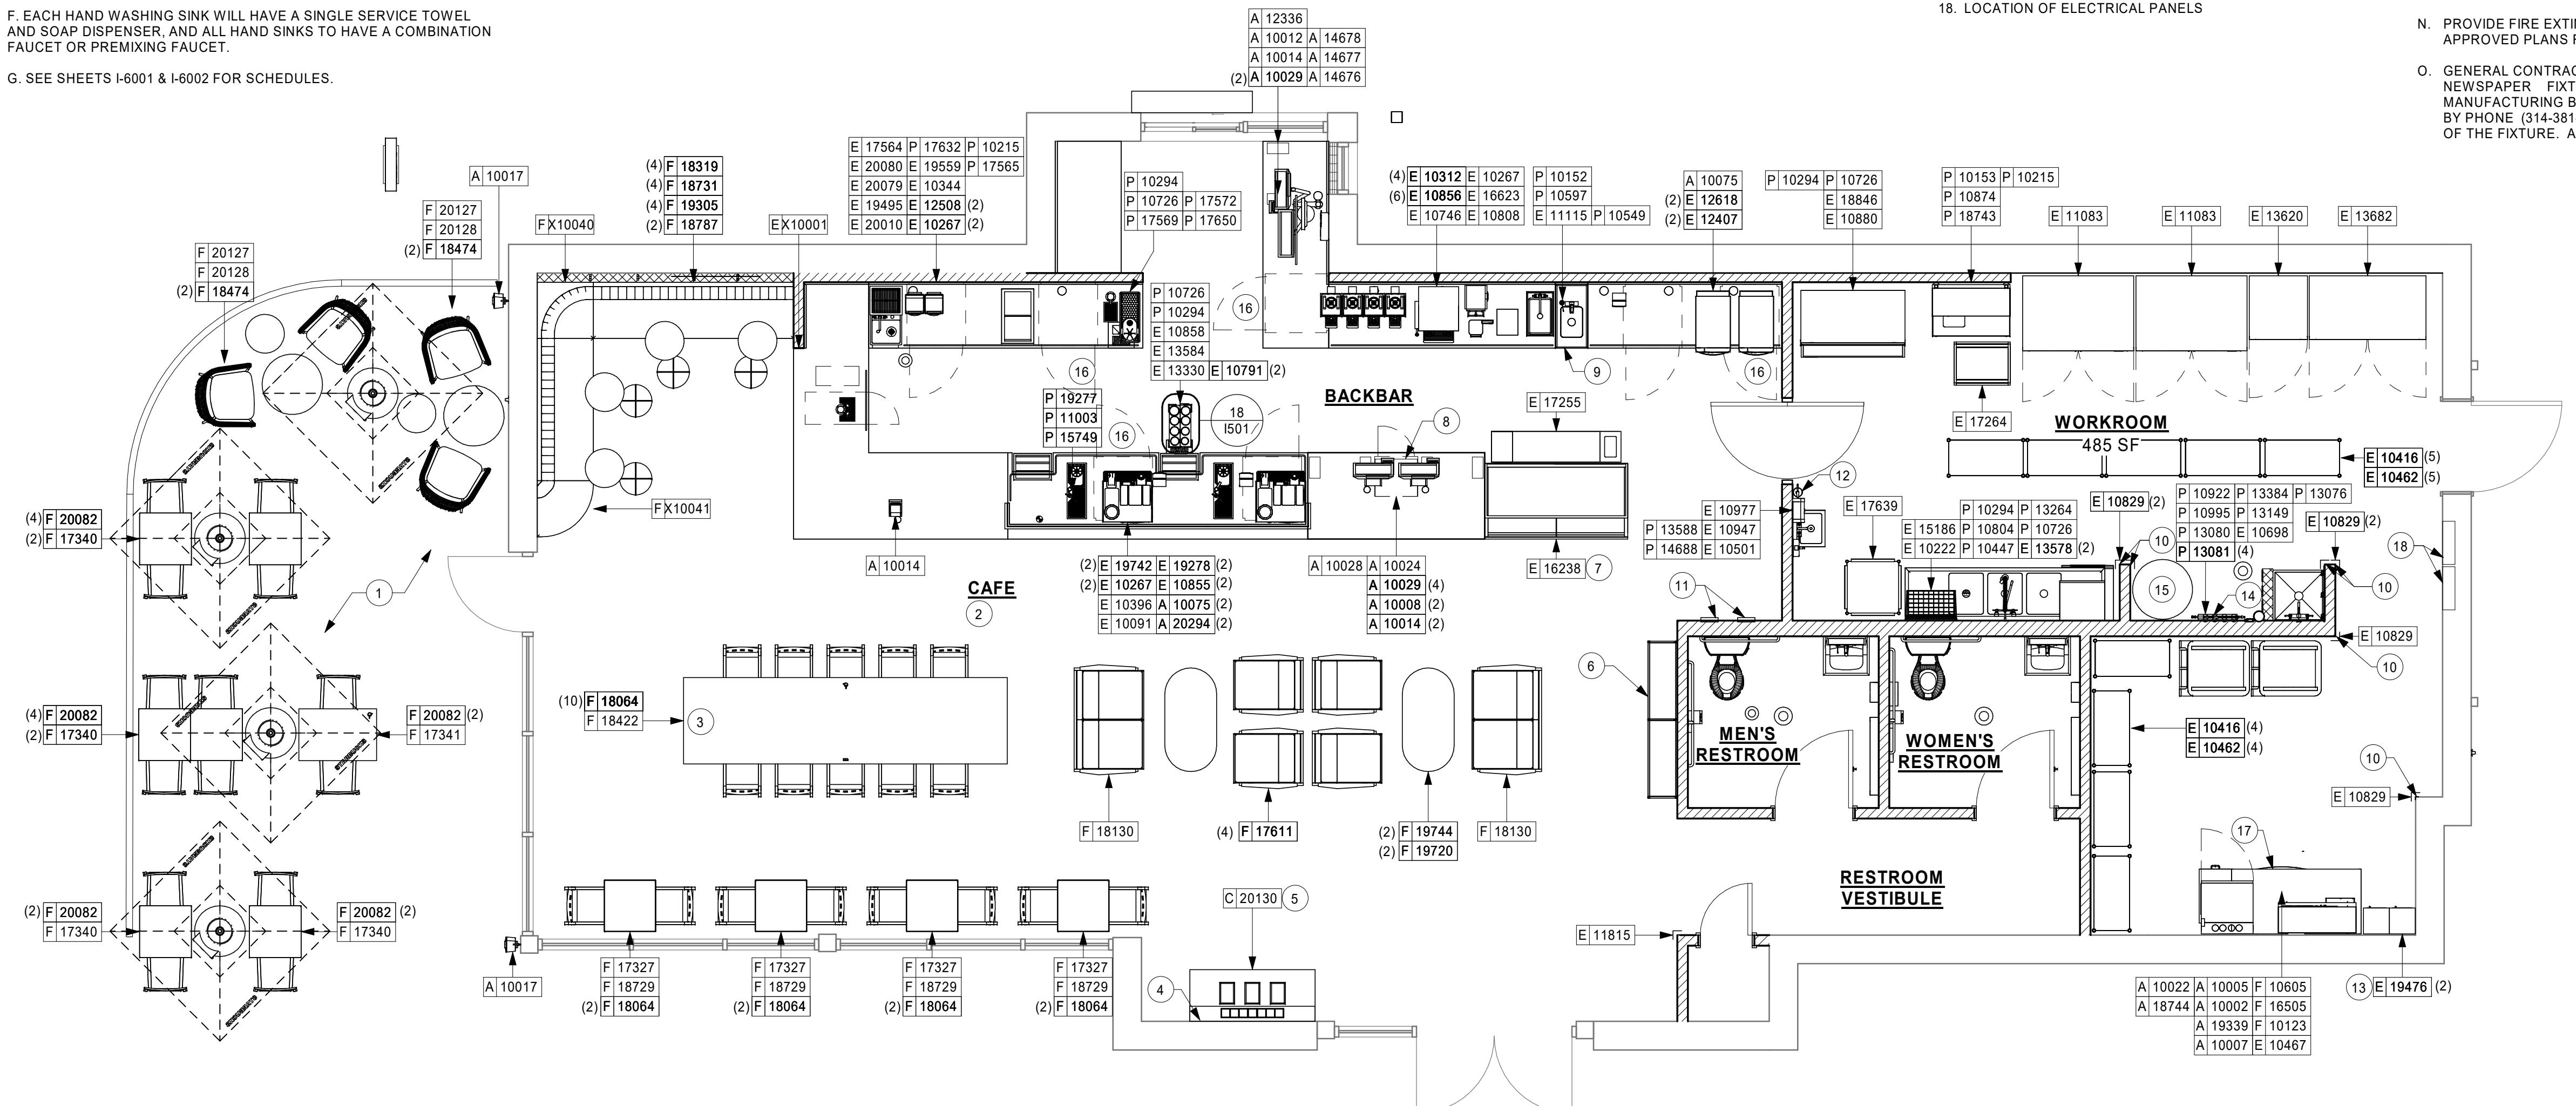

1ST FLOOR - FURNITURE, FIXTURES, AND EQUIPMENT PLAN

PLUMBING FIXTURE SCHEDULE - "P"						
DESIGN ID	COUNT	DESCRIPTION	FURN. BY	INST. BY	COMMENTS	
X0101	3	FLOOR DRAIN	GC	GC	ZURN FD2209, ADJUSTABLE FLOOR DRAIN, 3" HUB OUTLET, NICKEL BRONZE TOP.	
X0102	2	FLOOR CLEANOUT	GC	GC	ZURN ZN1400, ADJUSTABLE FLOOR CLEANOUT, NICKEL BRONZE FRAME AND COVER.	
X0103	1	RECIRCULATING PUMP	GC	GC	BELL AND GOSSET MODEL NBF-18S, 120V, 100 WATT, WITH AQUASTAT	
DRAIN						
10294	5	DRAIN - FLOOR SINK SQUARE - 12IN 305MM	SB	GC	ZURN FD2372-H, A.R.E. FLOOR SINK WITH 6" SUPM DEPTH AND 1/2 GRATE.	
10726	5	FLOOR SINK - GRATE HALF SQUARE - 12IN 305MM	SB	GC	ZURN FD2372-H, A.R.E. FLOOR SINK WITH 6" SUPM DEPTH AND 1/2 GRATE.	
FAUCET						
10152	1	FAUCET - DOUBLE LABORATORY WITH BENT RISER SPOUT	SB	GC		
10153	1	FAUCET - WATER TOWER - 12IN 305MM	SB	GC		
10215	2	FAUCET - DOUBLE LABORATORY WITH SWING SPOUT	SB	GC		
10447	1	FAUCET - PRE RINSE SPRAYER WALL MOUNTED	SB	GC	1.2 GPM FLOW RATE	
10597	3	FAUCET - SINGLE HANDLE	SB	GC	0.5 GPM FLOW RATE	
10804	1	FAUCET - PRE RINSE SWING SPOUT	SB	GC		
10874	1	FAUCET - HOT WATER DISPENSER GOOSENECK	SB	GC		
10922	1	FAUCET - MOP SINK WALL MOUNTED	SB	GC		
11003	2	FAUCET - METERED	SB	GC	METERED	
13588	1	FAUCET - HAND SINK WALL MOUNTED	SB	GC		
15749	2	FAUCET - HOT AND COLD WATER SYSTEM	SB	GC		
17569	1	FAUCET - WARE RINSER IN COUNTER - 24X9IN 600X235MM	SB	GC		
17572	1	FAUCET - TAP SINGLE HANDLE	SB	GC		
FILTER						
13076	1	FILTER - PREFILTRATION SYSTEM	SB	GC	GC TO COORDINATE WITH SB VENDOR	
13080	1	FILTER - HEAD QUAD	SB	GC	GC TO COORDINATE WITH SB VENDOR	
13081	4	FILTER - CARBON FILTER CARTRIDGE	SB	GC	GC TO COORDINATE WITH SB VENDOR	
13149	1	FILTER - PRESSURE GAUGE	SB	GC	GC TO COORDINATE WITH SB VENDOR	
OTHER						
13384	1	WATER HEATER, PROVIDE WATER HEATER STAND AND WALL MOUNT RESTRAINTS PER LOCAL JURISDICTION REQUIREMENTS	GC	GC	A. O. SMITH BTH-150, 100 GALLON, 150 MBH INPUT, 98% EFFICIENT, 178 GPH @ 100 DEG. RISE	
SINK						
10116	2	SINK - RESTROOM WALL MOUNTED	SB	GC		
10549	1	SINK - RINSE DROP IN SST - 12X20IN 305X510MM	SB	GC		
10995	1	SINK - MOP - 24X24IN 610X610MM	SB	GC		
13264	1	SINK - 3 COMP WORK SST - 93IN 2350MM	SB	GC		
14688	1	SINK - HAND WITH SIDE SPLASH WALL MOUNTED SST	SB	GC		
17565	1	SINK - RINSE WITH DRAINBOARD - 15X27IN 380X685MM	SB	GC		
17632	1	SINK - STACKED DRAINBOARD - 15IN 380MM	SB	GC		
17650	1	SINK - DRAIN TRAY - 9X6IN 230X150MM	SB	GC		
18743	1	SINK - WATER FILLING STATION - 36X24IN 915X610MM	SB	GC		
19277	2	SINK - COUNTERTOP RINSER WITH DRAIN TROUGH - 26X9IN 660X235MM	SB	GC		
TOILET						
X0110	2	TOILET SINGLE FLUSH 1.0 GPF	GC	GC	VENDOR : KOHLER; MODEL K-3519 FINISH : WHITE #0, REQUIRES SEPARATE SEAT MODEL MODEL # K-4650; 1.0GPF	

DATA DEVICE SCHEDULE - "A"						
DESIGN ID	COUNT	DESCRIPTION	FURN. BY	INST. BY	COMMENTS	
AUDIO VISUAL						
10005	1	MUSIC SYSTEM	SB	GC		
10010	1	DT ORDER MONITOR	SB	VD		
10012	1	DT COMMUNICATION SYSTEM	SB	VD		
10015	3	SPEAKER RECESSED - BLACK	SB	GC	COLOR: BLACK	
10017	2	SPEAKER SURFACE MOUNTED	SB	GC	EXTERIOR ONLY	
12336	1	DT TIMER SYSTEM	SB	VD		
14676	1	DT POS MONITOR ARM DOUBLE SURFACE MOUNTED	SB	VD		
19339	1	AMPLIFIER - 40W	SB	GC		
DATA						
10002	1	COMPUTER MANAGER WORKSTATION	SB	GC		
10007	1	PRINTER MANAGER WORKSTATION	SB	GC		
18744	1	EQUIPMENT RACK WITH LOCK - 24IN 610MM	SB	GC		
20294	2	IOT MODULE	SB	GC		
POINT OF SALE						
10008	2	POS - REGISTER WITH COMPACT CASH DRAWER	SB	GC		
10014	4	POS PRINTER	SB	GC		
10022	1	MONEY COUNTER	SB	GC		
10029	6	POS BANK	SB	GC		
10075	3	CUP LABELER	SB	GC		
14677	1	POS - DT TENDERING REGISTER	SB	GC	PART OF RETAIL IT EQUIPMENT PACKAGE	
14678	1	POS - DT EXPEDITOR	SB	GC	PART OF RETAIL IT EQUIPMENT PACKAGE	
SECURITY						
10024	1	SAFE LH - 20X18X26IN 510X455X600MM	SB	GC		
10028	1	SAFE BASE	SB	GC		

SPECIALTY EQUIPMENT SCHEDULE - "E"						
DESIGN ID	COUNT	DESCRIPTION	FURN. BY	INST. BY	COMMENTS	
COOLING						
10267	5	FRIDGE UNDERCOUNTER 1 DOOR - 27IN 685MM	SB	GC		
11083	2	FRIDGE REACH IN 2 DOOR - 51X35IN 1295X890MM	SB	GC		
12618	2	FRIDGE UNDERCOUNTER 1 DOOR WITH SHELF - 27IN 685MM	SB	GC		
EQUIPMENT						
10312	4	BREWER SOFT HEAT WARMING STAND SINGLE	SB	GC		
10746	1	BREWER DUAL SOFT HEAT	SB	GC		
10808	1	GRINDER DITTING KR1203	SB	GC		
10856	6	BREWER SERVER SOFT HEAT	SB	GC		
12407	2	OVEN TURBOFEE NEXT GENERATION	SB	GC		
12508	2	BLENDER QUIET MODEL ON COUNTER	SB	GC		
15186	1	DISHWASHER HOT LOW STEAM	SB	GC		
16623	1	SCALE DIGITAL WITH ADJUSTABLE DISPLAY MOUNT SMALL	SB	GC		
17564	1	BLENDER PITCHER RINSER WITH SENSOR	SB	GC		
19559	1	NITROGEN GENERATOR ELEMENT	SB	GC		
19742	2	ESPRESSO MACHINE MASTRENA II	SB	GC		
FOOD CASE						
16238	1	FOOD CASE - ZEPHYR - 66IN 1675MM	SB	GC		
ICE						
10344	1	ICE - BIN DROP IN 90LB 40KG	SB	GC		
10880	1	ICE - BIN B100	SB	GC		
18846	1	ICE - MACHINE CIM1446HR SERIES REMOTE COOLED	SB	GC		
19278	2	ICE - BIN DROP IN 45LB 20KG HORIZONTAL	SB	GC		
OTHER						
10091	1	CUP DISPENSER TALL HOT VERTICAL	SB	GC		
10099	2	RESTROOM TOILET PAPER HOLDER	SB	GC		
10172	2	RESTROOM SEAT COVER DISPENSER	SB	GC		
10179	2	HAND DRYER SURFACE MOUNTED	SB	GC		
10384	2	DIAPER CHANGING STATION HORIZONTAL	SB	GC		
10396	1	CUP DISPENSER SHORT HOT VERTICAL	SB	GC		
10467	1	FILE CABINET 2 DRAWER	SB	GC		
10501	1	PIPE EXTINGUISHER	SB	GC		
10641	1	RESTROOM TRASH SANITARY NAPKIN WALL MOUNTED	SB	GC		
10769	2	RESTROOM GRAB BAR VERTICAL - 18IN 455MM	SB	GC		
10791	2	CUP DISPENSER GRANDE VENTI COLD VERTICAL	SB	GC		
10829	6	CORNER GUARD - 1.25IN 30MM - PEWTER	SB	GC		
10855	2	CUP DISPENSER GRANDE VENTI HOT VERTICAL	SB	GC		
10858	1	CUP DISPENSER TALL COLD VERTICAL	SB	GC		
10859	2	RESTROOM GRAB BAR - 48IN 1220MM	SB	GC		
10862	2	RESTROOM GRAB BAR - 36IN 915MM	SB	GC		
10947	1	SOAP DISPENSER WALL MOUNTED	SB	GC		
10977	1	PAPER TOWEL DISPENSER FULL SIZE - TRANSLUCENT GRAY	SB	GC		
11115	3	SOAP DISPENSER SINK MOUNTED	SB	GC		
11815	1	CORNER GUARD - 1.25IN 30MM - HOT ROLLED STEEL MT001				



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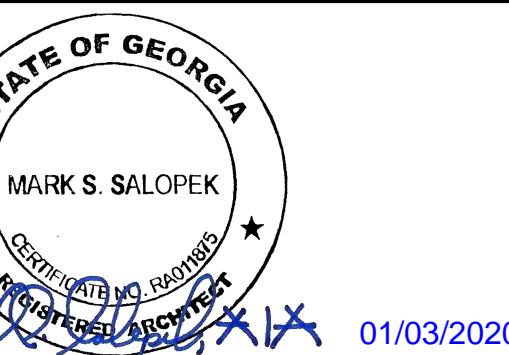
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STARBUCKS TEMPLATE VERSION: i2019-07-26

GPD GROUP
Professional Corporation

520 SOUTH MAIN ST, SUITE 2501
AKRON, OH 44311
P: 330-572-2100 F: 330-572-2101

GPD PROJECT NO: 2019261.12



PROJECT NAME:
HWY 81 & LAKE DOW
PROJECT ADDRESS:
850 HWY 81
MCDONOUGH, GA 30252

STORE #: 59695
PROJECT #: 85535-001
ISSUE DATE: 12/03/2019
DESIGN MANAGER: RV
PRODUCTION DESIGNER: TW
CHECKED BY: GPD GROUP

Revision Schedule			
Rev	Date	By	Description

SHEET TITLE:
CASEWORK PLAN
SCALE: AS SHOWN
SHEET NUMBER:
I102

KEYED NOTES



1. DO NOT CAULK TRASH RINGS TO COUNTERTOPS.
2. INSTALL CASEWORK, COUNTERTOPS, SHELVES, CUBBIES, FINISHES, TRIM AND TABLE TOPS THROUGHOUT. REFERENCE FINISH SCHEDULE AND MANUFACTURER'S SPECIFICATIONS FOR ADDITIONAL INFORMATION.
3. ALL COUNTERTOPS UTILIZED FOR CUSTOMER TRANSACTIONS, INCLUDING BAR, CONDIMENTS AND SALES COUNTERTOPS SHALL BE INSTALLED AT 2'-10" (860 MM) MAXIMUM A.F.F.
4. PROVIDE COUNTERTOP TASK LIGHTING. MOUNT TO UNDERSIDE OF SHELVES. SEE INTERIOR ELEVATIONS AND ELECTRICAL FOR ADDITIONAL INFORMATION.
5. VARIABLE WIDTH FILLER CABINET / COUNTERTOP REQUIRED TO FILL GAP (FIELD VERIFY DIMENSION). VENDOR TO COORDINATE EXACT DIMENSION WITH GC PRIOR TO INSTALLATION.
6. FLOOR DRAIN BELOW. CASEWORK MANUFACTURER TO COORDINATE DESIGN TO INSURE THIS AREA IS READILY ACCESSIBLE FOR CLEANING AND FREE OF COUNTERTOP SUPPORT.
7. UNDER COUNTER LED STRIP ALONG ENTIRE COUNTER TO ILLUMINATE FRONT BAR FACE PANEL.

GENERAL NOTES


- A. GENERAL CONTRACTOR TO NOTIFY CONSTRUCTION MANAGER IMMEDIATELY IF A DISCREPANCY EXISTS BETWEEN CASEWORK SHOP DRAWINGS, EXITING SITE CONDITIONS, ARCHITECTURAL DRAWINGS OR BUILT FIXTURES. ALL DIMENSIONS SHALL BE FIELD VERIFIED BY GC PRIOR TO SHOP DRAWINGS PRODUCTION.
- B. STARBUCKS CONSTRUCTION MANAGER TO COORDINATE AND SCHEDULE CASEWORK DELIVERY DATE. GENERAL CONTRACTOR TO CONFIRM CASEWORK DELIVERY DATE WITH CASEWORK MANUFACTURER AT FOUR (4) WEEKS PRIOR AND THEN ONE (1) WEEK PRIOR TO SCHEDULED DATE OF DELIVERY.
- C. STARBUCKS CONTRACTS DIRECTLY WITH CASEWORK VENDOR TO SUPPLY CASEWORK LISTED IN THE CASEWORK SCHEDULE, UNLESS OTHERWISE NOTED.
- D. CASEWORK VENDOR TO PROVIDE COMPLETE SHOP DRAWINGS AND INSTALLATION PACKAGE TO GENERAL CONTRACTOR TO FACILITATE PROPER INSTALLATION.
- E. ALL CASEWORK BOX BASE / TOE KICKS SHALL BE SET AND LEVELED USING 1/4" (6 MM) NON-ABSORBENT PLASTIC SHIMS PROVIDED BY CASEWORK VENDOR.
- F. SEE INTERIOR FINISH ELEVATIONS AND SCHEDULES FOR LOCATION AND TAGGING OF WALL TREATMENTS BY CV AND OTHERS.
- G. SEE REFLECTED CEILING PLAN FOR CASEWORK SOFFIT LOCATIONS.
- H. REFERENCE PLUMBING AND ELECTRICAL PLANS FOR PLACEMENT OF ELECTRICAL, DATA AND PLUMBING ON FRONT AND BACKLINE OF BAR.
- I. PROVIDE ACCENT LIGHTING AT FRONT EDGE OF BAR. SEE INTERIOR ELEVATIONS AND ELECTRICAL FOR ADDITIONAL INFORMATION.
- J. CASEWORK VENDOR TO ENGINEER PROPER COUNTERTOP SUPPORT AT ESPRESSO BAR AND OTHER WORKSTATIONS PER STARBUCKS MINIMUM PERFORMANCE REQUIREMENTS.

LEGEND

- INDICATES STAINLESS STEEL (SST) COUNTERTOP
- INDICATES SOLID SURFACE (SS) COUNTERTOP
- DATUM POINT
- CASEWORK TAG
- UNDERCOUNTER LED STRIP

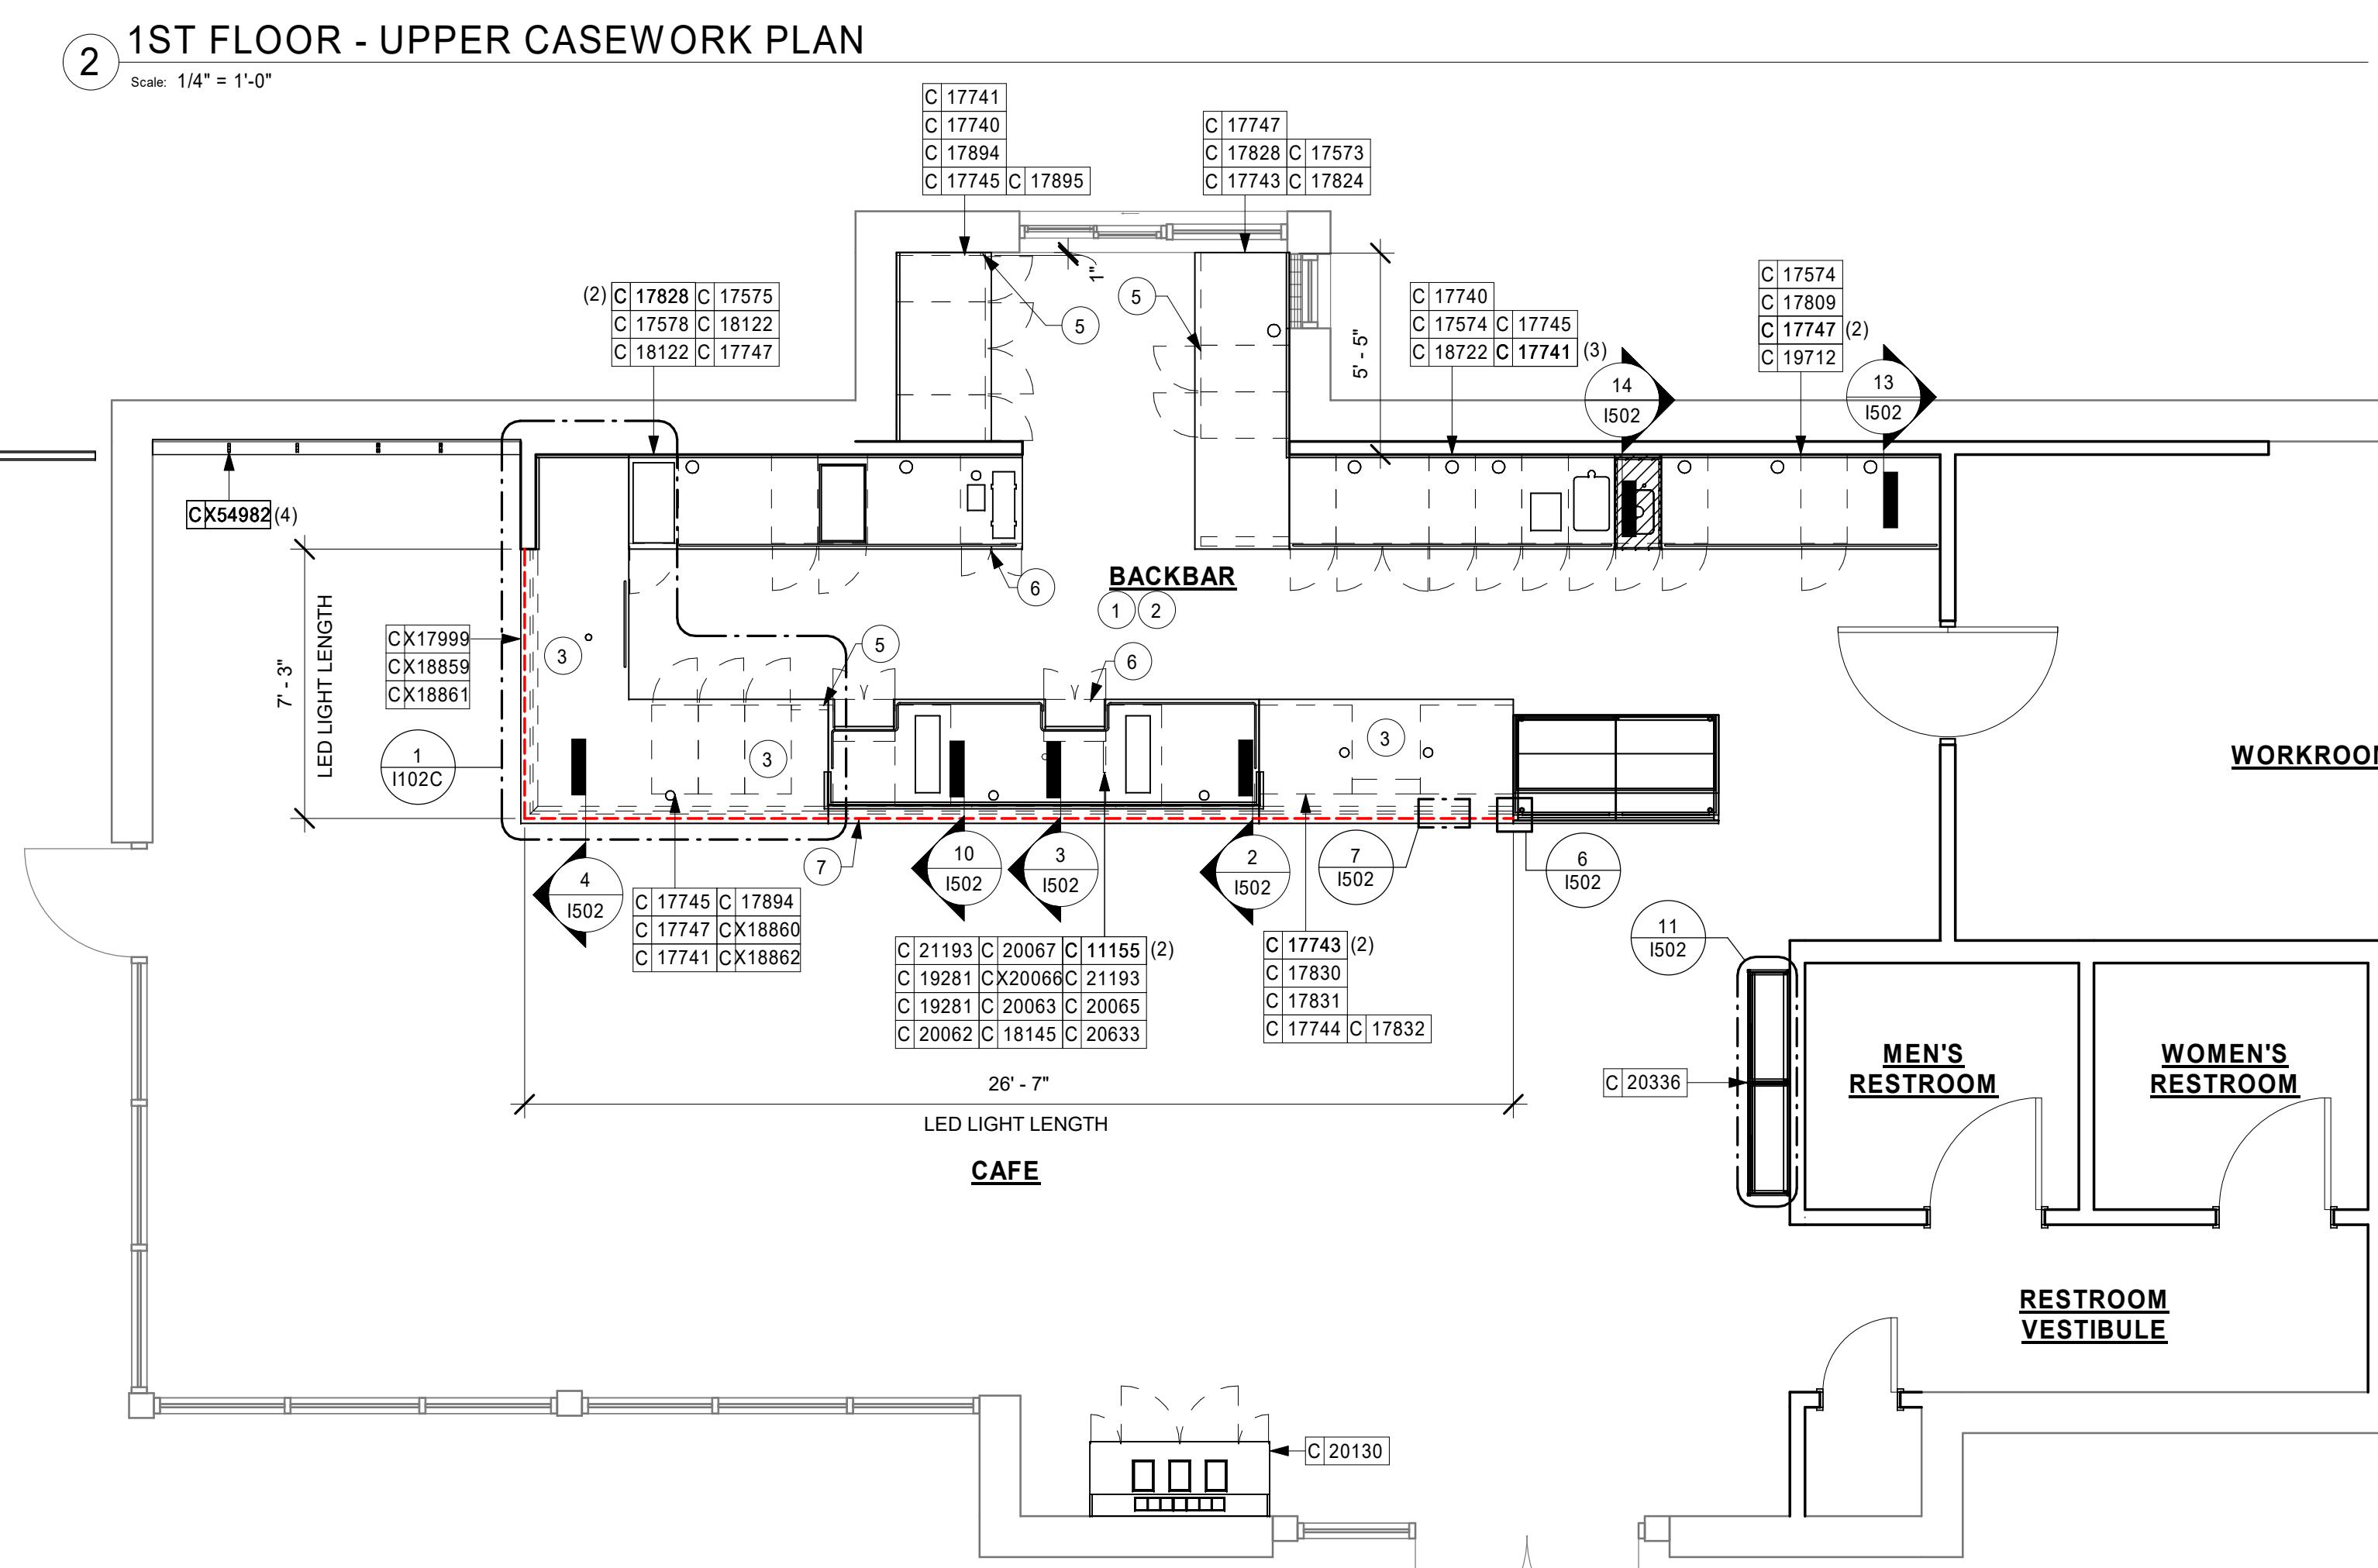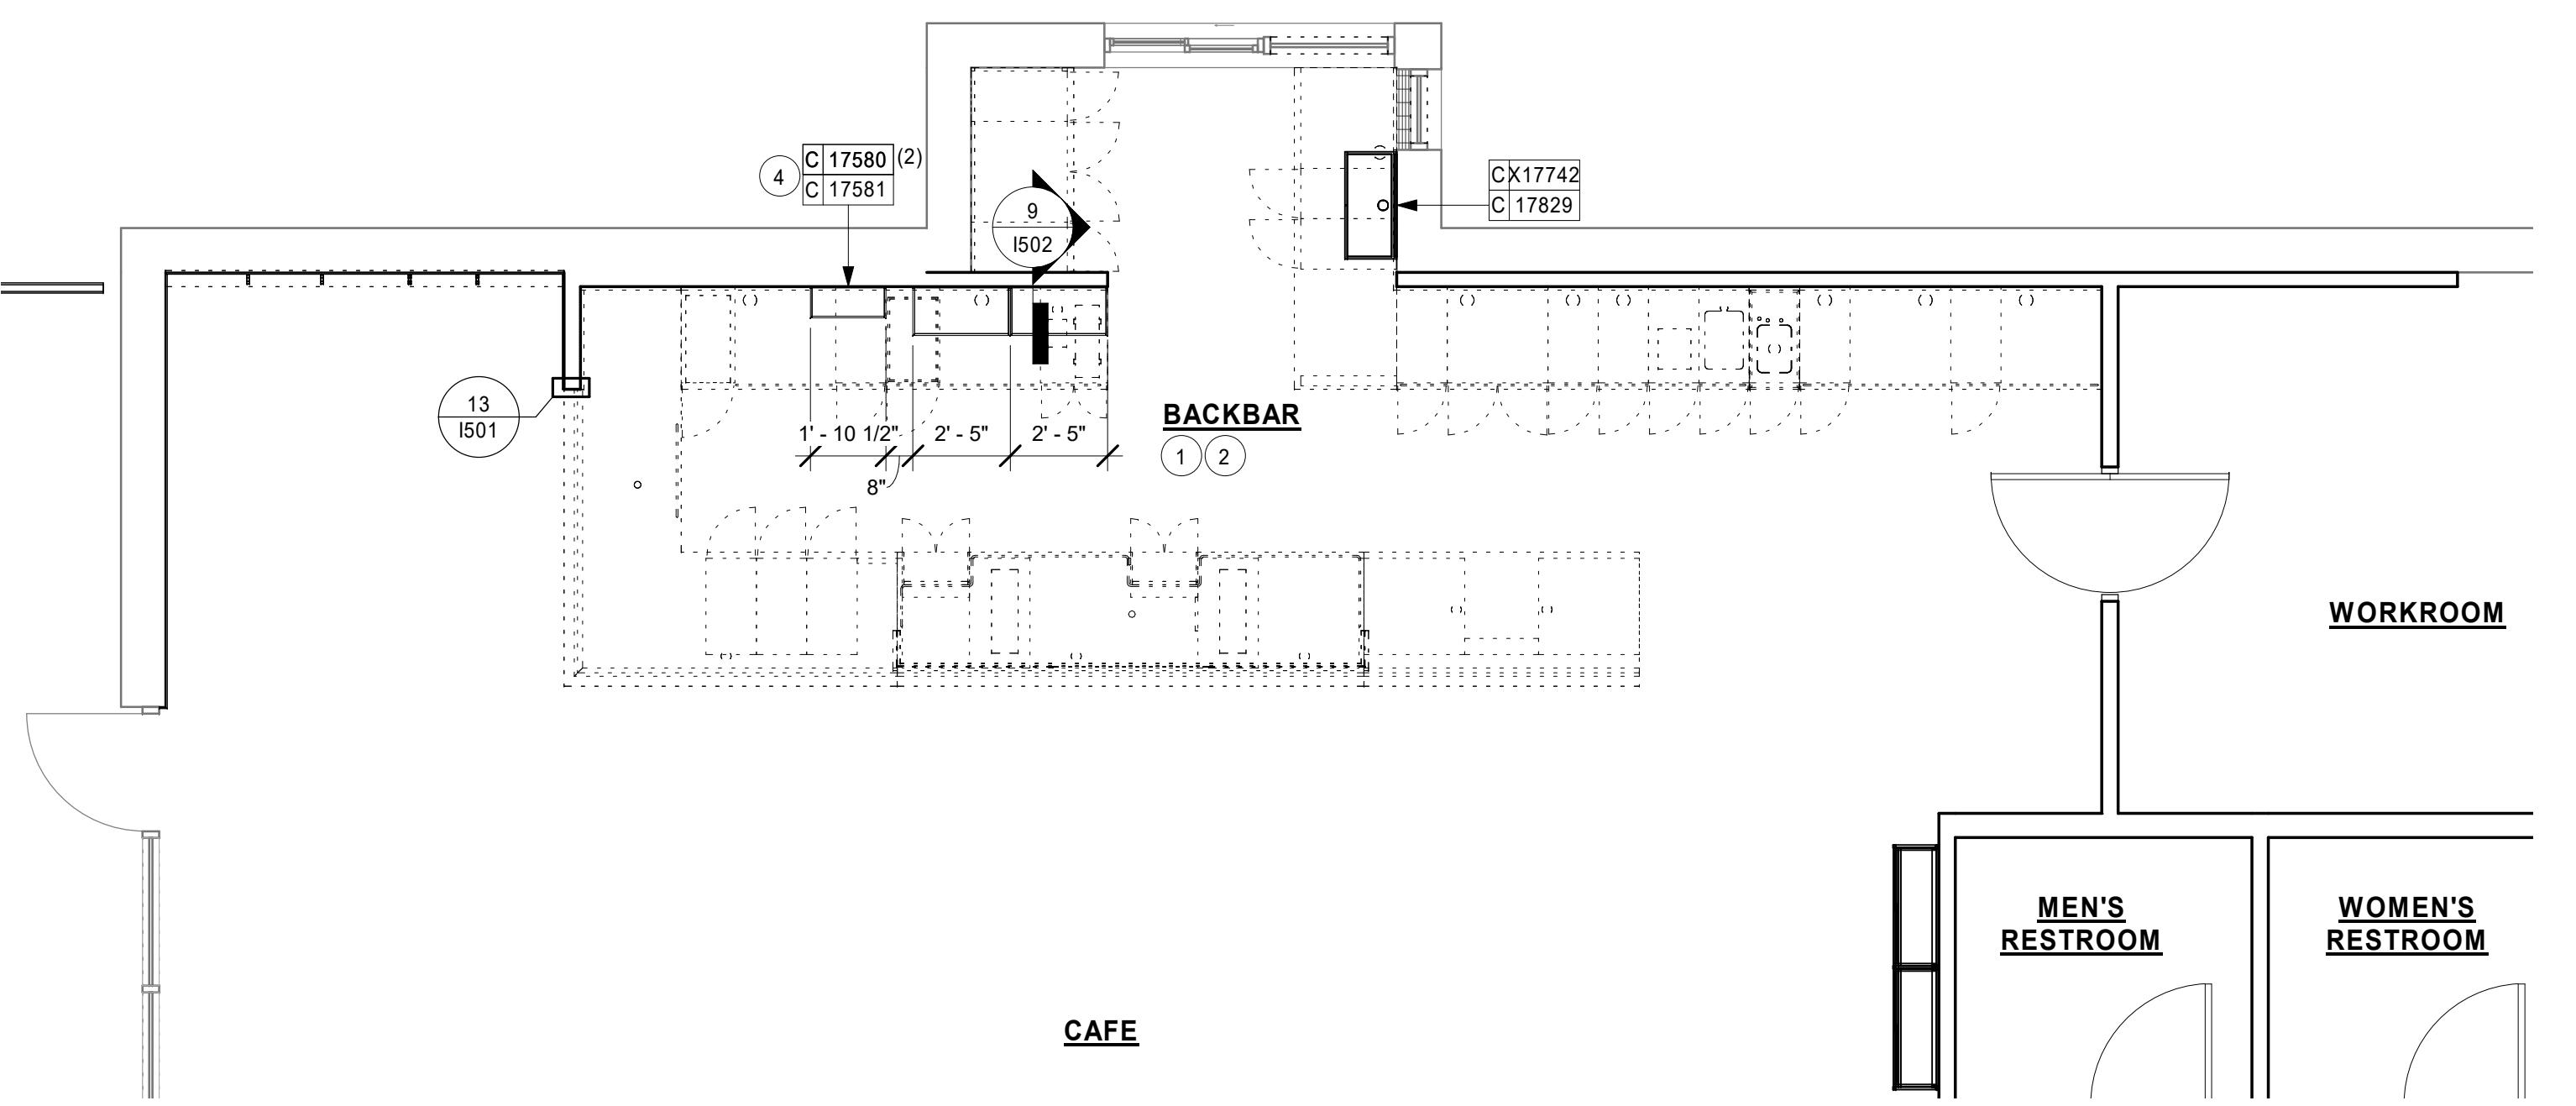

0 2' 4' 6' 8'
Scale: 1/4" = 1'-0"

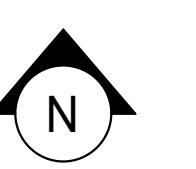



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GPD PROJECT NO: 2019261.12

STATE OF GEORGIA
MARK S. SALOPEK
CERTIFIED AND SIGNED
01/03/2020

PROJECT NAME:
HWY 81 & LAKE DOW

PROJECT ADDRESS:
850 HWY 81
MCDONOUGH, GA 30252

STORE #: 59695
PROJECT #: 85535-001
ISSUE DATE: 12/03/2019
DESIGN MANAGER: RV
PRODUCTION DESIGNER: TW
CHECKED BY: GPD GROUP

Revision Schedule

Rev	Date	By	Description

SHEET TITLE:
CASEWORK SCHEDULES

SCALE: AS SHOWN

SHEET NUMBER:

I102B

CASEWORK SCHEDULE - "C"					
DESIGN ID	COUNT	DESCRIPTION	FURN. BY	INST. BY	COMMENTS
CABINET					
17573	1	CABINET - COUNTER SUPPORT PANEL - 3IN 75MM	SB	GC	
17574	2	CABINET - SINK OR ICE - 15IN 380MM	SB	GC	
17575	1	CABINET - BACKBAR SINK OR ICE - 20IN 510MM	SB	GC	
17580	2	CABINET - CBE TEA SHELF - 29IN 735MM - FLAT BLACK MT0028	SB	GC	
17581	1	CABINET - CBE DRY INCLUSION SHELF - 23IN 585MM - FLAT BLACK MT0028	SB	GC	
17740	2	CABINET - 30IN 760MM	SB	GC	
17741	5	CABINET - 15IN 380MM	SB	GC	
17743	3	CABINET - POS - 30IN 760MM	SB	GC	
17744	1	CABINET - POS BRIDGE - 22IN 560MM	SB	GC	
17745	3	CABINET - DRAWER - 15IN 380MM	SB	GC	
17747	1	CABINET - BACKBAR TRASH - 15IN 380MM	SB	GC	
17747	5	CABINET - TRASH - 15IN 380MM	SB	GC	
18122	2	CABINET - BACKBAR SINK OR ICE - 16IN 405MM	SB	GC	
19281	2	CABINET - ESPRESSO ICE BIN STAINLESS - 20IN 510MM	SB	GC	
21193	2	CABINET - ESPRESSO CUBBY WITH OPEN BACK - 18IN 455MM	SB	GC	
X17742	1	CUSTOM CABINET - DT POS UPPER CUBBY WITH DOORS - 32IN 815MM	SB	GC	
CAFE					
20130	1	CONDIMENT CART THREE DROP - WALNUT AND BLACK WD0077 CP0005	SB	GC	
20336	1	WALL BAY 2 UNIT - 72IN 1830MM - WALNUT WD0077	SB	GC	
COUNTERTOP					
17578	1	COUNTERTOP - CBE - LF - 127IN 3225MM	SB	GC	
17809	1	COUNTERTOP - HAND SINK WITH LOW SPLASH STAINLESS - 15IN 380MM	SB	GC	
17824	1	COUNTERTOP - DT POS - LF - VARIABLE LENGTH	SB	GC	
17828	3	COUNTERTOP - BACKSPLASH - VARIABLE LENGTH	SB	GC	
17830	1	COUNTERTOP - POS - 82IN 2085MM	SB	GC	
18722	1	COUNTERTOP - BREW WITH TRASH DROP - LF - 105IN 2665MM	SB	GC	
19712	1	COUNTERTOP - WARMING - LF - 90IN 2285MM	SB	GC	
20062	1	COUNTERTOP - ESPRESSO METRO - LF - 139IN 3530MM	SB	GC	
20063	1	COUNTERTOP - FRONTBAR CAP - 139IN 3530MM	SB	GC	
DIEWALL					
17831	1	DIEWALL - POS - 82IN 2085MM	SB	GC	
20064	1	DIEWALL - ESPRESSO - 139IN 3530MM	SB	GC	
X18859	1	CUSTOM DIEWALL - 84.5IN	SB	GC	
X18860	1	CUSTOM DIEWALL - 126.25 IN	SB	GC	
FIT KIT					
17894	2	FIT KIT - CABINET FILLER PANEL	SB	GC	
17895	1	FIT KIT - BACKBAR COUNTERTOP	SB	GC	
X17999	1	CUSTOM FIT KIT - BACKBAR COUNTERTOP	SB	GC	
OTHER					
11155	2	ESPRESSO MACHINE PUMP MOUNT - 10X10IN 255X255MM	SB	GC	
17829	1	FRENCH CLEAT - VARIABLE LENGTH	SB	GC	DESIGNER TO VERIFY QUANTITY. PROVIDE OVERALL LENGTH REQUIRED.
18145	1	COUNTERTOP SUPPORT LEG	SB	GC	
20067	1	SNEEZE GUARD - 139IN 3530MM	SB	GC	
20633	1	COUNTERTOP SUPPORT LEG SLIM	SB	GC	
X20066	1	CUSTOM SHROUD - 139IN 3530MM	SB	GC	
X54982	4	CUSTOM CASEWORK- HANGING ARTWORK FRAME. STLMARK #212 BRUSHED BRUTE BRONZE.	SB	GC	SEE DETAILS FOR LENGTH
PANEL					
17832	1	PANEL - 82IN 2085MM	SB	GC	
20065	1	PANEL - 139IN 3530MM	SB	GC	
X18861	1	CUSTOM PANEL - 85.5IN	SB	GC	
X18862	1	CUSTOM PANEL - 127.25IN	SB	GC	

CASEWORK FINISH SCHEDULE			
ENGINE ZONE	MATERIAL DESCRIPTION	FINISH CODE	COMMENTS
COMPOSITE - BRUSHED DARK GREY			
COUNTERTOPS - BACKBAR	COMPOSITE - BRUSHED DARK GREY	CP0057	
COUNTERTOPS - ESPRESSO	COMPOSITE - BRUSHED DARK GREY	CP0057	
COUNTERTOPS - FRONTBAR	COMPOSITE - BRUSHED DARK GREY	CP0057	
COUNTERTOPS - SHROUD	COMPOSITE - BRUSHED DARK GREY	CP0057	
METAL - ALUMINUM - BRUSHED			
CABINETS - DT POS CUBBY	METAL - ALUMINUM - BRUSHED		
METAL - FLAT BLACK POWDERCOAT			
CABINETS - DOOR PULL	METAL - FLAT BLACK POWDERCOAT	MT0028	
CABINETS - UNDERCOUNTER	METAL - FLAT BLACK POWDERCOAT	MT0028	
ICE BIN			
METAL - STAINLESS STEEL - BRUSHED			
CABINETS - CABINET LEG	METAL - STAINLESS STEEL - BRUSHED	#4 BRUSHED 16GA	
CABINETS - UNDERCOUNTER	METAL - STAINLESS STEEL - BRUSHED	#4 BRUSHED 16GA	
COUNTERTOPS - HAND SINK	METAL - STAINLESS STEEL - BRUSHED	#4 BRUSHED 16GA	
PLAM - MOTTLED BLACK			
CABINETS - DT POS CUBBY	PLAM - MOTTLED BLACK	PL0019	
CABINETS - UNDERCOUNTER	PLAM - MOTTLED BLACK	PL0019	
WOOD - WALNUT - PLANK - VERTICAL			
FINISH PANELS - FRONTBAR	WOOD - WALNUT - PLANK - VERTICAL	WD0077 MAD100	INSTALLED VERTICALLY

CASEWORK CABINET BASE SCHEDULE			
DESIGN ID	COUNT	BASE OPTION	DESCRIPTION
17573	1	Other	CABINET - COUNTER SUPPORT PANEL - 3IN 75MM
17574	2	Other	CABINET - SINK OR ICE - 15IN 380MM
17575	1	Other	CABINET - BACKBAR SINK OR ICE - 20IN 510MM
17740	2	Other	CABINET - 30IN 760MM
17741	5	Other	CABINET - 15IN 380MM
17743	3	Other	CABINET - POS - 30IN 760MM
17744	1	Box Base	CABINET - POS BRIDGE - 22IN 560MM
17745	3	Other	CABINET - DRAWER - 15IN 380MM
17747	1	Other	CABINET - BACKBAR TRASH - 15IN 380MM
17747	5	Other	CABINET - TRASH - 15IN 380MM
17894	2	Other	FIT KIT - CABINET FILLER PANEL
18122	2	Other	CABINET - BACKBAR SINK OR ICE - 16IN 405MM
21193	2	Other	CABINET - ESPRESSO CUBBY WITH OPEN BACK - 18IN 455MM



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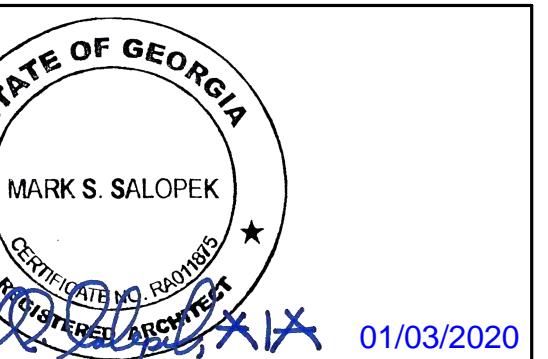
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BUCKS TEMPLATE VERSION: i2019-07-26



PROJECT NO: 2019261_12



HIGHWAY & LAKE DOW


PROJECT ADDRESS:
850 HWY 81
MCDONOUGH,

RE #: 59695
JECT #: 85535-001
DATE: 12/03/2019
N MANAGER: RV
DUCTION DESIGNER: TW
KED BY: CBB GROUP

Revision Schedule


**TITLE:
LARGED BAR PLANS
DETAILS
: AS SHOWN**

NUMBER:

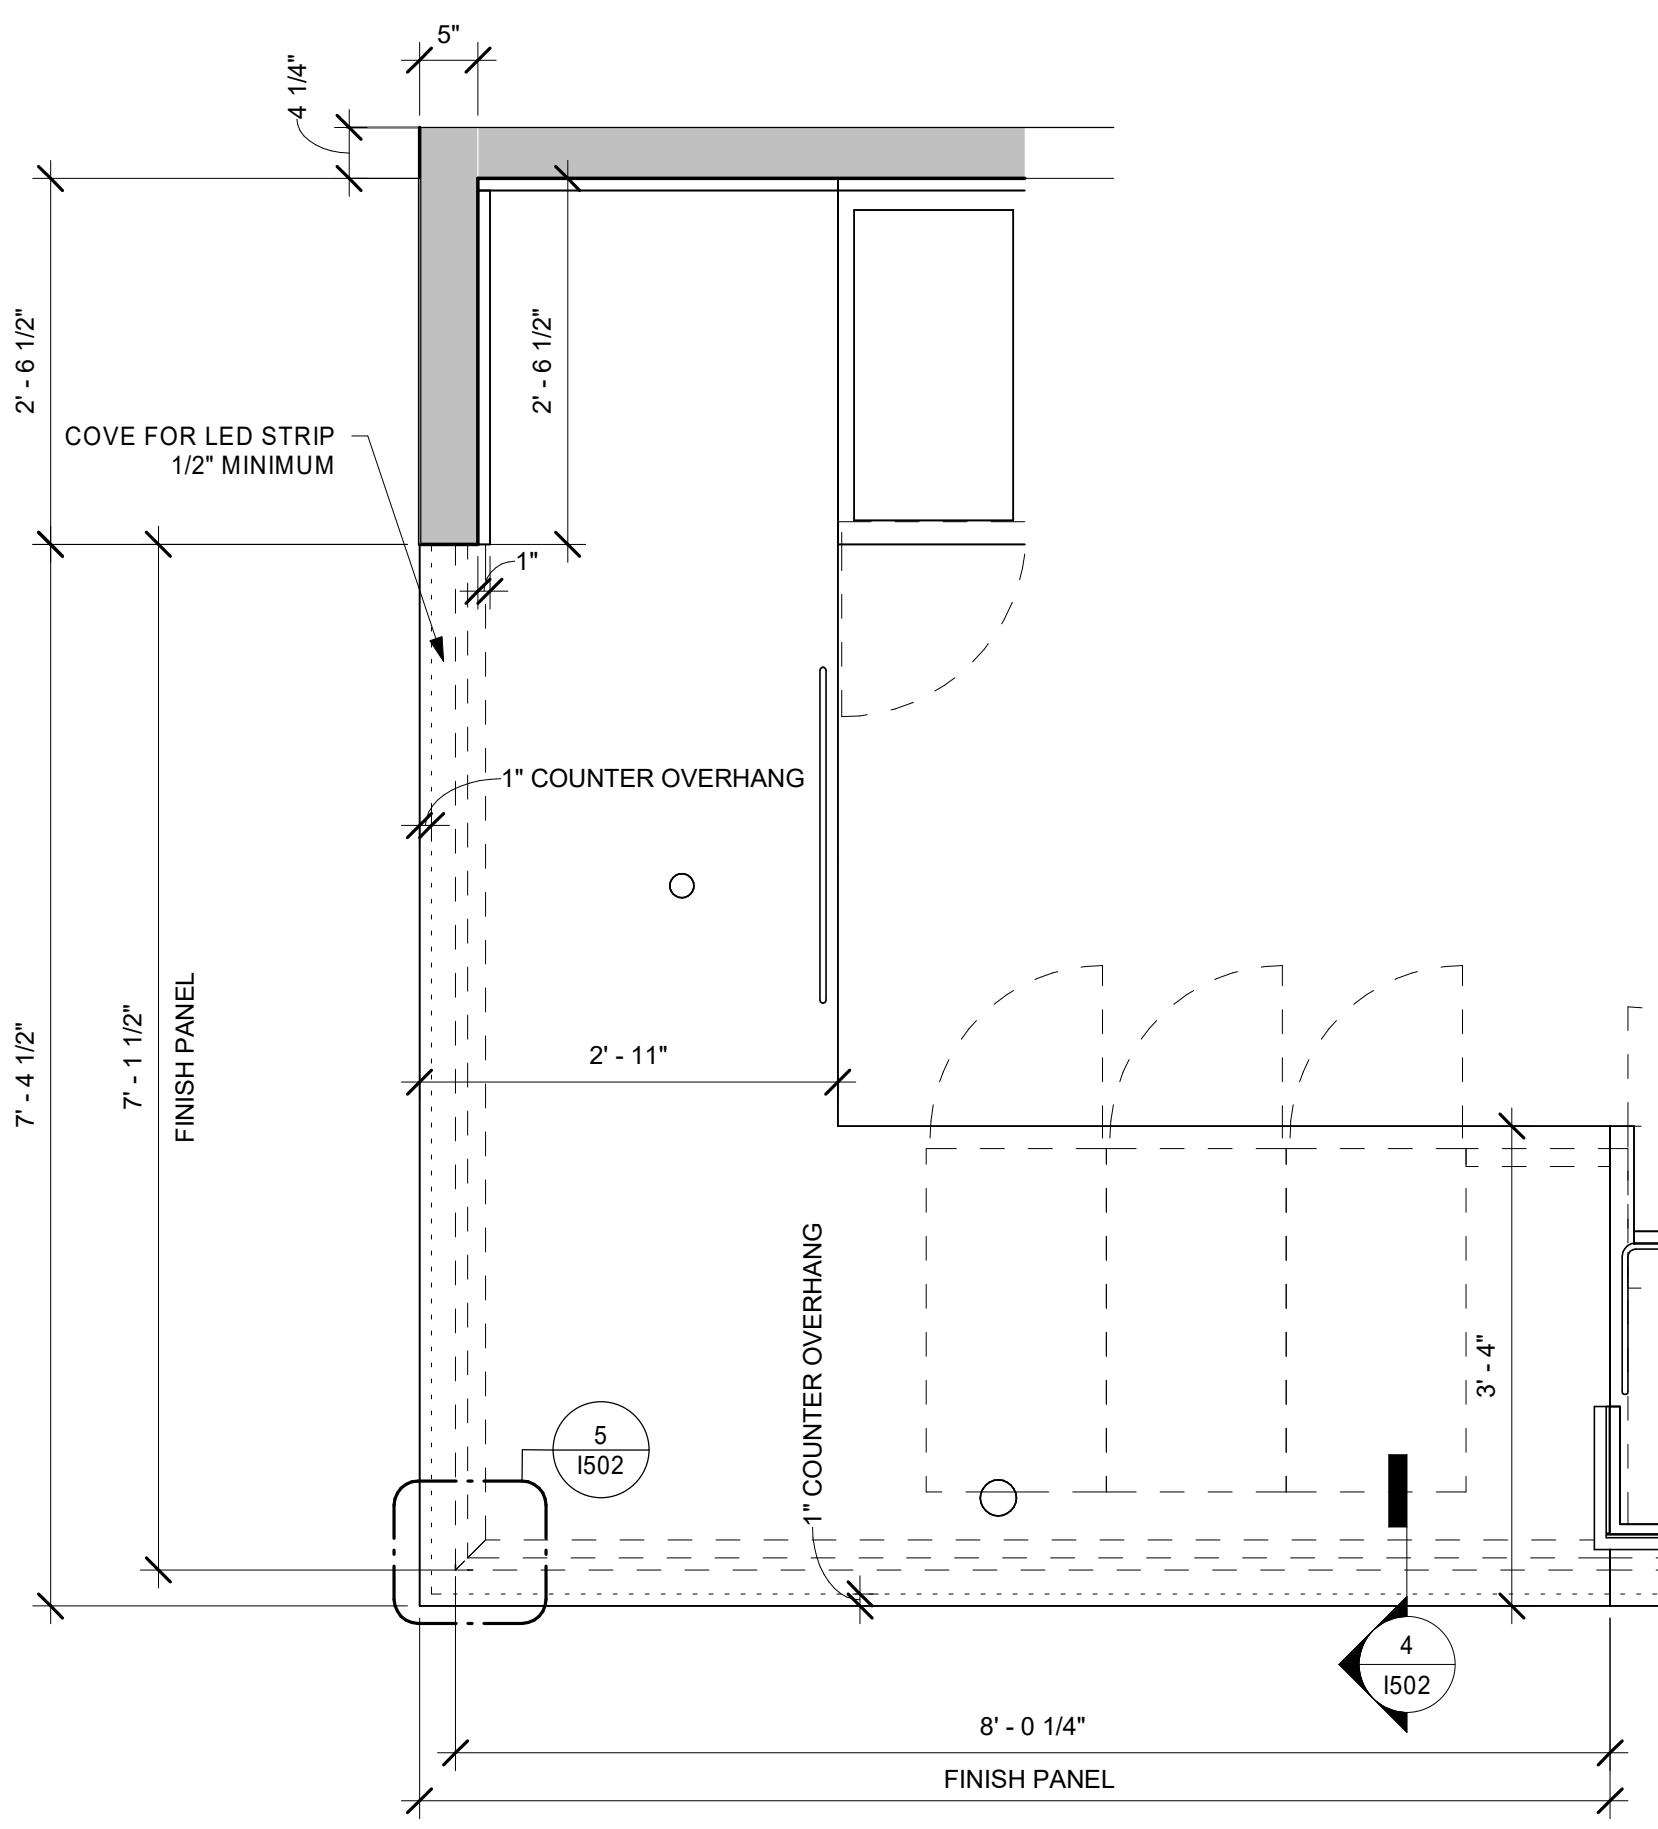


1 1ST FLOOR - CUSTOM BAR CASEWORK PLAN

1/3/2020 12:19:27 PM

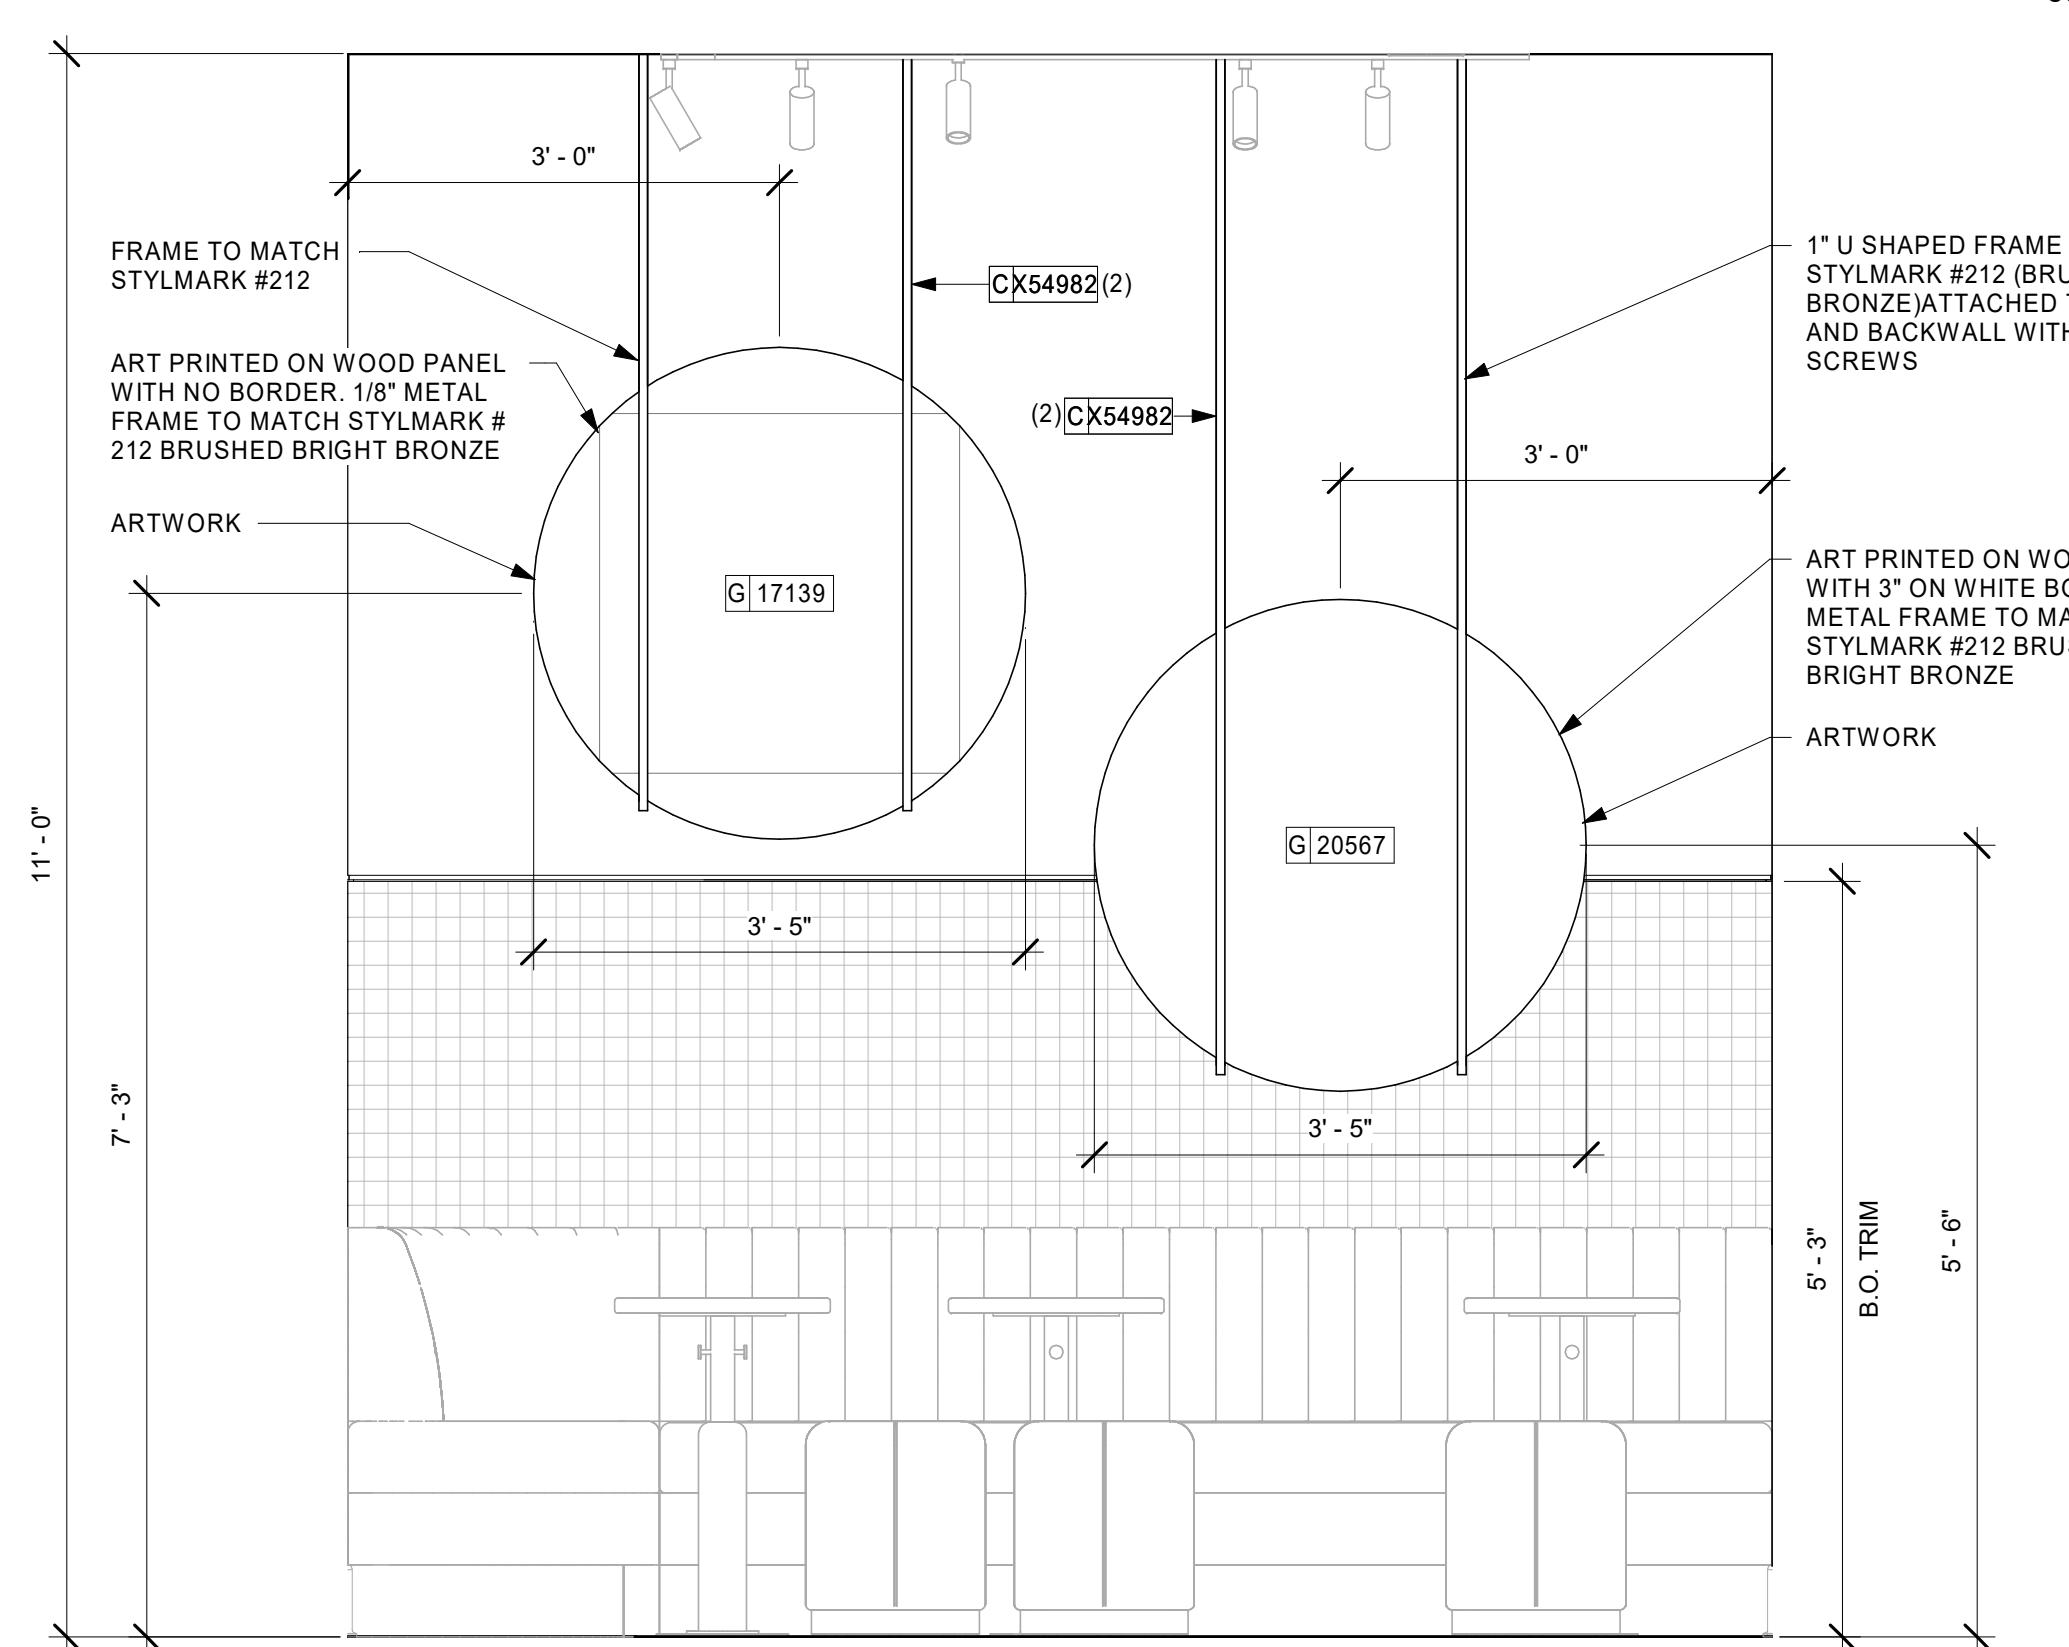

2 ART AT BANQUETTE

1/3/2020 12:19:27 PM

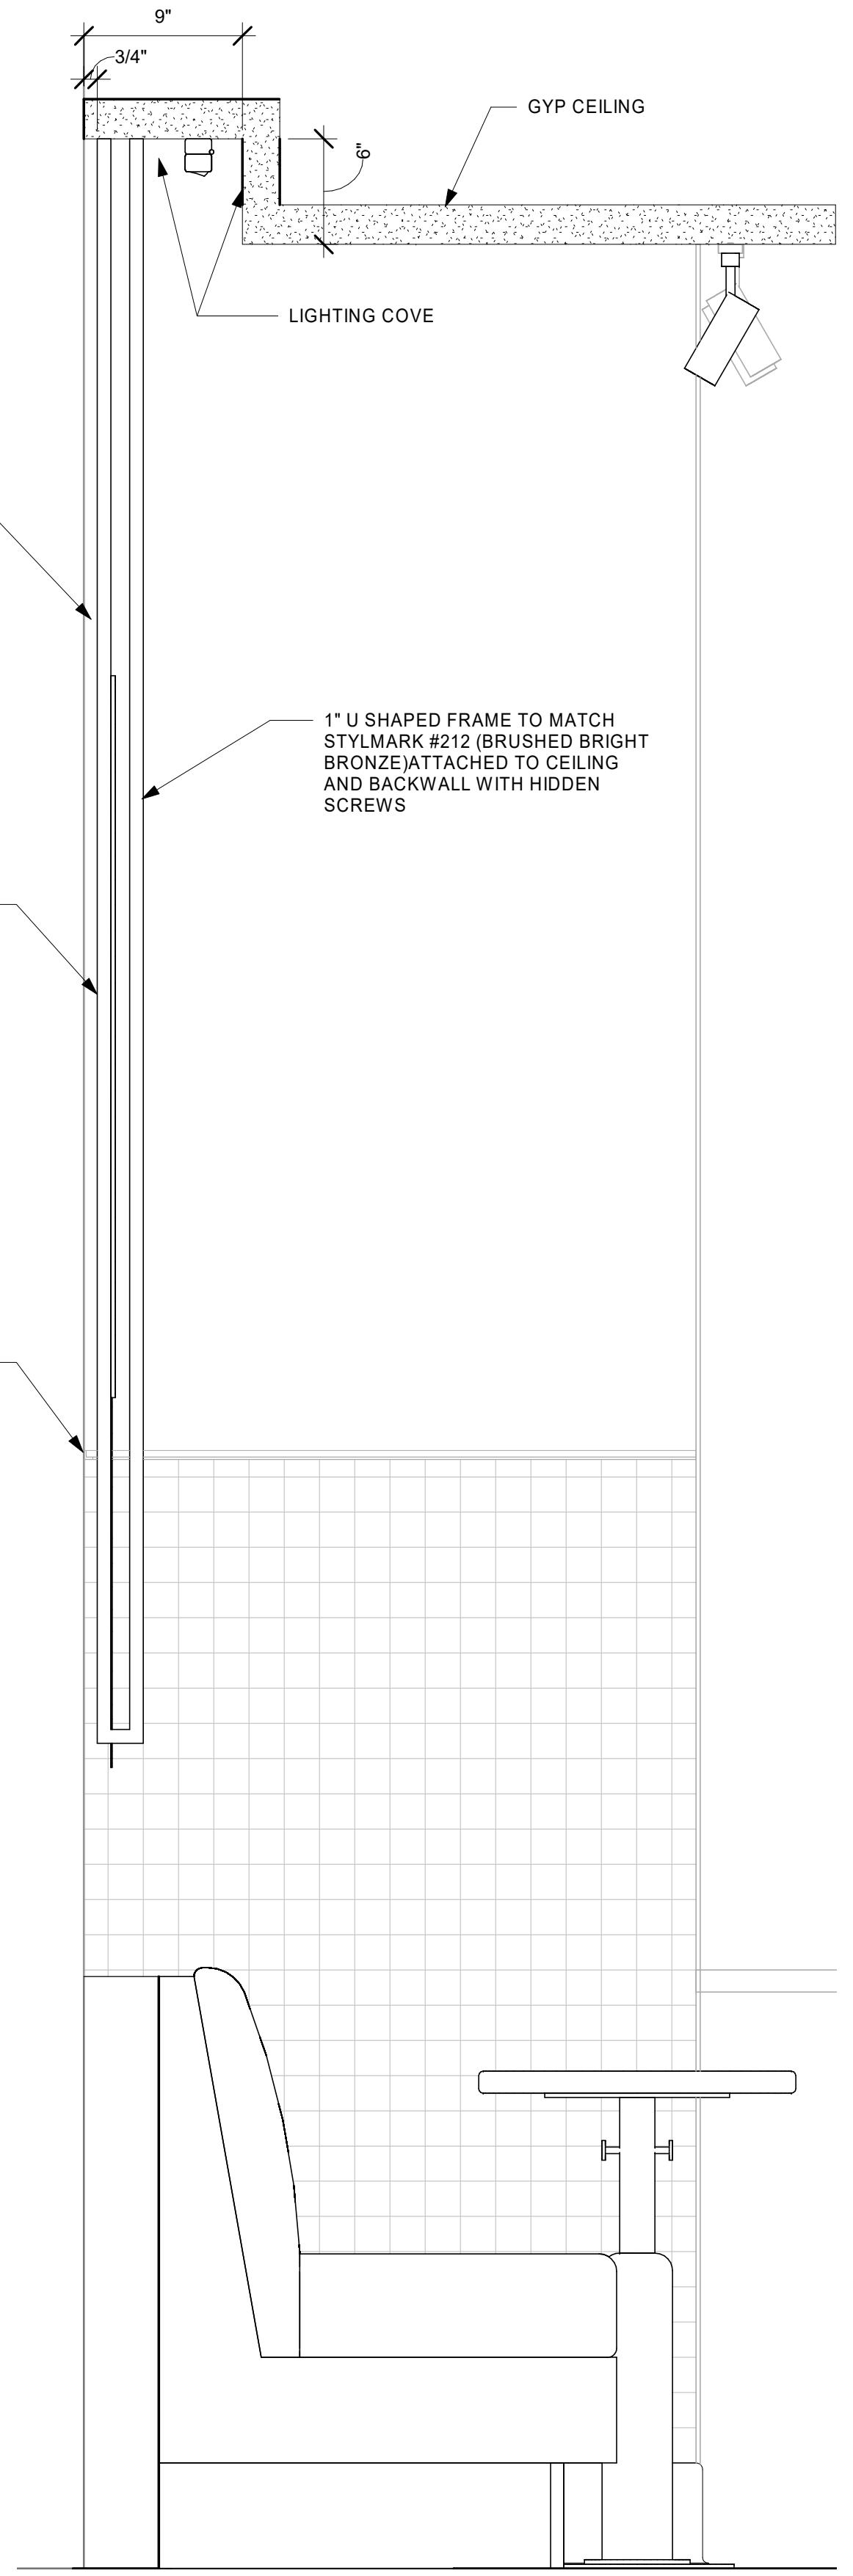

3 HANGING BANQUETTE ART ATTACHMENT DETAIL

1/3/2020 12:19:27 PM




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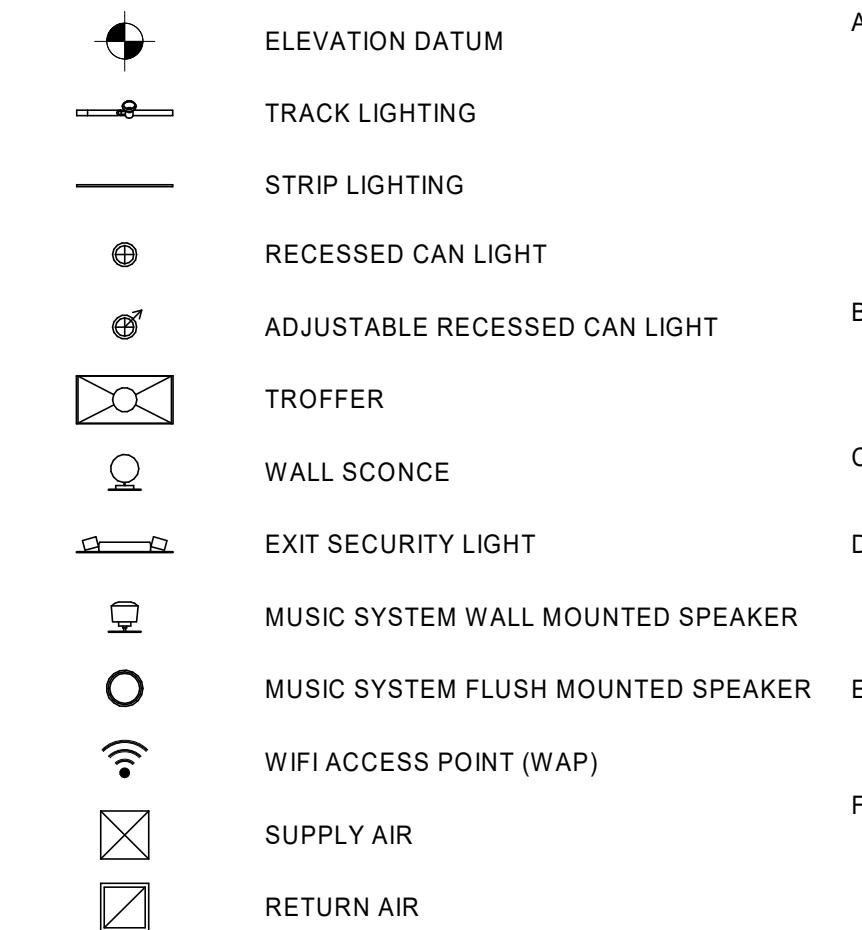
SHEET TITLE:
REFLECTED CEILING PLAN
SCALE: AS SHOWN

SHEET NUMBER:
1103

LIGHTING FIXTURE SCHEDULE - "L"						
DESIGN ID	COUNT	DESCRIPTION	FURN. BY	INST. BY	BULB	COMMENTS
ADDITIONAL LIGHTING EQUIP.						
CL1	1	CURRENT LIMITER FOR R SERIES TRACK - MINI END FEED COLOR TO MATCH TRACK	SB	GC		JUNO TCL1 2 AMP CURRENT LIMITER - WHITE
CL4	1	CURRENT LIMITER FOR R SERIES TRACK - MINI END FEED COLOR TO MATCH TRACK	SB	GC		JUNO TCL4 4 AMP CURRENT LIMITER
T/C	1	TIME CLOCK	SB	GC		TORK-T101R TIME CLOCK
EXIT						
11517	2	EMERGENCY EXIT LIGHT - BLACK	SB	GC	INTEGRATED LED	JUNO #NXP3-3-G-BL
19045	1	LED EXIT SIGN WITH EMERGENCY LIGHT - WHITE AND GREEN	SB	GC	INTEGRATED LED	
19056	5	EMERGENCY LIGHT DOUBLE - WHITE	SB	GC	LED 5W LOW ENERGY OR EQUAL	JUNO #N1WHHO
19057	1	EMERGENCY LIGHT DOUBLE - BLACK	SB	GC	LED 5W LOW ENERGY OR EQUAL	JUNO #N1BLHO
RECESSED CAN						
19023	32	CAN - LED MOUNTING FRAME - 2IN 50MM - NEW CEILING	SB	GC		
19115	4	CAN - LED DOWNLIGHT CONE WITH DRIVER - 2IN 50MM - BLACK - 1000LM SPOT	SB	GC		DRIVER: JUNO #2LEDDRIVER-G2-10LM-120-FRPC TRIM: JUNO #2LEDTRIM-G2-ADJ-27K-90CRI-SP-BL
19116	28	CAN - LED DOWNLIGHT CONE WITH DRIVER - 2IN 50MM - BLACK - 1000LM NFL	SB	GC		DRIVER: JUNO #2LEDDRIVER-G2-10LM-120-FRPC TRIM: JUNO #2LEDTRIM-G2-ADJ-27K-90CRI-NFL-BL
SCONCE						
16593	2	SCONCE - LED RESTROOM VANTY TUBULAR - OPAL GLASS AND BRUSHED NICKEL	SB	GC	INTEGRATED LED	
STRIP						
14409	1	STRIP - UNDER COUNTER LED TAPE IN HOUSING - VARIABLE LENGTH	SB	GC		33" - 10" UNDERCOUNTER LIGHTING AT CUSTOMER SIDE OF FRONTBAR. DESIGN TO SPECIFY HOUSING COLOR, FIELD TRIMMABLE TO 6IN LENGTHS
19068	11	STRIP - LED WALL GRAZER - 48IN 1220MM - 2700LM	SB	GC	INTEGRATED LED	ECOSENSE:L50-I-48"-08-27-90-MULT-15X15
TRACK						
19080	13	TRACK - LED FIXTURE - 2IN 50MM - BLACK - 900LM SPOT	SB	GC	INTEGRATED LED	LTC-ID-A-1-10-SP-9-27-P-Q-J1-BLCK
19083	22	TRACK - LED FIXTURE - 2IN 50MM - BLACK - 900LM FLOOD	SB	GC	INTEGRATED LED	LTC-ID-A-1-10-FL-9-27-P-Q-J1-BLCK
19409	2	TRACK - WITH CONNECTORS - 4FT 122CM - BLACK - 2 CIRCUIT	SB	GC		JUNO:R4BL
19410	5	TRACK - WITH CONNECTORS - 6FT 183CM - BLACK - 2 CIRCUIT	SB	GC		JUNO:R6BL
19412	1	TRACK - WITH CONNECTORS - 12FT 365CM - BLACK - 2 CIRCUIT	SB	GC		JUNO:R12BL
19413	7	TRACK - WITH CONNECTORS - 16FT 488CM - BLACK - 2 CIRCUIT	SB	GC		JUNO:R16BL
TROFFER						
15057	6	TROFFER - LED RECESSED - 24X48IN 600X1200MM - WHITE - 3900LM	SB	GC		

CEILING TREATMENT SCHEDULE - "U"						
DESIGN ID	AREA	DESCRIPTION	FURN. BY	INST. BY	COMMENTS	
OTHER						
11302	439 SF	ACT - WORKROOM - 2X4FT 61X122 CM		GC	GC	WASHABLE VINYL FACED 2X4 GRID/ACT FOR BOH
PAINT SCHEDULE						
DESIGN ID	DESCRIPTION	LRV	FUR. N. BY	INST. BY	COMMENTS	
X76461	SW - FIRST STAR	GC	GC		SW7646, USE PRIMER CP-1; NCS - S 4500-N; AKZO NOBEL - 30YY 33/047	
X48599	SW - MOROCCAN BROWN	8	GC		SW6060	
X59778	SW - DOVE TAIL	27	GC		SW7018, USE PRIMER CP-1; NCS - S 4500-N; AKZO NOBEL - 30YY 33/047	
X70201	SW7020 BLACK FOX, OR EQUIVALENT	8	GC		SW 7020 SG, USE PRIMER CP-1; NCS - S 7502-Y; AKZO NOBEL - 30YY 10/038	

LEGEND

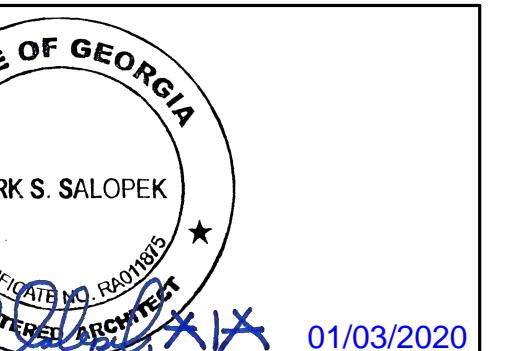


GENERAL NOTES

- A. IF REQUIRED BY LOCAL CODE, GENERAL CONTRACTOR TO PROVIDE SEMI-RECESSED SPRINKLER HEADS WITH POLISHED CHROME ESCUTCHEONS CENTERED IN ACOUSTIC CEILING TILE, IF PENDANT HEADS ARE REQUIRED IN GWB SOFFIT OVER FRONTBAR, CONCEAL SUPPLY PIPING WITHIN SOFFIT. GENERAL CONTRACTOR TO SUBMIT SPRINKLER LAYOUT TO STARBUCKS' CONSTRUCTION MANAGER FOR APPROVAL PRIOR TO INSTALLATION.
- B. LEAVE TEN (10) ADDITIONAL RETAIL CEILING TILES TO MATCH RETAIL CEILING PAINT COLOR ABOVE THE WORKROOM CEILING AT MANAGER'S DESK FOR FUTURE USE.
- C. PROVIDE GROMMET AT ACOUSTIC CEILING PENETRATIONS FOR FIXTURES OF SUPPORTS.
- D. HEATING, VENTILATING AND AIR CONDITIONING SHOWN ON THIS PLAN PROVIDED FOR REFERENCE ONLY. SEE MECHANICAL DRAWINGS FOR ADDITIONAL INFORMATION.
- E. DIFFUSERS AND RETURNS IN ACOUSTIC CEILING TILE TO BE CENTERED IN TILE AND PAINTED TO MATCH ADJACENT FINISHES (TYP.).
- F. PAINT ALL EXPOSED HVAC DUCTS, HVAC DIFFUSERS, LIGHT TRIM RINGS, PIPING, CONDUIT AND JUNCTION BOXES THE SAME COLOR AS SPECIFIED ON SURROUNDING CEILING OR SOFFIT UNLESS OTHERWISE NOTED. TYPICAL THROUGHOUT RETAIL AREA OF STORE.
- G. PAINT SUBSTITUTIONS ARE NOT ALLOWED. USE STARBUCKS' NATIONAL ACCOUNT "COLOR CODE" WHEN ORDERING PAINTS.
- H. DATA CABLING ABOVE HEAD SHALL BE IN PLENUM WHEN AVAILABLE.
- I. DATA CABLING AT EXPOSED CEILING SHALL BE INSTALLED IN METAL CONDUIT OR PER LOCAL CODE REQUIREMENT.

KEYED NOTES

1. GWB SOFFIT WITH SMOOTH FINISH (PAINT AS SCHEDULED).
2. GWB CEILING. PAINT CEILING DIFFUSERS AS INDICATED.
3. WASHABLE CEILING TILE LOCATED IN BACK OF HOUSE AND ABOVE CAFE BAR (IF APPLICABLE).
4. OPEN TO STRUCTURE ABOVE, PAINT BOTTOM OF DECK AND TRUSSES AS SCHEDULED.
5. EXTERIOR SPEAKER
6. RECESSED RETURN GRILLE.
7. ROLLER SHADE. FIELD VERIFY WIDTH OF EACH SHADE PRIOR TO PROCUREMENT.
8. FLUSH MOUNTED CEILING SPEAKER
9. EXTERIOR SECURITY LIGHT
10. EMERGENCY EGRESS LIGHTING TYP.
11. 24x24IN CEILING ACCESS HATCH. FLUSH WITH CEILING-PAINTED TO MATCH CEILING
12. EXTERIOR AWNINGS WITH METAL TIE-BACKS. SEE BUILDING EXTERIOR ELEVATIONS AND SCHEDULES FOR ADDITIONAL INFORMATION.
13. RECESSED SUPPLY DIFFUSER
14. EXTERIOR WALL SCONCE TYP.
15. RESTROOM WALL SCONCE
16. EXIT SIGNAGE TO BE WALL MOUNTED IMMEDIATELY ABOVE STOREFRONT FRAMING. SEE ELECTRICAL DRAWINGS FOR ADDITIONAL INFORMATION

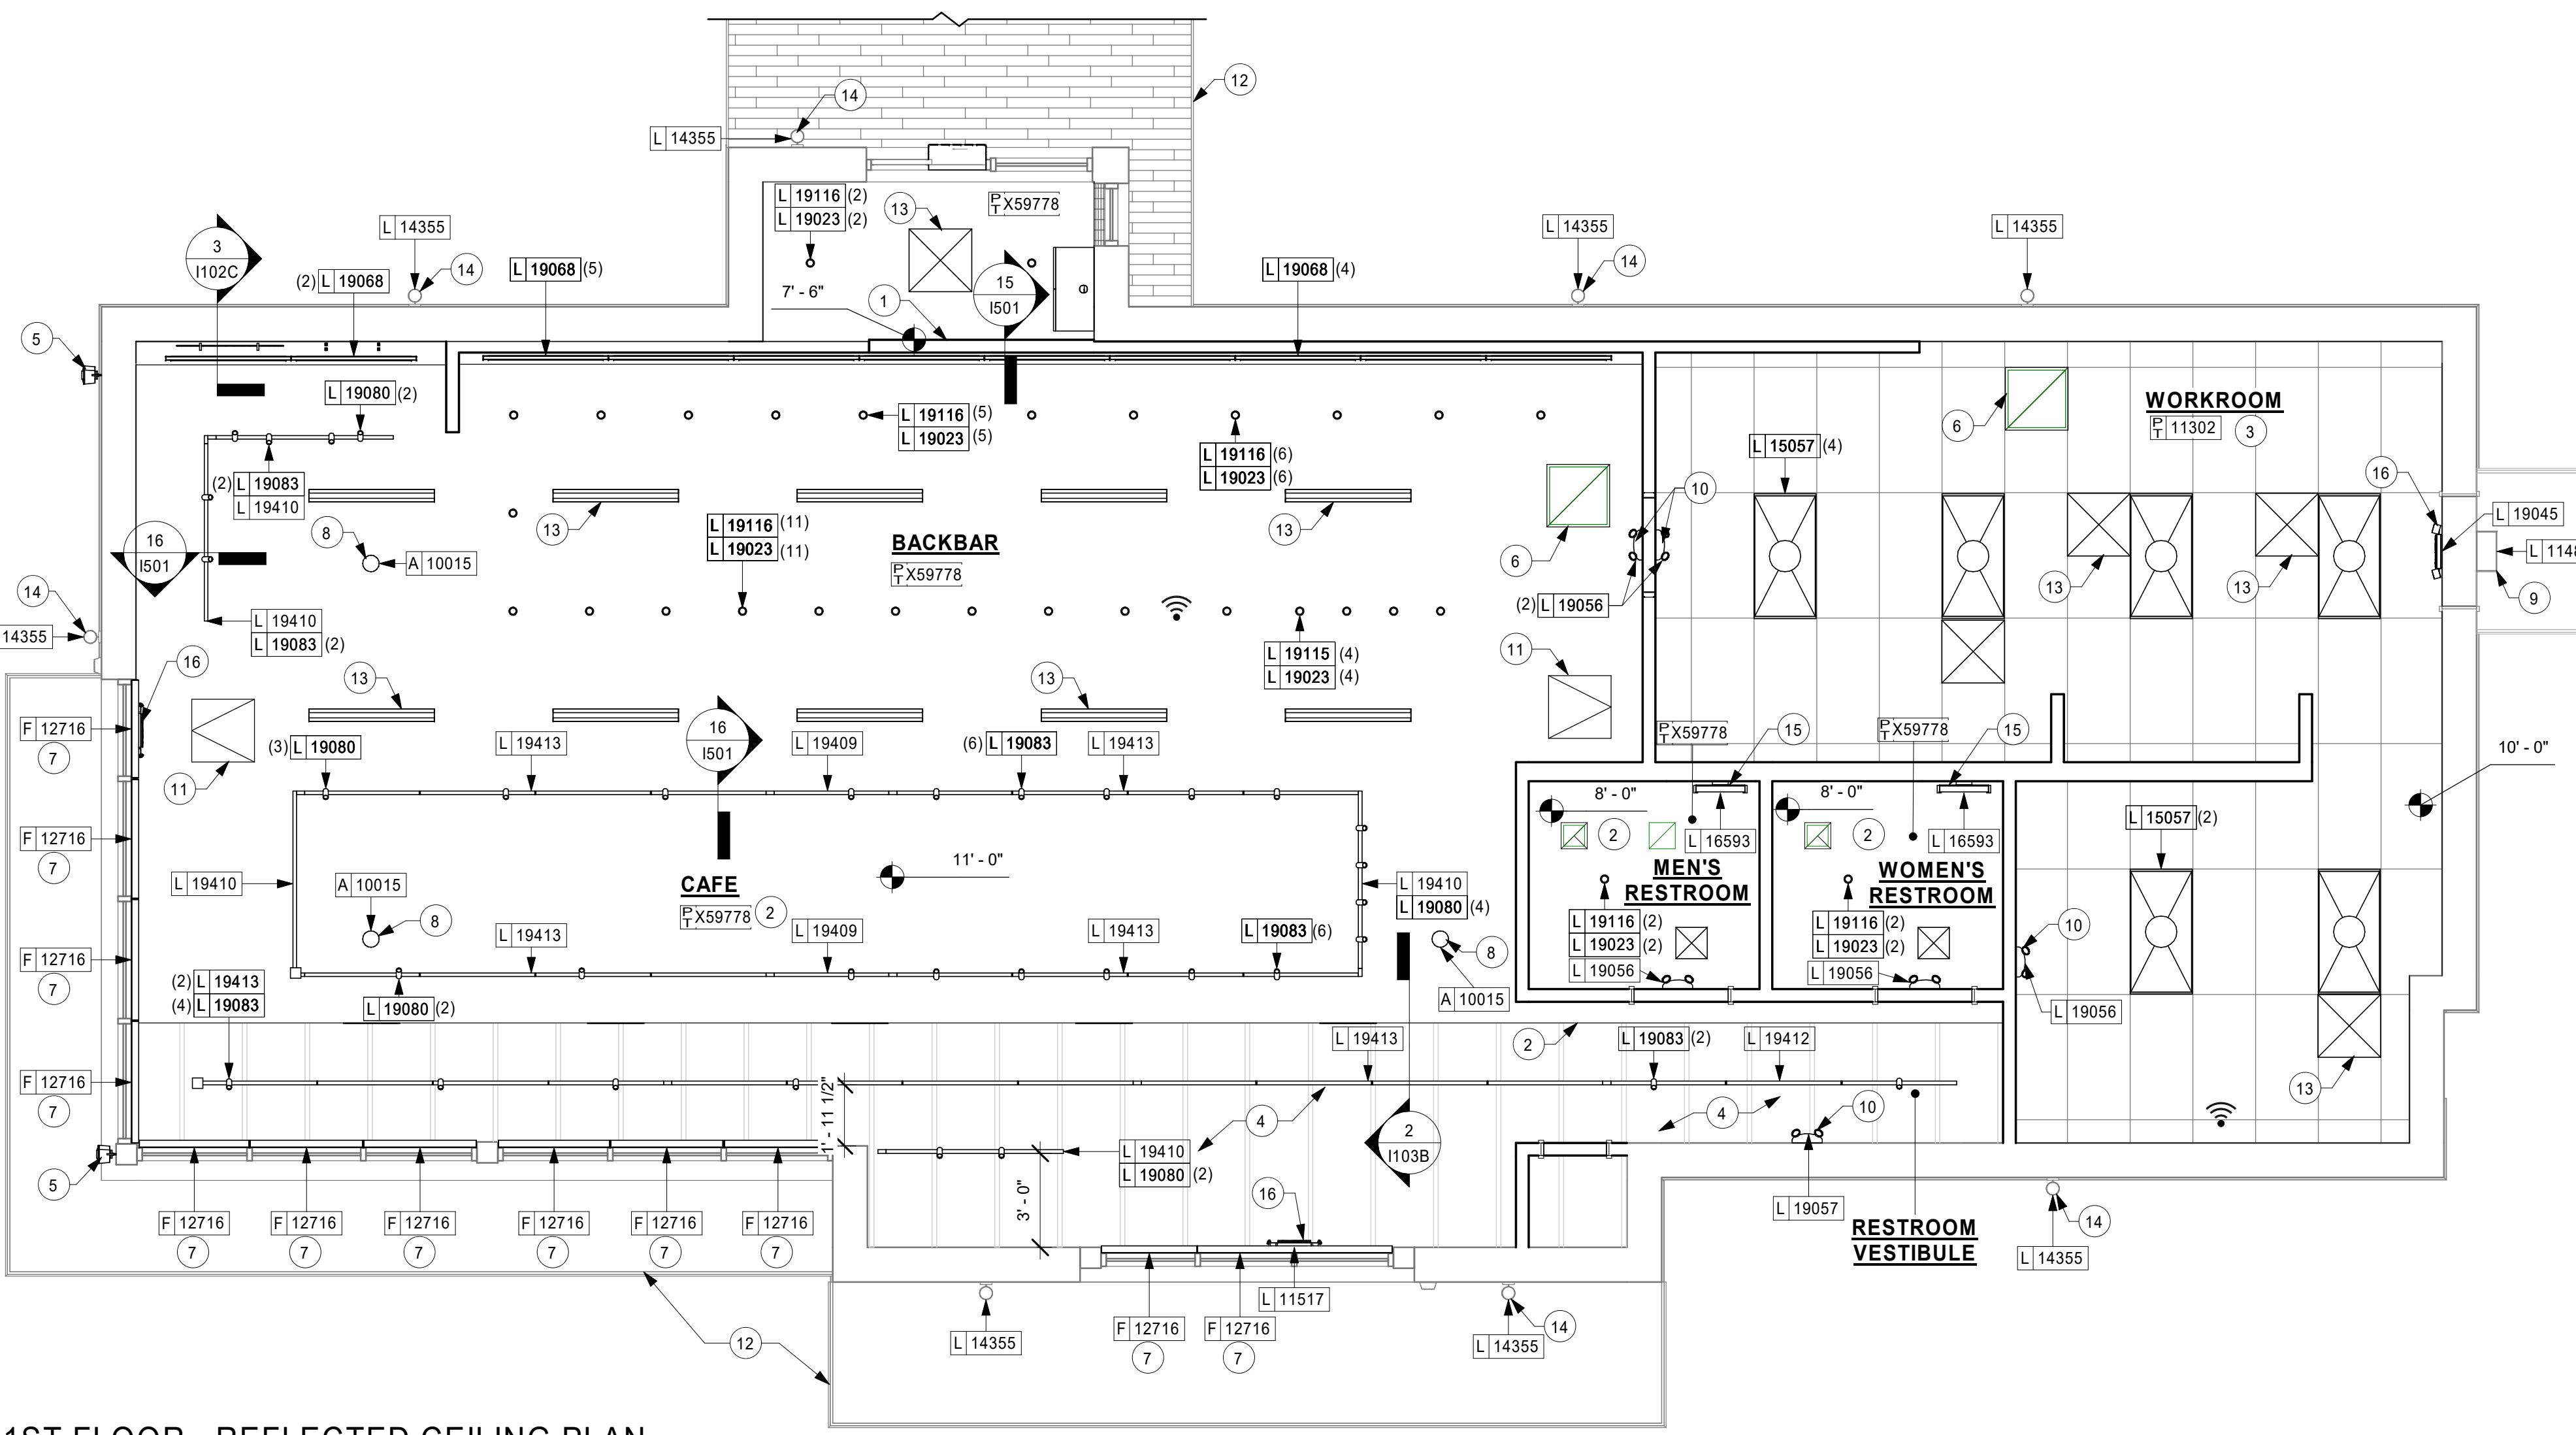

RESPONSIBILITY LEGEND

GC GENERAL CONTRACTOR
LL LANDLORD
SB STARBUCKS

Scale: 1/4" = 1'-0"
0 2' 4' 8'





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STARBUCKS TEMPLATE VERSION: i2019-07-26

GPD GROUP
Professional Corporation

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P: 330-572-2100 F: 330-572-2101

GPD PROJECT NO: 2019261.12



01/03/2020

PROJECT NAME:
HWY 81 & LAKE DOW

PROJECT ADDRESS:
850 HWY 81
MCDONOUGH, GA 30252

STORE #: 59695
PROJECT #: 85535-001
ISSUE DATE: 12/03/2019
DESIGN MANAGER: RV
PRODUCTION DESIGNER: TW
CHECKED BY: GPD GROUP

Revision Schedule

Rev	Date	By	Description

SHEET TITLE:
LIGHTING PLAN

SCALE: AS SHOWN

SHEET NUMBER:
I103B

LIGHTING PLAN NOTES

- A. IF REQUIRED BY LOCAL CODE, GENERAL CONTRACTOR TO PROVIDE SEMI-RECESSED SPRINKLER HEADS WITH POLISHED CHROME ESCUTCHEONS CENTERED IN ACOUSTICAL CEILING TILE. IF PENDANT HEADS ARE REQUIRED IN GYPSUM SOFFIT OVER FRONTBAR, CONCEAL SUPPLY PIPING WITHIN SOFFIT. GENERAL CONTRACTOR TO SUBMIT SPRINKLER LAYOUT TO STARBUCKS' CONSTRUCTION MANAGER FOR APPROVAL PRIOR TO INSTALLATION.
- B. GENERAL CONTRACTOR TO PROVIDE AND LOCATE SPRINKLERS PER LOCAL CODES. CONTACT STARBUCKS CONSTRUCTION MANAGER IF DESIGN INTENT IS AFFECTED.
- C. WHERE ACOUSTICAL CEILING MEETS WALL, PROVIDE ANGLE WALL MOLDING FOR REVEAL. MATCH CEILING GRID COLOR WHEN APPLICABLE.
- D. LEAVE (10) ADDITIONAL RETAIL CEILING TILES, TO MATCH RETAIL CEILING PAINT COLOR, ABOVE THE WORKROOM CEILING AT MANAGER'S DESK FOR FUTURE USE.
- E. PROVIDE GROMMET AT ALL CEILING PENETRATIONS FOR FIXTURES OR SUPPORTS.
- F. HEATING, VENTILATING, AND AIR CONDITIONING (HVAC) SHOWN FOR DESIGN INTENT ONLY. CONTACT PROJECT MANAGER IF CHANGED.
- G. DIFFUSERS AND RETURNS AT BACKBAR IN ACOUSTICAL CEILING TILE TO BE CENTERED IN TILE, PAINTED TO MATCH ADJACENT FINISHES, TYPICAL.
- H. PAINT ALL EXPOSED HVAC DUCTS, HVAC DIFFUSERS, RECESSED SPEAKERS, LIGHT TRIM RINGS, PIPING, CONDUIT AND JUNCTION BOXES THE SAME COLOR AS SPECIFIED ON SURROUNDING CEILING OR SOFFIT UNLESS NOTED OTHERWISE. TYPICAL THROUGHOUT RETAIL AREA OF STORE.
- J. PAINT SUBSTITUTIONS ARE NOT ALLOWED. USE STARBUCKS' NATIONAL ACCOUNT "COLOR CODE" WHEN ORDERING PAINTS.
- K. SEE LIGHTING DESIGN PLAN FOR LIGHTING SCHEDULE, FIXTURE TYPES AND DIMENSIONED LOCATIONS.
- L. ADJUST EACH TRACK HEAD AT MENU BOARD LIGHTING SO LIGHT BEAMS ARE POINTING CONSISTENTLY, JUST BELOW THE CENTER OF EACH MENU BOARD PANEL.. ADJUST FOCUS OF ALL TRACK AND RECESSED DIRECTIONAL LIGHTING TO FULLY ILLUMINATE ALL ARTWORK, MENU BOARDS, AND MERCHANDISE BAYS.
- M. ALL FIXTURES IN FOOD PREPARATION AREA SHALL HAVE SHATTERPROOF LAMPS IF THE FIXTURE IS NOT LENSED.
- N. CENTER EMERGENCY/EXIT LIGHTS ABOVE DOORS, UON.

SHEET NOTES

1. LIGHT COVE
2. OPEN STRUCTURE ABOVE
3. EXPOSED STRUCTURE AND DUCTWORK TO BE PAINTED TO MATCH CEILING AS SCHEDULED


LIGHTING LEGEND

- TRACK HEAD: SPOT (2" HOUSING DID 19083)
- TRACK HEAD: FLOOD (2" HOUSING DID 19080)
- CAN FIXTURE: NARROW FLOOD (2" DID 19116)
- CAN FIXTURE: SPOT (2" DID 19115)

RESPONSIBILITY LEGEND

- GC GENERAL CONTRACTOR
LL LANDLORD
SB STARBUCKS

0 2' 4' 8'
Scale: 1/4" = 1'-0"

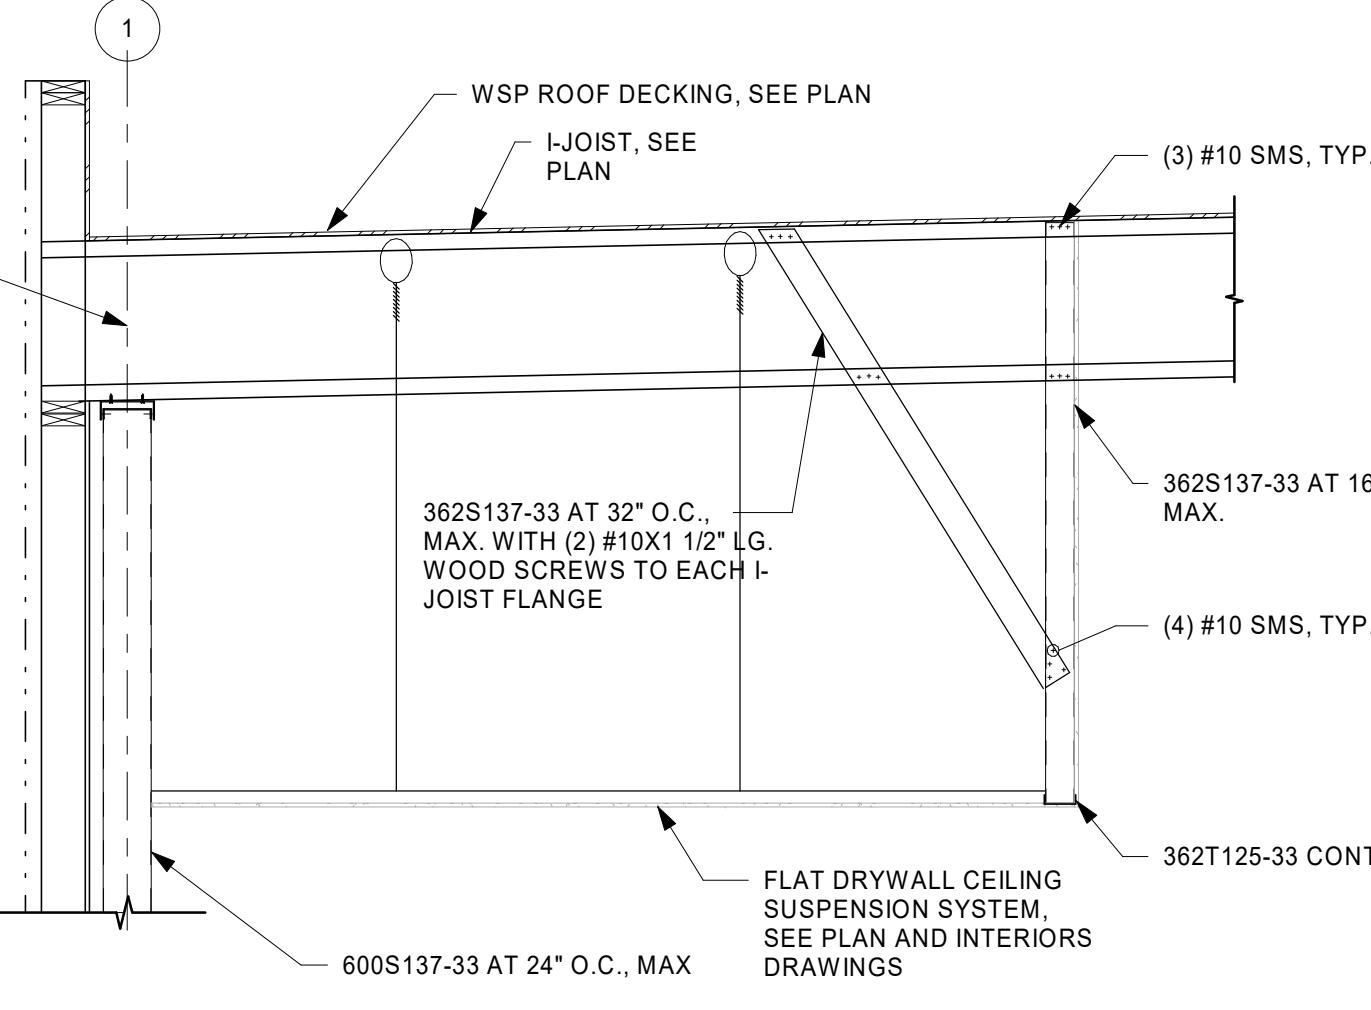

SECTION AT BULKHEAD

Scale: 1/2" = 1'-0"



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P: 330-572-2100 F: 330-572-2101
GPD PROJECT NO: 2019261.12

STATE OF GEORGIA
MARK S. SALOPEK
CERTIFIED AND APPROVED
01/03/2020

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MCDONOUGH, GA 30252

STORE #: 59695
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ISSUE DATE: 12/03/2019
DESIGN MANAGER: RV
PRODUCTION DESIGNER: TW
CHECKED BY: GPD GROUP

Revision Schedule

Rev	Date	By	Description

SHEET TITLE:
FLOOR FINISH PLAN

SCALE: AS SHOWN

SHEET NUMBER:

1104

WALL BASE SCHEDULE - "B"					
DESIGN ID	LENGTH	DESCRIPTION	FURN. BY	INST. BY	COMMENTS
X41003	66' - 10 1/2"	1" x 1" THICK TRIM	GC	GC	TRIM AT TILE/PAINT TRANSITION PAINTED SW7646 - FIRST STAR
X51055	23' - 8 3/4"	QUADEC SCHLUTER	GC	GC	CUSTOM QUADEC SCHLUTER: Q100 ABGB, FINISH: STYLMARK #212 MATERIAL SAMPLE TO BE SENT TO DESIGNER BEFORE INSTALLATION
TILE BASE					
19795	229' - 1 1/4"	POLYVINYL FLOOR TILE - ECOGRIP - PEWTER	SB	GC	
20215	118' - 2 1/2"	TILE BASE - FORMULA - UNION BLACK - 6X12IN 150X300MM	SB	GC	GROUT: MAPEI - 10 BLACK, OR EQUAL
X41001	49' - 3 3/4"	JOLLY SCHLUTER TRIM AT RESTROOM TILE	GC	GC	JOLLY SCHLUTER: ABGB BRUSHED: COLOR ANTHRACITE

FLOOR TREATMENT SCHEDULE - "T"					
DESIGN ID	AREA	DESCRIPTION	FURN. BY	INST. BY	COMMENTS
PLASTIC					
19795	1043 SF	POLYVINYL FLOOR TILE - ECO-GRIP - PEWTER	SB	GC	
TILE					
20220	1158 SF	TILE - LUNAR - TITANIUM - 24X24IN 600X600MM	SB	GC	GROUT: MAPEI - 09 GRAY, OR EQUAL
WALK OFF MAT					
19289	39 SF	WALK OFF MAT - HELIX Z2 - BLACK AND GUNMETAL - 12X9IN 305X230MM	SB	GC	CANNOT BE CUT TO SIZE; USE HELIX Z1 AS BORDER WHEN FULL TILES CANNOT BE PLACED

KEYED NOTES

1. TILE START POINT WHERE INDICATED.
2. FLOOR SINK LOCATION. SEE BUILDING FLOOR PENETRATION PLAN ON SHEET A102 AND PLUMBING FOR ADDITIONAL INFORMATION.
3. RECESSED ELECTRICAL. SEE BUILDING FLOOR PENETRATION PLAN ON SHEET A102 AND ELECTRICAL FOR ADDITIONAL INFORMATION.
4. RECESSED WALK-OFF MAT AT ENTRY. SEE INTERIOR DETAIL SHEETS FOR TRANSITION.
5. MOP SINK WHERE INDICATED. SEE PLUMBING PLANS FOR MORE INFORMATION.

GENERAL NOTES

- A. WORKROOM TO BE FINISHED PER LOCAL CODE REQUIREMENTS.
- B. FLOORS, WALLS AND CEILING FINISHES IN FOOD PREPARATION AREAS SHALL BE SMOOTH, NON-TOXIC, NON-ABSORBENT, DURABLE AND EASILY CLEANABLE. PAINT SHALL BE WASHABLE; SEMI-GLOSS OR HIGH-GLOSS FINISH.
- C. STARBUCKS TO SUPPLY FLOORING AND BASE FOR FRONT AND BACK OF HOUSE AS NOTED IN SCHEDULES. GENERAL CONTRACTOR TO INSTALL. GENERAL CONTRACTOR TO SUPPLY WORKROOM TILE AND BASE AND INSTALL. GENERAL CONTRACTOR TO SUPPLY AND INSTALL MORTAR, ADHESIVE, AND GROUT. GENERAL CONTRACTOR TO INSPECT ALL TILES AND REJECT DAMAGED OR SUBSTANDARD TILES PRIOR TO INSTALLATION.
- D. ALIGN TILE TRANSITIONS ON WHOLE TILES AS SHOWN.
- E. ALL FLOOR AND WALL JUNCTIONS IN STORAGE AND FOOD PREPARATION AREAS SHALL HAVE A 6" COVED BASE.

CONCRETE FINISH NOTES

FINISHING PROCESS FOR CONCRETE SLAB


- INTEGRAL GRINDING WILL BEGIN AT A MINIMUM OF 36 HYBRID BOND DIAMOND GRIT. AFTER A UNIFORM SCRATCH PATTERN HAS BEEN DEVELOPED IN THE SURFACE OF THE CONCRETE: BEGIN GRINDING THE FLOOR UP TO A DIAMOND GRIT ACCEPTABLE FOR DENSIFYING. LEVEL OF FINISH TO BE [OPEN AGGREGATE, SALT & PEPPER, LIGHT SAND]. GC TO HAND GRIND OR USE A STAND-UP EDGER FOR GRINDING/POLESING EDGE AND INSIDE CORNER CONDITIONS.
- CLEAN FLOOR WITH VEXCON CERTI-SHINE CLEAR DENSIFIER APPLIED IN MULTIPLE COATS.
- AFTER THE DENSIFIER HAS CURED, RINSE THE FLOOR WITH VEXCON CERTI-SHINE FIXATIVE, REMOVING UNREACTED SILICATES FROM THE SURFACE OF THE CONCRETE AND IMPROVING THE CHEMICAL AND STAIN RESISTANCE OF THE POLISHED CONCRETE SYSTEM.
- ONCE THE RINSE HAS BEEN COMPLETED CONTINUE POLISHING THE FLOOR UP TO A 400 GRT POLISH.
- CLEAN FLOOR AGAIN AND APPLY A VEXCON CERTI-SHINE FINISH COAT ULTRA WB IN MULTIPLE COATS. ALLOWING FOR OPTIMAL PENETRATION.
- AFTER THE STAIN PROTECTANT HAS CURED, BURNISH THE FLOOR WITH A HIGH SPEED BUFFER.

POLISHING PROCEDURE :

- ADHERE TO INDUSTRY STANDARD POLISHING PROCEDURES FOR DRY AND WET GRINDING/POLISHING IS ACCEPTABLE WHEN INDUSTRY STANDARD POLISHING PROCEDURES ARE ADHERED TO.
- SCRUB AND RINSE SLAB SURFACE WITH CLEAN WATER AND VACUUM WITH AUTO-SCRUBBER BETWEEN AND AFTER FINAL POLISHING PASSES..
- SEQUENTIAL PROGRESSION OF DIAMOND POLISHING STEPS SHALL BE REQUIRED AND LIMITED TO NO MORE THAN DOUBLE THE GRT VALUE OF THE PREVIOUS DIAMONDS USED.
- OVERLAP ADJACENT POLISHING PASSES BY 25 PERCENT.
- PERFORM EACH PASS PERPENDICULAR TO THE OTHER PASS NORTH/SOUTH THEN EAST/WEST; MULTIPLE PASSES MAY BE NEEDED.
- PROGRESSIVELY GRIND AND POLISH THE SLAB SURFACE UTILIZING APPROVED DIAMOND SEGMENTS AS NECESSARY TO PRODUCE FINISHING REQUIREMENTS.

PREPARATION :

- Clean dirt, dust, oil, grease and other contaminants that interfere with penetration or performance of specified product from surfaces. Use appropriate concrete cleaners approved by the concrete surface treatment manufacturer where necessary. Rinse thoroughly using pressure water spray to remove cleaner residues. Allow surfaces to dry completely before application of product.
- Repair, patch and fill cracks, voids, defects and damaged areas in surface as approved by the Architect. Allow repair materials to cure completely before application of product.
- Variations in substrate texture and color will affect final appearance and should be corrected prior to application of sealer/hardener system and the polishing steps.
- Protect surrounding areas prior to application of densifiers and stains. If products are accidentally misapplied to adjacent surfaces, flush with water immediately before material dries.
- Avoid contact in areas not to be treated. Avoid contact with metal, glass and painted surfaces.
- Apply specified sealants and caulking and allow complete curing before application of penetrating concrete hardener/densifier.
- Test surfaces with droplets of water. If water beads and does not penetrate surface, or penetrates only in some areas, profile surfaces by grinding, sanding, or abrasive blasting. Retest and continue profiling surface until water droplets immediately darken and uniformly penetrate concrete surfaces.

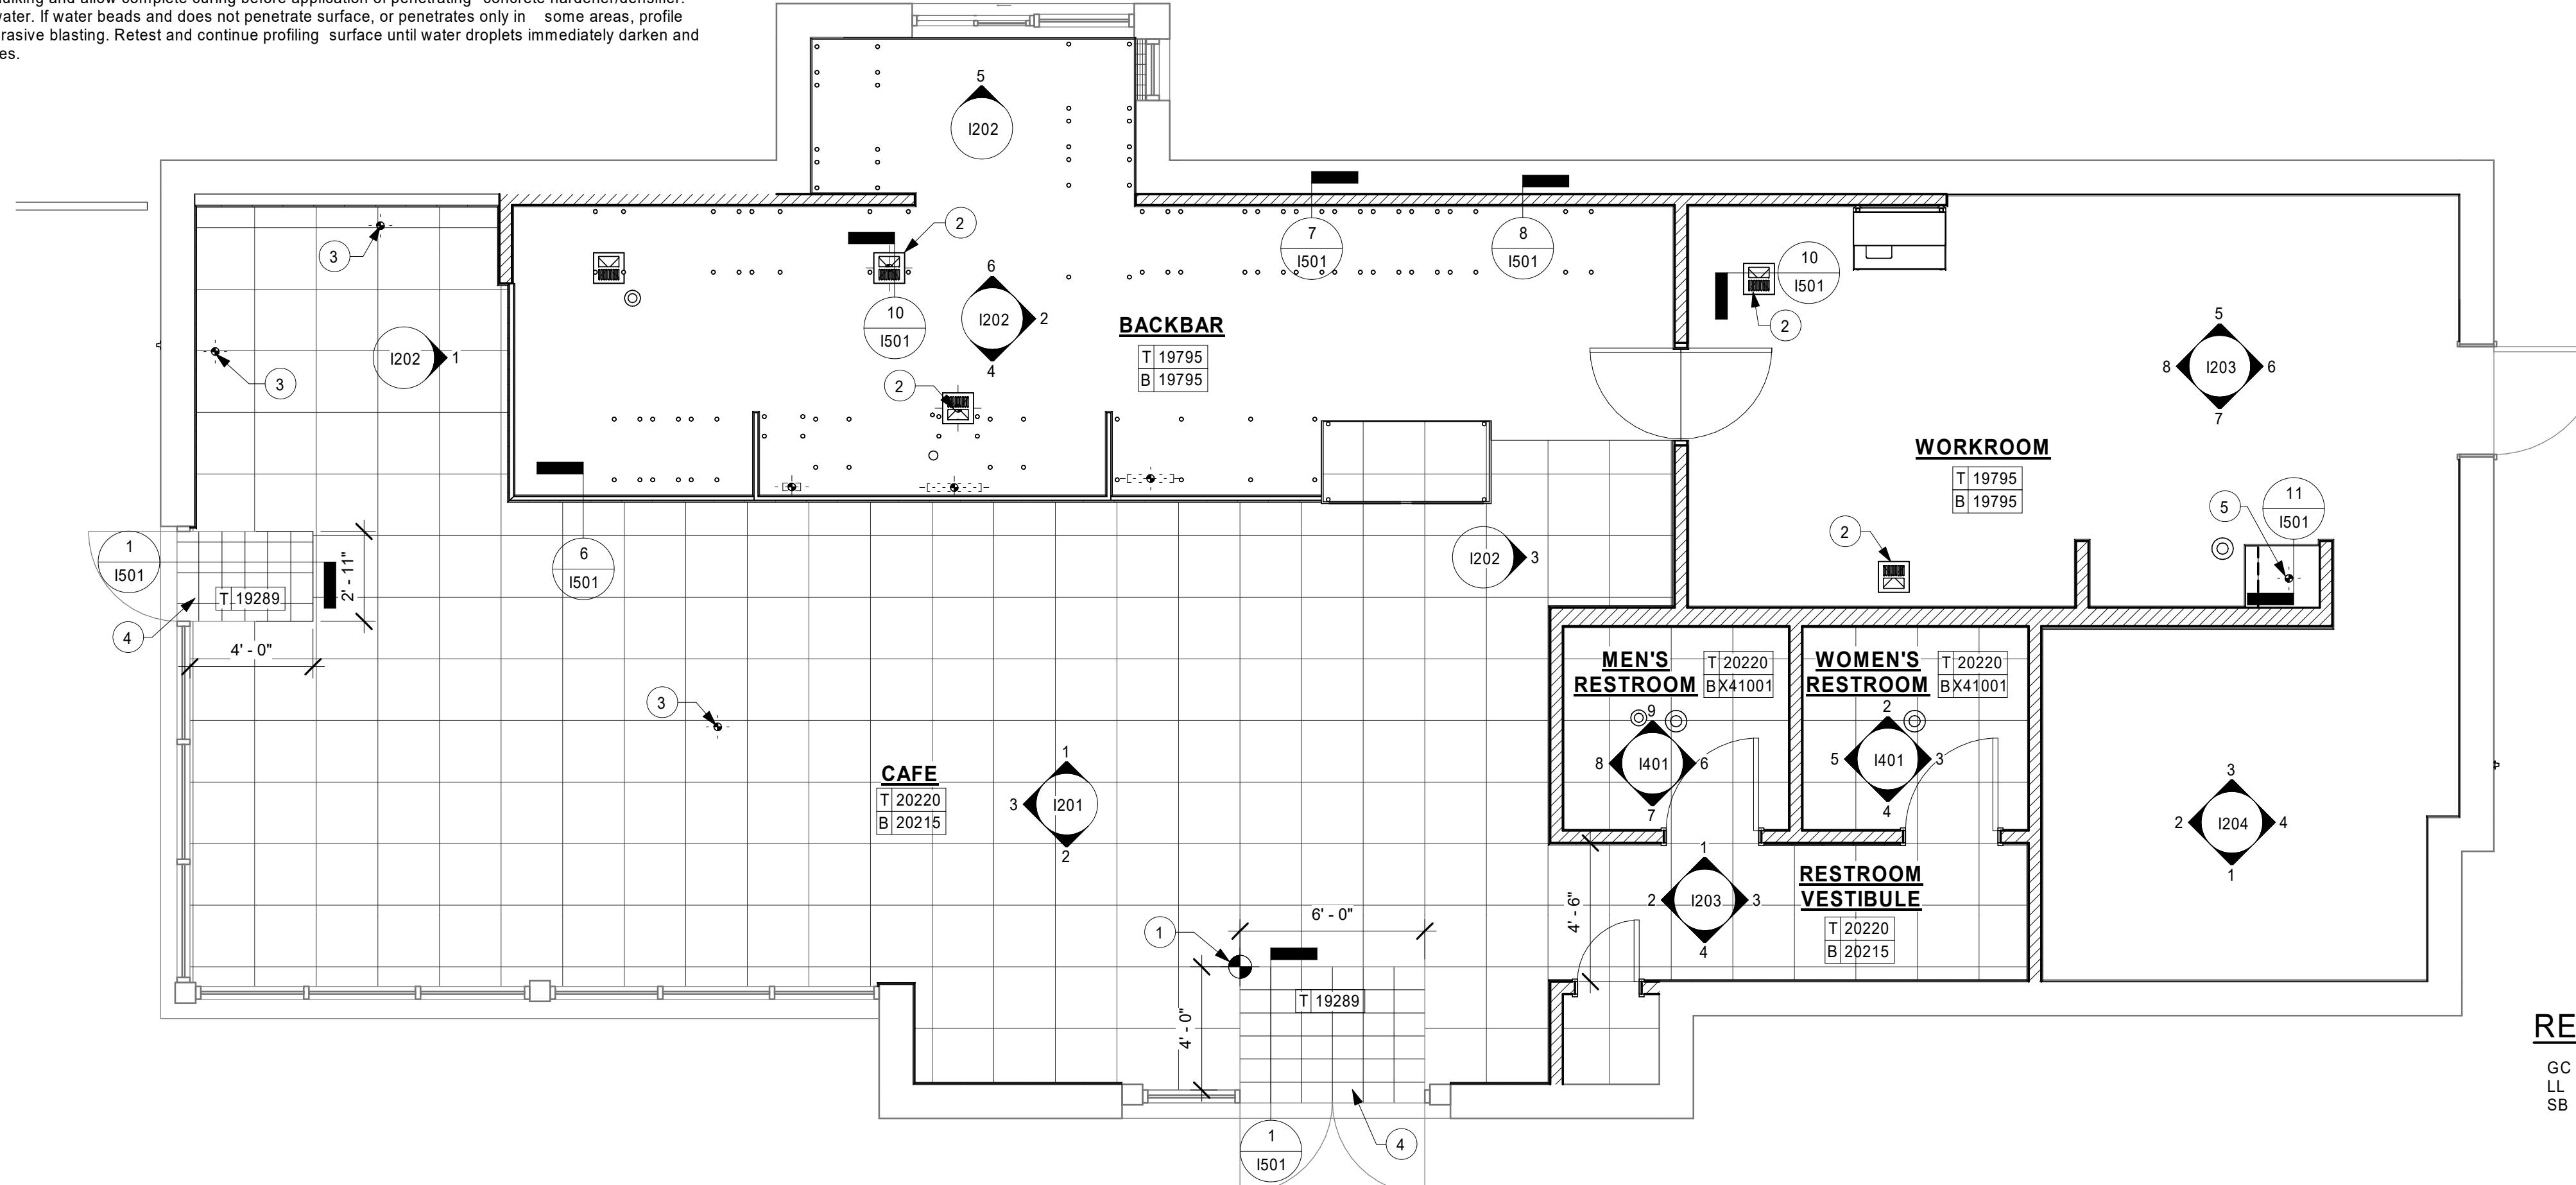

RESPONSIBILITY LEGEND

GC GENERAL CONTRACTOR
LL LANDLORD
SB STARBUCKS

0 2' 4' 8'
Scale: 1/4" = 1'-0"



1 1ST FLOOR - FLOOR FINISH PLAN

Scale: 1/4" = 1'-0"



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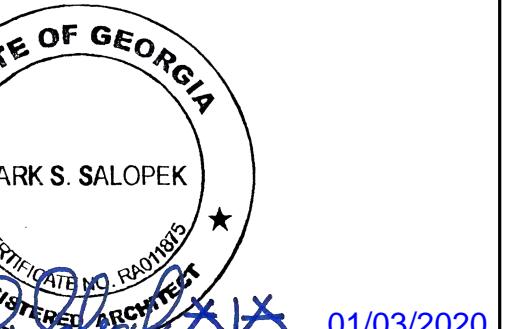
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GPD PROJECT NO: 2019261.12



MARK S. SALOPEK
01/03/2020

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PROJECT ADDRESS:
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MCDONOUGH, GA 30252


STORE #: 59695
PROJECT #: 85535-001
ISSUE DATE: 12/03/2019
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Revision Schedule

Rev Date By Description


SHEET TITLE:
INTERIOR FINISH ELEVATIONS
SCALE: AS SHOWN

SHEET NUMBER:
I201

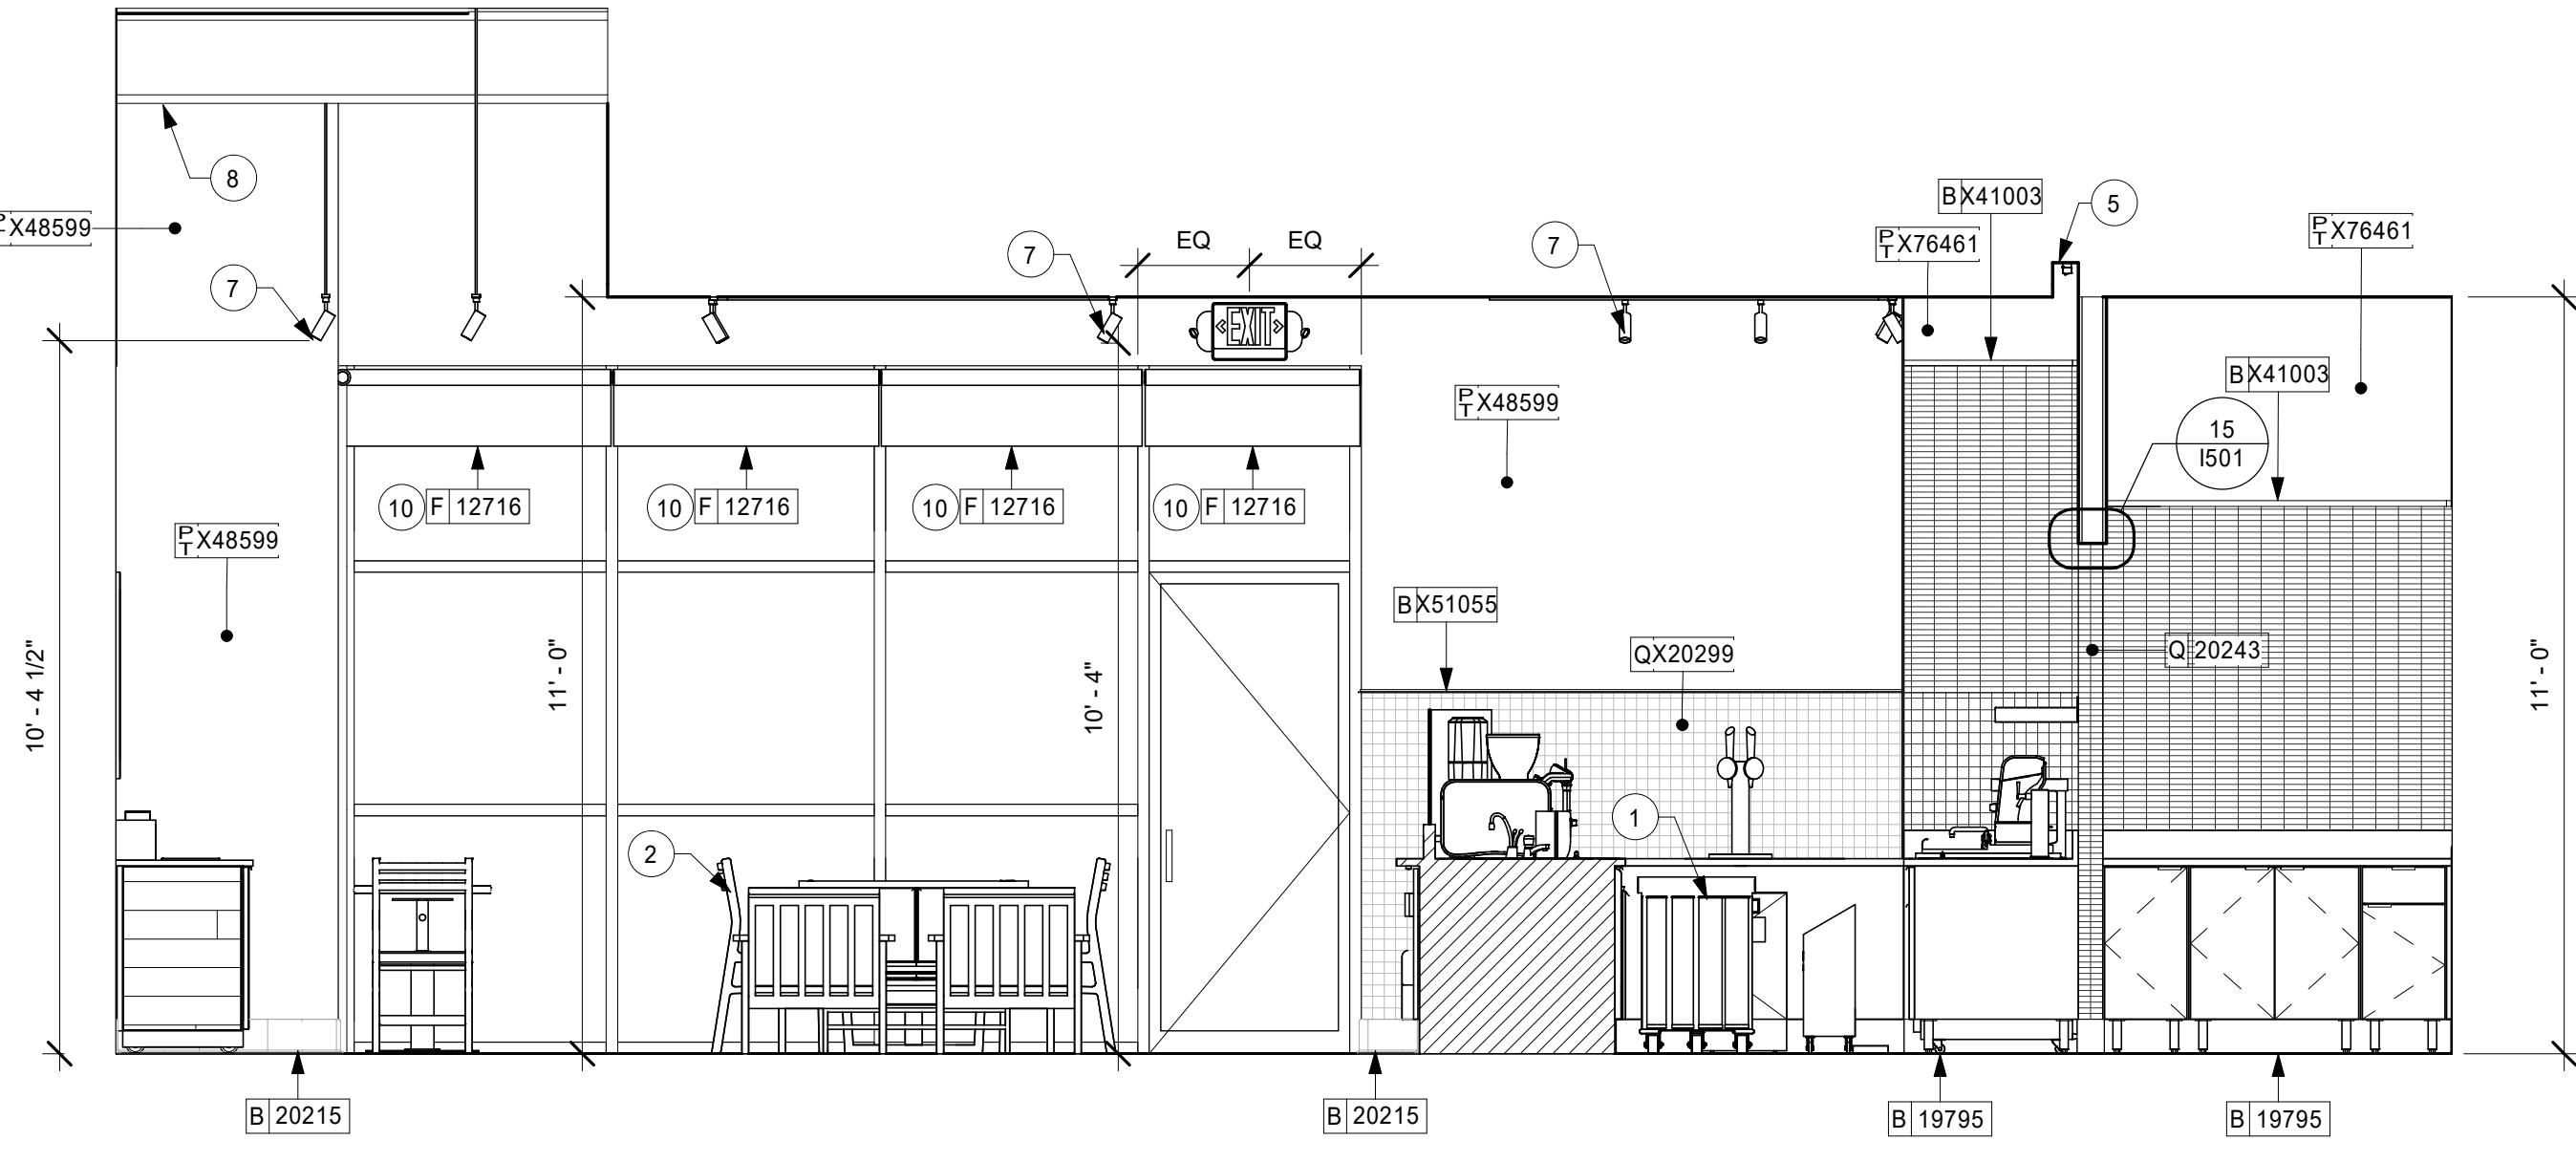


CAFE & BACKBAR

Scale: 3/8" = 1'-0"

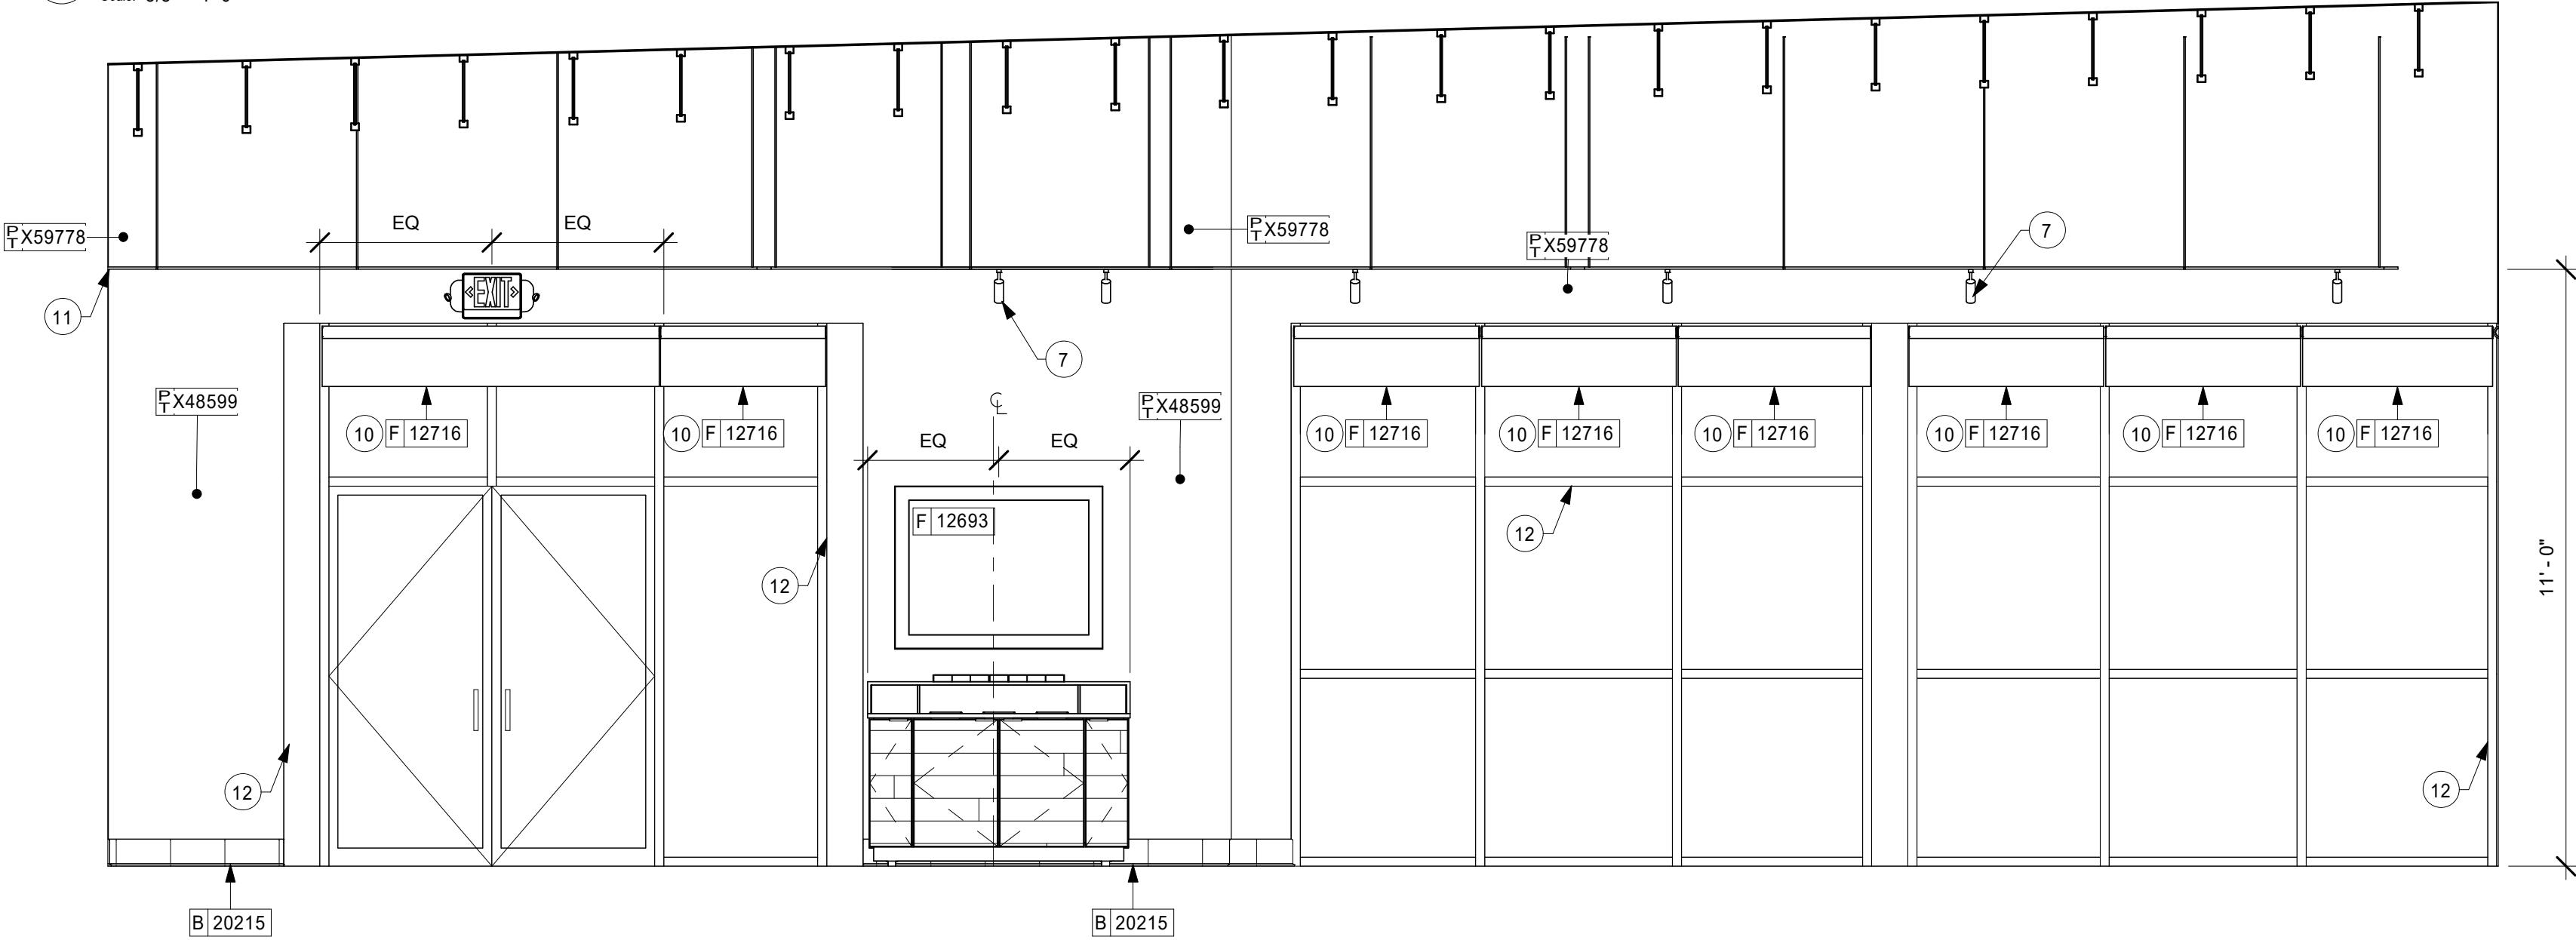

CAFE

Scale: 3/8" = 1'-0"

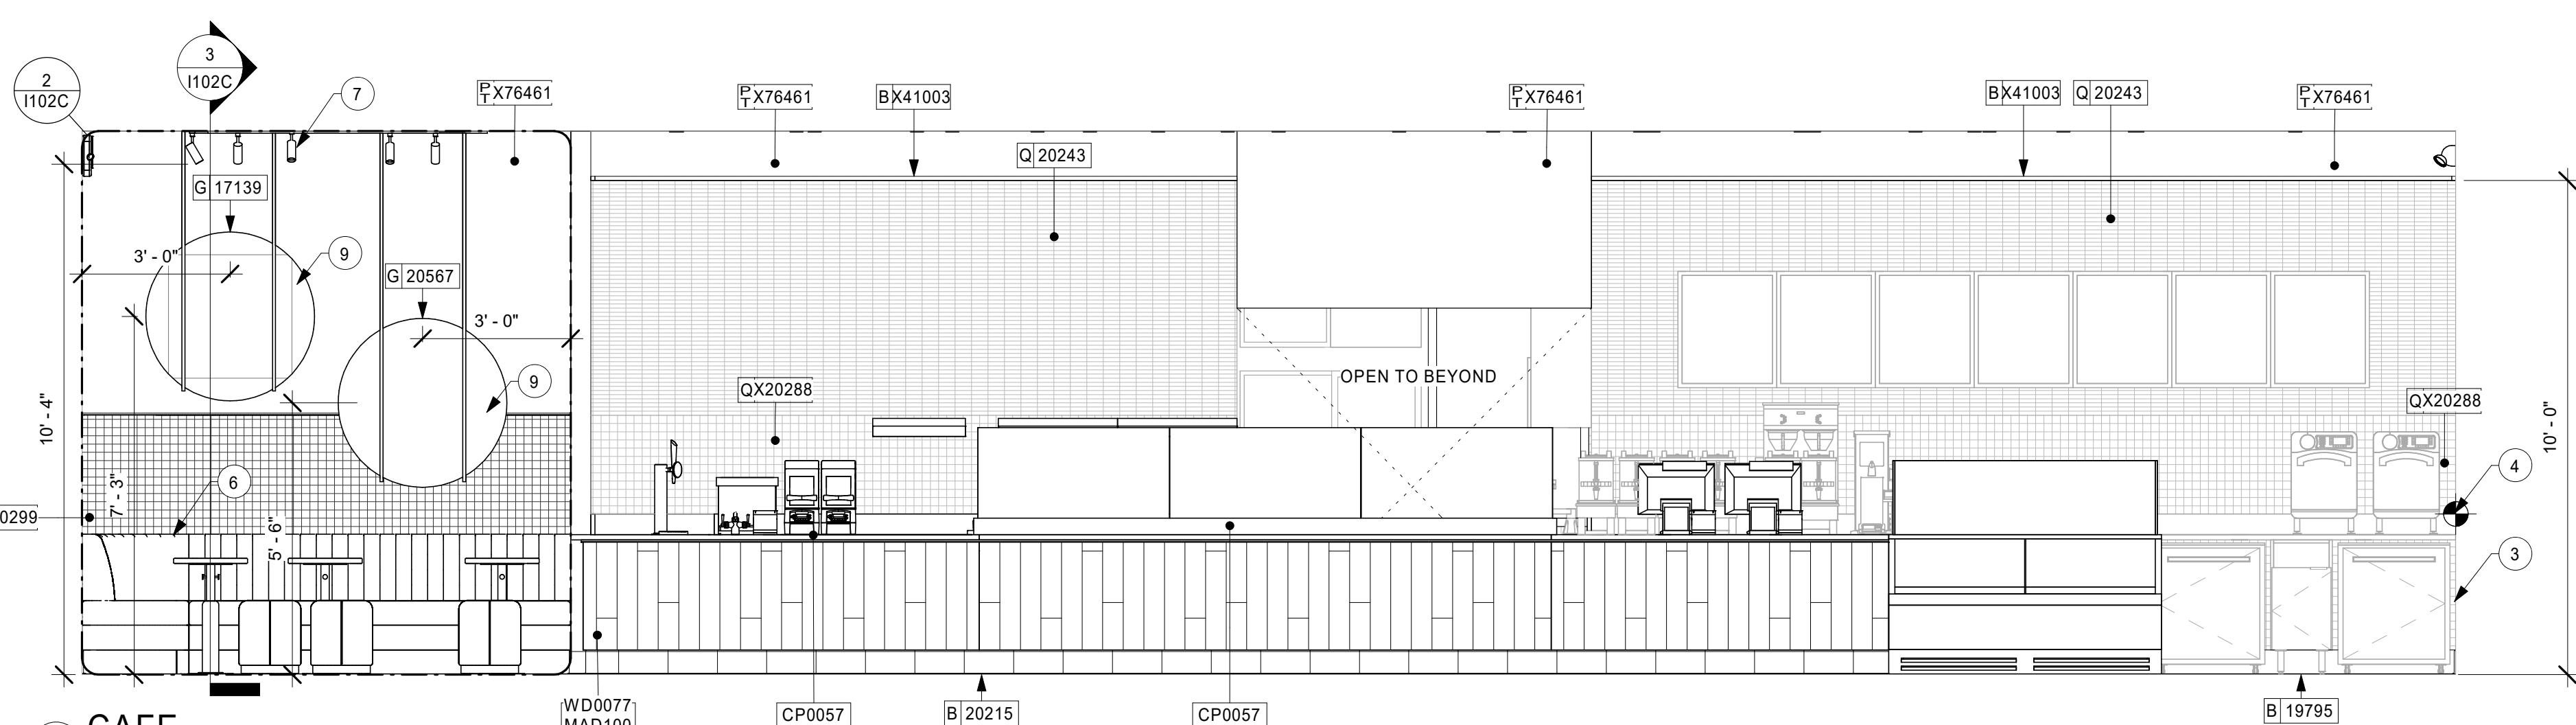

CAFE

Scale: 3/8" = 1'-0"

LEGEND

INDICATES WALL BLOCKING.
FIRE TREATED WALL BLOCKING TO BE PROVIDED AS REQUIRED TO SUPPORT WALL ATTACHMENTS. EXTEND BLOCKING 4" (100mm) BEYOND EDGE OF ATTACHMENTS.

WALL TILE START POINT DATUM

KEYED NOTES

1. CUP DISPENSERS. SEE FF & E PLAN ON SHEET I101 FOR ADDITIONAL INFORMATION.
 2. CAFE FURNITURE. SEE FF E PLAN (SHEET I-101) FOR LAYOUT.
 3. WALL TILE TO EXTEND BELOW WARMING STATION TO TOP OF WALL BASE.
 4. TILE START POINT WHERE INDICATED.
 5. COVE FOR WALL FLOOD LIGHT
 6. BANQUETTE SEATING
 7. MOUNT TRACK LIGHTING FLUSH WITH GYP. CEILING AT 11'-0". SUSPEND TRACK SO BOTTOM OF TRACK HEAD IS 10'-4" A.F.F. WHERE STRUCTURE IS EXPOSED
 8. PAINT EXPOSED STRUCTURE AND DUCTWORK SW7018 TO MATCH CEILING AS SCHEDULED
 9. CUSTOM ARTWORK AND MOUNTING. SEE ENLARGED DETAIL FOR MORE INFORMATION
 10. ROLLER SHADES, TYP.
 11. HORIZONTAL PAINT TRANSITION AT 11'-0"
 12. ALUMINUM STOREFRONT
- E. PAINT SUBSTITUTIONS ARE NOT ALLOWED. USE STARBUCKS NATIONAL ACCOUNT COLOR CODE WHEN ORDERING PAINTS.
- F. FLOORS, WALLS AND CEILING FINISHES IN FOOD PREPARATION AREAS SHALL BE SMOOTH, NON-TOXIC, NON-ABSORBENT, DURABLE AND EASILY CLEANABLE. PAINT SHALL BE WASHABLE: SEMI-GLOSS OR HIGH GLOSS FINISH.
- G. ALL WOOD SURFACES (DOORS, TRIM, SHELVES, CABINETRY) SHALL BE SEALED.
- H. REFER TO CASEWORK FINISH SCHEDULE ON THE CASEWORK FINISH PLAN ON SHEET I102 FOR CASEWORK FINISH MATERIAL INFORMATION.
- I. ALIGN TILE TRANSITIONS ON WHOLE TILES AS SHOWN.
- J. ALL FLOOR AND WALL JUNCTIONS IN STORAGE AND FOOD PREPARATION AREAS SHALL HAVE A 6" COVED BASE.
- K. ALL FOOD STORAGE SHALL BE 6" (150MM) A.F.F.
- L. INSTALL BLOCKING AND HANGERS FOR WALL SHELVING BEFORE INSTALLING BACK BAR TILE.
- M. GENERAL CONTRACTOR TO PROVIDE AND INSTALL WORKROOM WALL FINISHES.

GENERAL NOTES

- A. FOR GRAPHICS SCHEDULE, REFER TO THE FURNITURE, FIXTURES, AND EQUIPMENT (FF & E) SCHEDULES ON SHEET I101.
- B. REFER TO MANUFACTURER'S INSTRUCTIONS INCLUDED WITH ARTWORK/GRAFICS FOR PROPER INSTALLATION.
- C. CHANGE PAINT COLOR ONLY AT INSIDE CORNERS UNLESS OTHERWISE INDICATED.

- D. PAINT FINISHES SHALL BE APPLIED AS FOLLOWS, UNLESS NOTED OTHERWISE:
 - 1) WOODS AND METAL SURFACES SHALL BE SEMI-GLOSS OR EQUAL.
 - 2) ACCENT AND TRIM PAINTS TO BE SEMI-GLOSS OR EQUAL.
 - a. WALL AND CEILING PAINTS TO BE EGGHELL OR EQUAL.
 - 3) PAINTS IN BOH, RESTROOM(S) OR CAFE BAR SHALL BE SEMI-GLOSS OR EQUAL.

- E. PAINT SUBSTITUTIONS ARE NOT ALLOWED. USE STARBUCKS NATIONAL ACCOUNT COLOR CODE WHEN ORDERING PAINTS.

- F. FLOORS, WALLS AND CEILING FINISHES IN FOOD PREPARATION AREAS SHALL BE SMOOTH, NON-TOXIC, NON-ABSORBENT, DURABLE AND EASILY CLEANABLE. PAINT SHALL BE WASHABLE: SEMI-GLOSS OR HIGH GLOSS FINISH.

- G. ALL WOOD SURFACES (DOORS, TRIM, SHELVES, CABINETRY) SHALL BE SEALED.

- H. REFER TO CASEWORK FINISH SCHEDULE ON THE CASEWORK FINISH PLAN ON SHEET I102 FOR CASEWORK FINISH MATERIAL INFORMATION.

- I. ALIGN TILE TRANSITIONS ON WHOLE TILES AS SHOWN.

- J. ALL FLOOR AND WALL JUNCTIONS IN STORAGE AND FOOD PREPARATION AREAS SHALL HAVE A 6" COVED BASE.

- K. ALL FOOD STORAGE SHALL BE 6" (150MM) A.F.F.

- L. INSTALL BLOCKING AND HANGERS FOR WALL SHELVING BEFORE INSTALLING BACK BAR TILE.

- M. GENERAL CONTRACTOR TO PROVIDE AND INSTALL WORKROOM WALL FINISHES.

WALL BASE SCHEDULE - "B"				
DESIGN ID	LENGTH	DESCRIPTION	FURN. BY	INST. BY
CHAIR RAIL				
X41003	66'-10 1/2"	1" X 1" THICK TRIM	GC	GC
X51055	23'-8 3/4"	QUADEC SCHLUTER	GC	GC
TILE BASE				
19795	229'-1 1/4"	POLYVINYL FLOOR TILE - ECOGRIP - PEWTER	SB	GC
20215	118'-2 1/2"	TILE BASE - FORMULA - UNION BLACK - 6X12IN 150X300MM	SB	GC
X41001	49'-3 3/4"	JOLLY SCHLUTER TRIM AT RESTROOM TILE	GC	GC

WALL TREATMENT (AREA) SCHEDULE - "Q"				
DESIGN ID	AREA	DESCRIPTION	FUR. N. BY	INST. BY
X28541	241 SF	WALL COVERING - TRI-KES - COLLECTION STACY GARCIA	GC	GC
PLASTIC				
11469	2370 SF	FRP - WHITE	GC	GC
TILE				
20219	428 SF	TILE - LUNAR - TITANIUM - 6X24IN 150X600MM	SB	GC
20243	267 SF	20243 TILE - COLOR STUDIO - WHITE - BRICK MOSAIC - 12X12IN 300X300MM SHEET	SB	GC
X20288	206 SF	X20288 TILE - COLOR STUDIO - WHITE - SQUARE MOSAIC - 12X12IN 300X300MM SHEET	GC	GC
X20299	132 SF	x20299 TILE - COLOR STUDIO - MALT - SQUARE MOSAIC - 12X12IN 300X300MM SHEET	GC	GC

PAINT SCHEDULE				
DESIGN ID	DESCRIPTION	LRV	FUR. N. BY	INST. BY
X76461	SW - FIRST STAR		GC	GC
X48599	SW - MOROCCAN BROWN	8	GC	GC
X59778	SW - DOVETAIL	27	GC	GC
X70201	SW7020 BLACK FOX, OR EQUIVALENT	8	GC	GC

0 2' 4' 8'
Scale: 1/4" = 1'-0"



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SHEET TITLE:
INTERIOR FINISH ELEVATIONS
SCALE: AS SHOWN

SHEET NUMBER:
1202

WALL TREATMENT (AREA) SCHEDULE - "Q"

DESIGN ID	AREA	DESCRIPTION	FURN. N. BY	INST. BY	COMMENTS
X28541	241 SF	WALL COVERING - TRI-KES - COLLECTION STACY GARCIA	GC	GC	CODE SG2854, TYPE 2
PLASTIC					
11469	2370 SF	FRP - WHITE	GC	GC	
TITLE					
20219	428 SF	TILE - LUNAR - TITANIUM - 6X24IN 150X600MM	SB	GC	GROUT: MAPEI - 27 SILVER, OR EQUAL
20243	267 SF	20243 TILE - COLOR STUDIO - WHITE - BRICK MOSAIC - 12X12IN 300X300MM SHEET	SB	GC	GROUT: MAPEI - 11 SAHARA BEIGE, OR EQUAL
X20288	206 SF	X20288 TILE - COLOR STUDIO - WHITE - SQUARE MOSAIC - 12X12IN 300X300MM SHEET	GC	GC	GROUT: MAPEI - 11 SAHARA BEIGE, OR EQUAL
X20299	132 SF	x20299 TILE - COLOR STUDIO - MALT - SQUARE MOSAIC - 12X12IN 300X300MM SHEET	GC	GC	GROUT: MAPEI - 11 SAHARA BEIGE, OR EQUAL

WALL BASE SCHEDULE - "B"

DESIGN ID	LENGTH	DESCRIPTION	FURN. BY	INST. BY	COMMENTS
CHAIR RAIL					
X41003	66' - 10 1/2"	1" x 1" THICK TRIM	GC	GC	TRIM AT TILE/PAINT TRANSITION PAINTED SW7646 - FIRST STAR
X51055	23' - 8 3/4"	QUADEC SCHLUTER	GC	GC	CUSTOM QUADEC SCHLUTER: Q100 ABGB. FINISH: STYLMARK #212. MATERIAL SAMPLE TO BE SENT TO DESIGNER BEFORE INSTALLATION
TILE BASE					
19795	229' - 1 1/4"	POLYVINYL FLOOR TILE - ECOGRIP - PEWTER	SB	GC	
20215	118' - 2 1/2"	TILE BASE - FORMULA - UNION BLACK - 6X12IN 150X300MM	SB	GC	GROUT: MAPEI - 10 BLACK, OR EQUAL
X41001	49' - 3 3/4"	JOLLY SCHLUTER TRIM AT RESTROOM TILE	GC	GC	JOLLY SCHLUTER: ABGB BRUSHED: COLOR ANTHRACITE

KEYED NOTES

- ATTACH MENU BOARDS PER INSTALLATION DETAILS.
- SHELVING FOR CBE STATION AS SHOWN. G.C. TO PROVIDE WALL BLOCKING FOR FASTENERS.
- CUP DISPENSERS. SEE FF & E PLAN ON SHEET I101 FOR ADDITIONAL INFORMATION.
- WALL TILE BELOW EXPOSED CABINETRY AND BELOW UNDERSIDE OF COUNTERTOP SUBSTRATE TO BE FRP.
- WALL TILE TO EXTEND BELOW WARMING STATION TO TOP OF WALL BASE.
- TILE START POINT WHERE INDICATED.
- PROVIDE 6" (150MM) MIN. INTEGRAL SPLASHGUARD AT HAND SINK PER JURISDICTION REQUIREMENTS.
- DT AIR CURTAIN AS REQUIRED PER JURISDICTION BY LL.
- MOUNT TRACK LIGHTING FLUSH WITH GYP. CEILING AT 11' - 0". SUSPEND TRACK SO BOTTOM OF TRACK HEAD IS 10' - 4" A.F.F. WHERE STRUCTURE IS EXPOSED.
- TEMPERATURE CONTROLS
- BANQUETTE SEATING
- PAINT EXPOSED STRUCTURE AND DUCTWORK SW7018 TO MATCH CEILING AS SCHEDULED
- ALIGN PAINT TRANSITION WITH EDGE OF WALL
- 1X1IN WOOD TRIM. PAINT AS SCHEDULED

E. PAINT SUBSTITUTIONS ARE NOT ALLOWED. USE STARBUCKS NATIONAL ACCOUNT COLOR CODE WHEN ORDERING PAINTS.

F. FLOORS, WALLS AND CEILING FINISHES IN FOOD PREPARATION AREAS SHALL BE SMOOTH, NON-TOXIC, NON-ABSORBENT, DURABLE AND EASILY CLEANABLE. PAINT SHALL BE WASHABLE; SEMI-GLOSS OR HIGH GLOSS FINISH.

G. ALL WOOD SURFACES (DOORS, TRIM, SHELVES, CABINETRY) SHALL BE SEALED.

H. REFER TO CASEWORK FINISH SCHEDULE ON THE CASEWORK FINISH PLAN ON SHEET I102 FOR CASEWORK FINISH MATERIAL INFORMATION.

I. ALIGN TILE TRANSITIONS ON WHOLE TILES AS SHOWN.


J. ALL FLOOR AND WALL JUNCTIONS IN STORAGE AND FOOD PREPARATION AREAS SHALL HAVE A 6" COVED BASE.

K. ALL FOOD STORAGE SHALL BE 6" (150MM) A.F.F.

L. INSTALL BLOCKING AND HANGERS FOR WALL SHELVING BEFORE INSTALLING BACK BAR TILE.



M. GENERAL CONTRACTOR TO PROVIDE AND INSTALL WORKROOM WALL FINISHES.

PAINT SCHEDULE				
DESIGN ID	DESCRIPTION	LRV	FURN. N. BY	INST. BY
X76461	SW - FIRST STAR	GC	GC	COMMENTS SW7646. USE PRIMER CP-1; NCS - S 4500-N; AKZO NOBEL - 30YY 33/047
X48599	SW - MOROCCAN BROWN	8	GC	SW6060
X59778	SW - DOVETAIL	27	GC	SW7018. USE PRIMER CP-1; NCS - S 4500-N; AKZO NOBEL - 30YY 33/047
X70201	SW7020 BLACK FOX, OR EQUIVALENT	8	GC	SW 7020 SG. USE PRIMER CP-1; NCS - S 7502-Y; AKZO NOBEL - 30YY 10/038

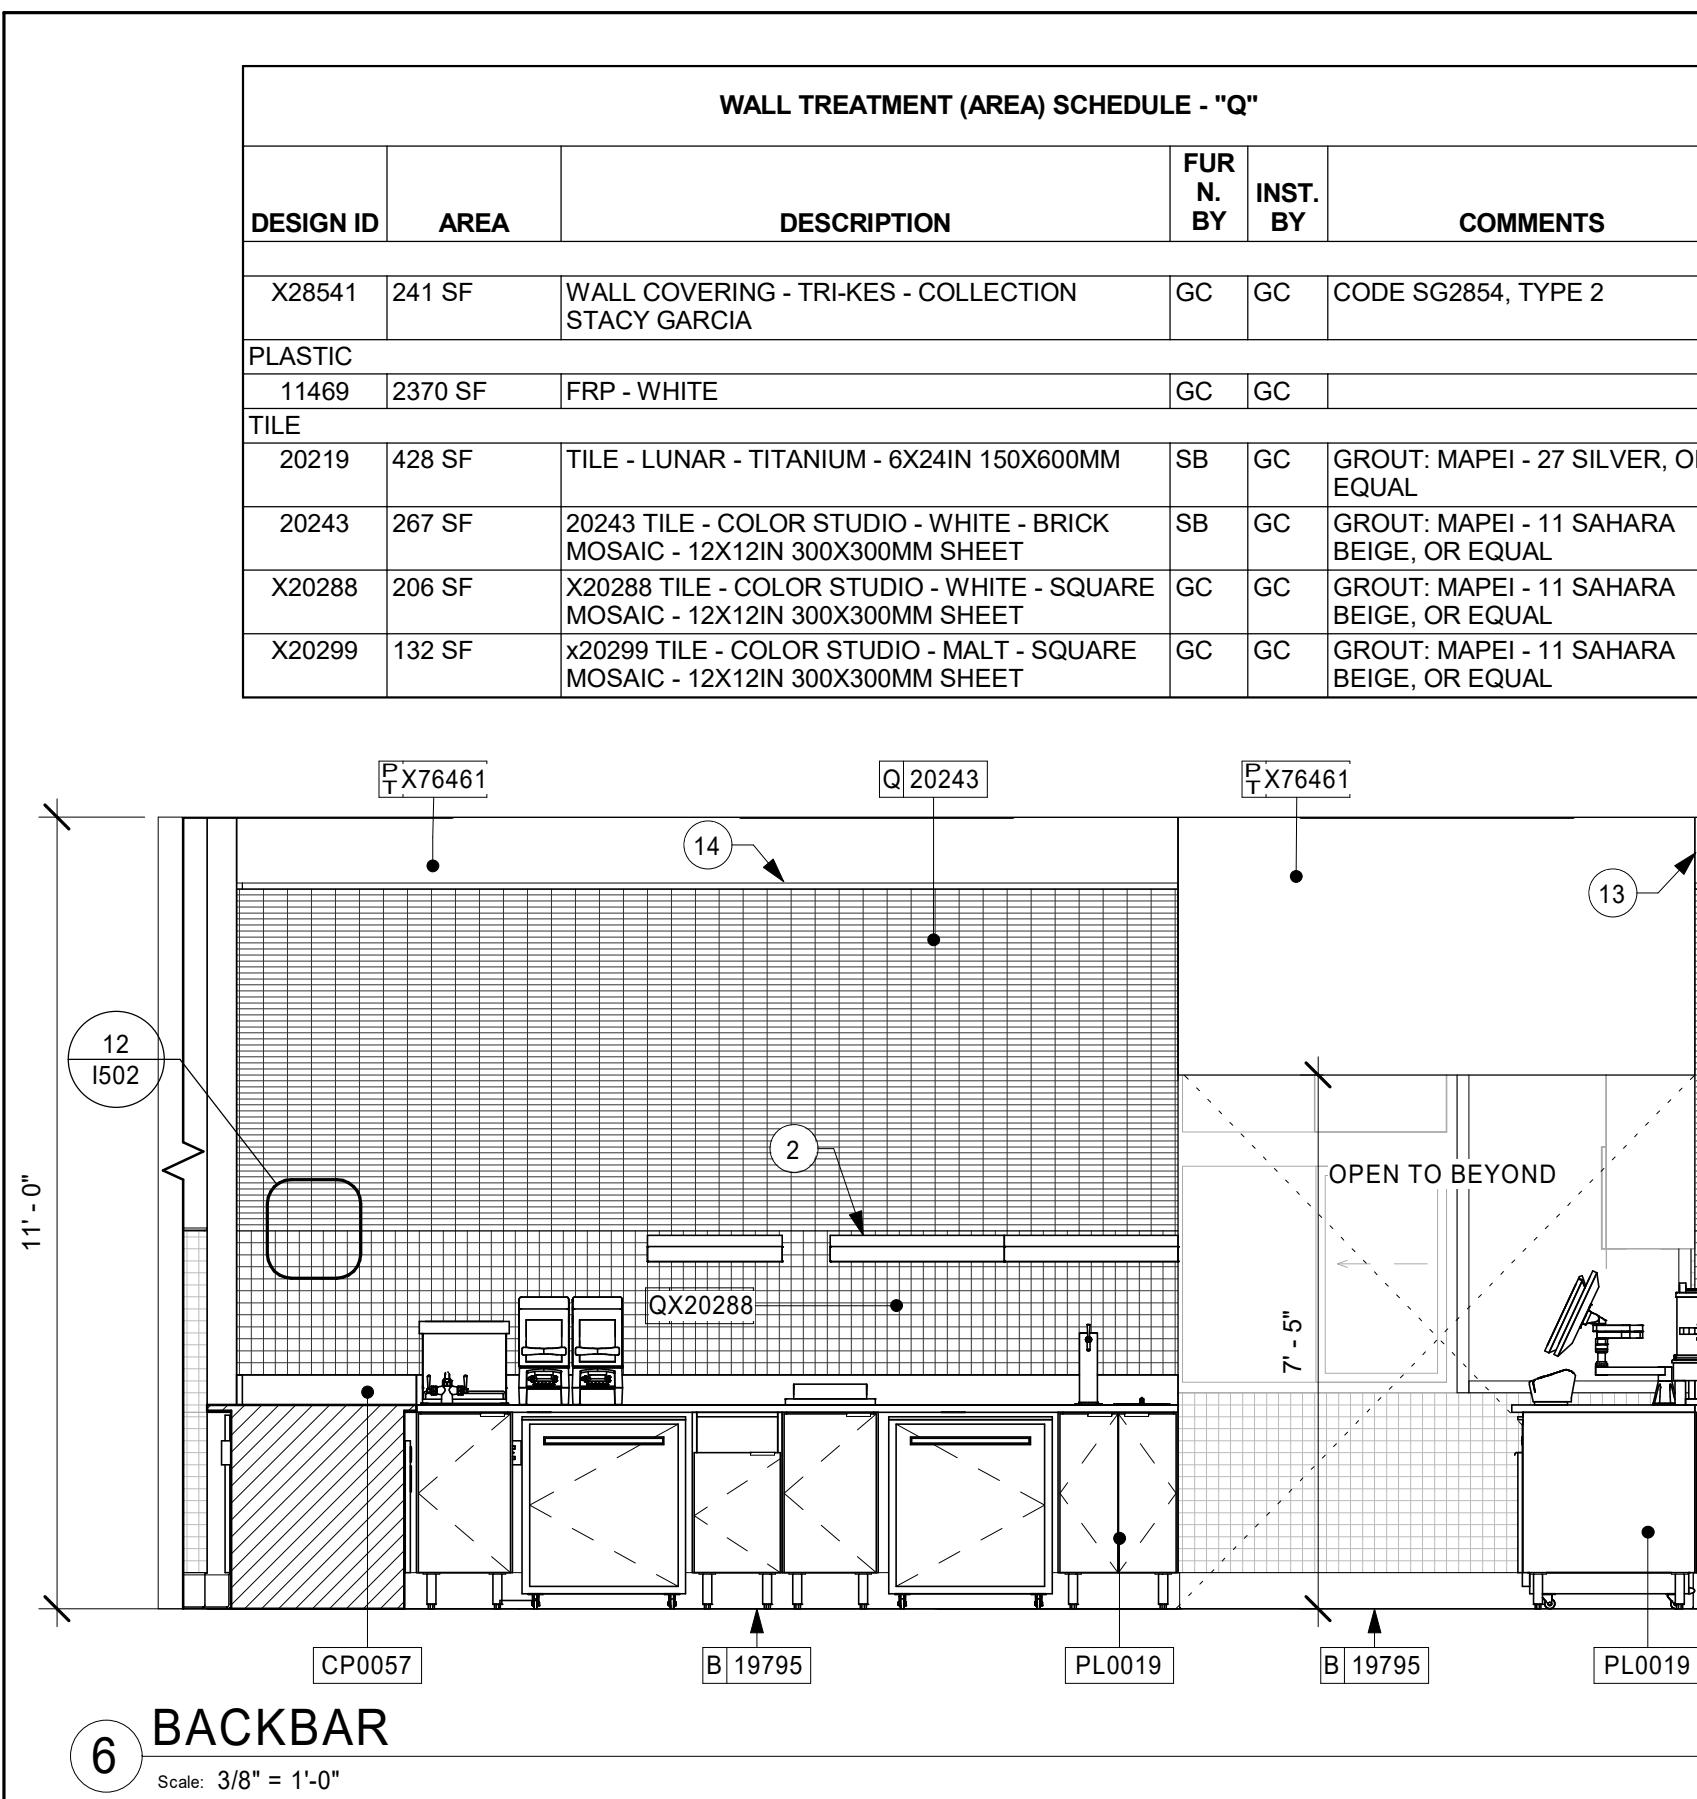

O:\2019\2019261\12_Hwy 81 & Lake Dow (McDonough, GA)\Dwg\Revit (2019)\Arch Model\85535_GA_HWY_81 & Lake Dow_Workshare.rvt

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Scale: 3/8" = 1'-0"

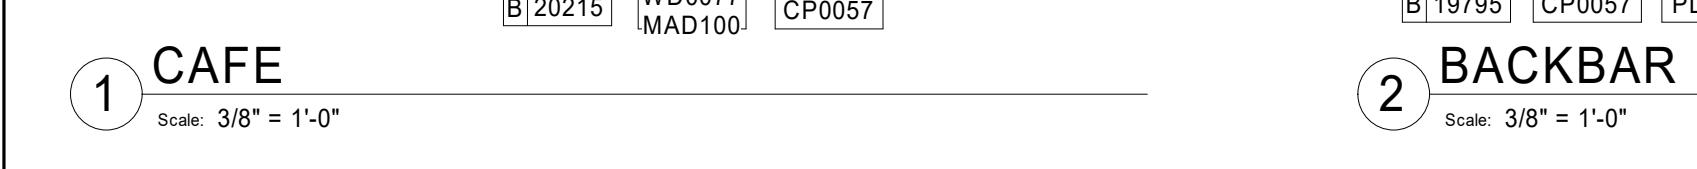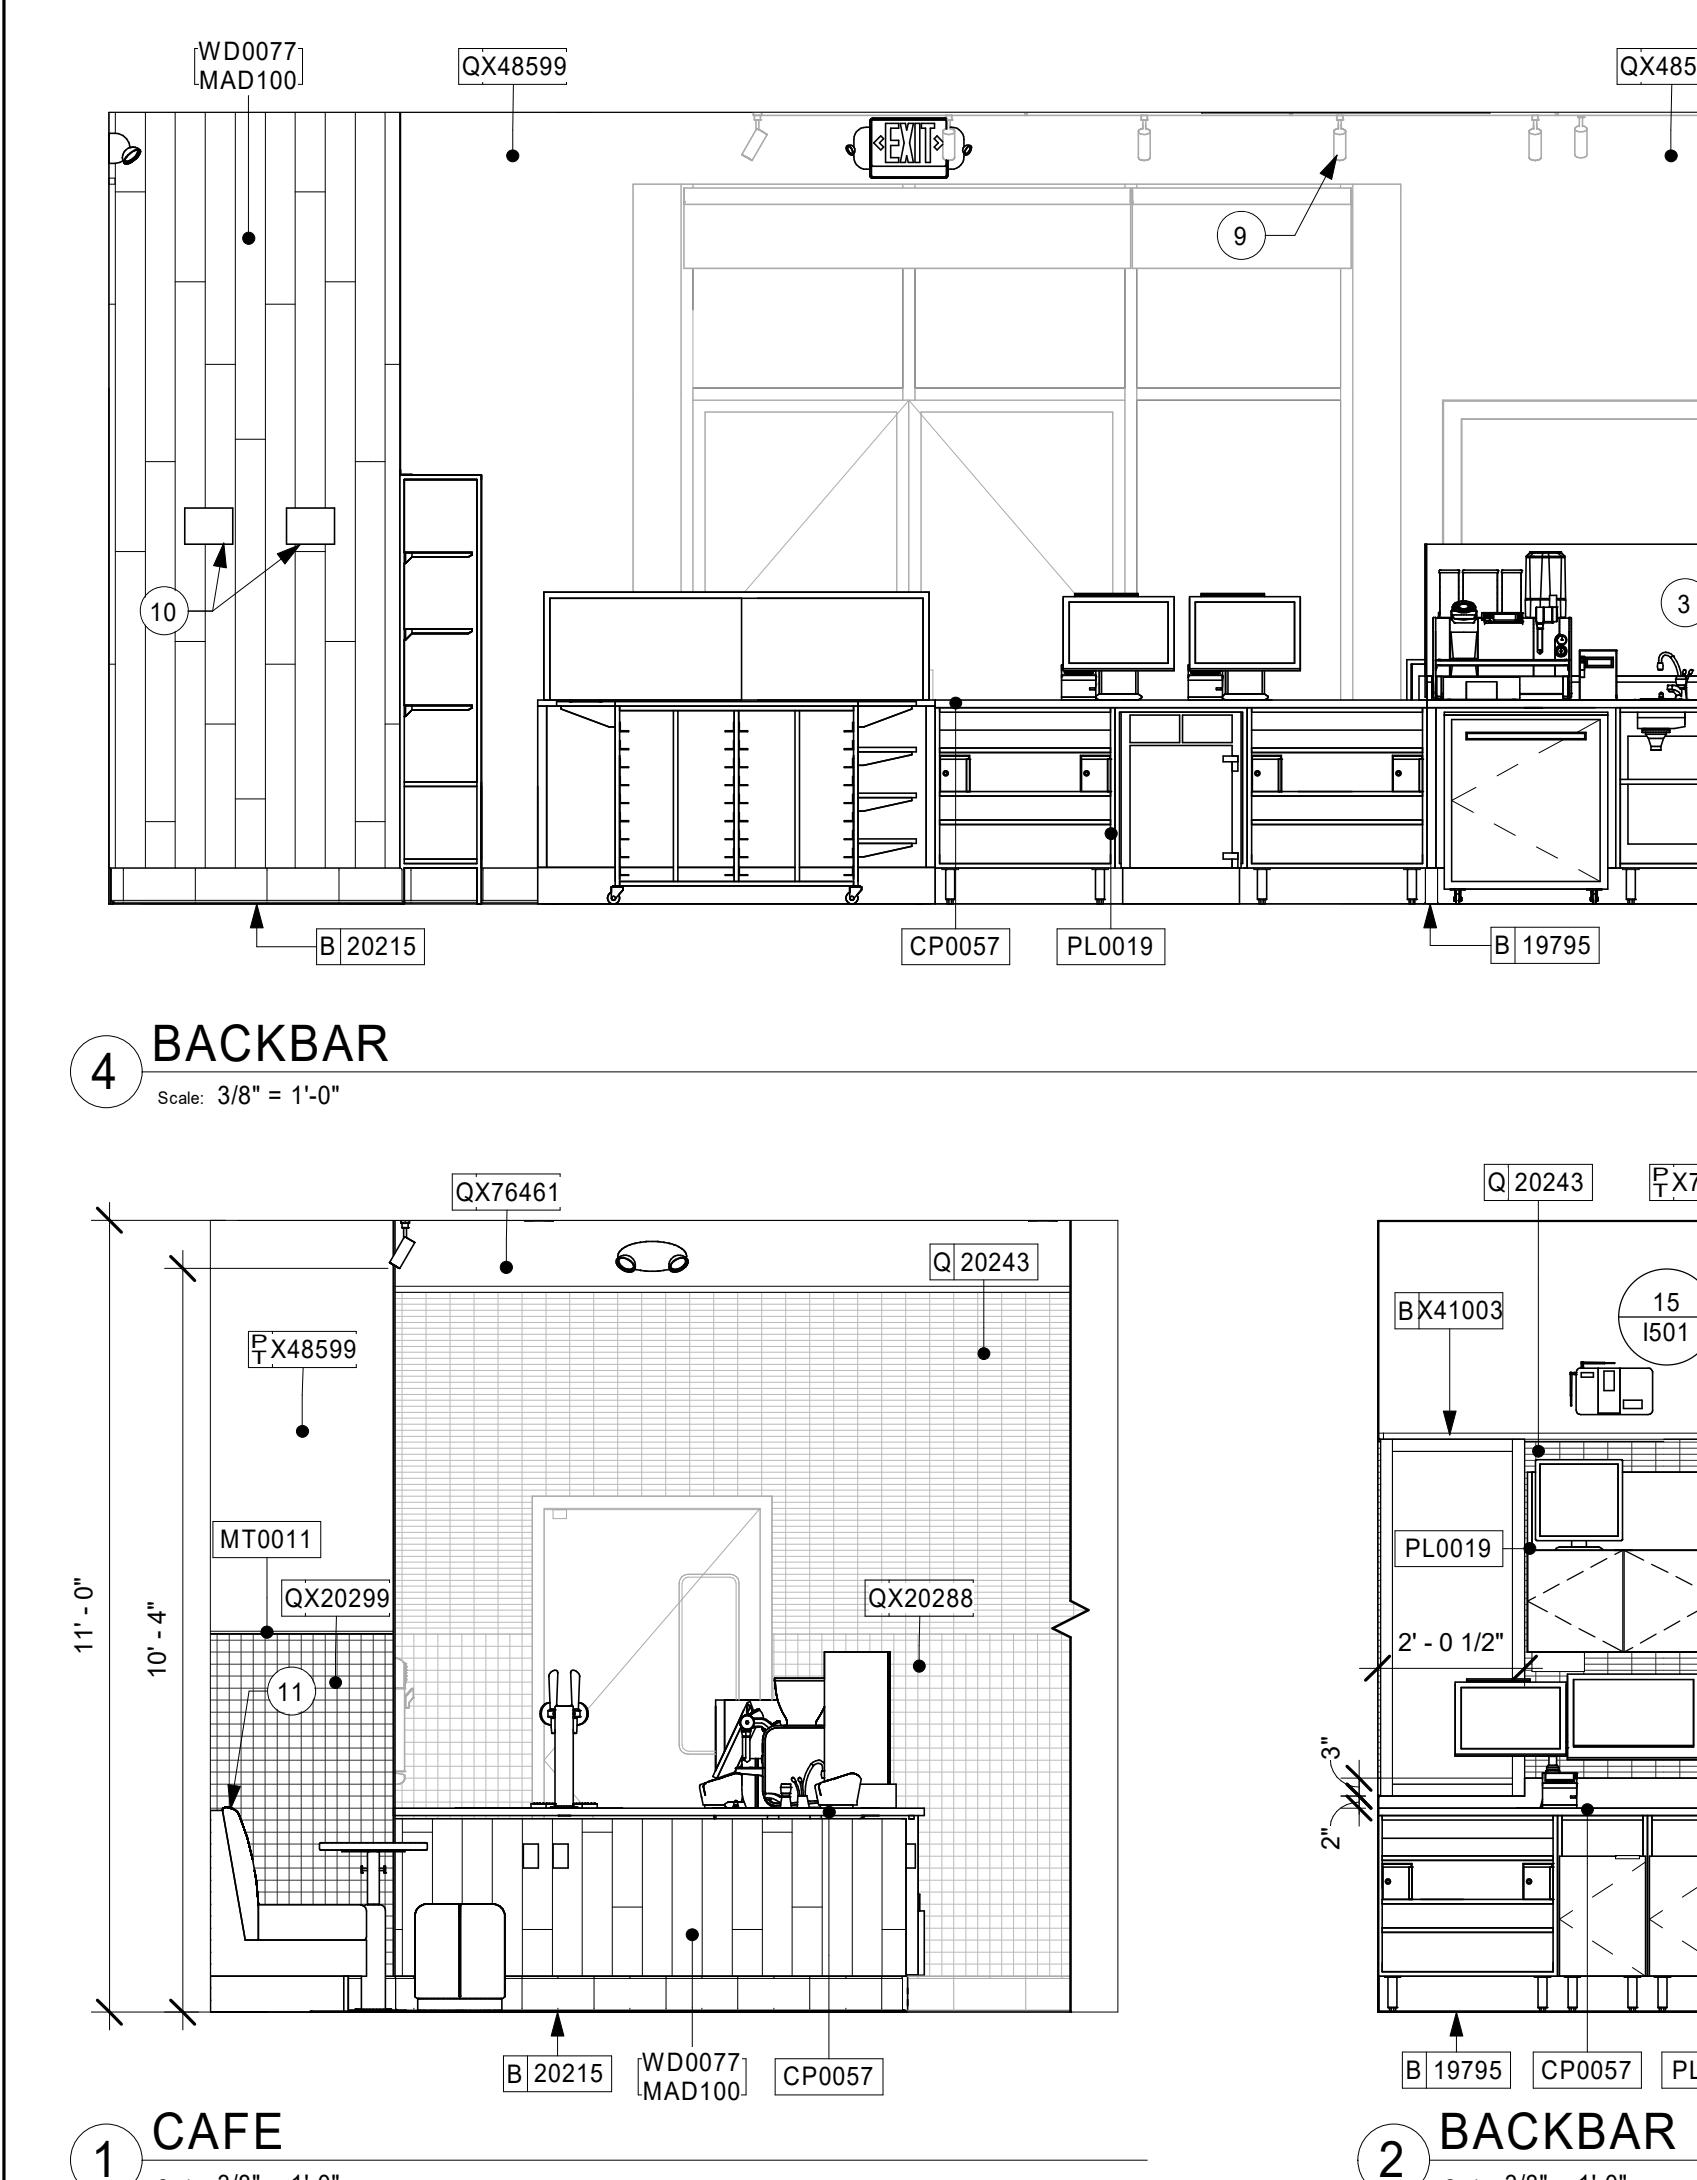


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STARBUCKS TEMPLATE VERSION: i2019-07-26

GPD GROUP
Professional Corporation
520 SOUTH MAIN ST, SUITE 2501
P: 330-572-2100 F: 330-572-2101



PROJECT NAME:
HWY 81 & LAKE DOW

PROJECT ADDRESS:
850 HWY 81
MCDONOUGH, GA 30252

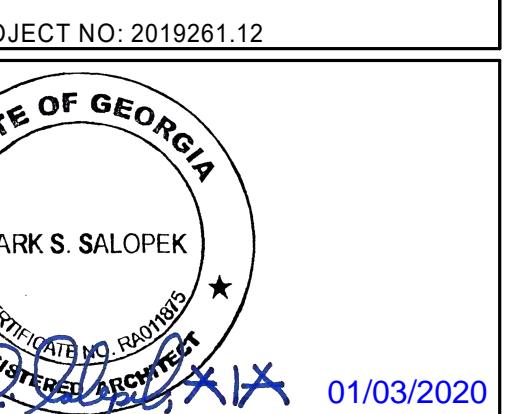STORE #: 59695
PROJECT #: 85535-001
ISSUE DATE: 12/03/2019

DESIGN MANAGER: RV
PRODUCTION DESIGNER: TW
CHECKED BY: GPD GROUP

Revision Schedule

Rev	Date	By	Description

SHEET TITLE:
INTERIOR FINISH ELEVATIONS
SCALE: AS SHOWN


SHEET NUMBER:
I203

KEYED NOTES

- WALL MOUNT HAND SINK WITH SOAP AND PAPER TOWEL DISPENSER. G.C. TO PROVIDE BLOCKING FOR FASTENERS.
- ICE MACHINE (SEE PLUMBING AND ELECTRICAL DRAWINGS FOR ADDITIONAL INFORMATION).
- MOP SINK, FULL HEIGHT FRP AT ENCLOSURE (SEE PLUMBING PLANS FOR MORE INFORMATION).
- HORIZONTAL WALL TREATMENT TRANSITION AT 11' - 0"
- ELECTRICAL PANELS (SEE ELECTRICAL DRAWINGS FOR ADDITIONAL INFORMATION).
- WATER FILTRATION EQUIPMENT (SEE PLUMBING DRAWINGS).
- LINE OF SOFFIT
- MOUNT TRACK LIGHTING FLUSH WITH GYP, CEILING AT 11' - 0". SUSPEND TRACK SO BOTTOM OF TRACK HEAD IS 10' - 4" A.F.F. WHERE STRUCTURE IS EXPOSED
- PAINT EXPOSED STRUCTURE AND DUCTWORK SW7018 TO MATCH CEILING AS SCHEDULED
- LOUVERED MECHANICAL RETURN GRILLE


GENERAL NOTES

- FOR GRAPHICS SCHEDULE, REFER TO THE FURNITURE, FIXTURES, AND EQUIPMENT (FF & E) SCHEDULES ON SHEET I601.
- REFER TO MANUFACTURER'S INSTRUCTIONS INCLUDED WITH ARTWORK/GRAPHICS FOR PROPER INSTALLATION.
- CHANGE PAINT COLOR ONLY AT INSIDE CORNERS UNLESS OTHERWISE INDICATED.
- PAINT FINISHES SHALL BE APPLIED AS FOLLOWS, UNLESS NOTED OTHERWISE:
 - WOODS AND METAL SURFACES SHALL BE SEMI-GLOSS OR EQUAL.
 - ACCENT AND TRIM PAINTS TO BE SEMI-GLOSS OR EQUAL.
 - PAINTS IN BOH, RESTROOM(S) OR CAFE BAR SHALL BE SEMI-GLOSS OR EQUAL.
- PAINT SUBSTITUTIONS ARE NOT ALLOWED. USE STARBUCKS NATIONAL ACCOUNT COLOR CODE WHEN ORDERING PAINTS.
- FLOORS, WALLS AND CEILING FINISHES IN FOOD PREPARATION AREAS SHALL BE SMOOTH, NON-TOXIC, NON-ABSORBENT, DURABLE AND EASILY CLEANABLE. PAINT SHALL BE WASHABLE; SEMI-GLOSS OR HIGH GLOSS FINISH.
- ALL WOOD SURFACES (DOORS, TRIM, SHELVES, CABINETRY) SHALL BE SEALED.
- REFER TO CASEWORK FINISH SCHEDULE ON THE CASEWORK FINISH PLAN ON SHEET H02 FOR CASEWORK FINISH MATERIAL INFORMATION.
- ALIGN TILE TRANSITIONS ON WHOLE TILES AS SHOWN.
- ALL FLOOR AND WALL JUNCTIONS IN STORAGE AND FOOD PREPARATION AREAS SHALL HAVE A 6" COVED BASE.
- ALL FOOD STORAGE SHALL BE 6" (150MM) A.F.F.
- INSTALL BLOCKING AND HANGERS FOR WALL SHELVING BEFORE INSTALLING BACK BAR TILE.
- GENERAL CONTRACTOR TO PROVIDE AND INSTALL WORKROOM WALL FINISHES.

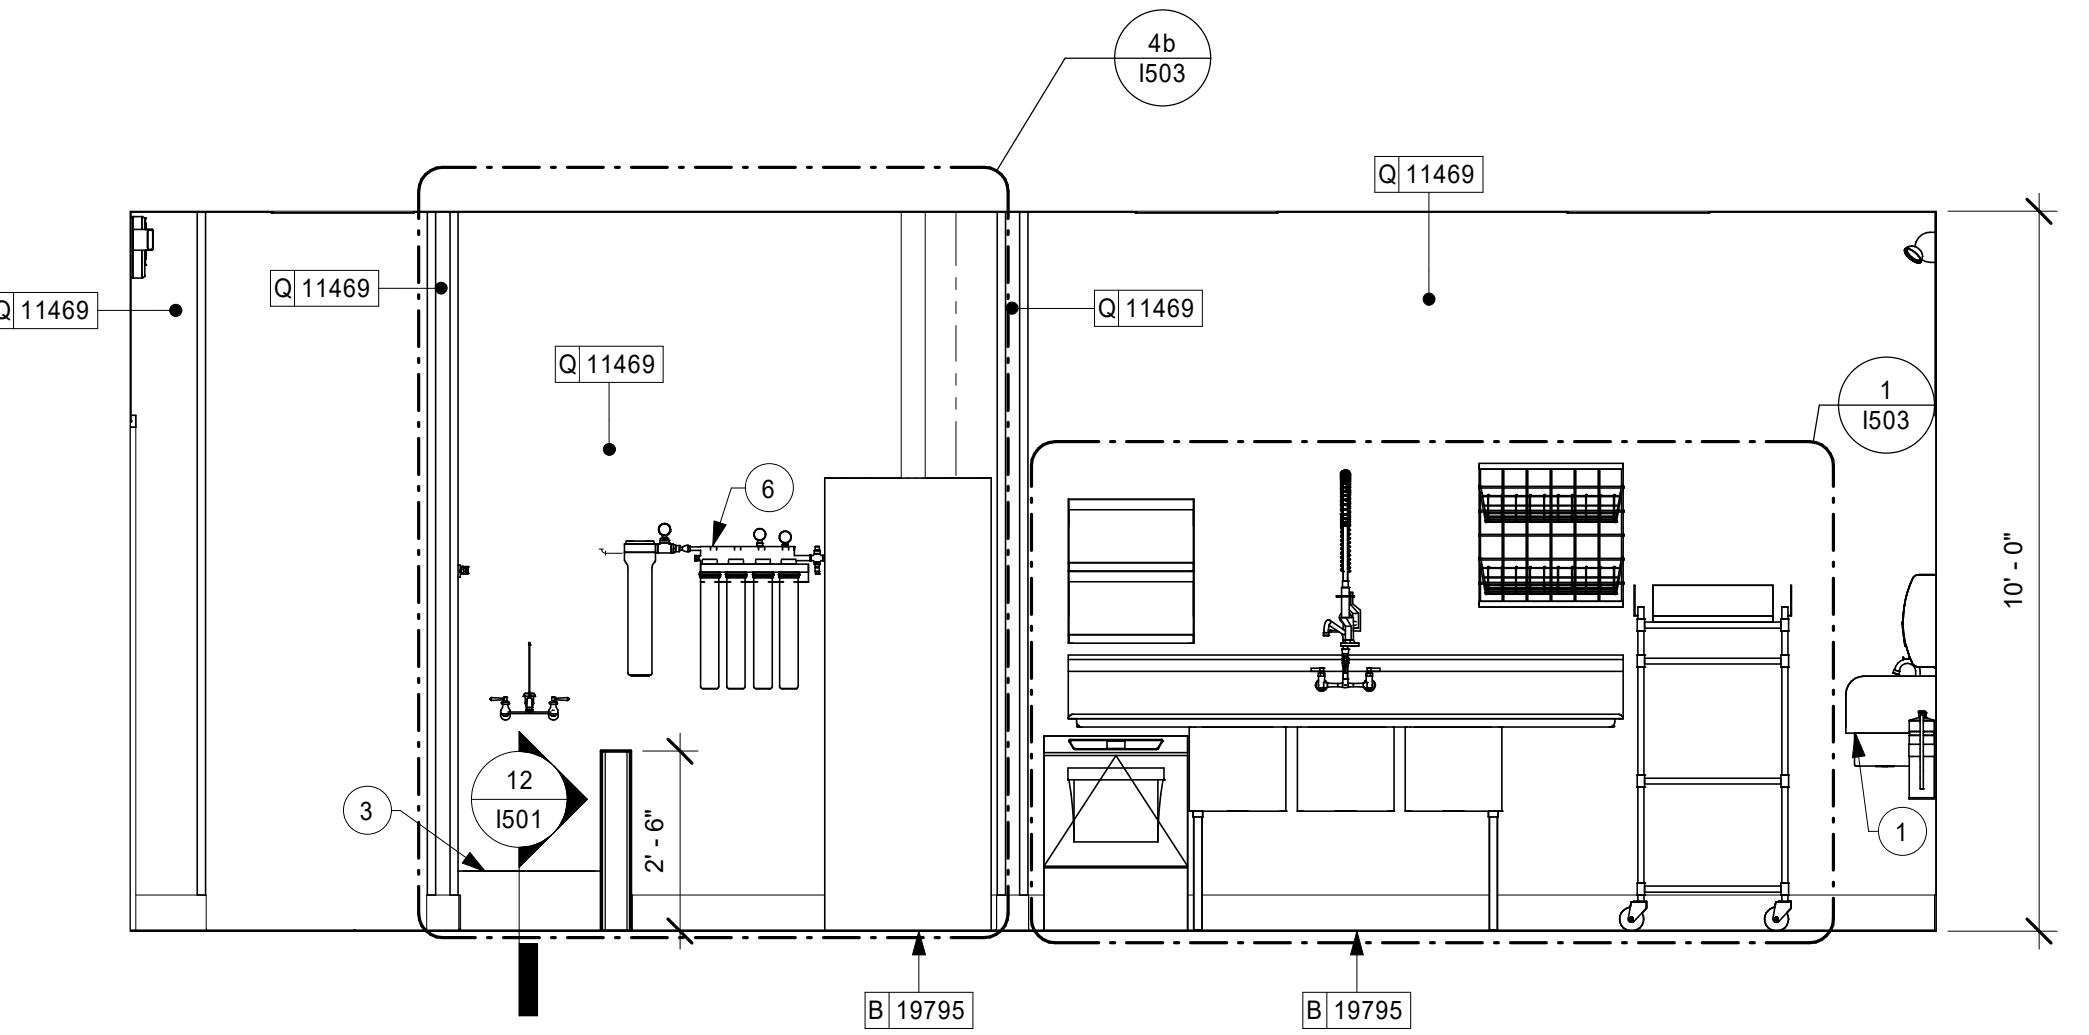


7 WORKROOM

Scale: 3/8" = 1'-0"

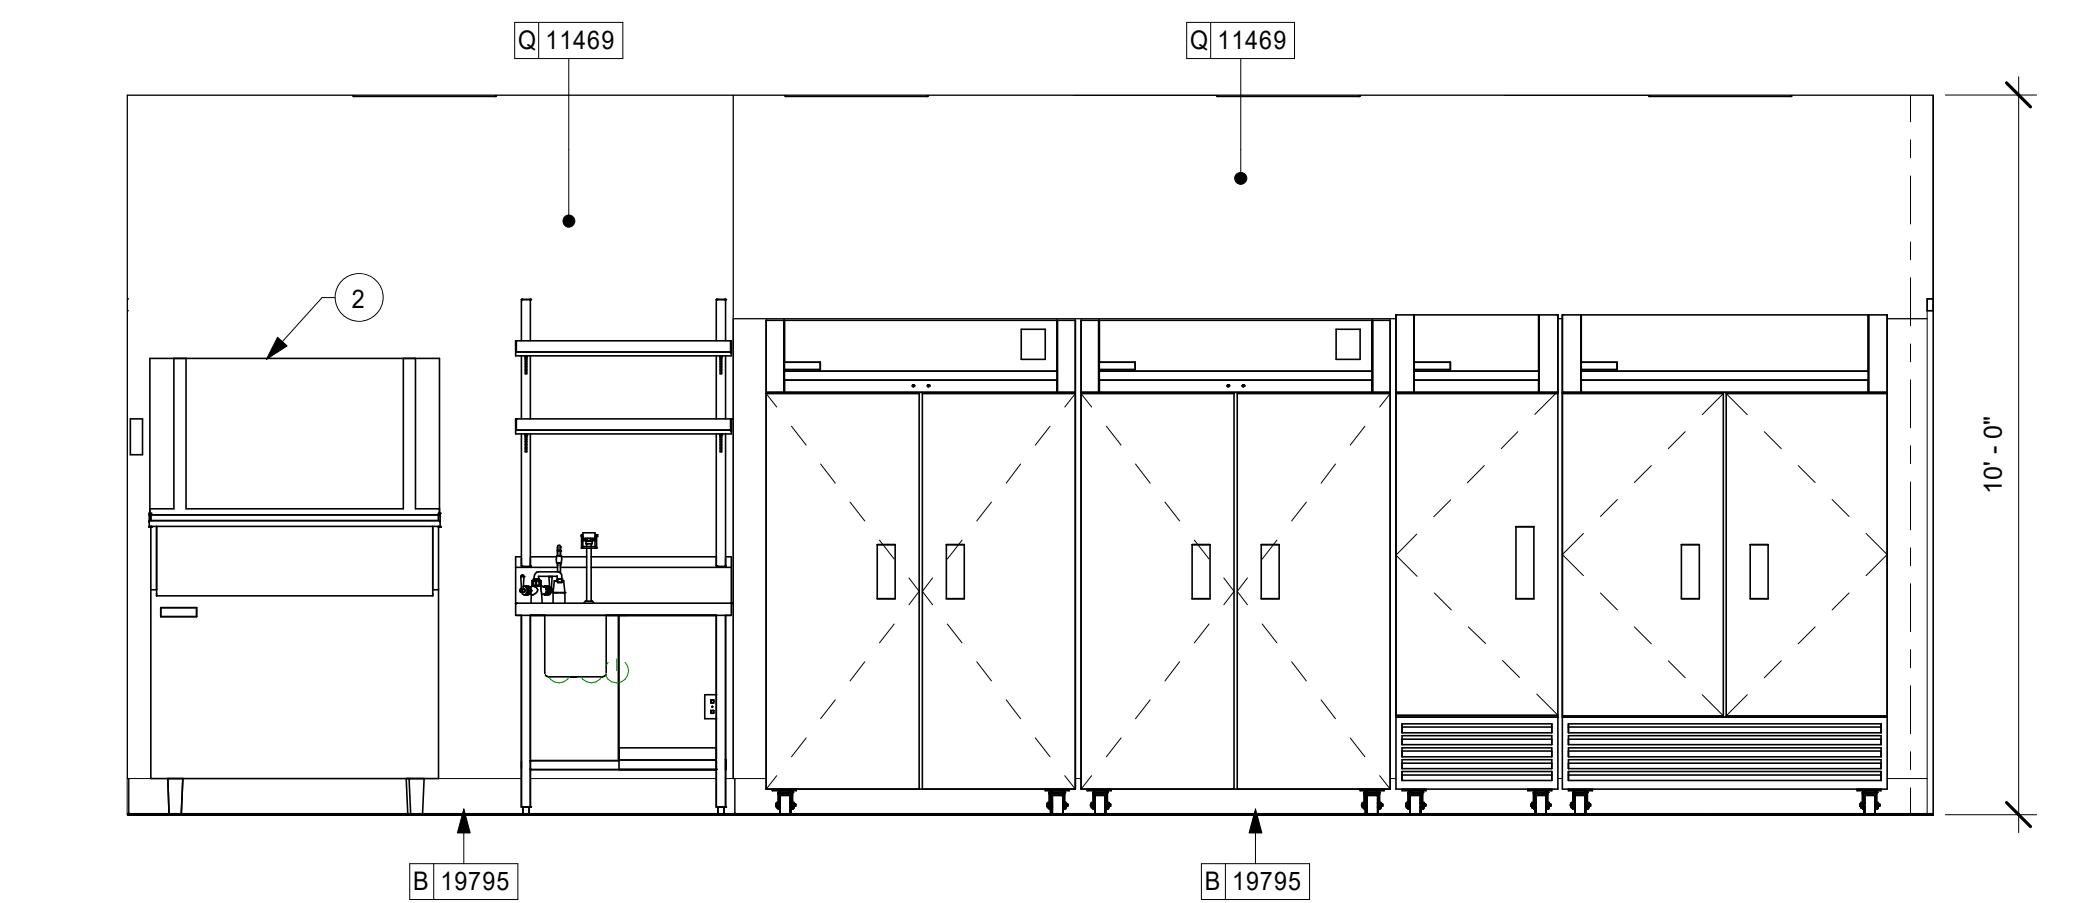


8 WORKROOM

Scale: 3/8" = 1'-0"

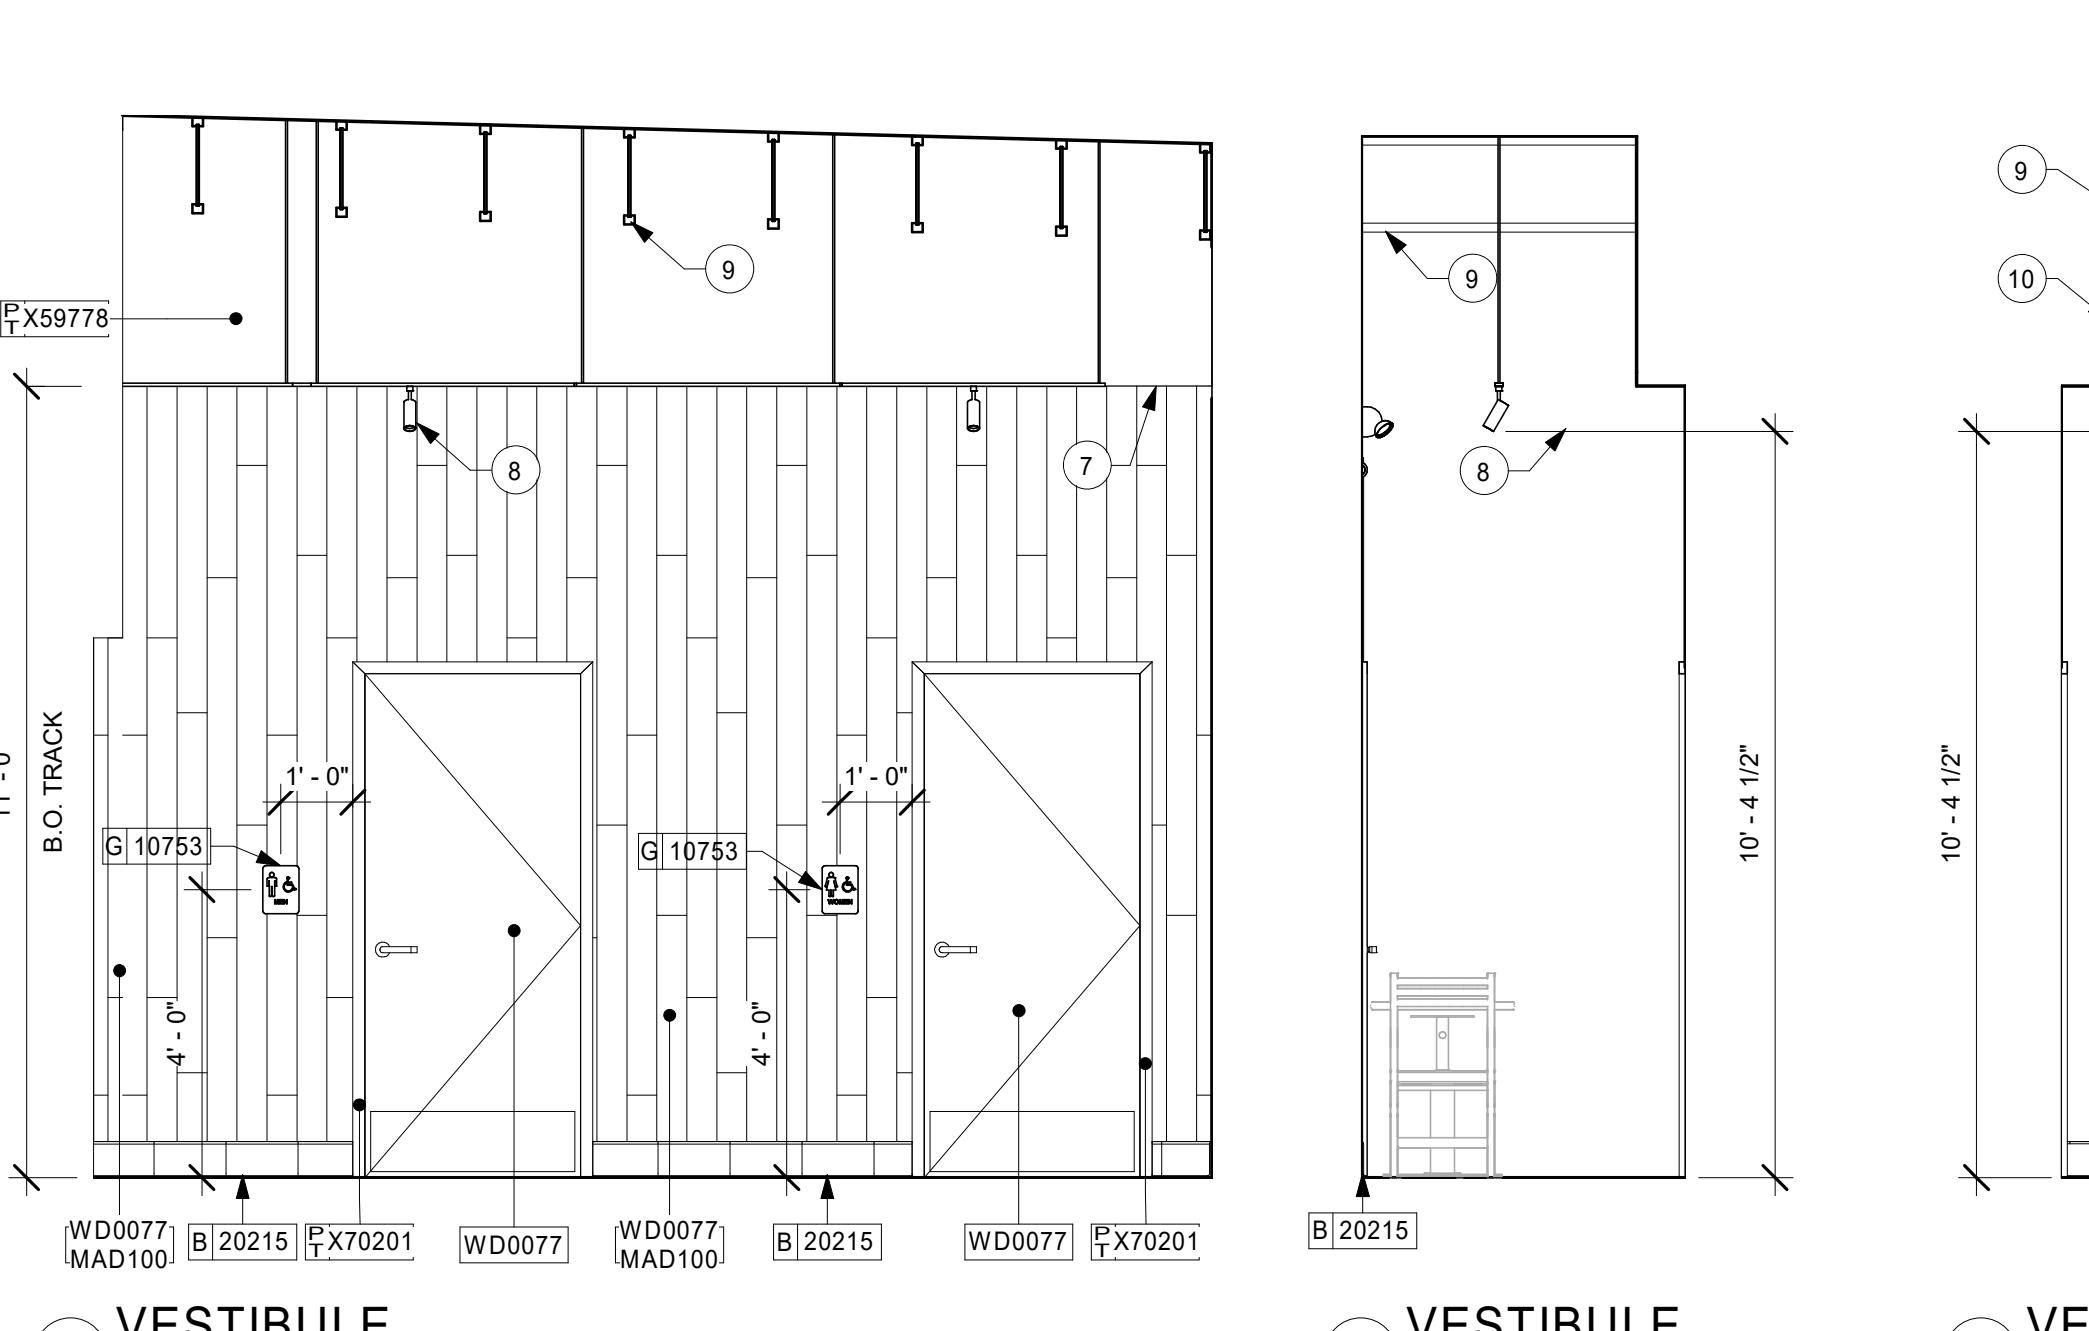

5 WORKROOM

Scale: 3/8" = 1'-0"

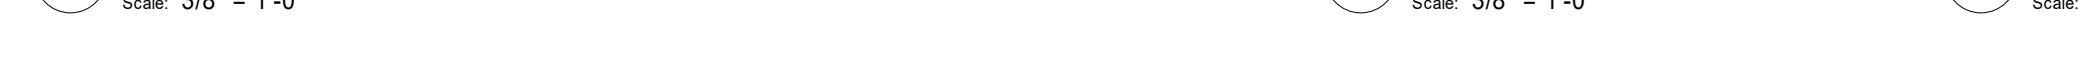

6 WORKROOM

Scale: 3/8" = 1'-0"



1 VESTIBULE

Scale: 3/8" = 1'-0"



2 VESTIBULE

Scale: 3/8" = 1'-0"




3 VESTIBULE

Scale: 3/8" = 1'-0"




4 VESTIBULE

Scale: 3/8" = 1'-0"

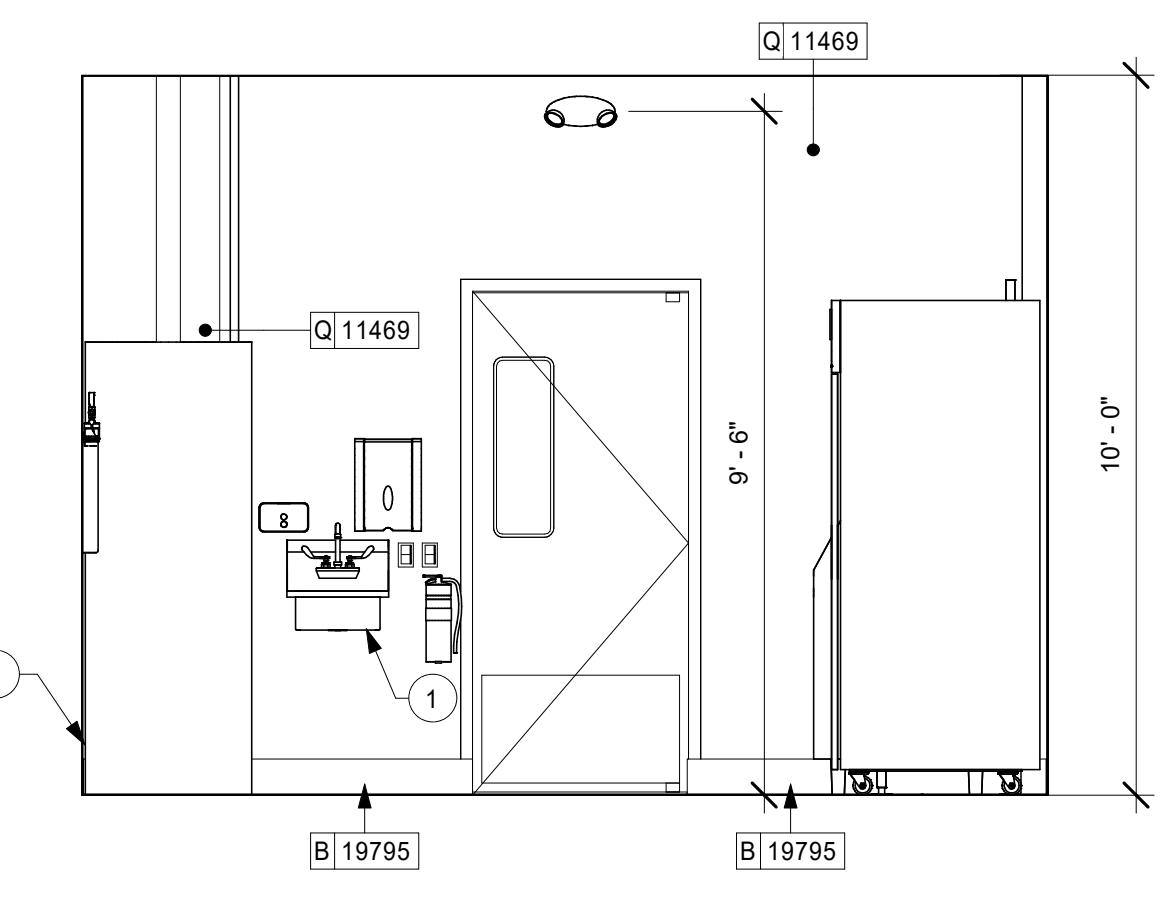


7 WORKROOM

Scale: 3/8" = 1'-0"

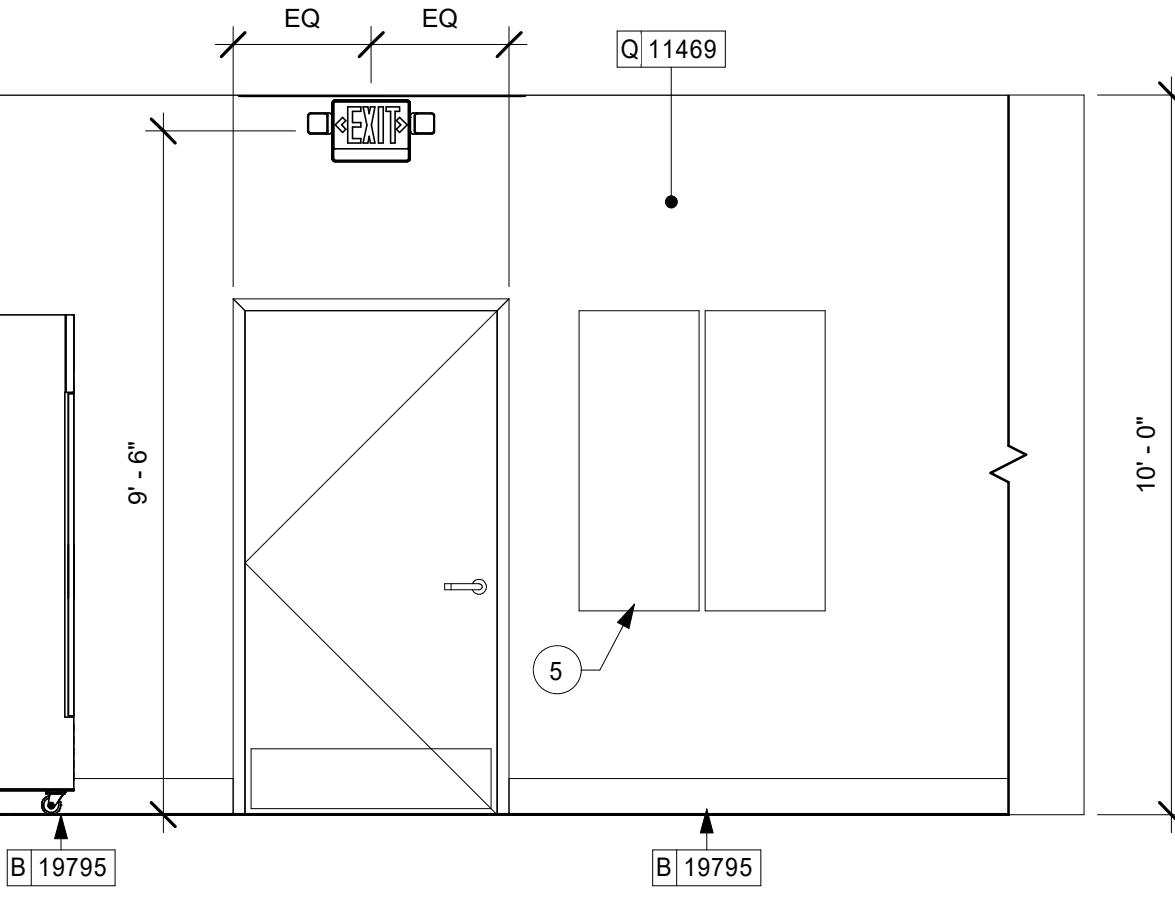

8 WORKROOM

Scale: 3/8" = 1'-0"

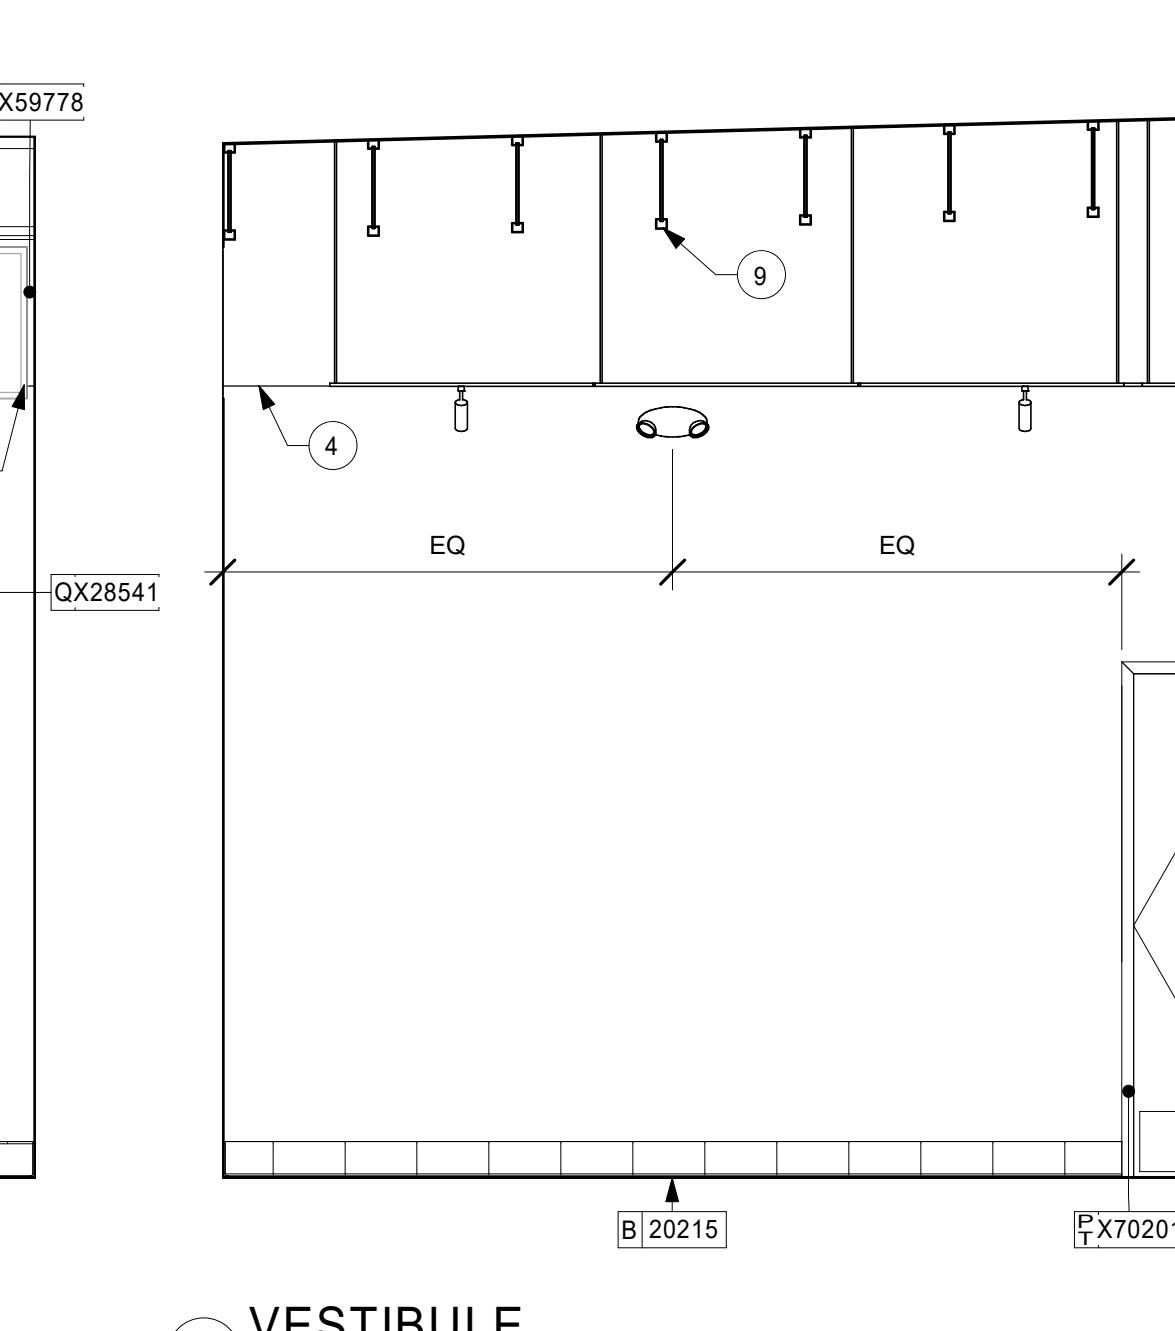

5 WORKROOM

Scale: 3/8" = 1'-0"



6 WORKROOM

Scale: 3/8" = 1'-0"



1 VESTIBULE

Scale: 3/8" = 1'-0"



2 VESTIBULE

Scale: 3/8" = 1'-0"



3 VESTIBULE

Scale: 3/8" = 1'-0"



4 VESTIBULE

Scale: 3/8" = 1'-0"

WALL BASE SCHEDULE - "B"				
DESIGN ID	LENGTH	DESCRIPTION	FURN. BY	INST. BY
CHAIR RAIL				
X41003	66' - 10 1/2"	1" x 1" THICK TRIM	GC	GC
X51055	23' - 8 3/4"	QUADEC SCHLUTER	GC	GC
TILE BASE				
19795	229' - 1 1/4"	POLYVINYLL FLOOR TILE - ECOGRIP - PEWTER	SB	GC
20215	118' - 2 1/2"	TILE BASE - FORMULA - UNION BLACK - 6X12IN 150X300MM	SB	GC
X41001	49' - 3 3/4"	JOLLY SCHLUTER TRIM AT RESTROOM TILE	GC	GC

WALL TREATMENT (AREA) SCHEDULE - "Q"				
DESIGN ID	AREA	DESCRIPTION	FUR. N. BY	INST. BY
X28541	241 SF	WALL COVERING - TRI-KES - COLLECTION STACY GARCIA	GC	GC
PLASTIC	2370 SF	FRP - WHITE	GC	GC
TITLE				
20219	428 SF	TILE - LUNAR - TITANIUM - 6X24IN 150X600MM	SB	GC
20243	267 SF	20243 TILE - COLOR STUDIO - WHITE - BRICK MOSAIC - 12X12IN 300X300MM SHEET	SB	GC
X20288	206 SF	x20288 TILE - COLOR STUDIO - WHITE - SQUARE MOSAIC - 12X12IN 300X300MM SHEET	GC	GC
X20299	132 SF	x20299 TILE - COLOR STUDIO - MALT - SQUARE MOSAIC - 12X12IN 300X300MM SHEET	GC	GC

PAINT SCHEDULE				
DESIGN ID	DESCRIPTION	FUR. N. BY	INST. BY	Comments
X76461	SW - FIRST STAR	GC	GC	SW7646, USE PRIMER CP-1; NCS - S 4500-N; AKZO NOBEL - 30YY 33/047
X48599	SW - MOROCCAN BROWN	8	GC	SW6060
X59778	SW - DOVETAIL	27	GC	SW7018, USE PRIMER CP-1; NCS - S 4500-N; AKZO NOBEL - 30YY 33/047
X70201	SW7020 BLACK FOX, OR EQUIVALENT	8	GC	SW 7020 SG, USE PRIMER CP-1; NCS - S 7502-Y; AKZO NOBEL - 30YY 10/038

0 2' 4' 8'
Scale: 1/4" = 1'-0"

WALL BASE SCHEDULE - "B"					
DESIGN ID	LENGTH	DESCRIPTION	FURN. BY	INST. BY	COMMENTS
CHAIR RAIL					
X41003	66' - 10 1/2"	1" x 1" THICK TRIM	GC	GC	TRIM AT TILE/PAINT TRANSITION PAINTED SW7646 - FIRST STAR
X51055	23' - 8 3/4"	QUADEC SCHLUTER	GC	GC	CUSTOM QUADEC SCHLUTER: Q100 ABGB. FINISH: STYLMARK #212. MATERIAL SAMPLE TO BE SENT TO DESIGNER BEFORE INSTALLATION
TILE BASE					
19795	229' - 1 1/4"	POLYVINYL FLOOR TILE - ECOGRIP - PEWTER	SB	GC	
20215	118' - 2 1/2"	TILE BASE - FORMULA - UNION BLACK - 6X12IN 150X300MM	SB	GC	GROUT: MAPEI - 10 BLACK, OR EQUAL
X41001	49' - 3 3/4"	JOLLY SCHLUTER TRIM AT RESTROOM TILE	GC	GC	JOLLY SCHLUTER: ABGB BRUSHED: COLOR ANTHRACITE

PAINT SCHEDULE					
DESIGN ID	DESCRIPTION	LRV	FUR N. BY	INST. BY	COMMENTS
X76461	SW - FIRST STAR	GC	GC		SW7646, USE PRIMER CP-1; NCS - S 4500-N; AKZO NOBEL - 30YY 33/047
X48599	SW - MOROCCAN BROWN	8	GC	GC	SW6060
X59778	SW - DOVETAIL	27	GC	GC	SW7018, USE PRIMER CP-1; NCS - S 4500-N; AKZO NOBEL - 30YY 33/047
X70201	SW7020 BLACK FOX, OR EQUIVALENT	8	GC	GC	SW 7020 SG, USE PRIMER CP-1; NCS - S 7502-Y; AKZO NOBEL - 30YY 10/038

WALL TREATMENT (AREA) SCHEDULE - "Q"					
DESIGN ID	AREA	DESCRIPTION	FUR N. BY	INST. BY	COMMENTS
X28541	241 SF	WALL COVERING - TRI-KES - COLLECTION STACY GARCIA	GC	GC	CODE SG2854, TYPE 2
PLASTIC					
11469	2370 SF	FRP - WHITE	GC	GC	
TILE					
20219	428 SF	TILE - LUNAR - TITANIUM - 6X24IN 150X600MM	SB	GC	GROUT: MAPEI - 27 SILVER, OR EQUAL
20243	267 SF	20243 TILE - COLOR STUDIO - WHITE - BRICK MOSAIC - 12X12IN 300X300MM SHEET	SB	GC	GROUT: MAPEI - 11 SAHARA BEIGE, OR EQUAL
X20288	206 SF	X20288 TILE - COLOR STUDIO - WHITE - SQUARE MOSAIC - 12X12IN 300X300MM SHEET	GC	GC	GROUT: MAPEI - 11 SAHARA BEIGE, OR EQUAL
X20299	132 SF	x20299 TILE - COLOR STUDIO - MALT - SQUARE MOSAIC - 12X12IN 300X300MM SHEET	GC	GC	GROUT: MAPEI - 11 SAHARA BEIGE, OR EQUAL

KEYED NOTES

1. MANAGER'S DESK (SEE ENLARGED DETAILS).

GENERAL NOTES

- A. FOR GRAPHICS SCHEDULE, REFER TO THE FURNITURE, FIXTURES, AND EQUIPMENT (FF & E) SCHEDULES ON SHEET I601.
- B. REFER TO MANUFACTURER'S INSTRUCTIONS INCLUDED WITH ARTWORK/GRAFICS FOR PROPER INSTALLATION.
- C. CHANGE PAINT COLOR ONLY AT INSIDE CORNERS UNLESS OTHERWISE INDICATED.
- D. PAINT FINISHES SHALL BE APPLIED AS FOLLOWS, UNLESS NOTED OTHERWISE:
 - 1) WOODS AND METAL SURFACES SHALL BE SEMI-GLOSS OR EQUAL.
 - 2) ACCENT AND TRIM PAINTS TO BE SEMI-GLOSS OR EQUAL.
 - a. WALL AND CEILING PAINTS TO BE EGGSHELL OR EQUAL.
 - 3) PAINTS IN BOH, RESTROOM(S) OR CAFE BAR SHALL BE SEMI-GLOSS OR EQUAL.

- E. PAINT SUBSTITUTIONS ARE NOT ALLOWED. USE STARBUCKS NATIONAL ACCOUNT COLOR CODE WHEN ORDERING PAINTS.
- F. FLOORS, WALLS AND CEILING FINISHES IN FOOD PREPARATION AREAS SHALL BE SMOOTH, NON-TOXIC, NON-ABSORBENT, DURABLE AND EASILY CLEANABLE. PAINT SHALL BE WASHABLE; SEMI-GLOSS OR HIGH GLOSS FINISH.
- G. ALL WOOD SURFACES (DOORS, TRIM, SHELVES, CABINETRY) SHALL BE SEALED.

- H. REFER TO CASEWORK FINISH SCHEDULE ON THE CASEWORK FINISH PLAN ON SHEET I102 FOR CASEWORK FINISH MATERIAL INFORMATION.

- I. ALIGN TILE TRANSITIONS ON WHOLE TILES AS SHOWN.
- J. ALL FLOOR AND WALL JUNCTIONS IN STORAGE AND FOOD PREPARATION AREAS SHALL HAVE A 6" COVED BASE.
- K. ALL FOOD STORAGE SHALL BE 6" (150MM) A.F.F.
- L. INSTALL BLOCKING AND HANGERS FOR WALL SHELVING BEFORE INSTALLING BACK BAR TILE.
- M. GENERAL CONTRACTOR TO PROVIDE AND INSTALL WORKROOM WALL FINISHES.




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STARBUCKS TEMPLATE VERSION: i2019-07-26

GPD GROUP
Professional Corporation
520 SOUTH MAIN ST, SUITE 2501
P: 330-572-2100 F: 330-572-2101
GPD PROJECT NO: 2019261.12







PROJECT NAME:
HWY 81 & LAKE DOW
PROJECT ADDRESS:
850 HWY 81
MCDONOUGH, GA 30252

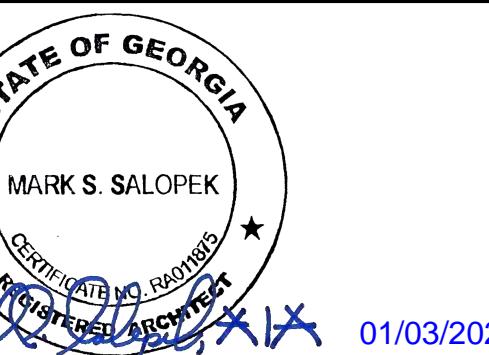STORE #: 59695
PROJECT #: 85535-001
ISSUE DATE: 12/03/2019
DESIGN MANAGER: RV
PRODUCTION DESIGNER: TW
CHECKED BY: GPD GROUP

Revision Schedule
Rev Date By Description

SHEET TITLE:
INTERIOR FINISH ELEVATIONS
SCALE: AS SHOWN

SHEET NUMBER:
1204

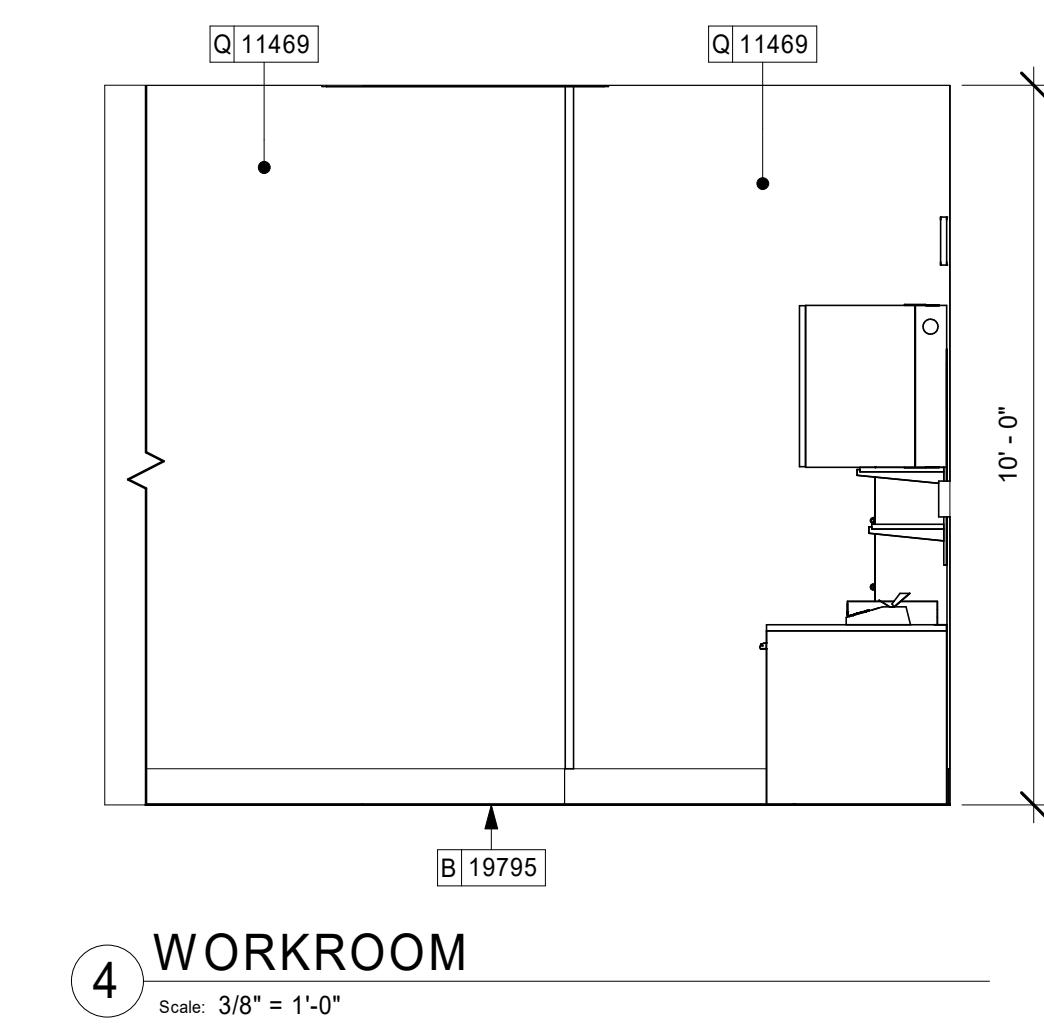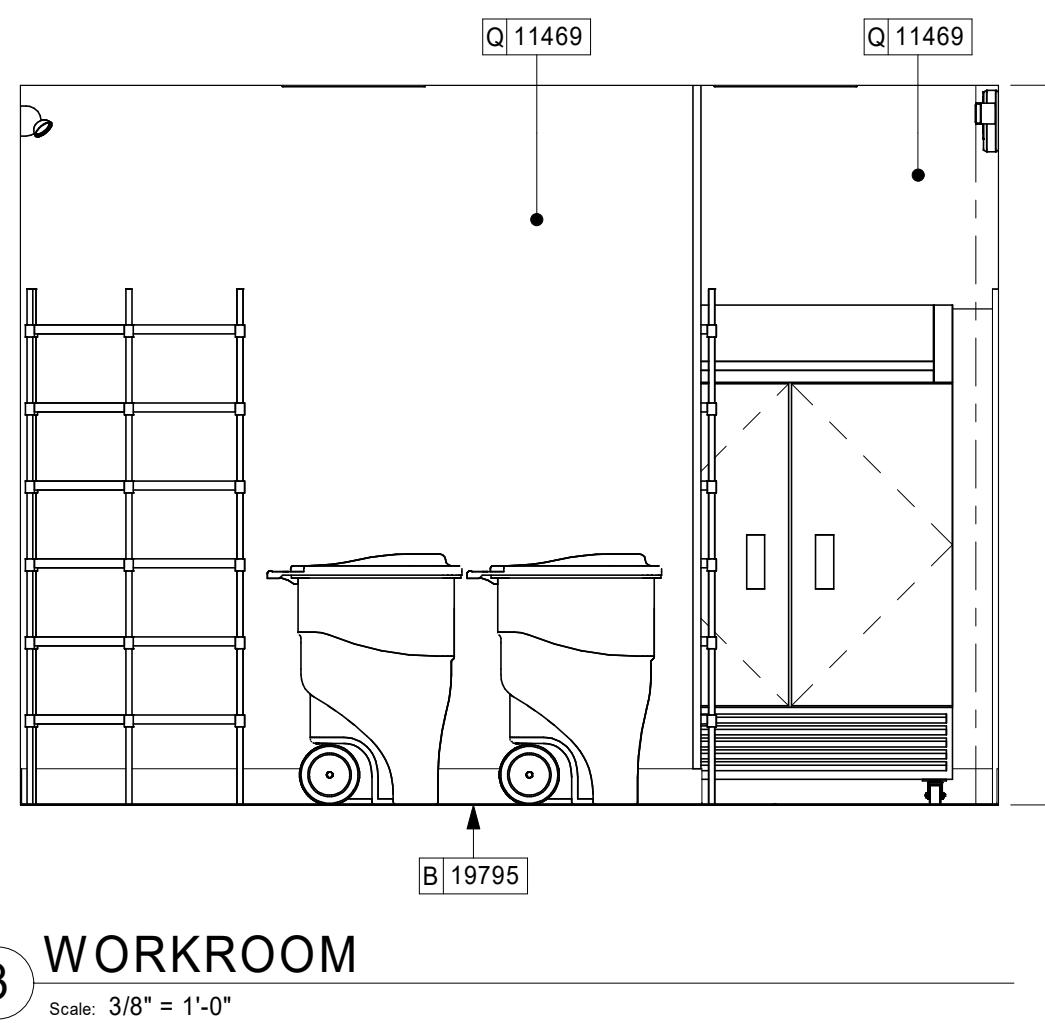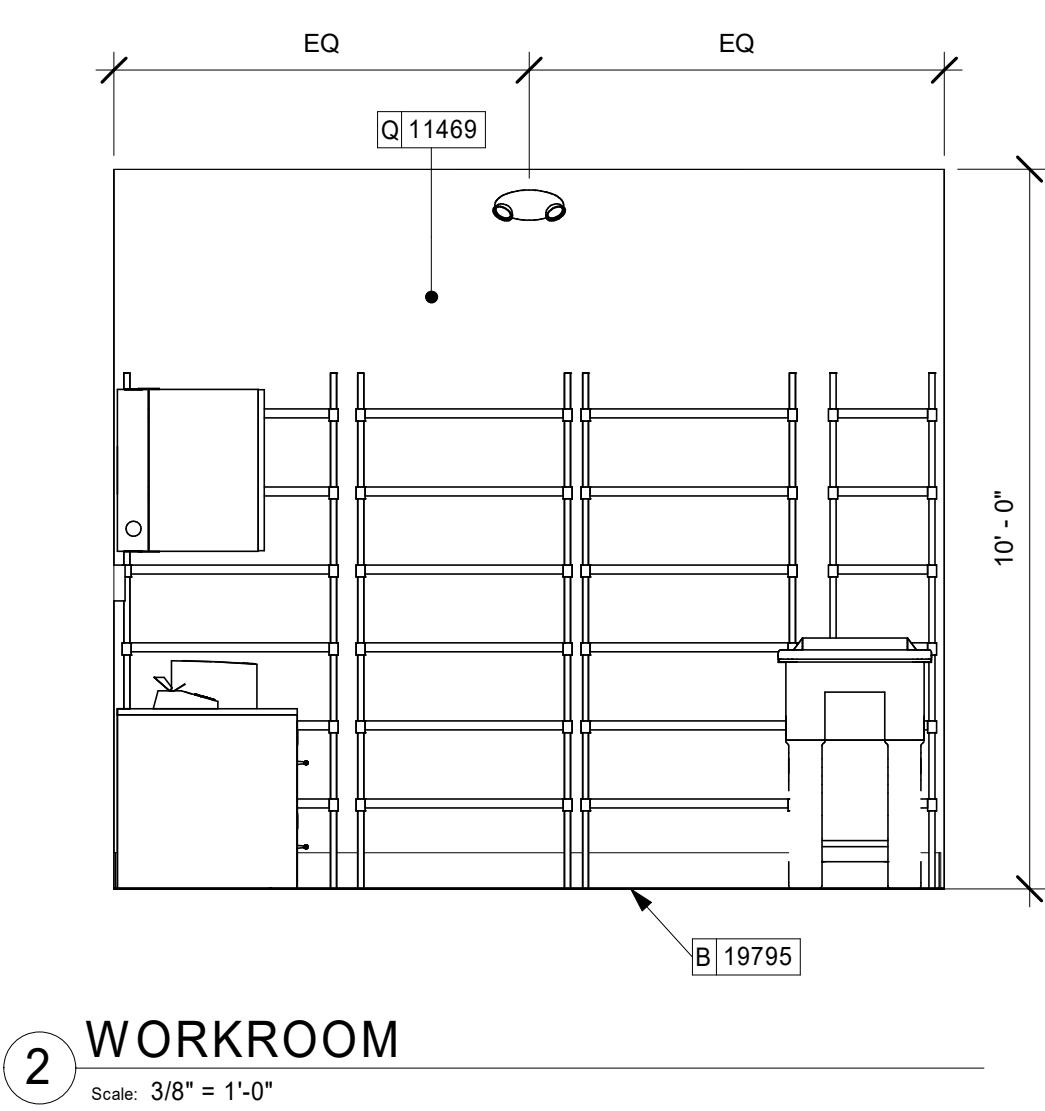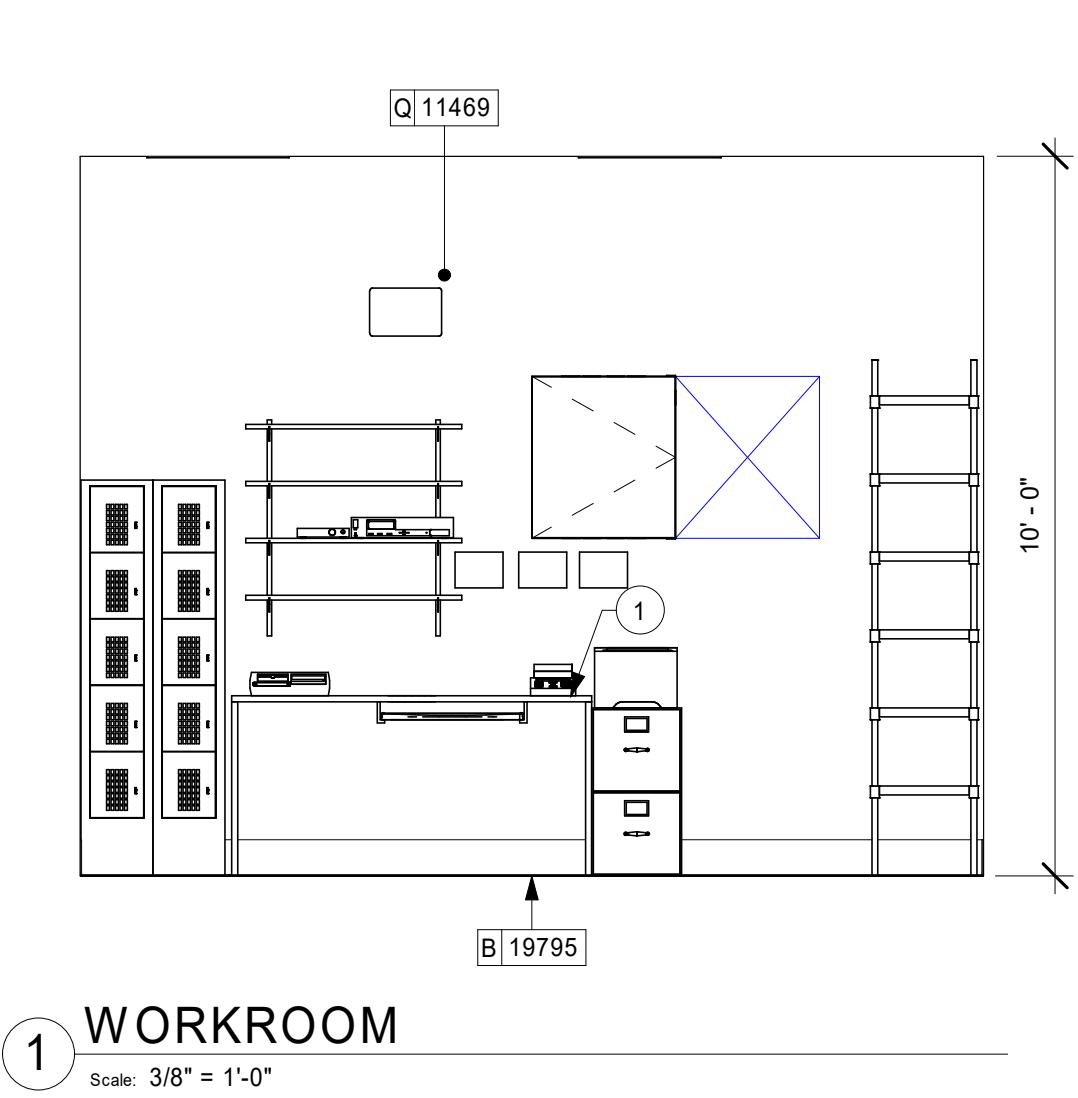



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STARBUCKS TEMPLATE VERSION: I2019-07-26



GPD GROUP
Professional Corporation

520 SOUTH MAIN ST, SUITE 2501

P: 330-572-2100 F: 330-572-2101

GPD PROJECT NO: 2019261.12



PROJECT NAME:
HWY 81 & LAKE DOW

PROJECT ADDRESS:
850 HWY 81
MCDONOUGH, GA 30252

STORE #: 59695
PROJECT #: 85535-001
ISSUE DATE: 12/03/2019
DESIGN MANAGER: RV
PRODUCTION DESIGNER: TW
CHECKED BY: GPD GROUP

Revision Schedule			
Rev	Date	By	Description

SHEET TITLE:
RESTROOM PLAN & ELEVATIONS
SCALE: AS SHOWN

SHEET NUMBER:


I401

KEYED NOTES

1. 60" (1525mm) ACCESSIBLE TURNING RADIUS.
2. 30" (760mm) X 40" (1015MM) CLEAR FLOOR SPACE.
3. WATER CLOSET CLEAR FLOOR SPACE.
4. BABY CHANGING FIXTURE. GENERAL CONTRACTOR TO PROVIDE BLOCKING PER MANUFACTURER'S RECOMMENDATION.
5. TILE START POINT WHERE INDICATED.
6. WALL MOUNTED LAVATORY INSTALLED WITH INSULATED BOOT AT EXPOSED PIPES.
7. CENTER MIRROR OVER LAVATORY. MOUNT AT 40" (1015MM) MAX. TO BOTTOM EDGE OF REFLECTIVE SURFACE.
8. COAT HOOK. MOUNTED AT 48" AFF ON CENTERLINE OF DOOR.
9. CENTER SCONCE LIGHTING OVER MIRROR (SEE ELECTRICAL).

GENERAL NOTES

- A. GENERAL CONTRACTOR TO VERIFY ALL DIMENSIONS AND NOTIFY STARBUCKS CONSTRUCTION MANAGER OF ANY DISCREPANCIES PRIOR TO CONSTRUCTION.
- B. ALL DIMENSIONS ARE TO BE TAKEN FROM A DESIGNATED DATUM POINT.
- C. DIMENSIONS ARE TO FACE OF FINISHED SURFACE UNLESS OTHERWISE NOTED.
- D. DIAPER CHANGING STATION IS TO BE INSTALLED PER MANUFACTURER'S INSTRUCTIONS. UNIT IS TO BE FASTENED TO STRUCTURE AT ALL SIX CHASSIS ATTACHMENT POINTS.
- E. LOCATE DIAPER CHANGING STATION AS SHOWN TO ALLOW NECESSARY CLEARANCE FOR OPERATION OF ALL RESTROOM FIXTURES. LOCATION SHALL NOT IMPEDE ACCESS, EGREG, OR DOOR SWING.
- F. ALL RESTROOM ACCESSORY MOUNTING HEIGHTS AND CLEARANCES SHALL COMPLY WITH THE ACCESSIBILITY REQUIREMENTS OF THE LOCAL JURISDICTION.

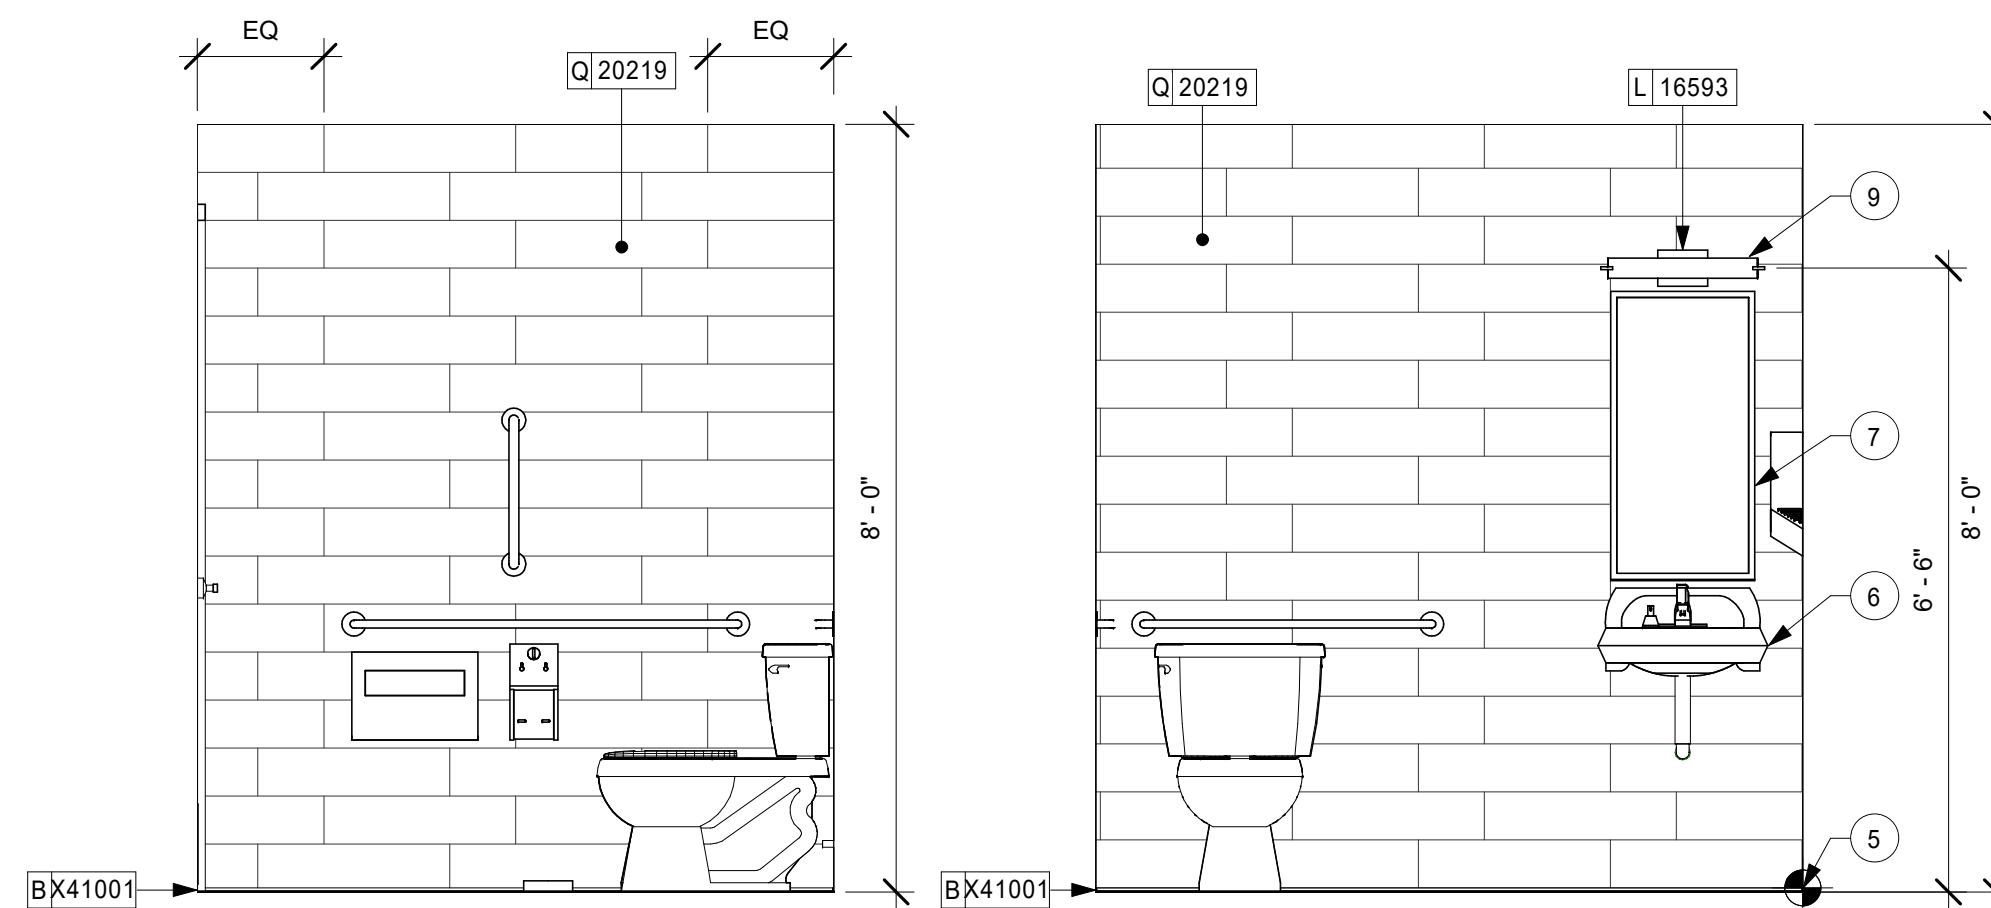


8 MEN'S RESTROOM

Scale: 1/2" = 1'-0"


9 MEN'S RESTROOM

Scale: 1/2" = 1'-0"

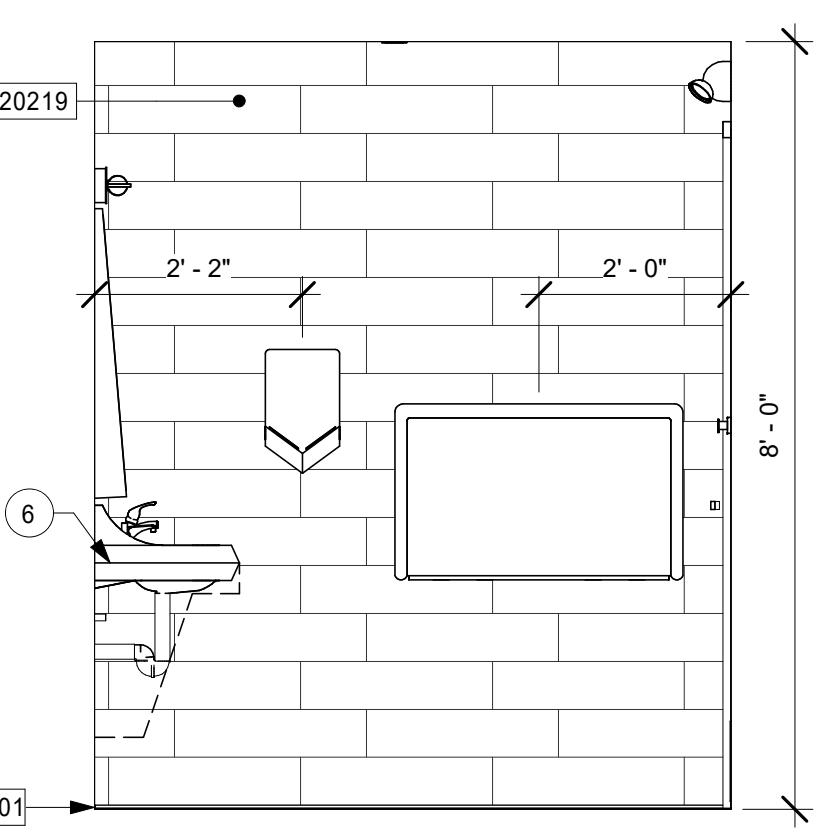


6 MEN'S RESTROOM

Scale: 1/2" = 1'-0"

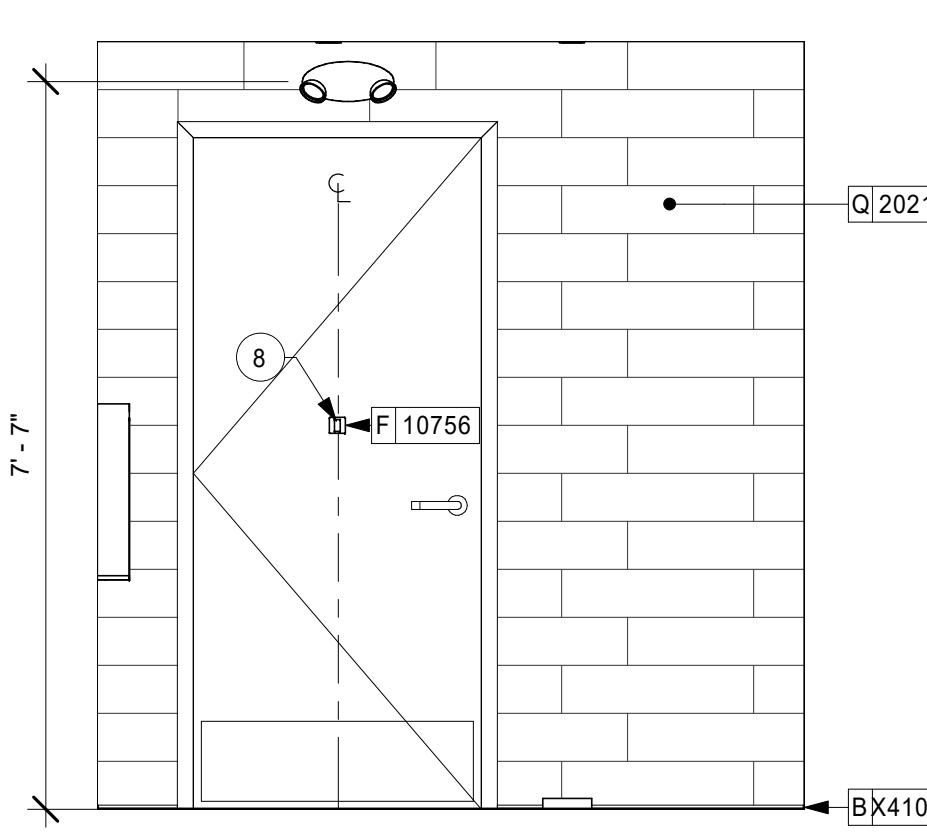

7 MEN'S RESTROOM

Scale: 1/2" = 1'-0"

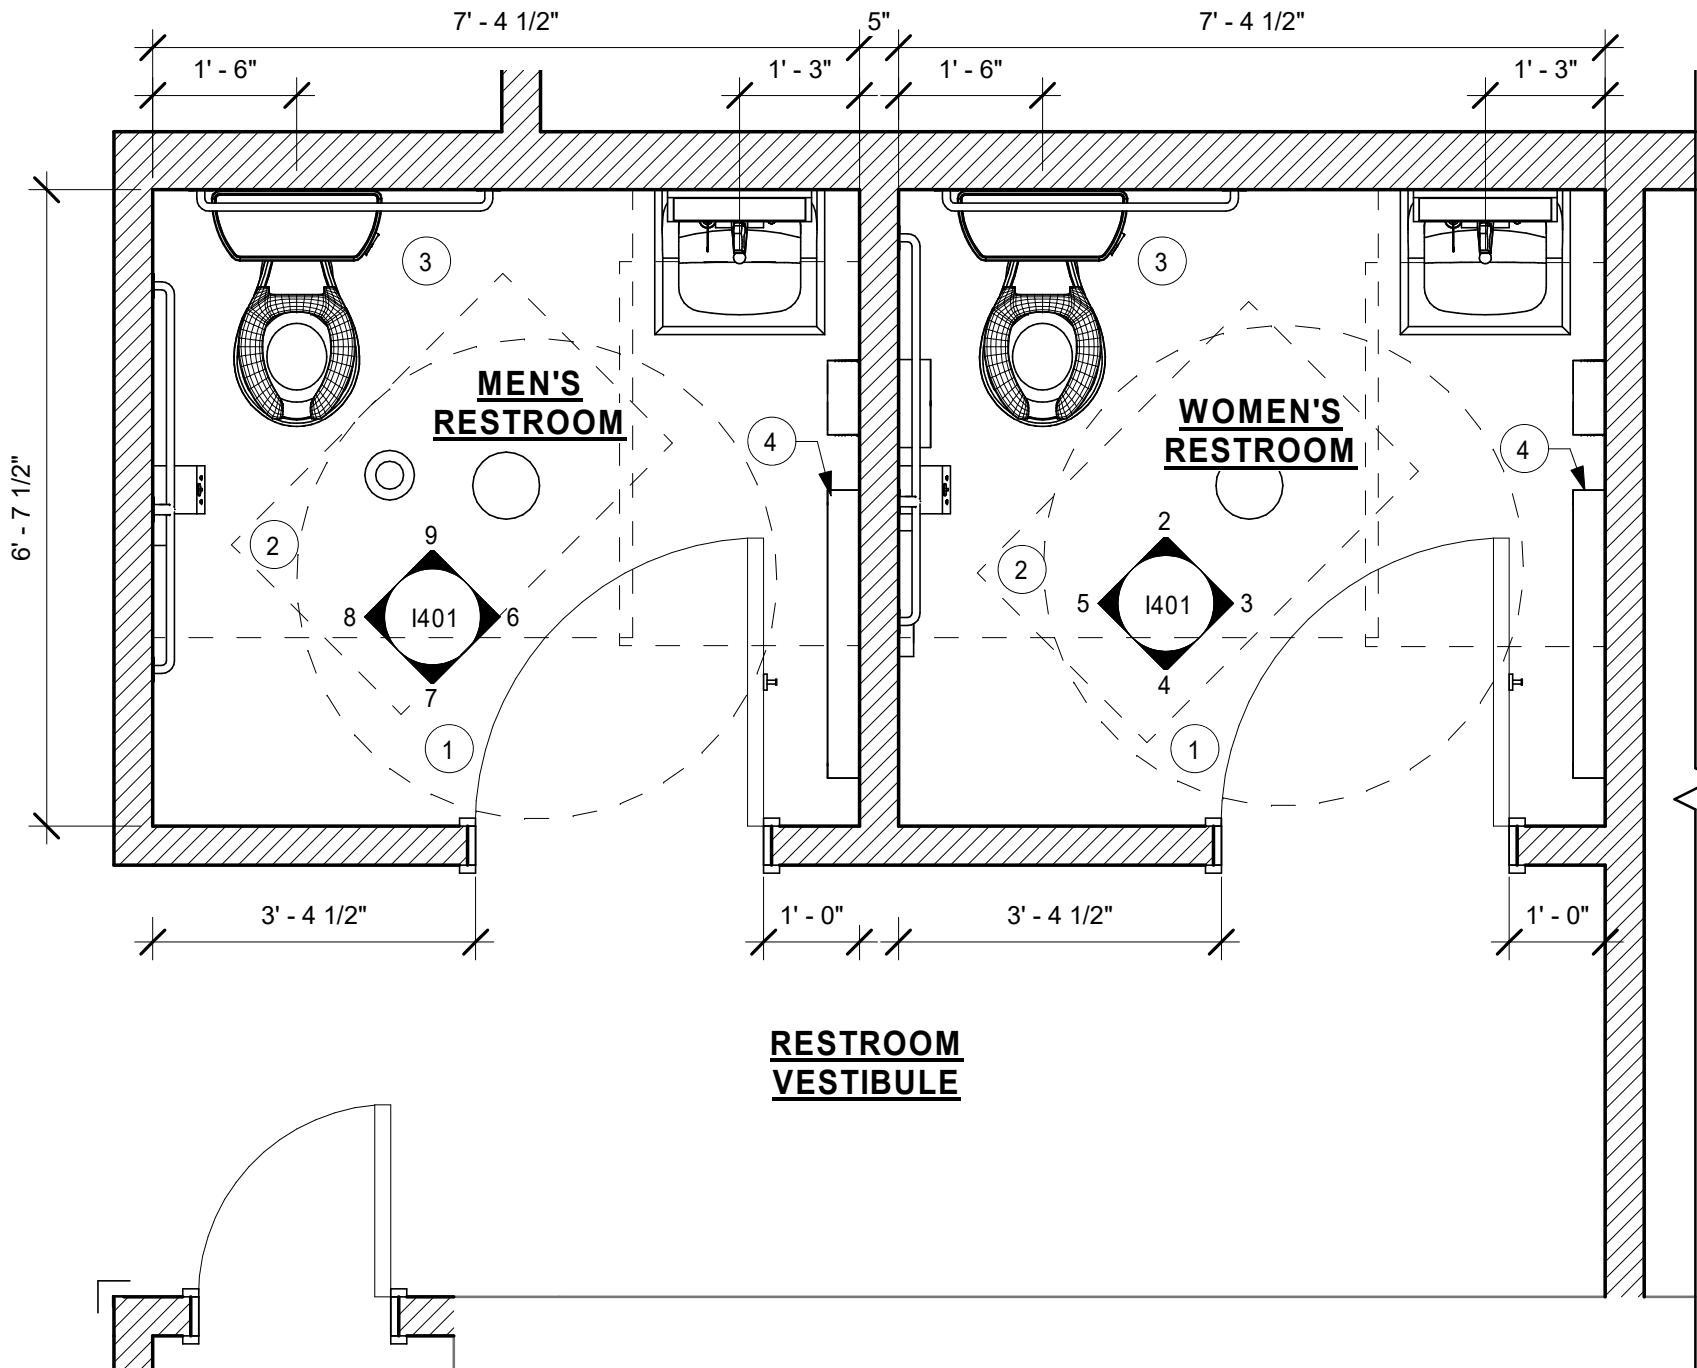


1 1ST FLOOR - ENLARGED RESTROOM PLAN

Scale: 1/2" = 1'-0"

WALL TREATMENT (AREA) SCHEDULE - "Q"					
DESIGN ID	AREA	DESCRIPTION	FURN. BY	INST. BY	COMMENTS
X28541	241 SF	WALL COVERING - TRI-KES - COLLECTION STACY GARCIA	GC	GC	CODE SG2854, TYPE 2
PLASTIC 11469	2370 SF	FRP - WHITE	GC	GC	
TILE 20219	428 SF	TILE - LUNAR - TITANIUM - 6X24IN 150X600MM	SB	GC	GROUT: MAPEI - 27 SILVER, OR EQUAL
20243	267 SF	20243 TILE - COLOR STUDIO - WHITE - BRICK MOSAIC - 12X12IN 300X300MM SHEET	SB	GC	GROUT: MAPEI - 11 SAHARA BEIGE, OR EQUAL
X20288	206 SF	X20288 TILE - COLOR STUDIO - WHITE - SQUARE MOSAIC - 12X12IN 300X300MM SHEET	GC	GC	GROUT: MAPEI - 11 SAHARA BEIGE, OR EQUAL
X20299	132 SF	X20299 TILE - COLOR STUDIO - MALT - SQUARE MOSAIC - 12X12IN 300X300MM SHEET	GC	GC	GROUT: MAPEI - 11 SAHARA BEIGE, OR EQUAL

WALL BASE SCHEDULE - "B"					
DESIGN ID	LENGTH	DESCRIPTION	FURN. BY	INST. BY	COMMENTS
CHAIR RAIL					
X41003	66' - 10 1/2"	1" x 1" THICK TRIM	GC	GC	TRIM AT TILE/PAINT TRANSITION PAINTED SW7646 - FIRST STAR
X51055	23' - 8 3/4"	QUADEC SCHLUTER	GC	GC	CUSTOM QUADEC SCHLUTER: Q100 ABGB. FINISH: STYLMARK #212. MATERIAL SAMPLE TO BE SENT TO DESIGNER BEFORE INSTALLATION
TILE BASE					
19795	229' - 1 1/4"	POLYVINYL FLOOR TILE - ECOGRIP - PEWTER	SB	GC	
20215	118' - 2 1/2"	TILE BASE - FORMULA - UNION BLACK - 6X12IN 150X300MM	SB	GC	GROUT: MAPEI - 10 BLACK, OR EQUAL
X41001	49' - 3 3/4"	JOLLY SCHLUTER TRIM AT RESTROOM TILE	GC	GC	JOLLY SCHLUTER: ABGB BRUSHED: COLOR ANTHRACITE

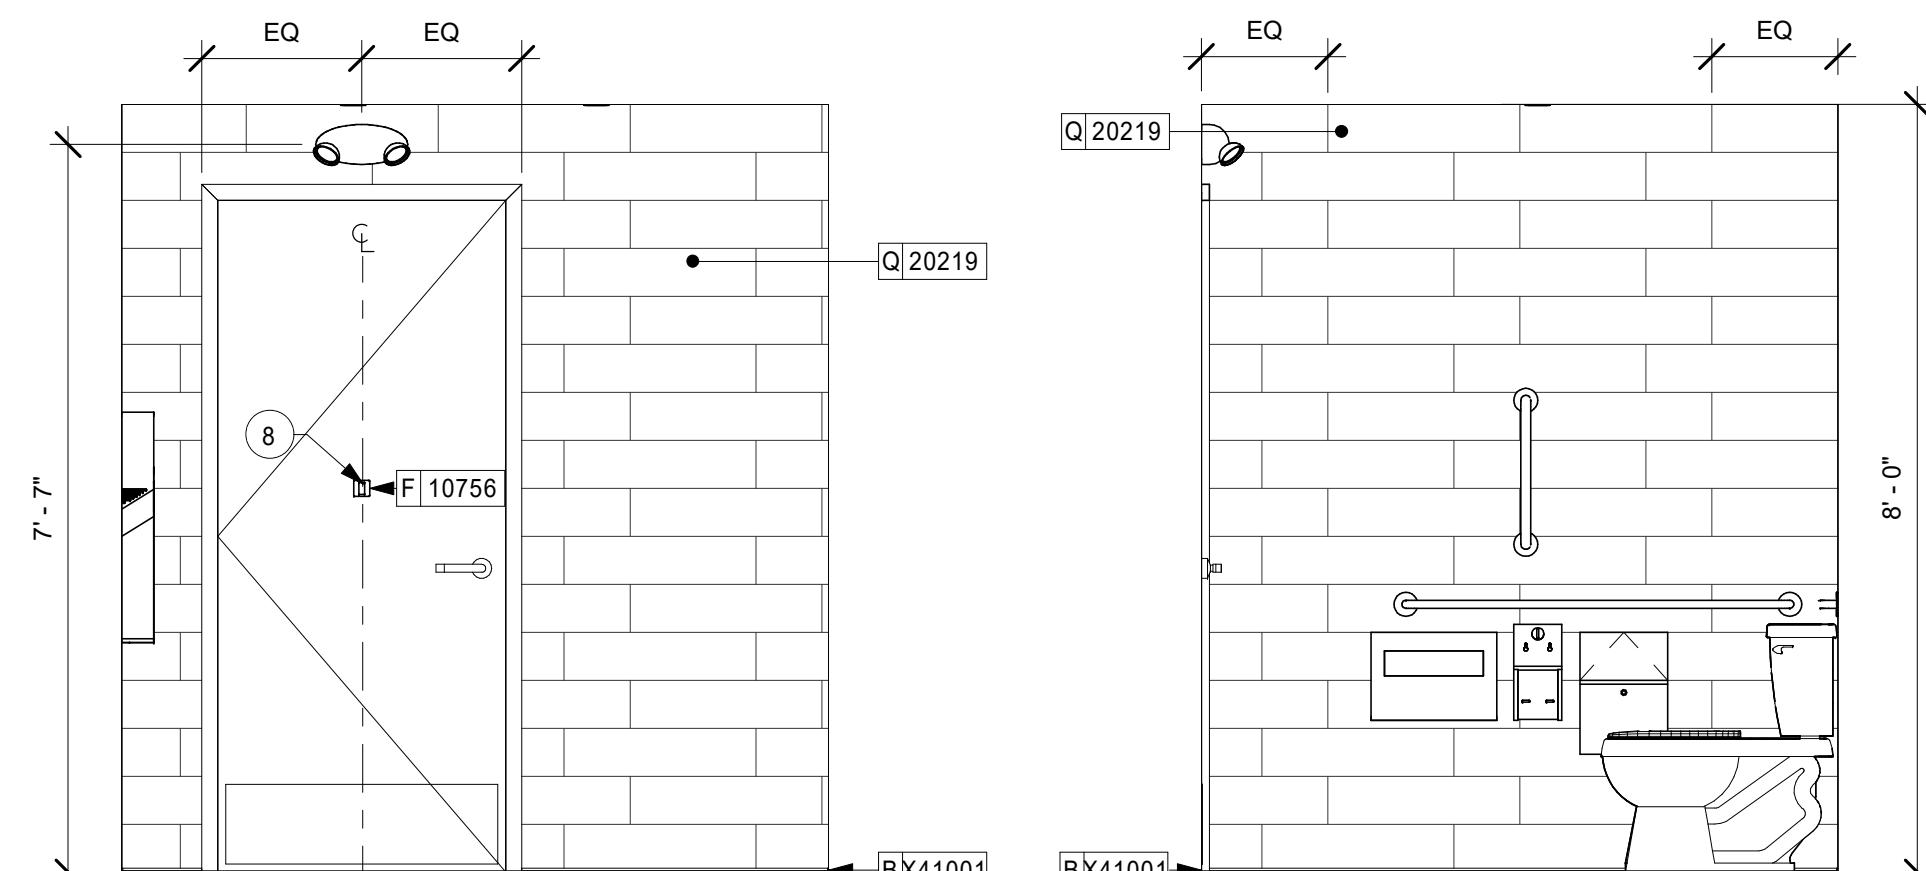


4 WOMEN'S RESTROOM

Scale: 1/2" = 1'-0"

5 WOMEN'S RESTROOM

Scale: 1/2" = 1'-0"

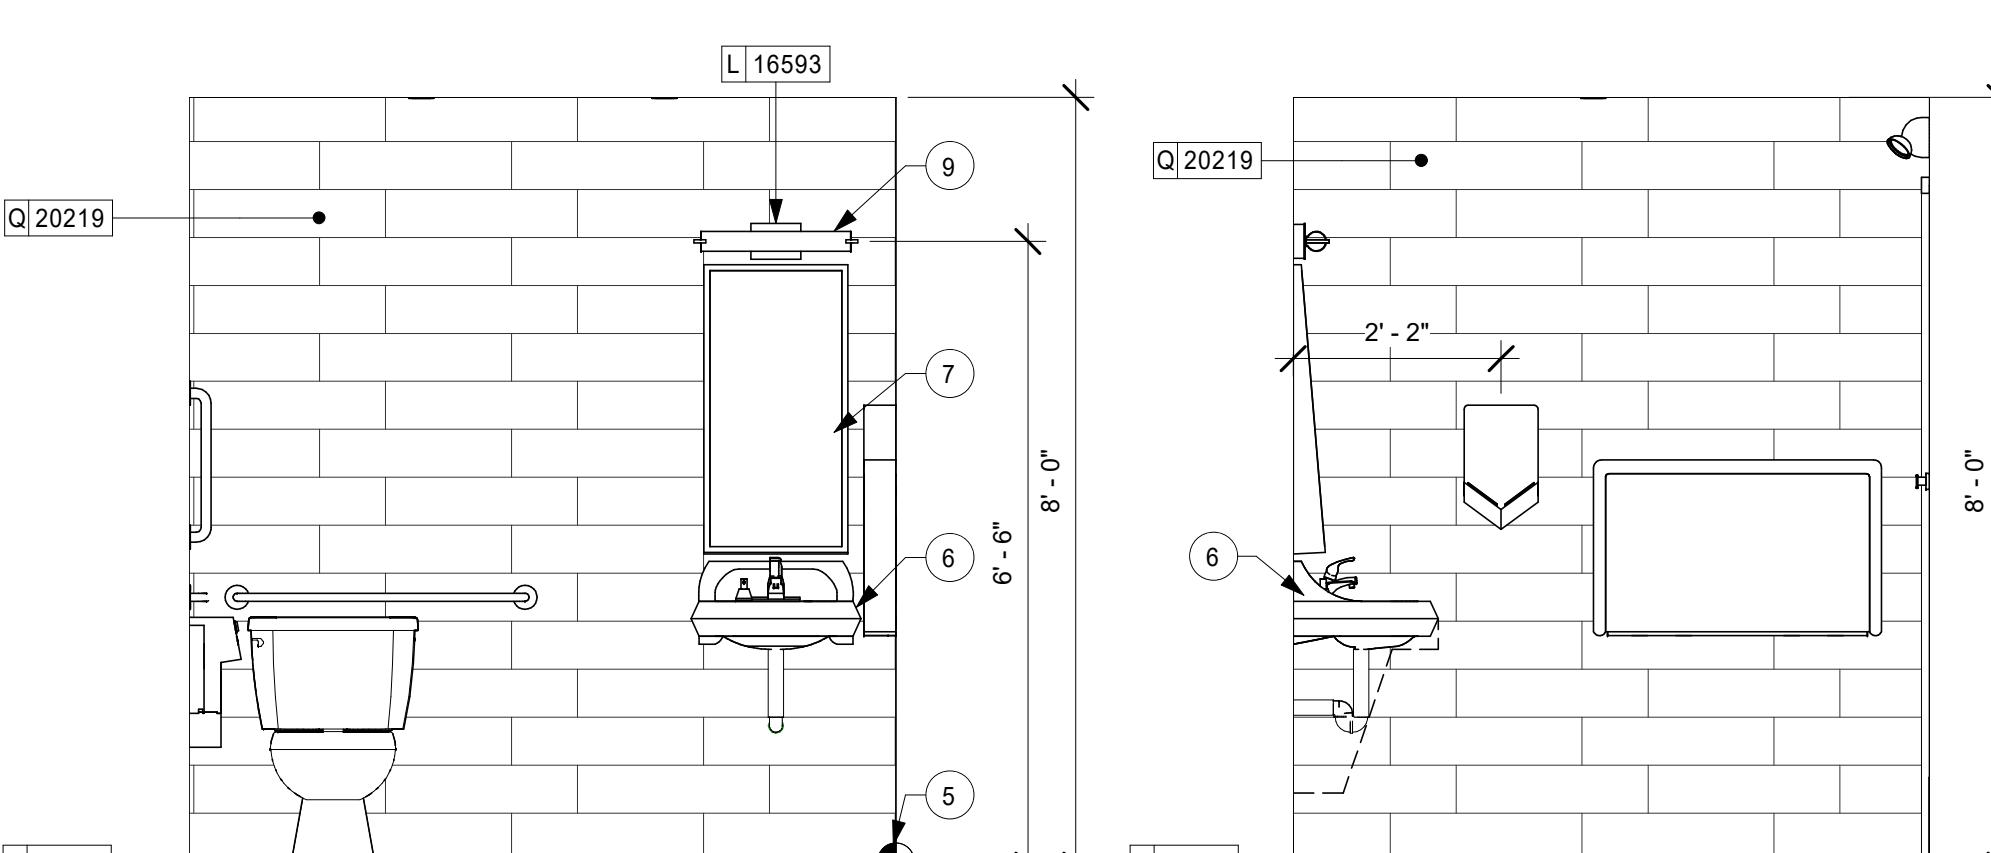


2 WOMEN'S RESTROOM

Scale: 1/2" = 1'-0"

3 WOMEN'S RESTROOM

Scale: 1/2" = 1'-0"

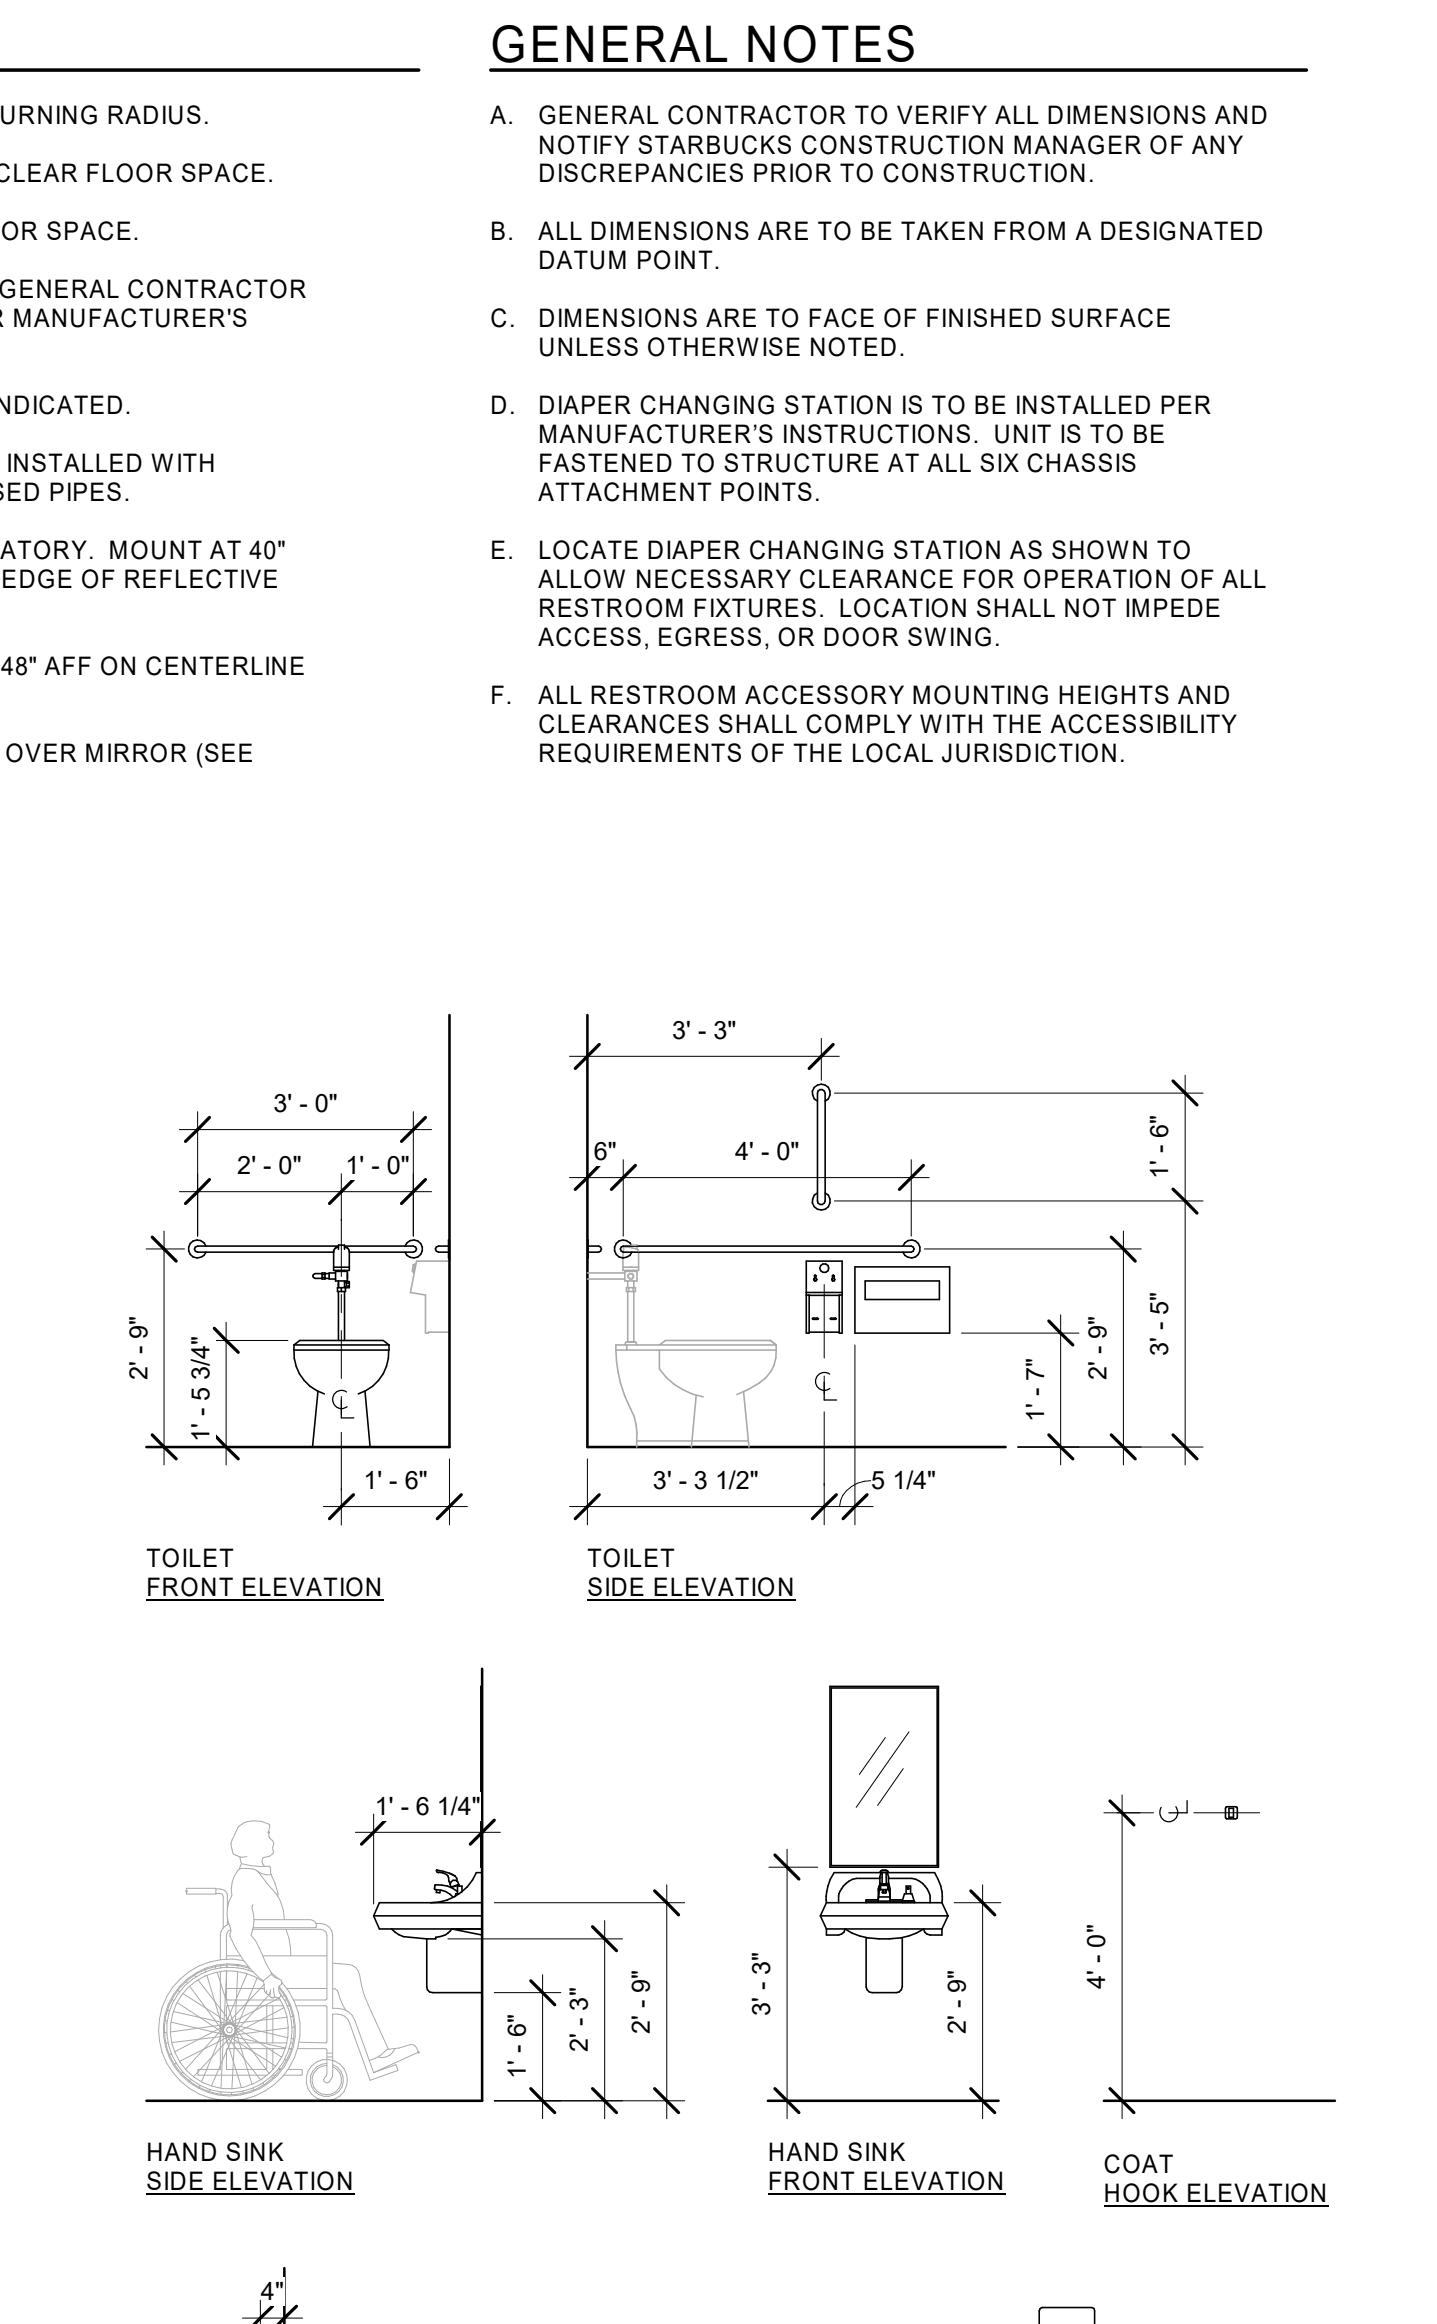

10 MOUNTING HEIGHTS FOR RESTROOM ACCESSORIES

Scale: 3/8" = 1'-0"




10 MOUNTING HEIGHTS FOR RESTROOM ACCESSORIES

Scale: 3/8" = 1'-0"



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Scale: 3/8" = 1'-0"

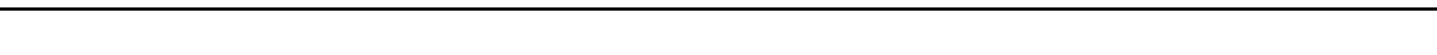

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