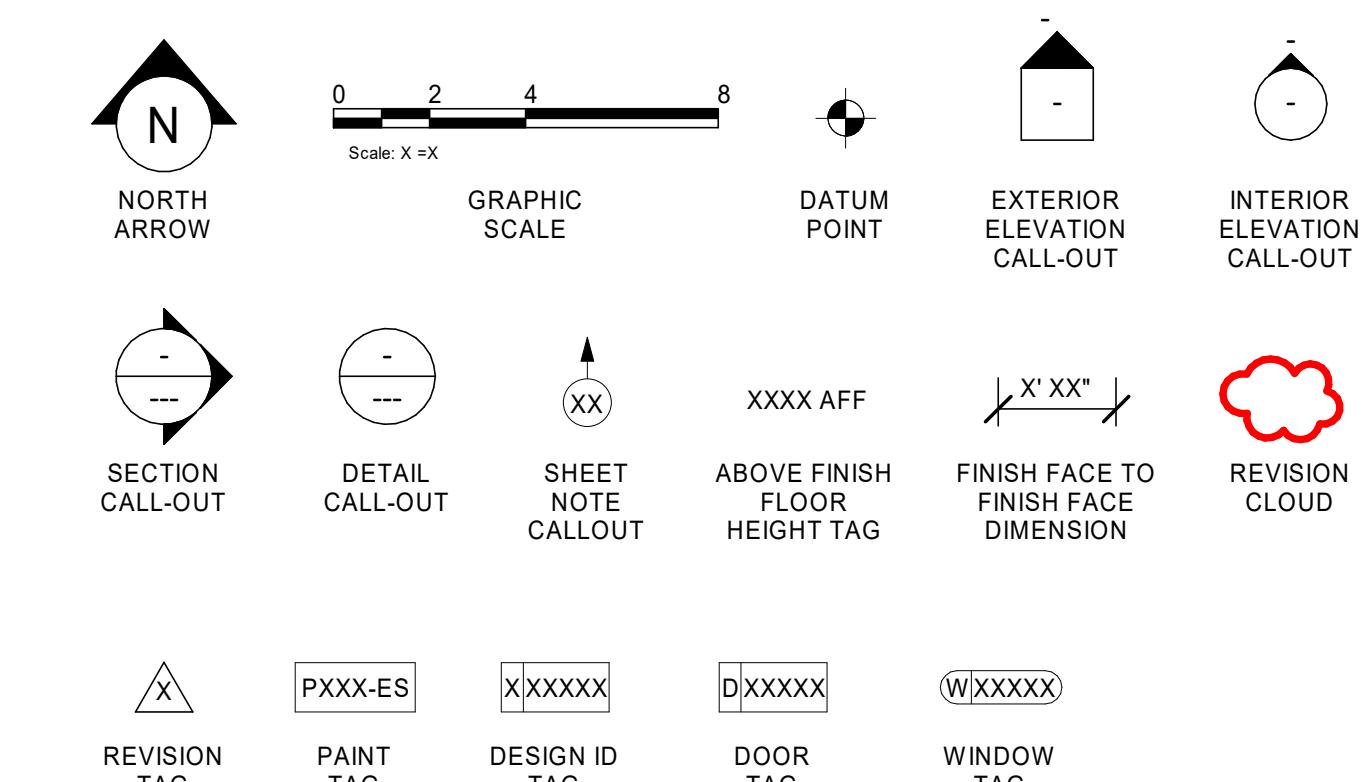


ABBREVIATIONS

A/C	AIR CONDITIONING
ACT	ACOUSTICAL CEILING TILE
ADJ	ADJUSTABLE
AFF	ABOVE FINISHED FLOOR
AMP	AMPERE
ARCH	ARCHITECT
BOH	BACK OF HOUSE
CAB	CABINET
CL	CENTER LINE
CLG	CEILING
CM	STARBUCKS
CTR	CONSTRUCTION MANAGER
CX	CENTER
CXA	COMMISSIONING
	COMMISSIONING AGENT
DEG	DEGREE
DET	DETAIL
DIA	DIAMETER
DIM	DIMENSION
DM	STARBUCKS
DN	DESIGN MANAGER
EA	EACH
EL	ELEVATION
EQ	EQUAL
EXIST	EXISTING
EXT	EXTERIOR
FF&E	FURNITURE, FIXTURE, AND EQUIPMENT
FLR	FLOOR
FOH	FRONT OF HOUSE
FOIC	FURNISHED BY OWNER, INSTALLED BY CONTRACTOR
FOIO	FURNISHED BY OWNER INSTALLED BY OWNER
FT	FOOT/FEET
G	GROUND
GC	GENERAL CONTRACTOR
GWB	GYPSUM WALLBOARD
HC	HOLLOW CORE
HDW	HARDWARE
HM	HOLLOW METAL
HORIZ	HORIZONTAL
HR	HOUR
HT	HEIGHT
HVAC	HEATING, VENTILATING AND AIR CONDITIONING
ID.	INSIDE DIAMETER
LEED	LEADERSHIP IN ENERGY AND ENVIRONMENTAL DESIGN
LL	LANDLORD
LV	LOW VOLTAGE
MAX	MAXIMUM
MEP	MECHANICAL, ELECTRICAL AND PLUMBING
MFR	MANUFACTURER
MIN	MINIMUM
NIC	NOT IN CONTRACT
NLT	NIGHT LIGHT
NTS	NOT TO SCALE
OC	ON CENTER
O.D.	OUTSIDE DIAMETER
PLC	PLACE
R	RADIUS
REF	REFERENCE
REQD	REQUIRED
REV	REVISION
RND	ROUND
SB	STARBUCKS
SC	SOLID CORE
SF	SQUARE FEET
SHT	SHEET
SIM	SIMILAR
SPEC	SPECIFICATION
SQ	SQUARE
TEMP	TEMPORARY
TYP	TYPICAL
UC	UNDER COUNTER
UNO	UNLESS NOTED OTHERWISE
VERT	VERTICAL
VIF	VERIFY IN FIELD

RESPONSIBILITY LEGEND

GC	GENERAL CONTRACTOR
LL	LANDLORD
SB	STARBUCKS

ARCHITECTURAL SYMBOL LEGEND**PROJECT CONTACTS**

MAILING ADDRESS: STARBUCKS COFFEE COMPANY
2401 UTAH AVENUE SOUTH
MS STOP: S-SD10
SEATTLE, WASHINGTON 98134
(206) 318-1575

DESIGN MANAGER: RYAN WONG
STARBUCKS COFFEE COMPANY
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MS STOP: S-SD10
SEATTLE, WASHINGTON 98134
(206) 318-0019

CONSTRUCTION MANAGER: RON BLANCHETTE
STARBUCKS COFFEE COMPANY
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MS STOP: S-SD10
SEATTLE, WASHINGTON 98134
(503) 572-4345

ARCHITECT OF RECORD: GPD ENGINEERING & ARCHITECTURE PROFESSIONAL CORPORATION
520 SOUTH MAIN ST. SUITE 2531
AKRON, OH 44311
330-572-3611
CONTACT: TONY WAHL
AWAHL@GPDGROUP.COM

MEP CONSULTANT OF RECORD: GPD ENGINEERING & ARCHITECTURE PROFESSIONAL CORPORATION
520 SOUTH MAIN ST. SUITE 2531
AKRON, OH 44311
330-572-3611

STRUCTURAL CONSULTANT: GPD ENGINEERING & ARCHITECTURE PROFESSIONAL CORPORATION
520 SOUTH MAIN ST. SUITE 2531
AKRON, OH 44311
330-572-3611

GENERAL NOTES

- THE DRAWINGS AND PROJECT MANUAL TOGETHER CONSTITUTE THE CONTRACT DOCUMENTS FOR CONSTRUCTION. ALL GENERAL REQUIREMENTS ARE TO BE MET AND ALL MATERIALS, FINISHES AND SYSTEMS ARE TO BE INSTALLED AND PERFORM PER SPECIFICATIONS UNLESS OTHERWISE NOTED.
- GENERAL CONTRACTOR SHALL VISIT THE SITE, REVIEW THE BUILDING SHELL DRAWINGS AS SUBMITTED BY THE LANDLORD OR STARBUCKS AND BECOME THOROUGHLY FAMILIAR WITH THE SITE CONDITIONS PRIOR TO CONSTRUCTION.
- GENERAL CONTRACTOR SHALL CONSULT WITH STARBUCKS CONSTRUCTION MANAGER TO RESOLVE ANY CHANGES, OMISSIONS OR PLAN DISCREPANCIES PRIOR TO CONSTRUCTION.
- ALL WORK SHALL BE PERFORMED IN STRICT COMPLIANCE WITH LOCAL, COUNTY, STATE AND FEDERAL CODES AND ORDINANCES.
- GENERAL CONTRACTOR SHALL VERIFY THE LOCATION OF ALL UTILITIES.
- GENERAL CONTRACTOR TO VERIFY ALL DIMENSIONS, INCLUDING CLEARANCES REQUIRED BY OTHER TRADES AND NOTIFY STARBUCKS CONSTRUCTION MANAGER OF ANY DISCREPANCIES PRIOR TO PROCEEDING WITH THE WORK. ALL DIMENSIONS ARE TO THE FACE OF THE FINISHED SURFACE UNLESS NOTED OTHERWISE. ALL DIMENSIONS TO BE TAKEN FROM DESIGNATED DATUM POINT. DO NOT SCALE DRAWINGS.
- GENERAL CONTRACTOR SHALL PATCH AND REPAIR ALL EXISTING WALLS, FLOORS, CEILINGS, OR OTHER SURFACES IDENTIFIED TO REMAIN THAT MAY BECOME DAMAGED DURING THE COURSE OF THE WORK.
- THE GENERAL CONTRACTOR IS RESPONSIBLE FOR OBTAINING PERMITS FOR FIRE PROTECTION, PLUMBING, MECHANICAL, AND ELECTRICAL SYSTEMS PRIOR TO INSTALLATION OF SUCH SYSTEMS.
- GENERAL CONTRACTOR SHALL RETAIN ONE SET OF PERMIT PLANS ON-SITE TO DOCUMENT ALL CHANGES MADE DURING CONSTRUCTION. THE RECORD DRAWINGS SHALL BE ISSUED TO THE OWNER AT PROJECT CLOSE-OUT AS DESCRIBED IN THE GENERAL REQUIREMENTS OF THE PROJECT MANUAL.
- GENERAL CONTRACTOR IS RESPONSIBLE FOR COORDINATING DELIVERY OF MATERIALS FROM STARBUCKS CONTRACTED THIRD PARTY LOGISTICS DISTRIBUTION SERVICES AND VENDOR DIRECT SHIPMENTS. SEE THE PROJECT MANUAL FOR ADDITIONAL INFORMATION.
- RESPONSIBILITY FOR SUPPLY AND DELIVERY OF MATERIALS AND EQUIPMENT IS IDENTIFIED IN THE DRAWING SCHEDULE SHEETS UNDER THE COLUMN LABELED "RESPONSIBILITY".
- FOR THE PURPOSE OF THE DOCUMENTS, TO "INSTALL" SHALL MEAN TO PROVIDE ALL FASTENERS, MISCELLANEOUS HARDWARE, BLOCKING, ELECTRICAL CONNECTIONS, PLUMBING CONNECTIONS AND OTHER ITEMS REQUIRED FOR A COMPLETE AND OPERATIONAL INSTALLATION, UNLESS OTHERWISE NOTED.
- ALL ITEM SUBSTITUTIONS MUST BE APPROVED BY THE STARBUCKS CONSTRUCTION MANAGER.

SITE INFORMATION

CODE AUTHORITIES: CITY OF COOS BAY
BUILDING CODE: 2019 OREGON STRUCTURAL SPECIALTY CODE
PLUMBING CODE: 2017 OREGON PLUMBING SPECIALTY CODE
MECHANICAL CODE: 2019 OREGON MECHANICAL SPECIALTY CODE
ELECTRICAL CODE: 2017 OREGON ELECTRICAL SPECIALTY CODE
ENERGY CODE: 2019 OREGON ZERO ENERGY READY COMMERCIAL CODE
FIRE CODE: 2019 OREGON FIRE CODE
HEALTH CODE: OREGON HEALTH CODE
ACCESSIBILITY CODE: 2009 ICC / ANSI A11.1

ZONING:

SPRINKLED: YES
LEASABLE AREA: 1,859
CONSTRUCTION TYPE: V-B
OCCUPANCY TYPE: A-2 NO CHANGE
PROPOSED USE: RETAIL SALES AND SERVICES

DEFERRED SUBMITTALS:

SIGNAGE
OCCUPANCY LOAD: 60
INDOOR SEATING / CAFE: 677 SF / 15 = 45
RETAIL / SALES: 290 SF / 30 = 10
BACKBAR: 375 SF / 200= 2
WORKROOM: 375 SF / 300 = 2
RESTROOM / VESTIBULES: 141 SF / 300 = 1

TOTAL INTERIOR OCCUPANT LOAD: 60
TOTAL INTERIOR SEATING: 40
TOTAL EXTERIOR SEATING: 10
TOTAL GROSS SQUARE FOOTAGE: 2,100 SF
TOTAL NET SQUARE FOOTAGE: 1,859 SF

INDEX OF SHEETS

LEGEND:	
X - SHEET ISSUED	
R - SHEET ISSUED FOR REFERENCE AND COORDINATION ONLY	
SEE TITLEBLOCK FOR REVISION ISSUE DATE(S)	
SHEET	SHEET TITLE
BID SET	
PERMIT SET	
REVISION 1	
REVISION 2	
REVISION 3	
REVISION 4	




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STARBUCKS TEMPLATE VERSION: i2019-10-25



GPD PROJECT NO: 2019355.20





1/31/2020

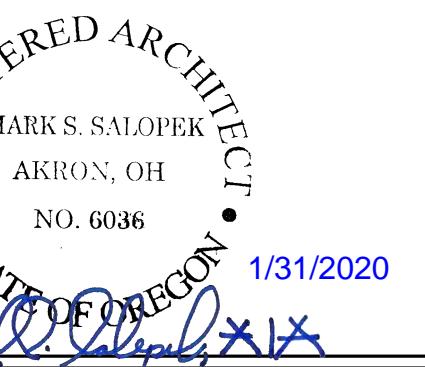PROJECT NAME: Hwy 101 - COOS BAY
PROJECT ADDRESS: 101, COOS BAY VILLAGE, COOS BAY, OR 97420

STORE #: 60983
PROJECT #: 84073-001
ISSUE DATE: 01-29-20 - 100 percent
DESIGN MANAGER: RYAN WONG
PRODUCTION DESIGNER: GPD
CHECKED BY: TC

Revision Schedule			
Rev	Date	By	Description

SHEET TITLE: GENERAL INFORMATION
SCALE: AS SHOWN
SHEET NUMBER: G001

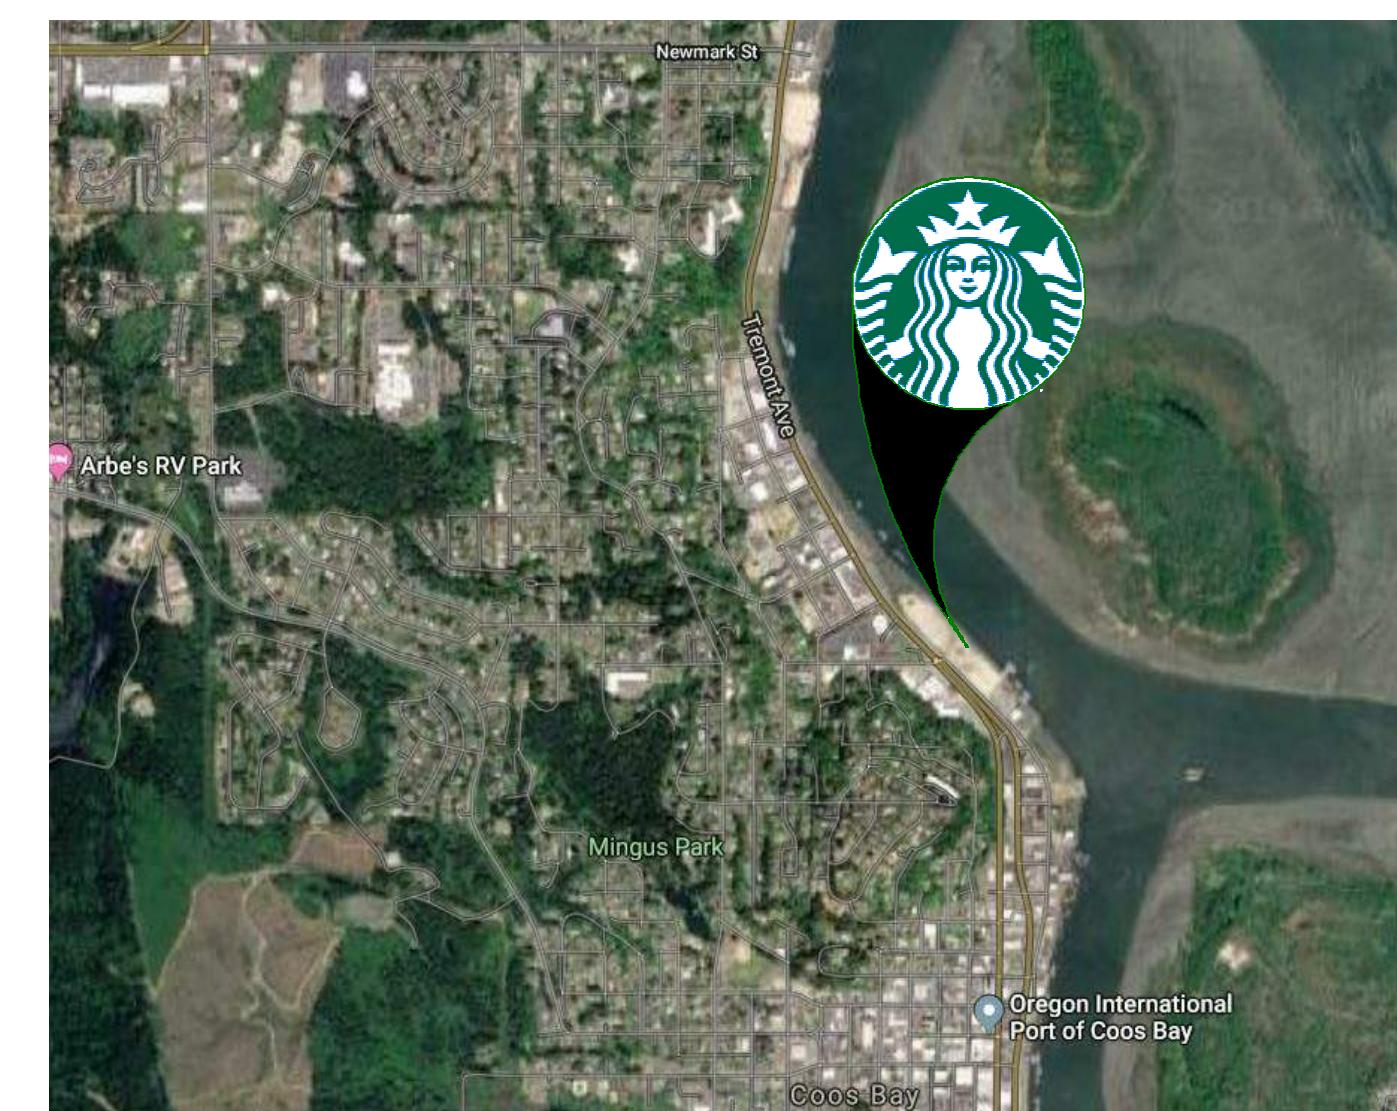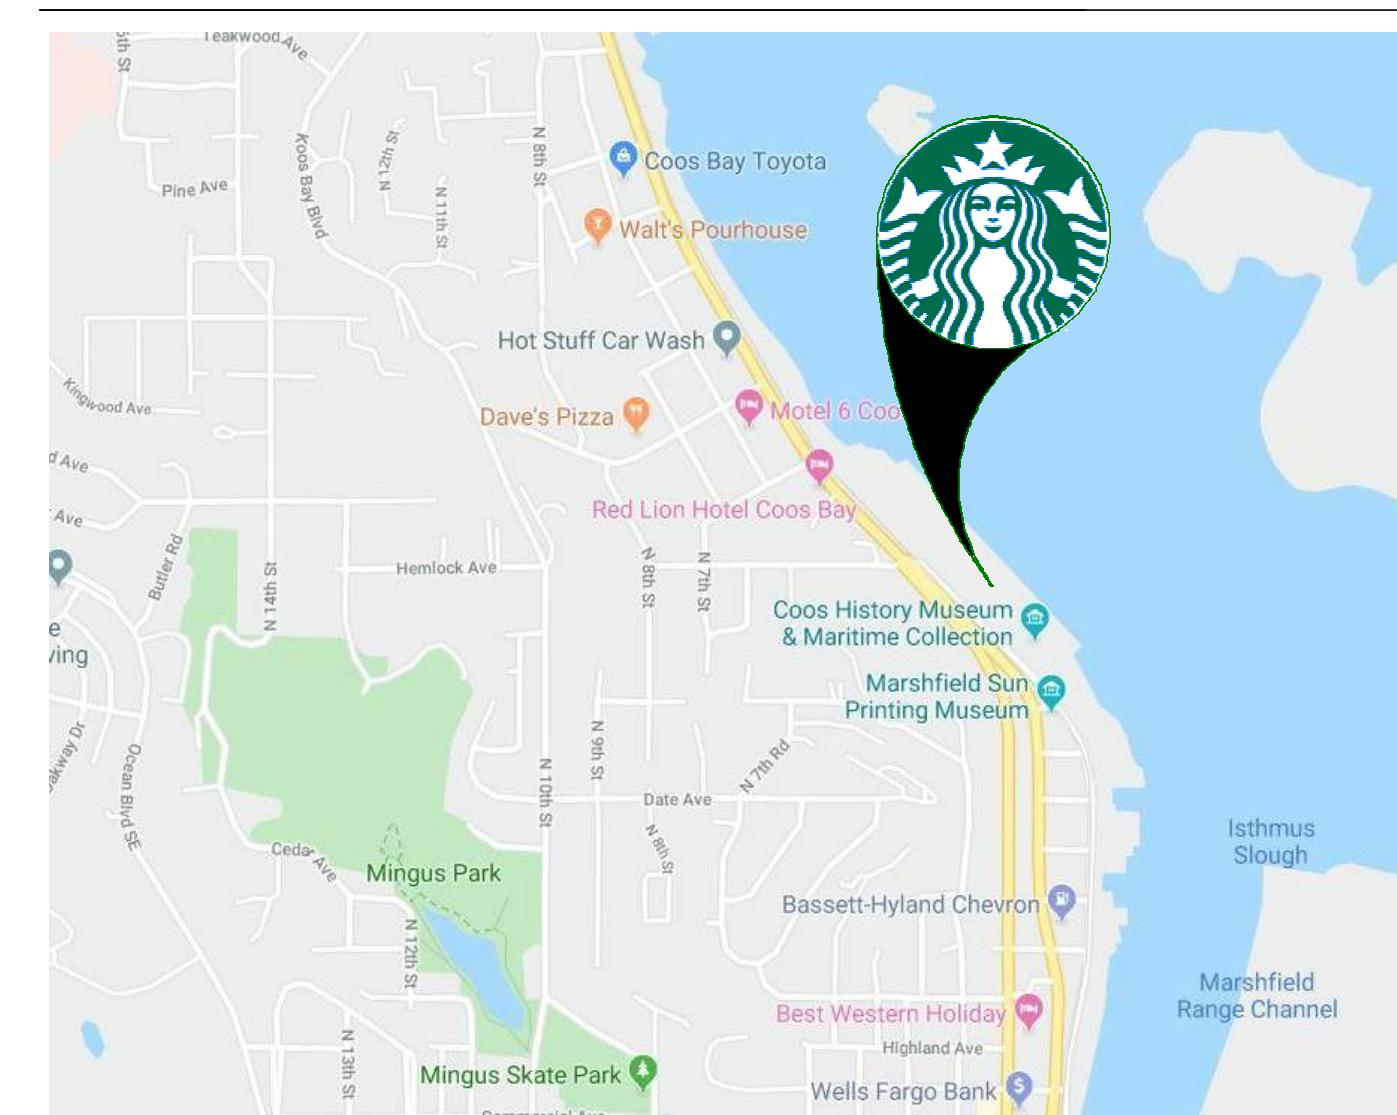AERIAL MAP**VICINITY PLAN****SCOPE OF WORK**

NEW PROPOSED TENANT IMPROVEMENT FOR NEW STARBUCKS STORE W/ DRIVE-THRU.

INTERIOR SCOPE OF WORK INCLUDES INTERIOR WALLS, WALL FINISHES, FURNITURE, FIXTURES, EQUIPMENT, CASEWORK, AND ACCESSIBLE RESTROOMS.

EXTERIOR SCOPE OF WORK INCLUDES BUILDING SIGNAGE, DRIVE-THRU EQUIPMENT. IT ALSO INCLUDES EXTERIOR FURNITURE.

SIGNAGE AND DRIVE-THRU EQUIPMENT PERMITTED SEPARATELY.

SITE INFORMATION

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SPRINKLED: YES
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TOTAL NET SQUARE FOOTAGE: 1,859 SF

SHEET TITLE: GENERAL INFORMATION
SCALE: AS SHOWN
SHEET NUMBER: G001



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INDOOR SEATING			
TYPE	DESCRIPTION	NUMBER OF ITEMS	TOTAL SEATS
01 SEAT	TABLE TOP, ROUND	2	4
02 SEAT	TABLE TOP, SQUARE/RECTANGLE	7	24
03 SEAT	COMMUNITY TABLE	1	8
04 SEAT	TABLE TOP, OVAL	1	4

OUTDOOR SEATING			
TYPE	DESCRIPTION	NUMBER OF ITEMS	TOTAL SEATS
05 SEAT	TABLE TOP, ROUND	1	2
06 SEAT	TABLE TOP, SQUARE	3	6
07 SEAT	OTHER (ADA)	1	2

EGRESS CALCULATION			
EXIT WIDTH REQUIRED - 60 OCC X 0.2	= 12 IN.		
EXIT WIDTH PROVIDED	= 114 IN.		
EXITS	= 36 IN. PRIMARY ENTRY, 36 IN. SECONDARY ENTRY, 42 IN. WORKROOM		
# EXITS REQUIRED	= 2		
# EXITS PROVIDED	= 3		
MAXIMUM ALLOWABLE TRAVEL DISTANCE	= 75 FT.		
MAXIMUM TRAVEL DISTANCE PROVIDED	= 42 FT.		
MINIMUM EXIT SEPARATION	= 74' - 11". (MAXIMUM DIAGONAL) / 2 = 37' - 5.5"		
EXIT SEPARATION PROVIDED	= 44' - 1.25"		

PLUMBING FIXTURE CALCULATION					
CHAPTER 29-29023 (FOR REFERENCE ONLY)					
OCCUPANCY	MALE	FEMALE	TOTAL		
30 OCC	30 OCC	30 OCC	60 OCC		
WATERCLOSETS		LAVATORIES		WATER FOUNTAIN	
1 / 25 OCC		1 / 40 OCC		FREE WATER PROVIDED	
FIXTURES	REQUIRED:	1 WC PER M	1 WC PER F	1 LAV PER M	1 LAV PER F
				0	
	PROVIDED:	1 WC PER M	1 WC PER F	1 LAV PER M	1 LAV PER F
				0	

ROOM SCHEDULE

NAME	AREA
BACKBAR	376 SF
CAFE	967 SF
MEN'S RESTROOM	49 SF
RESTROOM VESTIBULE	44 SF
WOMEN'S RESTROOM	48 SF
WORKROOM	374 SF
GRAND TOTAL	1859 SF

OCCUPANCY NOTES

OCCUPANCY CLASSIFICATION: A-2	
TOTAL OCCUPANTS: 60	
OCCUPANCY	
CAFE: 677 SQ. FT. / 15 SQ. FT. / OCC	45 OCC
RETAIL: 290 SQ. FT. / 30 SQ. FT. / OCC	10 OCC
BAR: 375 SQ. FT. / 200 SQ. FT. / OCC	2 OCC
WORKROOM: 375 SQ. FT. / 300 SQ. FT. / OCC	2 OCC
UNOCCUPIED: 141 SQ. FT. / 300 SQ. FT. / OCC	1 OCC
TOTAL OCC LOAD:	60 OCC

ACCESSIBLE SEATING

INTERIOR SEATING:
40 SEATS X 5% = 2 ADA REQUIRED (4 PROVIDED)

EXTERIOR SEATING:
10 SEATS X 5% = 1 ADA REQUIRED (1 PROVIDED)

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STARBUCKS TEMPLATE VERSION: i2019-10-25



GPD Engineering and Architecture
Professional Corporation

520 SOUTH MAIN ST, SUITE 2531
AKRON, OH 44311
P: 330-572-2100 F: 330-572-2101

GPD PROJECT NO: 2019355.20

REGISTERED ARCHITECT
• MARK S. SALOPEK
AKRON, OH
NO. 6036
STATE OF OREGON 1/31/2020
Mark Salopek

PROJECT NAME:
HWY 101 - COOS BAY

PROJECT ADDRESS:
**101, COOS BAY VILLAGE
COOS BAY, OR 97420**

STORE #: 60983
PROJECT #: 84073-001
ISSUE DATE: 01-29-20 - 100 percent
DESIGN MANAGER: RYAN WONG
PRODUCTION DESIGNER: GPD
CHECKED BY: TC


Revision Schedule

Rev	Date	By	Description

SHEET TITLE:
GENERAL INFORMATION


SCALE: AS SHOWN

SHEET NUMBER:
G002

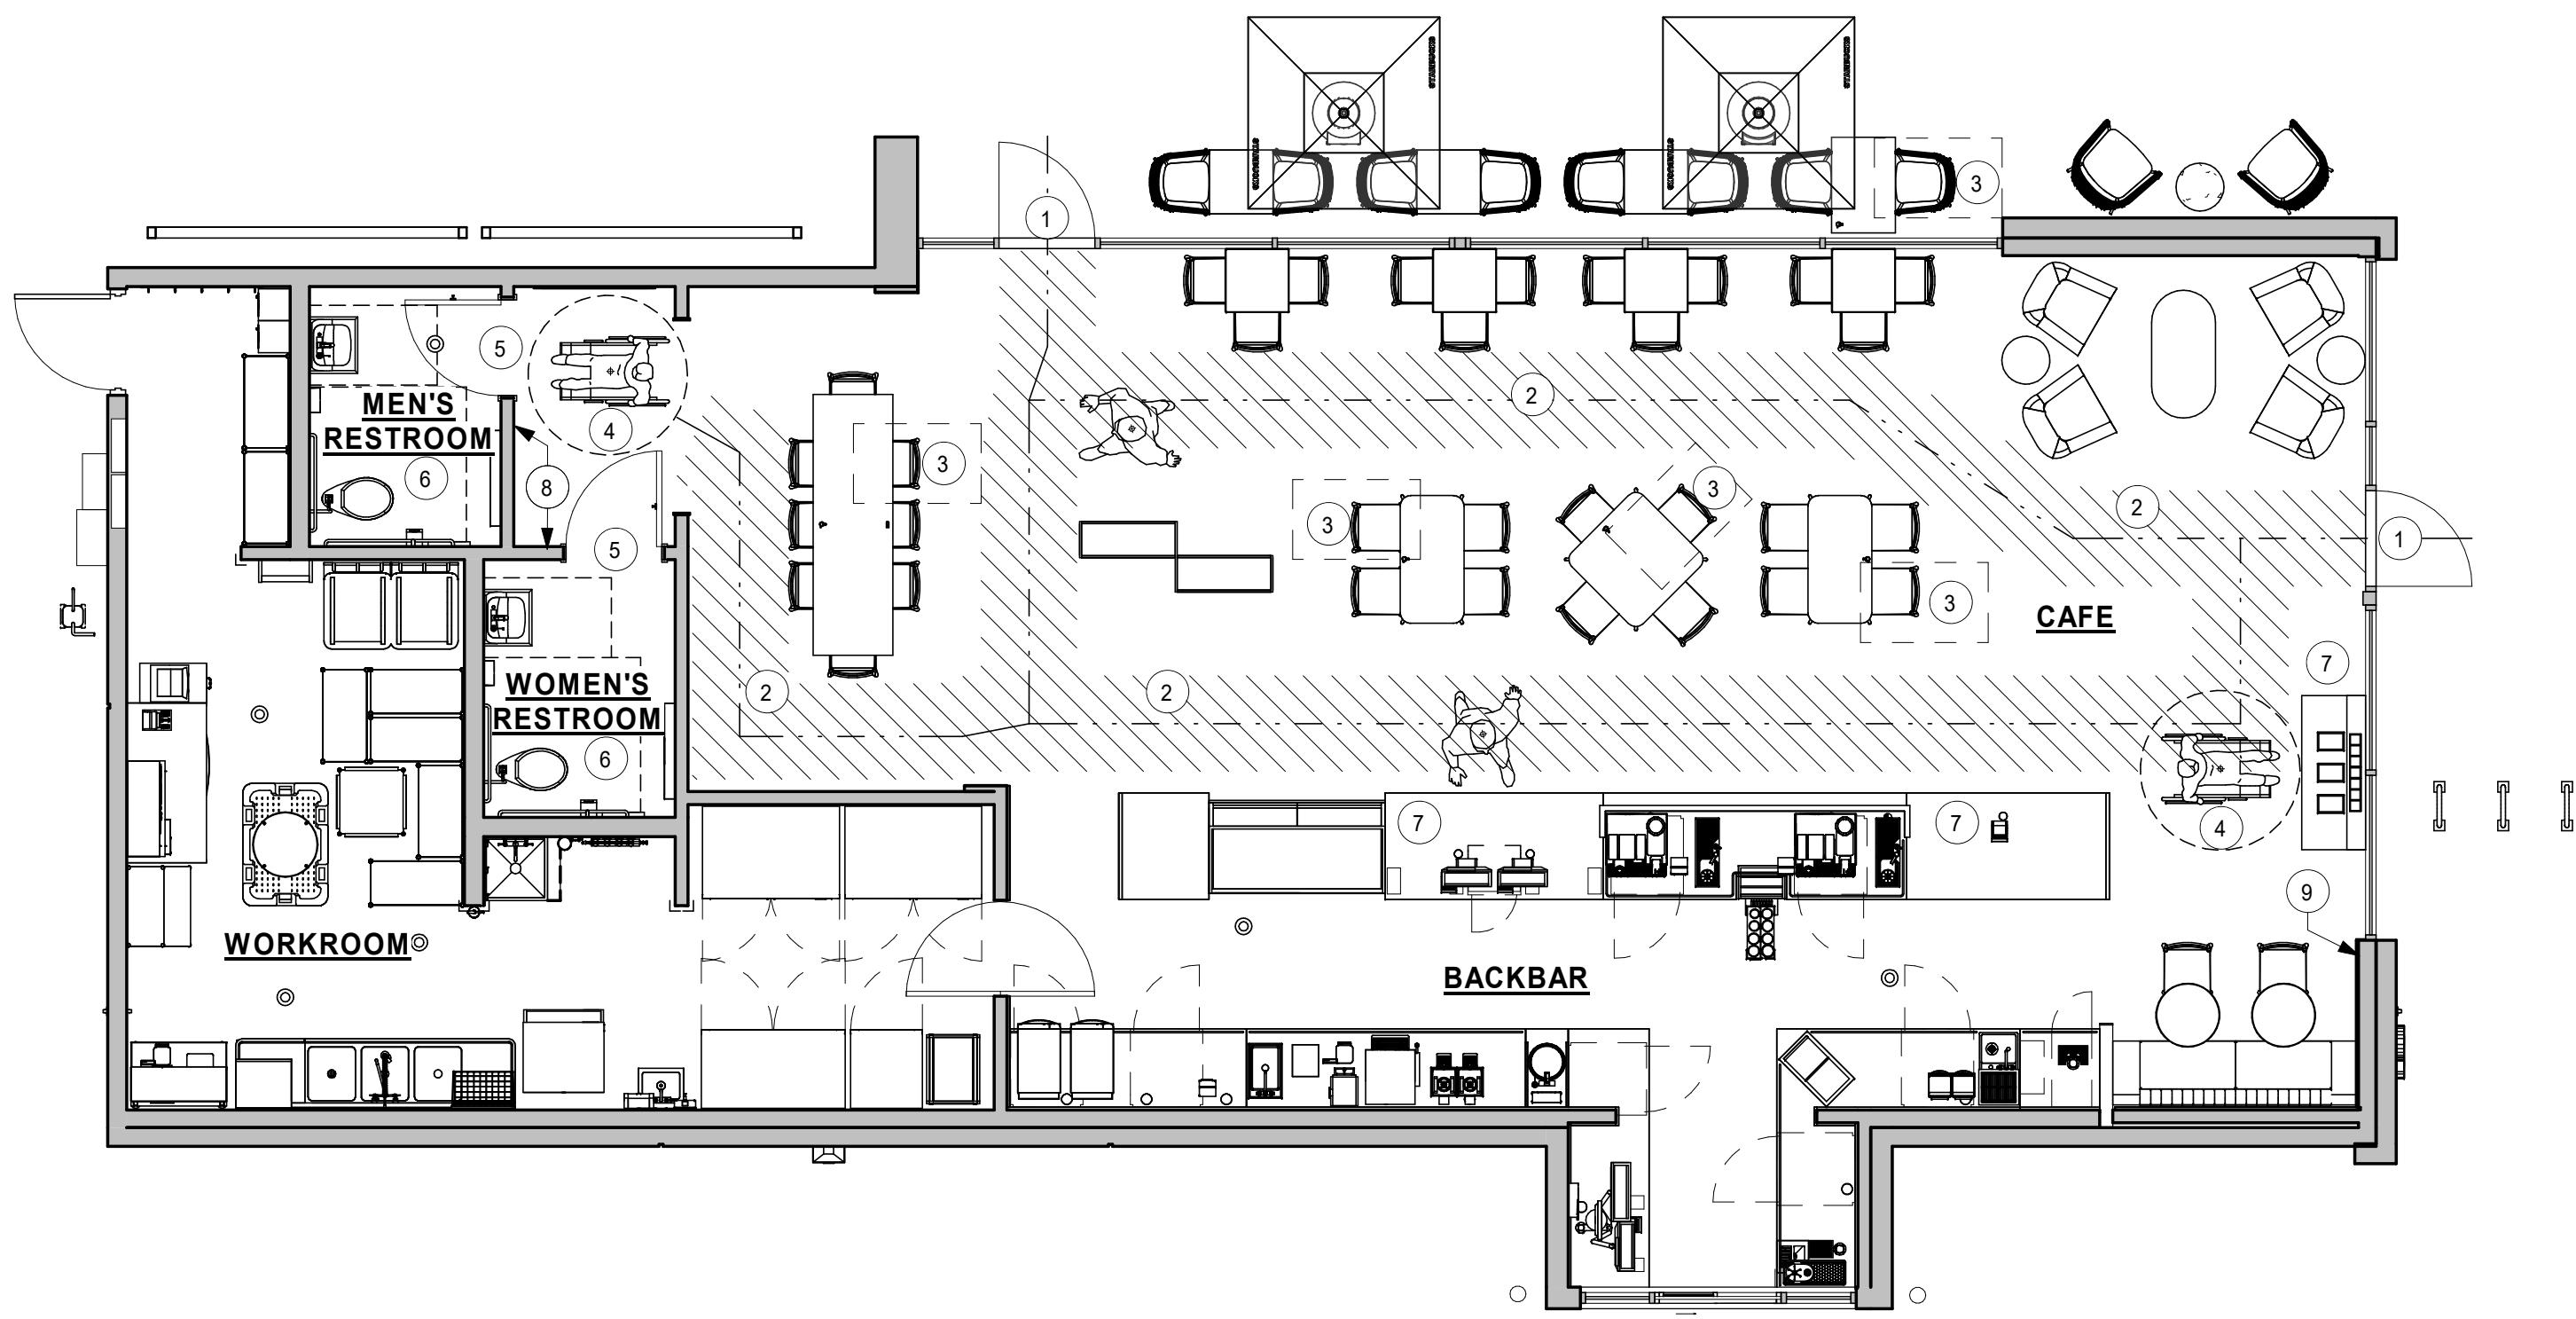

2 ACCESSIBILITY PLAN

Scale: 3/16" = 1'-0"

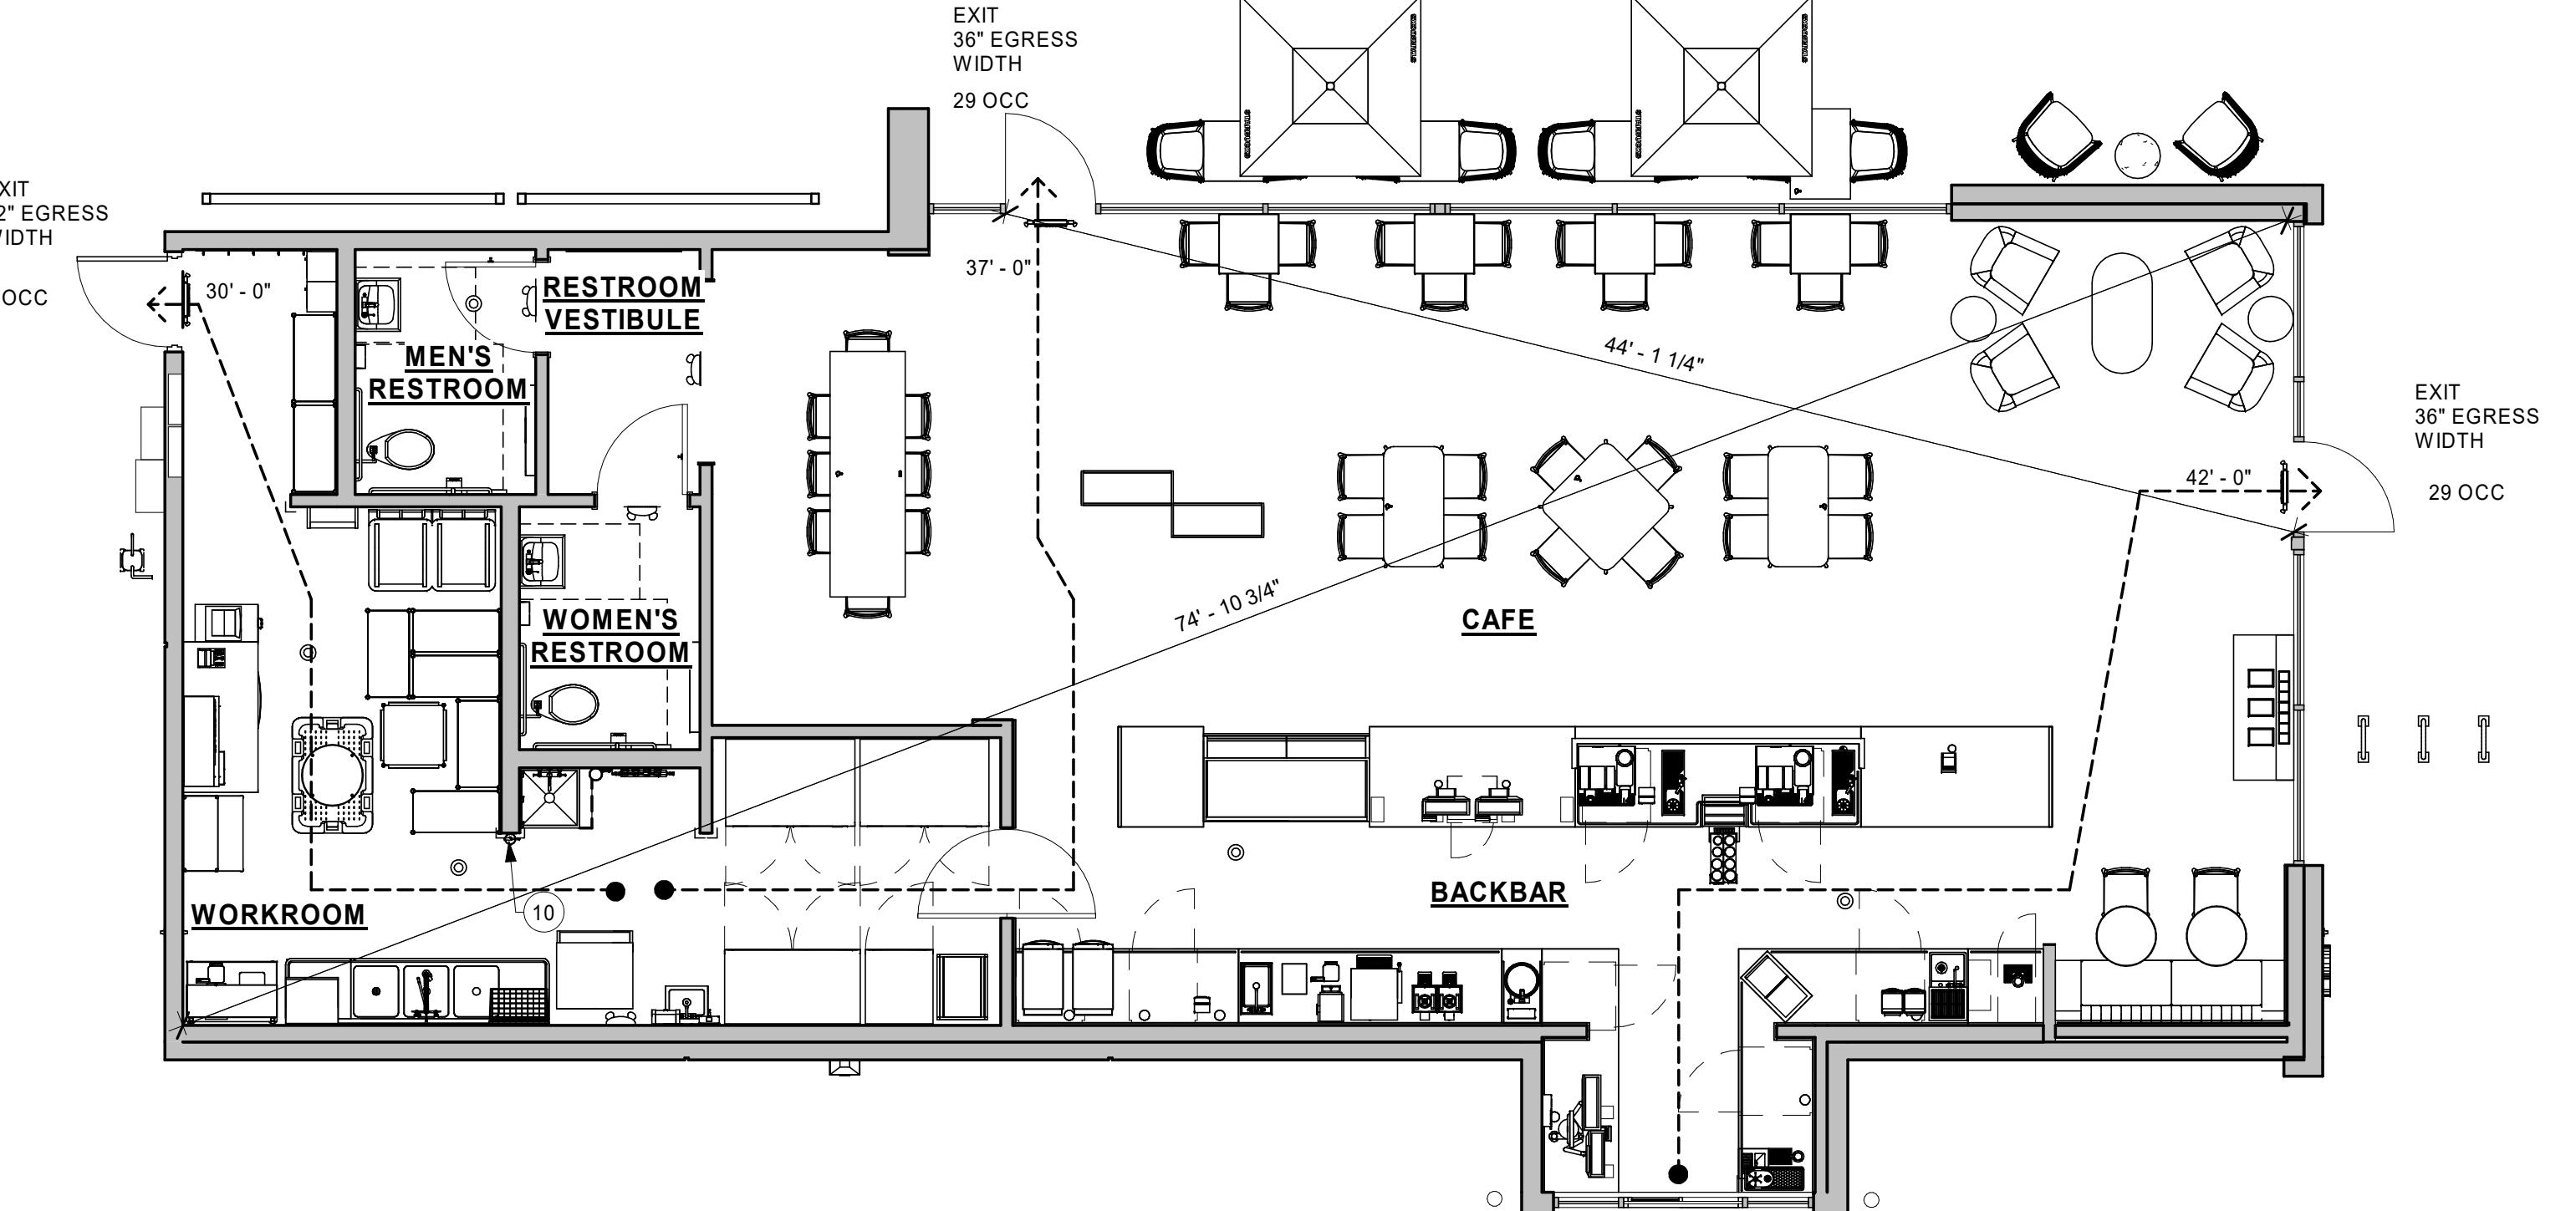

1 LIFE SAFETY PLAN

Scale: 3/16" = 1'-0"

KEYED NOTES

1. THRESHOLDS TO BE BARRIER FREE COMPLIANT PER ALL APPLICABLE CODES.
2. BARRIER-FREE PATH OF TRAVEL.
3. 30" (160 MM) X 48" (1220 MM) CLEAR FOR WHEELCHAIR ACCESS.
4. 60" (1525 MM) DIAMETER MINIMUM TURN RADIUS FOR WHEELCHAIR ACCESS.
5. 32" (815 MM) MINIMUM CLEAR AT RESTROOM DOOR.
6. SEE ENLARGED RESTROOM PLAN AND ELEVATIONS SHEET(S) FOR ADDITIONAL INFORMATION ON ACCESSIBLE RESTROOM CLEARANCES.
7. POS TRANSACTION PLANE, CONDIMENTS CART TOP AND HAND-OFF PLANE ARE 34 INCHES (860 MM) ABOVE THE FINISHED FLOOR FOR WHEELCHAIR ACCESSIBILITY.
8. PROVIDE BARRIER-FREE SIGNAGE AT ADA RESTROOMS PER ALL APPLICABLE CODES.
9. PROVIDE & POST OCCUPANT LOAD SIGNAGE, PER IBC 1004.3.
10. FIRE EXTINGUISHER LOCATION. G.C. TO CONFIRM LOCATION WITH INSPECTOR.

MEANS OF EGRESS NOTES

- A. EVERY ROOM OR SPACE THAT IS ASSEMBLY OCCUPANCY SHALL HAVE THE OCCUPANT LOAD OF THE ROOM OR SPACE POSTED IN A CONSPICUOUS PLACE, NEAR THE MAIN EXIT ACCESS DOORWAY. POSTED SIGNS SHALL BE OF AN APPROVED LEGIBLE PERMANENT DESIGN AND SHALL BE MAINTAINED BY THE OWNER AUTHORIZED AGENT. (1004.3)
- B. EGRESS SHALL NOT PASS THROUGH KITCHENS, STORAGE ROOMS, CLOSETS OR SIMILAR SPACES. (1014.2)

- C. PANIC AND FIRE EXIT HARDWARE, WHERE INSTALLED ON DOORS IN THIS BUILDING SHALL SATISFY THE FOLLOWING (1008.1.10):

- 1) THE ACTUATION PORTION OF THE RELEASING DEVICE SHALL EXTEND AT LEAST ONE-HALF OF THE DOOR LEAF WIDTH.
- 2) THE MAXIMUM UNLATCHING FORCE DOES NOT EXCEED 15 POUNDS (6.8 KG).
- 3) PIVOTED OR BALANCED DOORS SHALL BE OF THE PUSH-PAD TYPE WHERE PANIC HARDWARE IS REQUIRED AND THE PAD SHALL NOT EXTEND ACROSS MORE THAN ONE-HALF OF THE DOOR WIDTH, MEASURED FROM THE LATCH SIDE.
- 4) PANIC HARDWARE LISTED IN ACCORDANCE WITH UL 305.
- 5) FIRE EXIT HARDWARE LISTED IN ACCORDANCE WITH UL 10C AND UL 305.

- D. STRUCTURAL ELEMENTS, FIXTURES OR FURNISHINGS SHALL NOT PROJECT HORIZONTALLY FROM EITHER SIDE MORE THAN 4 INCHES (100 MM) OVER ANY WALKING SURFACE BETWEEN 27 INCHES (685 MM) AND 80 INCHES (2030 MM) ABOVE THE WALKING SURFACE. EXCEPTION: HANDRAILS SERVING STAIRS AND RAMPS ARE PERMITTED TO PROTRUDE 4 1/2 INCHES (115 MM) FROM THE WALL. (1003.3)

- E. THE PATH OF EGRESS TRAVEL EXITS AND WITHIN EXITS IN THIS BUILDING SHALL BE IDENTIFIED BY EXIT SIGNS CONFORMING TO THE REQUIREMENTS OF SECTION 1011 AND AS NOTED BELOW:

- 1) EXIT SIGNS SHALL BE READILY VISIBLE FROM ANY DIRECTION OF EGRESS TRAVEL.
- 2) EXIT SIGNS SHALL BE LOCATED AS NECESSARY TO CLEARLY INDICATE THE DIRECTION OF EGRESS TRAVEL.
- 3) NO POINT IN A CORRIDOR SHALL BE MORE THAN 100 FT (30.5 M) OR THE LISTED VIEWING DISTANCE FOR THE SIGN, WHICHEVER IS LESS, FROM THE NEAREST VISIBLE EXIT SIGN.

- F. WHERE KEY OPERATED LOCKING DEVICES ARE USED, POST A SIGN ON OR ADJACENT TO THE REQUIRED MAIN EXIT DOOR WITH 1 INCH (25 MM) LETTERING STATING THAT "THIS DOOR TO REMAIN UNLOCKED WHEN BUILDING IS OCCUPIED". (1008.1.9.3)

- G. EGRESS DOORS OR GATES SHALL BE OPENABLE FROM THE EGRESS SIDE WITHOUT THE USE OF A KEY, SPECIAL KNOWLEDGE OR EFFORT. DOOR HANDLES, PULLS, LATCHES, LOCKS AND OTHER OPERATING DEVICES SHALL BE INSTALLED 36 INCHES (960 MM) TO 48 INCHES (1220 MM) ABOVE THE FLOOR. MANUALLY OPERATED FLUSH BOLTS OR SURFACE BOLTS ARE NOT PERMITTED. ONE UNLATCHING OF ANY DOOR OR LEAF SHALL NOT REQUIRE MORE THAN ONE OPERATION. (1008.1.9)

- H. LANDINGS SHALL BE PROVIDED ON EACH SIDE OF DOORS AND SUCH LANDINGS SHALL BE AT THE SAME ELEVATION ON EACH SIDE OF THE DOOR. LANDINGS SHALL HAVE A WIDTH NOT LESS THAN THE WIDTH OF THE DOOR AND LENGTH MEASURED IN THE DIRECTION OF TRAVEL OF NOT LESS THAN 44 INCHES (1112 MM). (1008.1.5, 1008.1.6)

ROOM SCHEDULE

NAME	AREA
BACKBAR	376 SF
CAFE	967 SF
MEN'S RESTROOM	49 SF
RESTROOM VESTIBULE	44 SF
WOMEN'S RESTROOM	48 SF
WORKROOM	374 SF
GRAND TOTAL	1859 SF

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STARBUCKS TEMPLATE VERSION: i2019-10-25



520 SOUTH MAIN ST, SUITE 2531
AKRON, OH 44311
P: 330-572-2100 F: 330-572-2101

GPD PROJECT NO: 2019355.20

REGISTERED ARCHITECT
• MARK S. SALOPEK
AKRON, OH
NO. 6036
STATE OF OREGON 1/31/2020
Mark Salopek

LEGEND

- ↔ X-X' (XXMM) • TRAVEL DISTANCE
- ||||| BARRIER FREE PATH OF TRAVEL (MIN 3'-0" (915MM) - NO PINCH POINT)
- Emergency Light
- Exit Sign with Lighting
- Fire Extinguisher

PROJECT NAME:
HWY 101 - COOS BAY
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DESIGN MANAGER: RYAN WONG
PRODUCTION DESIGNER: GPD
CHECKED BY: TC

Revision Schedule			
Rev	Date	By	Description

SHEET TITLE:
**LIFE SAFETY AND
ACCESSIBILITY PLAN**
SCALE: AS SHOWN
SHEET NUMBER:
G003



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 COOS BAY, OR 97420

STORE #: 60983
 PROJECT #: 84073-001
 ISSUE DATE: 01-29-20 - 100 percent
 DESIGN MANAGER: RYAN WONG
 PRODUCTION DESIGNER: GPD
 CHECKED BY: TC

Revision Schedule


Rev	Date	By	Description

SHEET TITLE:
HEALTH DEPARTMENT PLAN
 SCALE: AS SHOWN
 SHEET NUMBER:
 G004

SPECIALTY EQUIPMENT SCHEDULE - "E" (HEALTH DEPT)			
DESIGN ID	COUNT	DESCRIPTION	COMMENTS
20178	27	ACOUSTIC CEILING PANEL	TECTUM DIRECT ATTACHED CEILING PANEL. MOUNTED BETWEEN TRUSSES. 8175110 BY ARMSTRONG. GC TO FIELD PAINT SW9140 BLUSTERY SKY
X5001	7	METAL WALL CAP (MT0011)	
COOLING			
10267	5	FRIDGE UNDERCOUNTER 1 DOOR - 27IN 685MM	
11083	2	FRIDGE REACH IN 2 DOOR - 51X35IN 1295X890MM	
12618	2	FRIDGE UNDERCOUNTER 1 DOOR WITH SHELF - 27IN 685MM	
13620	1	FREEZER REACH IN 1 DOOR LH - 27IN 685MM	
13682	1	FREEZER REACH IN 2 DOOR - 54IN 1370MM	
20010	1	FRIDGE NITRO 2 TAP JT NITCOM LH	KIT INCLUDES UNDERCOUNTER FRIDGE, FONT, TRAY, AND TUBING
EQUIPMENT			
10312	2	BREWER SOFT HEAT WARMING STAND SINGLE	
10746	1	BREWER DUAL SOFT HEAT	
10808	2	GRINDER DITTING KR1203	
10856	4	BREWER SERVER SOFT HEAT	
10907	1	DISHWASHER LEGS AND SKIRT	
12407	2	OVEN TURBOCHEF NEXT GENERATION	
12508	2	BLENDER QUIET MODEL ON COUNTER	
15186	1	DISHWASHER HOT LOW STEAM	
16623	2	SCALE DIGITAL WITH ADJUSTABLE DISPLAY MOUNT SMALL	
17564	1	BLENDER PITCHER RINSER WITH SENSOR	
19559	1	NITROGEN GENERATOR ELEMENT	
19742	2	ESPRESSO MACHINE MASTRENA II	
FOOD CASE			
16238	1	FOOD CASE - ZEPHYR - 66IN 1675MM	
ICE			

SPECIALTY EQUIPMENT SCHEDULE - "E" (HEALTH DEPT)			
DESIGN ID	COUNT	DESCRIPTION	COMMENTS
10102	1	ICE - BIN B55	TECTUM DIRECT ATTACHED CEILING PANEL ICE - MACHINE ICE1506HR REMOTE COOLED
10229	1	ICE - BIN DROP IN 90LB 40KG	
10344	1	ICE - BIN DROP IN 45LB 20KG HORIZONTAL	
19278	1	ICE - BIN DROP IN 45LB 20KG HORIZONTAL	
OTHER			
10091	1	CUP DISPENSER TALL HOT VERTICAL	
10099	2	RESTROOM TOILET PAPER HOLDER	
10172	2	RESTROOM SEAT COVER DISPENSER	
10179	2	HAND DRYER SURFACE MOUNTED	
10384	2	DIAPER CHANGING STATION HORIZONTAL	
10396	1	CUP DISPENSER SHORT HOT VERTICAL	
10467	1	FILE CABINET 2 DRAWER	
10501	1	FIRE EXTINGUISHER	
10769	2	RESTROOM GRAB BAR VERTICAL - 18IN 455MM	
10791	2	CUP DISPENSER GRANDE VENTI COLD VERTICAL	
10829	5	CORNER GUARD - 1.25IN 30MM - PEWTER	BOH ONLY
10855	2	CUP DISPENSER GRANDE VENTI HOT VERTICAL	
10858	1	CUP DISPENSER TALL COLD VERTICAL	
10859	2	RESTROOM GRAB BAR - 48IN 1220MM	
10862	2	RESTROOM GRAB BAR - 36IN 915MM	
10947	1	SOAP DISPENSER WALL MOUNTED	
10977	1	PAPER TOWEL DISPENSER FULL SIZE - TRANSLUCENT GRAY	
10992	1	PAPER TOWEL DISPENSER HALF SIZE - TRANSLUCENT GRAY	
11115	3	SOAP DISPENSER SINK MOUNTED	
13330	1	MOBILE CUP DISPENSER CADDY	
13584	1	CUP DISPENSER TRENTA COLD VERTICAL	
19495	1	NITRO 2 TAP HANDLE AND BADGE KIT	
20079	1	NITRO 2 TAP BADGE MOUNT BACKBAR LH	
20080	1	NITRO 2 TAP BADGE MOUNT BACKBAR RH	
X07403	1	ROOF ACCESS LADDER	
STORAGE			
10222	1	WIRE SHELF GRID AT SINK	
10416	7	WORKROOM SHELVING - 36IN 915MM	
10462	7	WORKROOM SHELVING POSTS	
10698	1	MOP RACK WITH 3 HOLDERS	
13578	1	DISHWARE DRYING RACK - 21IN 535MM	
15699	1	PARTNER WORK CENTER	
17264	1	ROLLING PASTRY TRAY THAW RACK - 20X26IN 510X60MM	
17639	1	WORKROOM CART - 24IN 610MM	
19476	2	5 COMP LOCKER - 12IN 305MM	
FILTER			

PLUMBING FIXTURE SCHEDULE - "P" (HEALTH DEPT)			
DESIGN ID	COUNT	DESCRIPTION	COMMENTS
X0101	6	FLOOR CLEANOUT	ZURN ZN1400, ADJUSTABLE FLOOR CLEANOUT, NICKEL BRONZE FRAME AND COVER.
X0102	2	FLOOR DRAIN	ZURN FD2209, ADJUSTABLE FLOOR DRAIN, 3" HUB OUTLET, NICKLE BRONZE TOP.
X0103	1	GREASE INTERCEPTOR 75 GPM	SCHIER MODEL GB-75, 75 GPM, 125 GAL LIQUID CAPACITY
X0104	1	RECIRCULATING PUMP	BELL AND GOSET MODEL NBF-18S, 120V, 100 WATT, WITH AQUASTAT
OTHER			
13384	1	WATER HEATER 55GAL GAS	AQ SMITH MODEL BT-60, 55 GALLON, 58 GHP @ 100°F RISE, 60 MBH INPUT, UEF=.62
SINK			
10116	2	SINK - RESTROOM WALL MOUNTED	
10549	1	SINK - RINSE DROP IN SST - 12X20IN 305X510MM	
10995	1	SINK - MOP - 24X24IN 610X610MM	
13700	1	SINK - 3 COMP WORK SST - 105IN 2665MM	
14688	1	SINK - HAND WITH SIDE SPLASH WALL MOUNTED SST	
17565	1	SINK - RINSE WITH DRAINBOARD - 15X27IN 380X685MM	
17632	1	SINK - STACKED DRAINBOARD - 15IN 380MM	
17650	1	SINK - DRAIN TRAY - 9X6IN 230X150MM	
18743	1	SINK - WATER FILLING STATION - 36X24IN 915X610MM	
19277	2	SINK - COUNTERTOP RINSER WITH DRAIN TROUGH - 26X9IN 660X235MM	
TOILET			
12951	2	TOILET - TANKLESS EFFICIENT SINGLE FLUSH	SLOAN MODEL ST-2020-1.28 ADA COMPLIANT, VITEROUS CHINA
			WATER CLOSET, WHITE, PROVIDE WITH CHURCH COMMERCIAL 295CT SEAT
13040	2	TOILET - FLUSH VALVE AUTOMATIC EFFICIENT SINGLE FLUSH	SLOAN MODEL 8111.12 OPTIMA SYSTEMS BATTERY POWERED FLUSHOMETERS

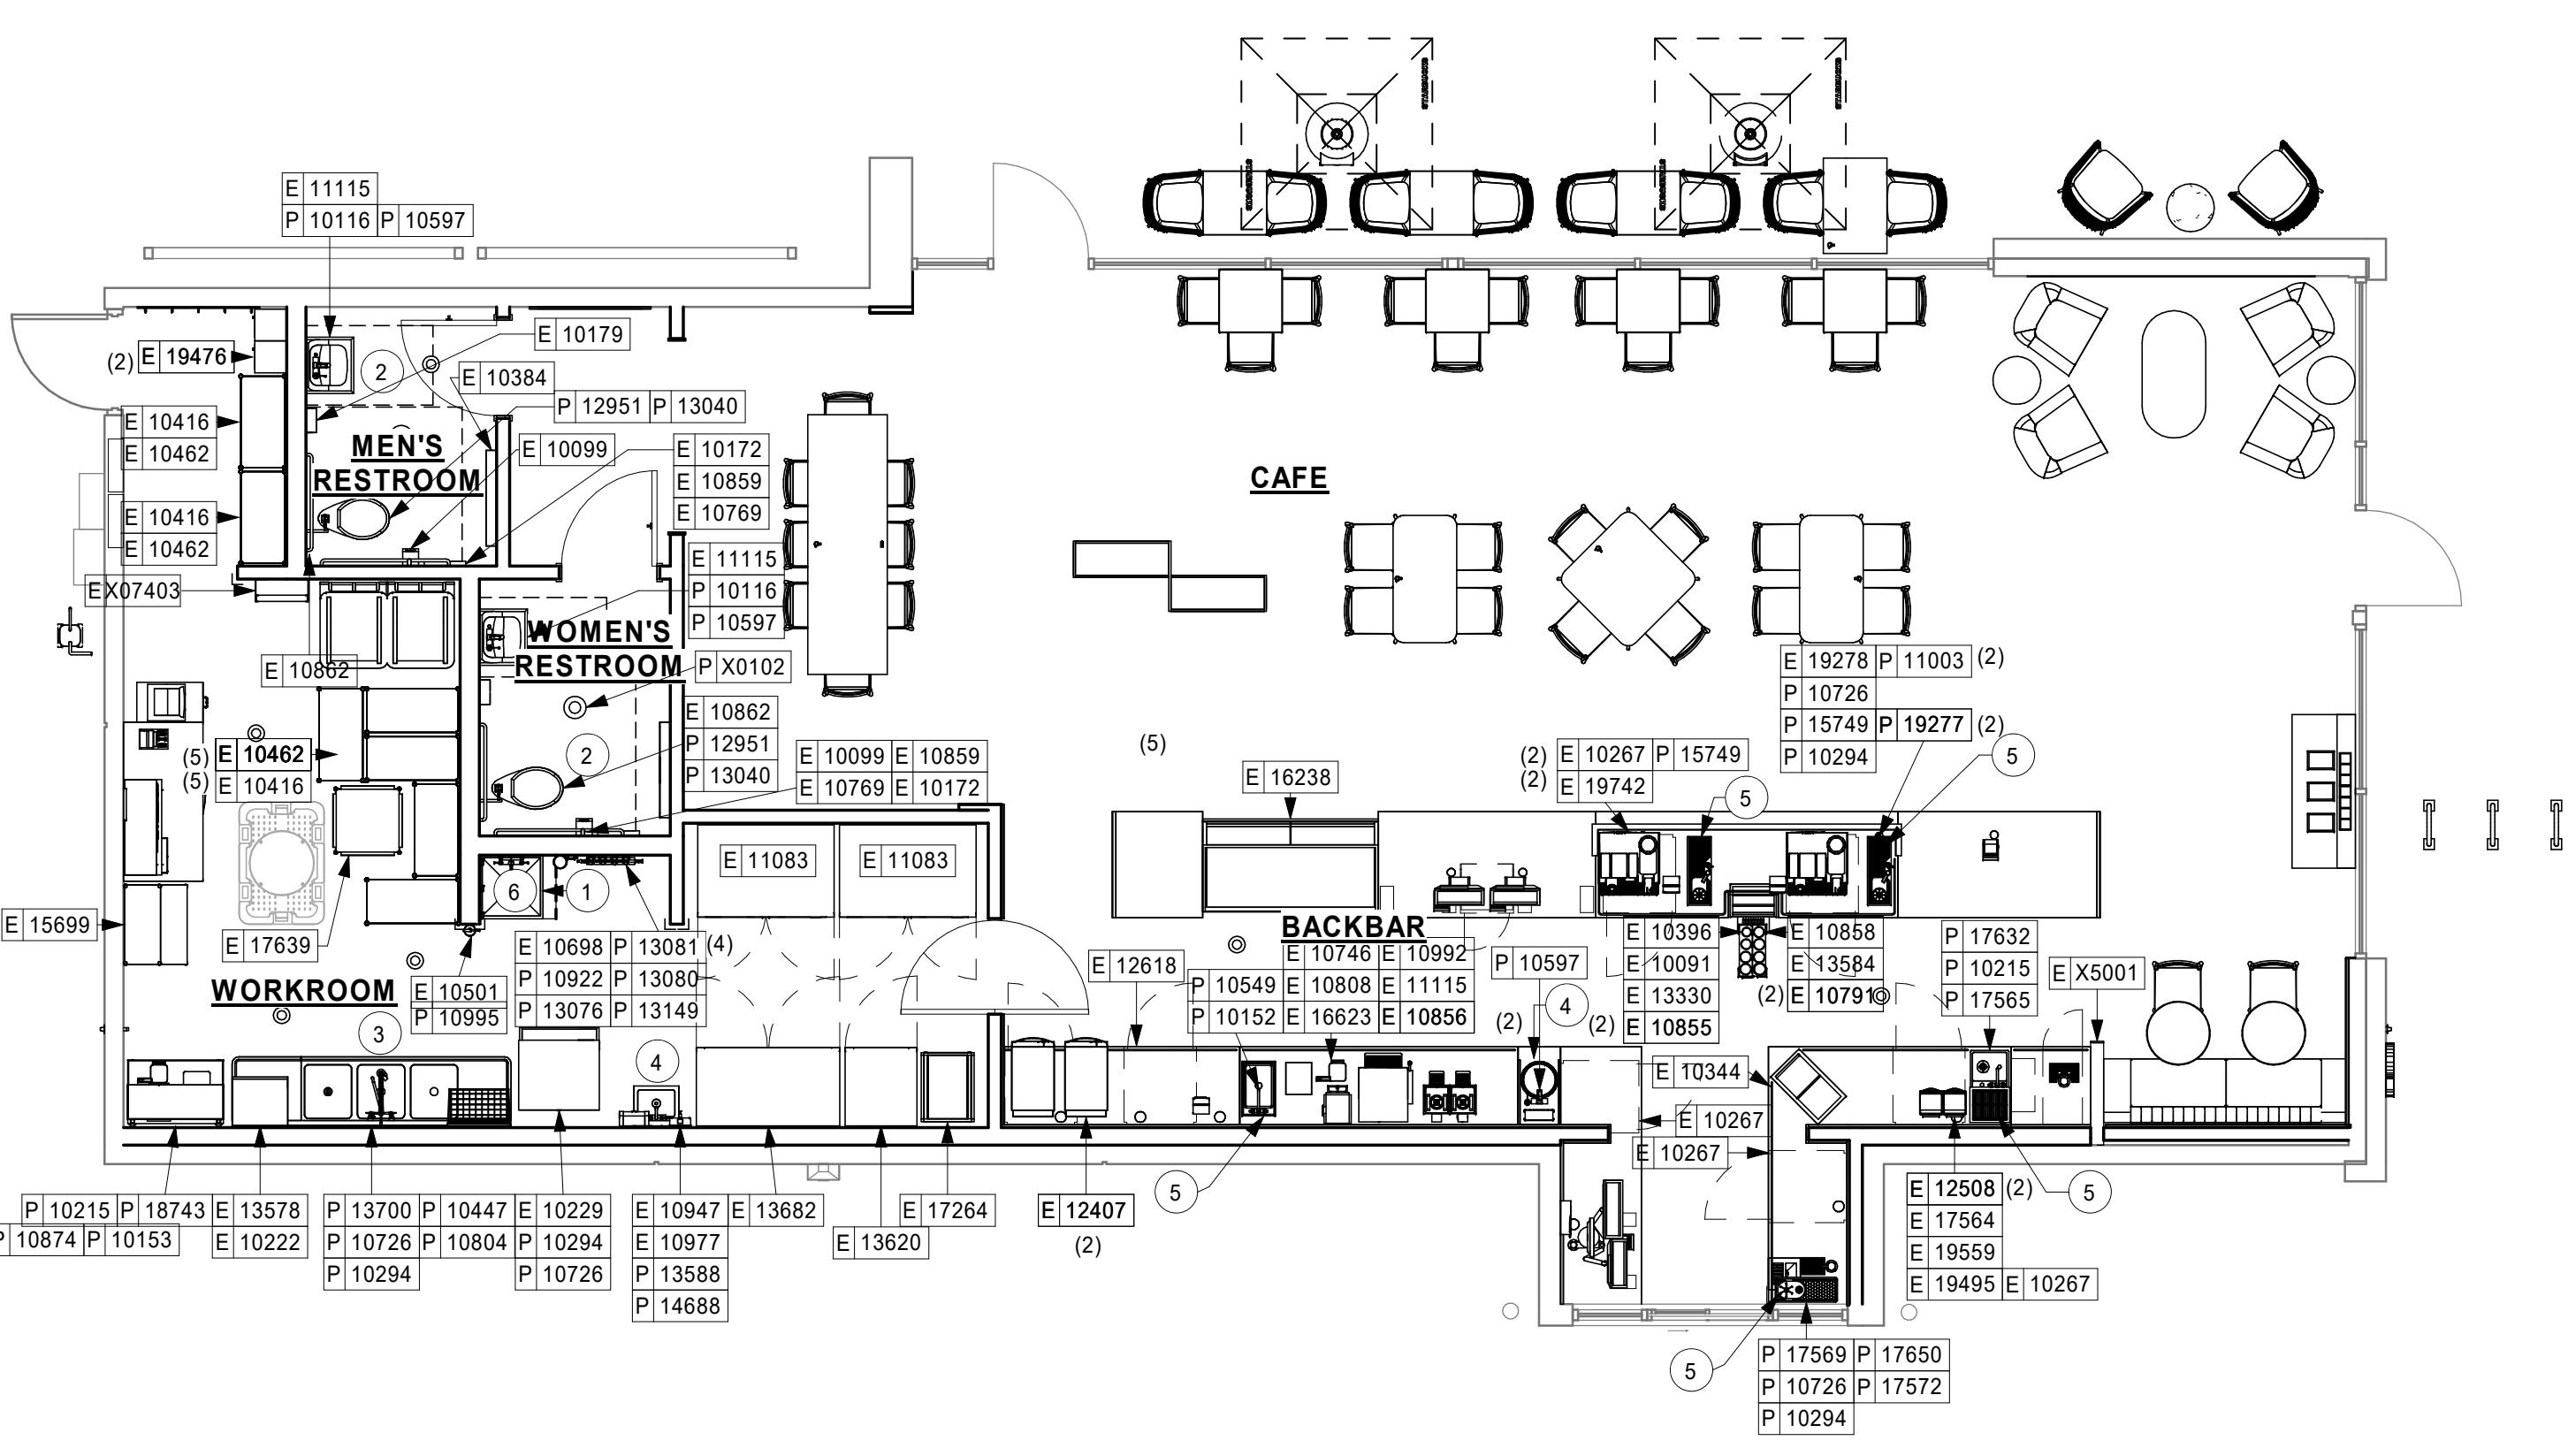

1 HEALTH DEPARTMENT PLAN

Scale: 3/16" = 1'-0"

HEALTH DEPT. FINISH SCHEDULE

BAR:

FLOOR: SEALED CONCRETE
 WALL: LAMINATE, WOOD CLADDING, BACKSPLASH, WITH 6" COVED TILE BASE
 CEILING: GYPSUM SOFFIT

CAFE:

FLOOR: SEALED CONCRETE WITH WALK OFF MATS
 WALL: STOREFRONT, WALL COVERING, PAINTED GYPSUM WALL BOARD WITH 6" COVED TILE BASE
 CEILING: GYPSUM SOFFIT & EXPOSED STRUCTURE

WORKROOM:

FLOOR: POLYVINYL FLOOR TILE - ECO-GRIP
 WALL: FRP WITH 6" COVED TILE BASE
 CEILING: ACOUSTICAL TILE CEILING

RESTROOMS:

FLOOR: SEALED CONCRETE
 WALL: WALL TILE
 CEILING: GYPSUM CEILING

HEALTH DEPT. PLAN NOTES

A. GENERAL CONTRACTOR TO SCHEDULE WITH LOCAL REFRIGERATION CONTRACTOR TO CONDUCT INITIAL FOOD CASE START-UP AND TESTING. FOR APPROVED CONTRACTOR, CONTACT VENDOR.

B. THE SPACE IS SERVED BY THE MUNICIPAL WATER AND SEWER SYSTEM UNLESS OTHERWISE NOTED.

C. ALL EQUIPMENT AND INSTALLATION WILL MEET NATIONAL SANITATION FOUNDATION STANDARDS OR EQUIVALENT.

D. EQUIPMENT UNITS SHALL CONTAIN NO EXPOSED THREADS, EMBELLISHMENTS OR OVERHANGING EDGES THAT SERVE AS PLACES FOR ACCUMULATION OF DUST, DIRT OR DEBRIS.


E. WARMING OVEN(S) SHOWN FOR PERMITTING PURPOSES. INSTALLATION AT STORE OPENING TO BE VERIFIED BY STARBUCKS CONSTRUCTION REPRESENTATIVE.

F. EACH HAND WASHING SINK WILL HAVE A SINGLE SERVICE TOWEL AND SOAP DISPENSER, AND ALL HAND SINKS TO HAVE A COMBINATION FAUCET OR PREMIXING FAUCET.

G. SEE SHEETS I-6001 & I-6002 FOR SCHEDULES.

SHEET NOTES

- WATER HEATER ON SHELF ABOVE.
- ADA COMPLIANT RESTROOM AND ACCESSORIES
- 3-COMP SINK.
- HAND SINK.
- WORK SINK.
- MOP SINK.

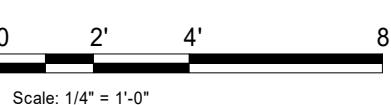

N

0 2' 4' 8'

Scale: 1/4" = 1'-0"


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HWY 101 (OREGON COAST HIGHWAY)

1 1ST FLOOR - SITE PLAN

Scale: 1/16" = 1'-0"

KEYED NOTES

1. STARBUCKS PATIO / SEATING AREA.
2. HATCH INDICATES STARBUCKS TENANT SPACE.
3. SIDEWALKS, BY LL, ENSURE ACCESSIBLE PATH OF TRAVEL TO ENTRY.
4. MINIMUM 12'-0" WIDE 6" THICK INTEGRAL BLACK REINFORCED CONCRETE (6X6 10/10 WWF) DRIVE-THRU LANE WITH 6" CURB. EXTEND 12' BEYOND CENTERLINE OF DT WINDOW AND 12' BEFORE ORDER POINT. (BY LL)
5. TRASH ENCLOSURE, BY LL.
6. LANDSCAPE AREA, BY LL.
7. CROSSROAD SAFETY STRIPING ON PAVEMENT BY LL.
8. CANOPY ABOVE, BY LL.
9. HOSE BIBB (BY LL). LOCATION PER SHELL DRAWINGS, SEE SHELL DRAWINGS FOR ADDITIONAL INFORMATION.
10. NON-ILLUMINATED BOLLARD AND FOOTING, BY LL.
11. STARBUCKS DRIVE-THRU EQUIPMENT. ASSOCIATED FOUNDATION AND ELECTRICAL CONDUIT WITH PULL STRINGS BY LL. SEE STRUCTURAL AND ELECTRICAL DRAWINGS FOR ADDITIONAL INFORMATION.
12. OUTLINE OF CANOPY ABOVE DRIVE-THRU WINDOW, BY LL.
13. SITE DIRECTIONAL SIGNAGE LOCATION, ASSOCIATED FOOTING AND ELECTRICAL CONDUIT WITH PULL STRINGS BY LL. SEE ELECTRICAL DRAWINGS.
14. ACCESSIBLE PARKING SPACES, BY LL.
15. DT CLEARANCE BAR LOCATION. ASSOCIATED FOOTING BY LL.
16. DT DETECTOR LOOP AT ORDER POINT AND DT WINDOW, BY LL. SEE ELECTRICAL FOR MORE INFORMATION.
17. HOOP BIKE RACK, BY LL. SEE SHELL BUILDING CONSTRUCTION DRAWINGS FOR DETAILS.
18. UMBRELLA AND BASE.
19. DRIVE-THRU WINDOW WITH AIR CURTAIN, BY LL.
20. DRIVE-THRU LANE ENTRY/EXIT THERMOGRAPHIC BY GC.
21. SITE BOLLARD BY LL.

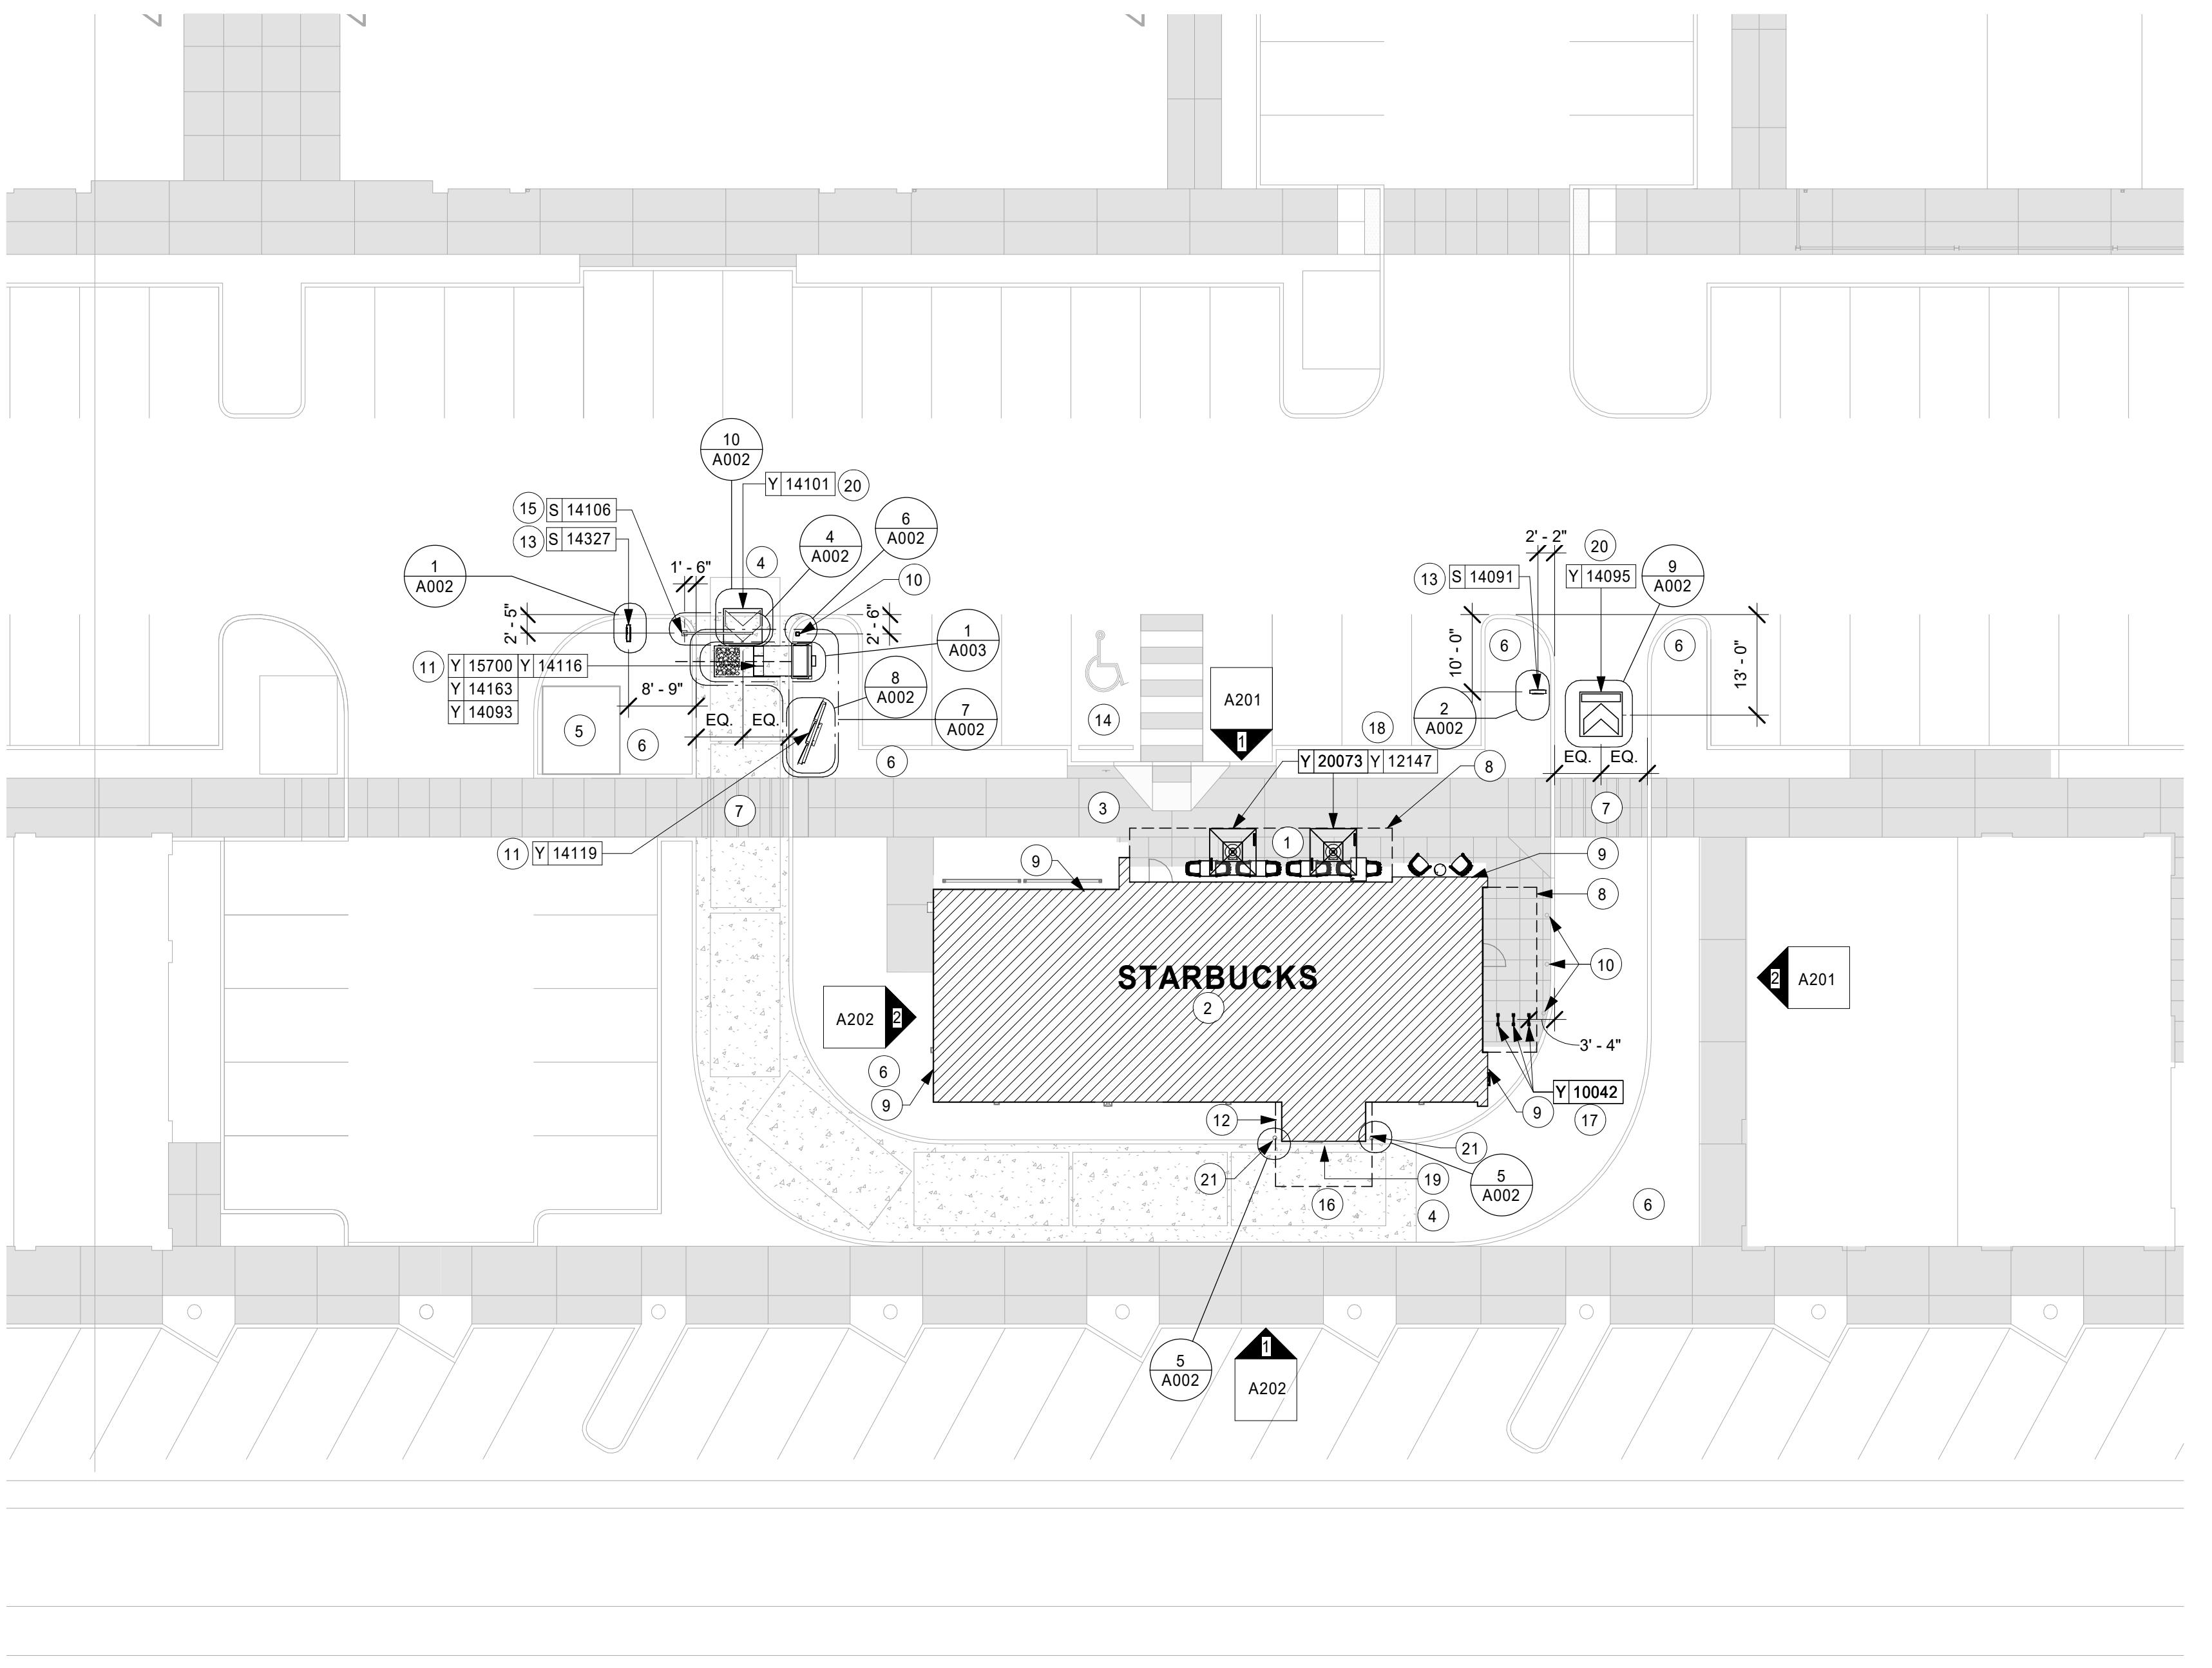GENERAL NOTES

- A. REFER TO EXTERIOR ELEVATIONS ON SHEET A201 FOR BUILDING SIGNAGE LOCATION AND DESIGN ID. REFER TO ELECTRICAL PLANS FOR ELECTRICAL REQUIREMENTS.
- B. LANDSCAPING TO BE PROVIDED PER ZONING CODE AND SUSTAINABILITY REQUIREMENTS.
- C. DRIVE-THRU EQUIPMENT INCLUDING VEHICLE DETECTION LOOP, WIRELESS COMMUNICATION AND MONITORS SHALL BE COORDINATED BY STARBUCKS CONSTRUCTION MANAGER. REFER TO ELECTRICAL DRAWINGS FOR ADDITIONAL REQUIREMENTS.
- D. PROVIDE 6" (150MM) THICK CONCRETE PAVING THE LENGTH OF THE DRIVE-THRU LANE, EXTENT TO INCLUDE DRIVE-THRU ENTRY POINT THROUGH WINDOW STANDING PAD.
- E. GENERAL CONTRACTOR TO APPLY CONCRETE SEALER TO ALL EXTERIOR CONCRETE PATIO AND WALKWAY SURFACES.
- F. GENERAL CONTRACTOR TO VERIFY ALL EXISTING ELEVATIONS AND BUILDING CONDITIONS IN FIELD PRIOR TO START OF CONSTRUCTION.
- G. PROVIDE DETECTABLE WARNING (IF APPLICABLE PER LOCAL CODE) AT TRANSITION FROM SIDEWALK TO DRIVE AISLE.
- H. ACCESSIBLE PARKING SPACES AND ACCESS AISLES SHALL HAVE SURFACE SLOPE NOT TO EXCEED 2% IN ALL DIRECTIONS.
- I. REFER TO ELECTRICAL DRAWINGS FOR SITE RELATED ELECTRICAL WORK.
- J. SCRABE AND REPATN ALL EXISTING PAINTED SITE FEATURES, INCLUDING, BUT NOT LIMITED TO CURBS, BOLLARDS, RAILINGS AND SITE LIGHTING BASES.
- K. SEE SHEET A002 FOR ARCHITECTURAL SITE DETAILS.

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STARBUCKS TEMPLATE VERSION: i2019-10-25



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GPD PROJECT NO: 2019355.20

REGISTERED ARCHITECT
MARK S. SALOPEK
AKRON, OH
NO. 6036
STATE OF OREGON 1/31/2020
Mark Salopek

PROJECT NAME:
HWY 101 - COOS BAY

PROJECT ADDRESS:
101, COOS BAY VILLAGE
COOS BAY, OR 97420

STORE #: 60983
PROJECT #: 84073-001
ISSUE DATE: 01-29-20 - 100 percent
DESIGN MANAGER: RYAN WONG
PRODUCTION DESIGNER: GPD
CHECKED BY: TC

Revision Schedule

Rev	Date	By	Description



Scale: 1/16" = 1'-0"



SHEET TITLE:
**ARCHITECTURAL SITE
PLAN**
SCALE: AS SHOWN

SHEET NUMBER:
A001



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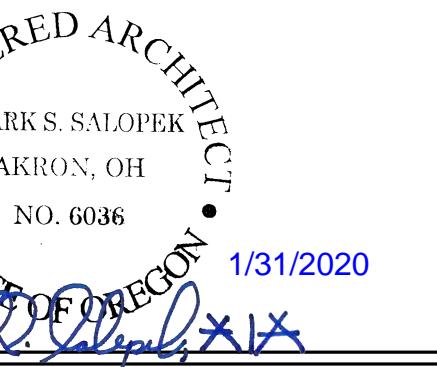
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STATE OF OREGON 1/31/2020

PROJECT NAME:
Hwy 101 - COOS BAY

PROJECT ADDRESS:
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STORE #: 60983
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Revision Schedule			
Rev	Date	By	Description

SHEET TITLE:
**BUILDING FLOOR
PENETRATION PLAN**

SCALE: AS SHOWN

SHEET NUMBER:

A102

KEYED NOTES



1. FLOOR SINK LOCATION, TYP. SEE SHEET P101.
2. ELECTRICAL STUB-UP LOCATION. SEE SHEET E101.
3. PLUMBING STUB-UP LOCATION. SEE SHEET P101.
4. WASTE DRAIN FOR MOP SINK.
5. WASTE DRAIN FOR TOILET.
6. LOCATION OF ELECTRICAL PANELS, SEE ELECTRICAL FOR ADDITIONAL INFORMATION.
7. FLOOR ELECTRICAL OUTLET, SEE ELECTRICAL FOR ADDITIONAL INFORMATION.
8. FLOOR CLEANOUT, SEE PLUMBING FOR ADDITIONAL INFORMATION.
9. DATUM POINT FOR ENGINE LAYOUT.
10. DATUM POINT FOR BOH AND RESTROOMS LAYOUT.
11. FLOOR DRAIN, SEE PLUMBING FOR ADDITIONAL INFORMATION.
12. GREASE INTERCEPTOR, SEE PLUMBING FOR ADDITIONAL INFORMATION.
13. OUTLINE OF RECESSED WALK-OFF MAT.
14. ELECTRICAL FLOOR PENETRATION. SEE SHEET E101

GENERAL NOTES


- A. ALL STUB-UP DIMENSIONS ARE RELATIVE TO FINISHED WALL LOCATIONS (SHOWN AS OUTLINES ON THIS PLAN). REFER TO FLOOR PLAN FOR WALL PLACEMENT.
- B. FLOOR SINK: REFER TO CUT SHEETS FOR COMPONENT SPECIFICATIONS AND CUTOUT REQUIREMENTS.
- C. WASTE LINE PENETRATIONS: REFER TO PLUMBING PLANS FOR INDIVIDUAL LINE LOCATIONS.
- D. STUB-UP PENETRATIONS: REFER TO ELECTRICAL AND PLUMBING PLANS FOR INDIVIDUAL STUB-UP LOCATIONS.
- E. TOILET FLOOR PENETRATION: REFER TO CUT SHEETS FOR STUB-UP LOCATION RELATIVE TO FINISHED WALL.
- F. PENETRATION TO BE LOCATED ON CENTERLINE OF WALL OR AS REQUIRED PER CONDITIONS.
- G. TRENCHING OUTLINE FOR GUIDELINE USE ONLY. GENERAL CONTRACTOR TO COORDINATE WITH SPECIFIC TRADES AND SITE CONDITIONS TO DETERMINE ACTUAL LAYOUT.
- H. REFER TO SHEET I101 FOR FLOOR FINISHES.

LEGEND

- EXISTING WALL
- DATUM POINT

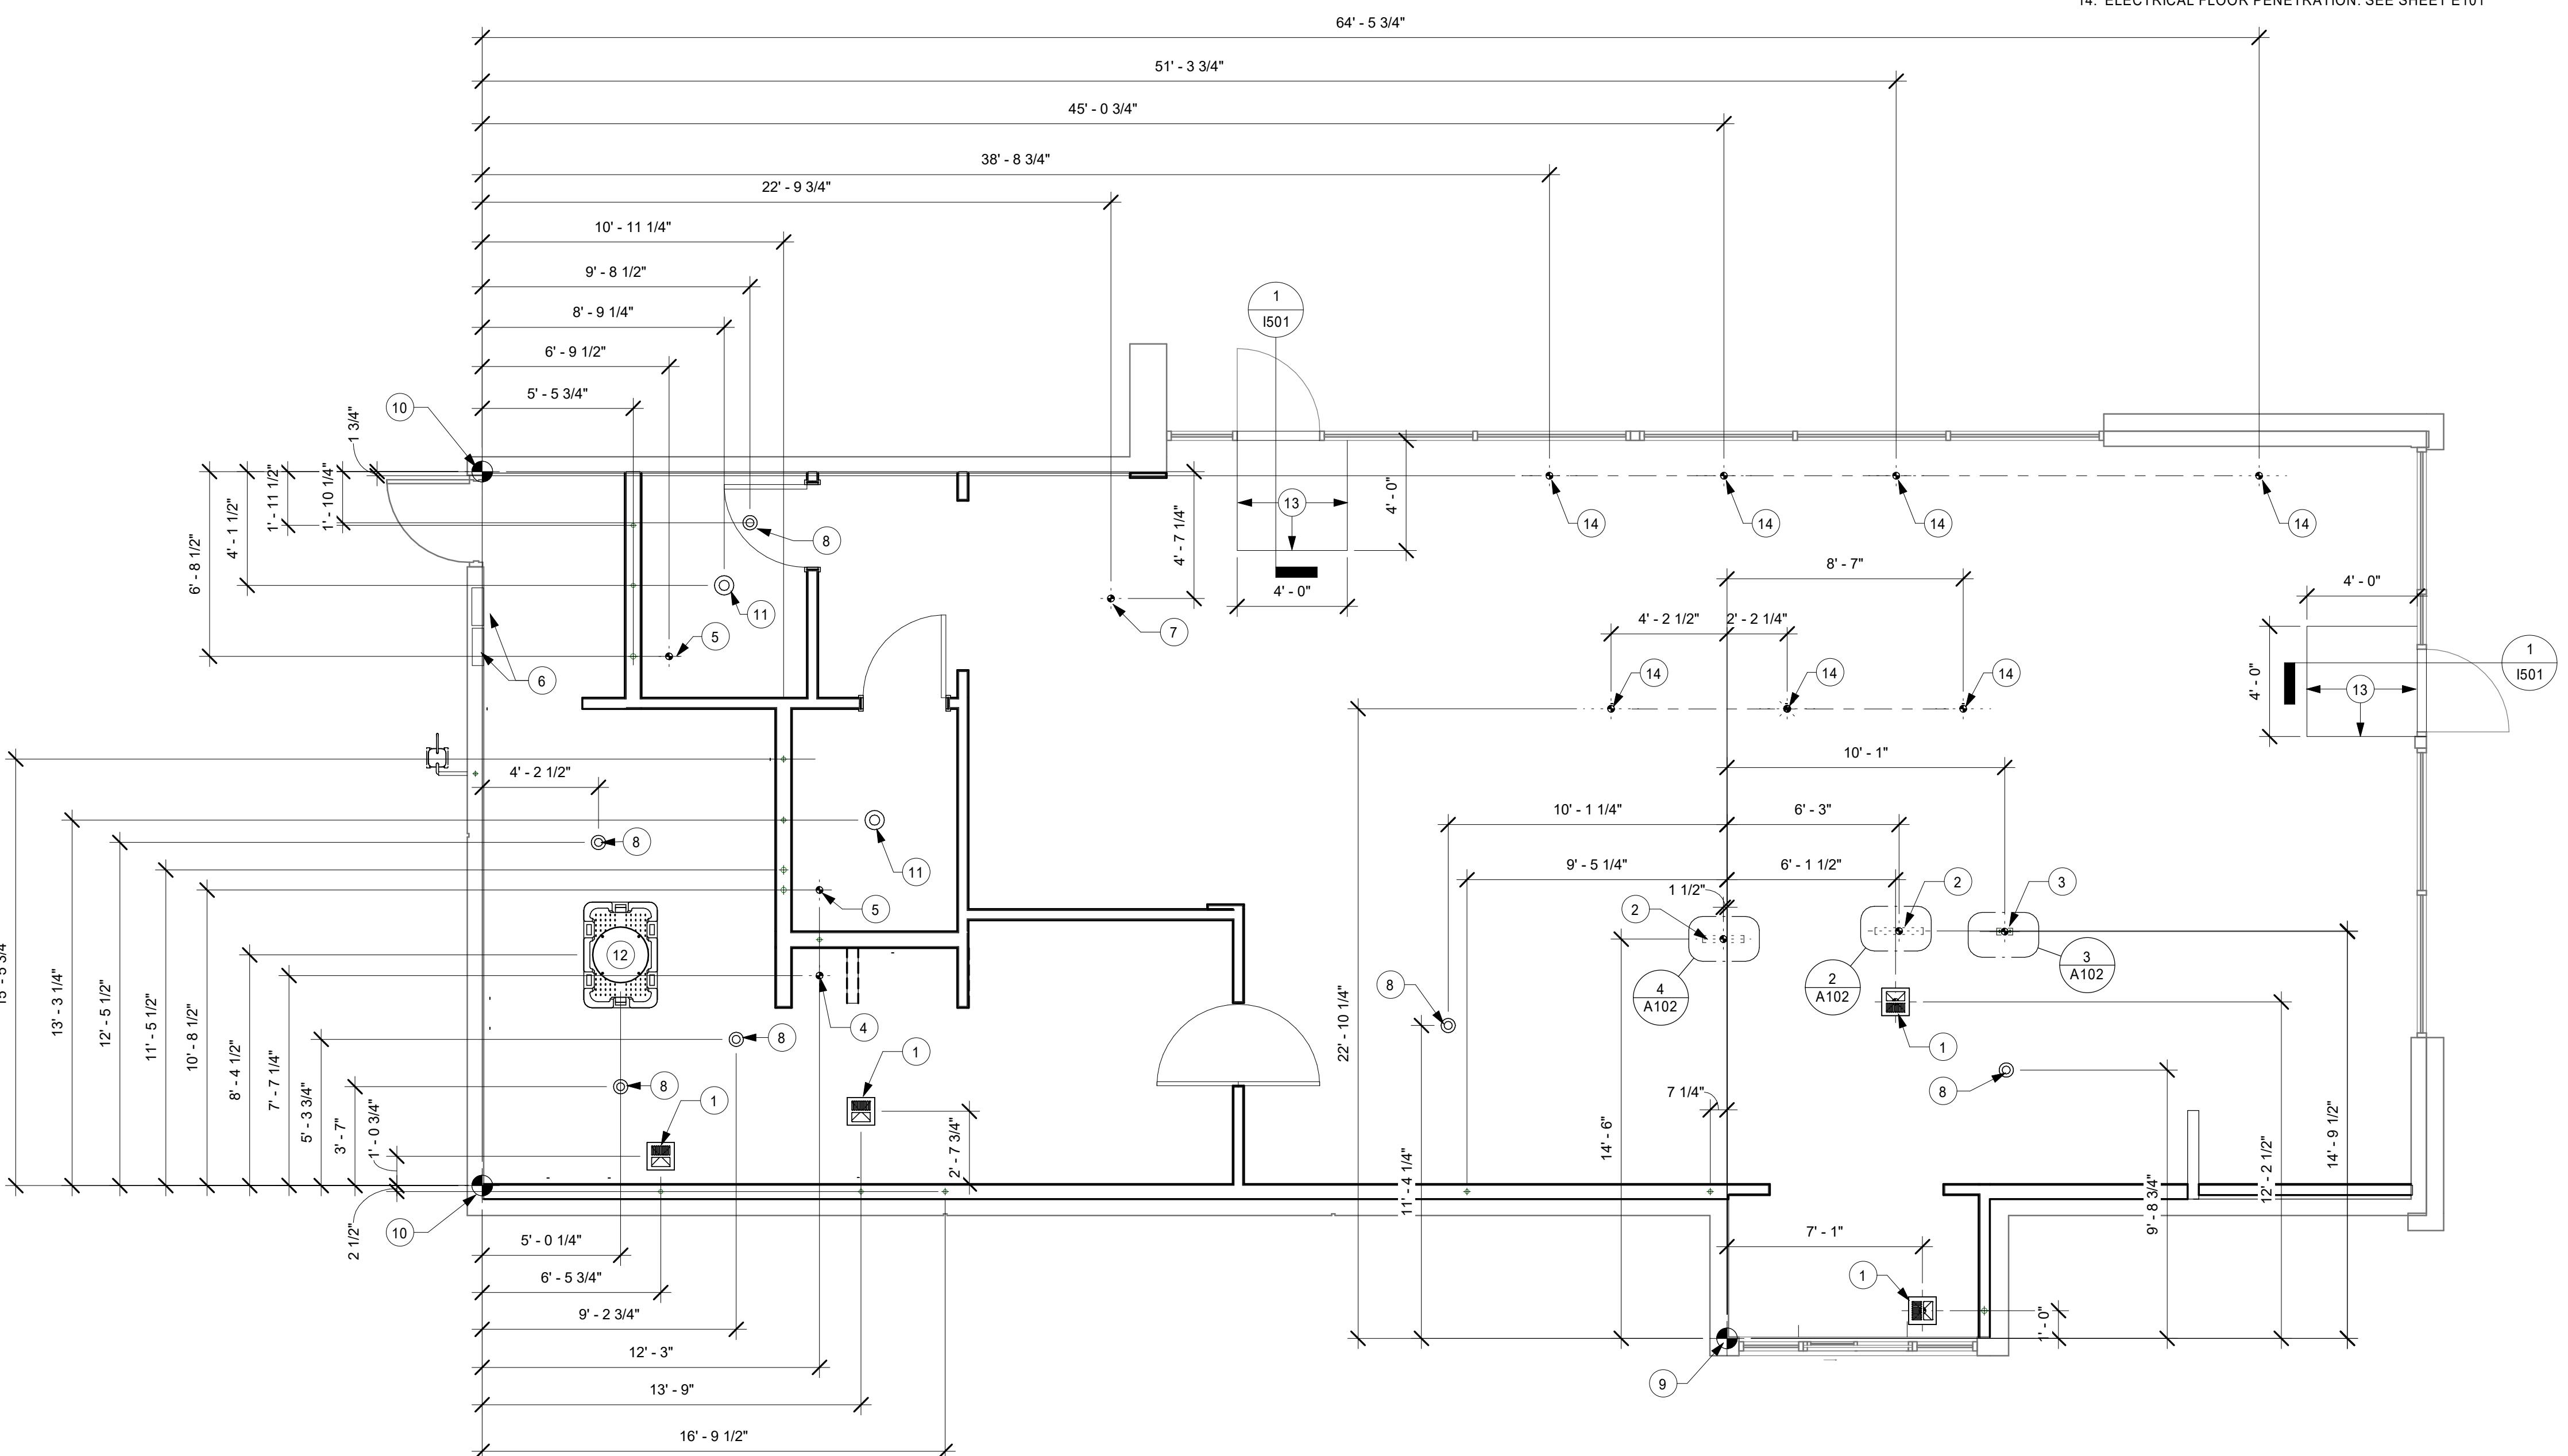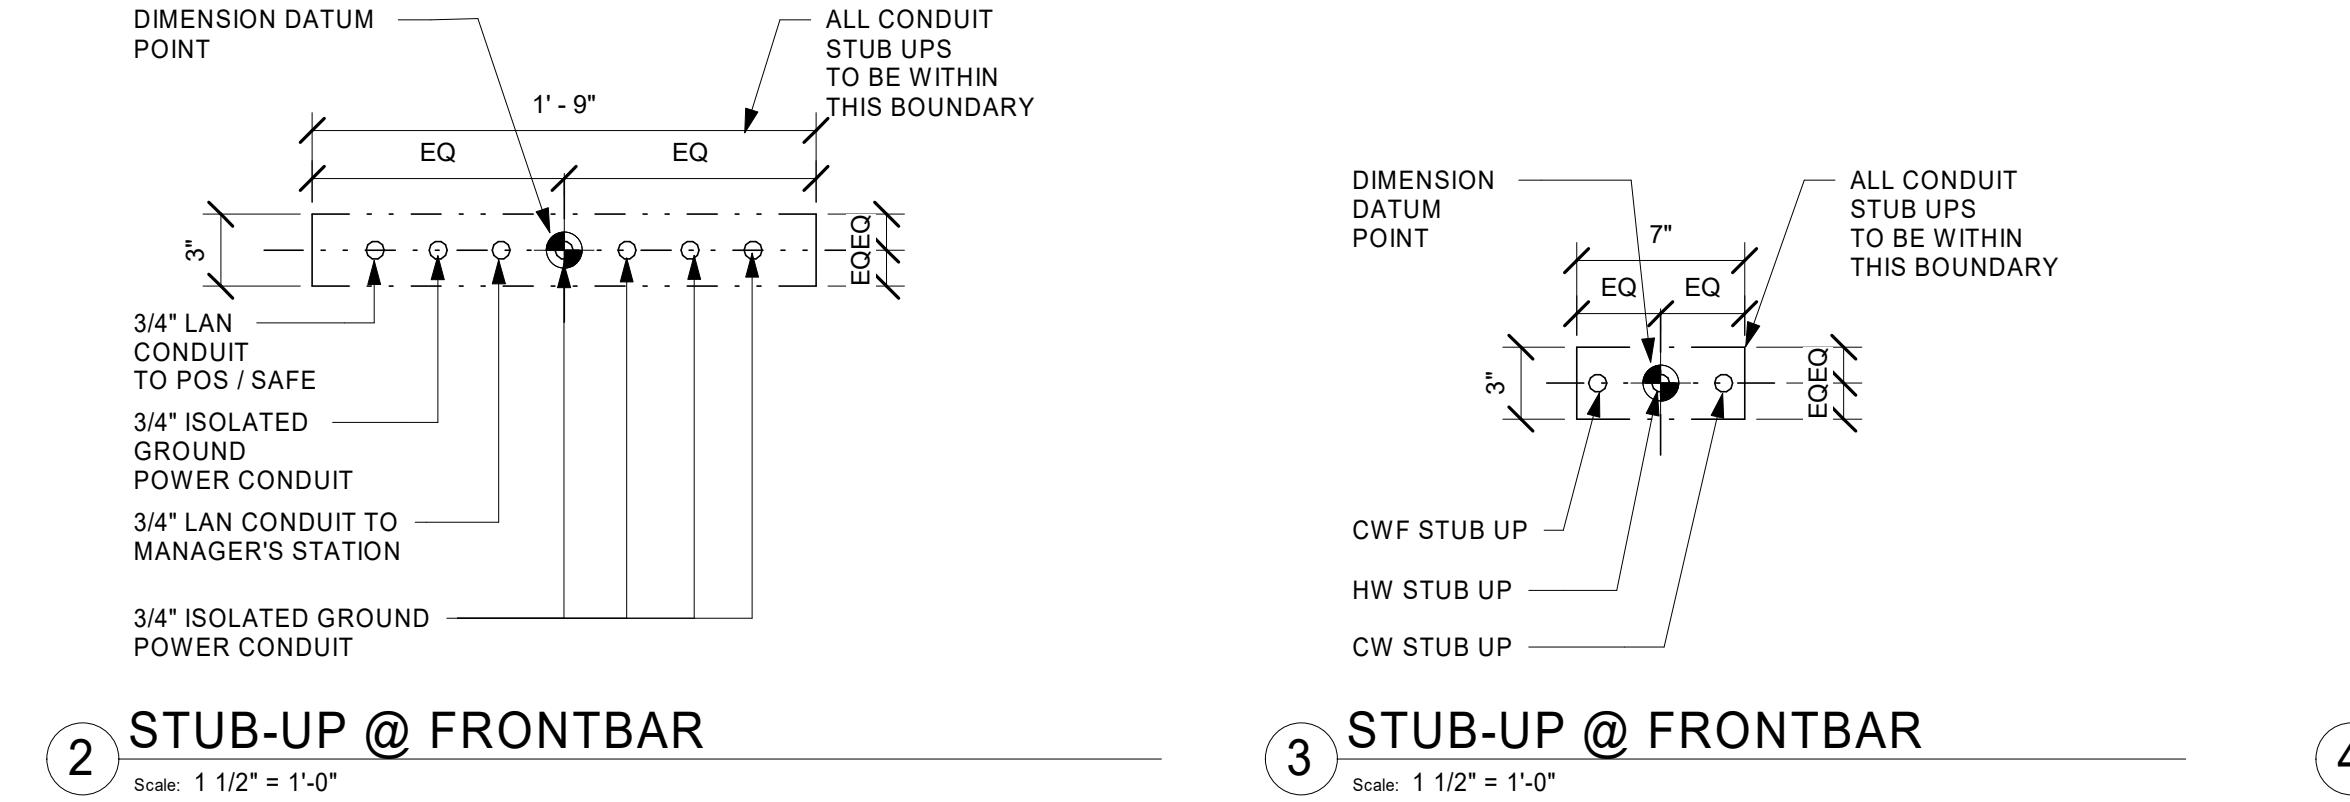

1 1ST FLOOR - FLOOR PENETRATION PLAN
Scale: 1/4" = 1'-0"

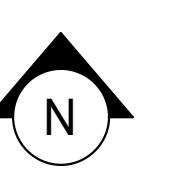



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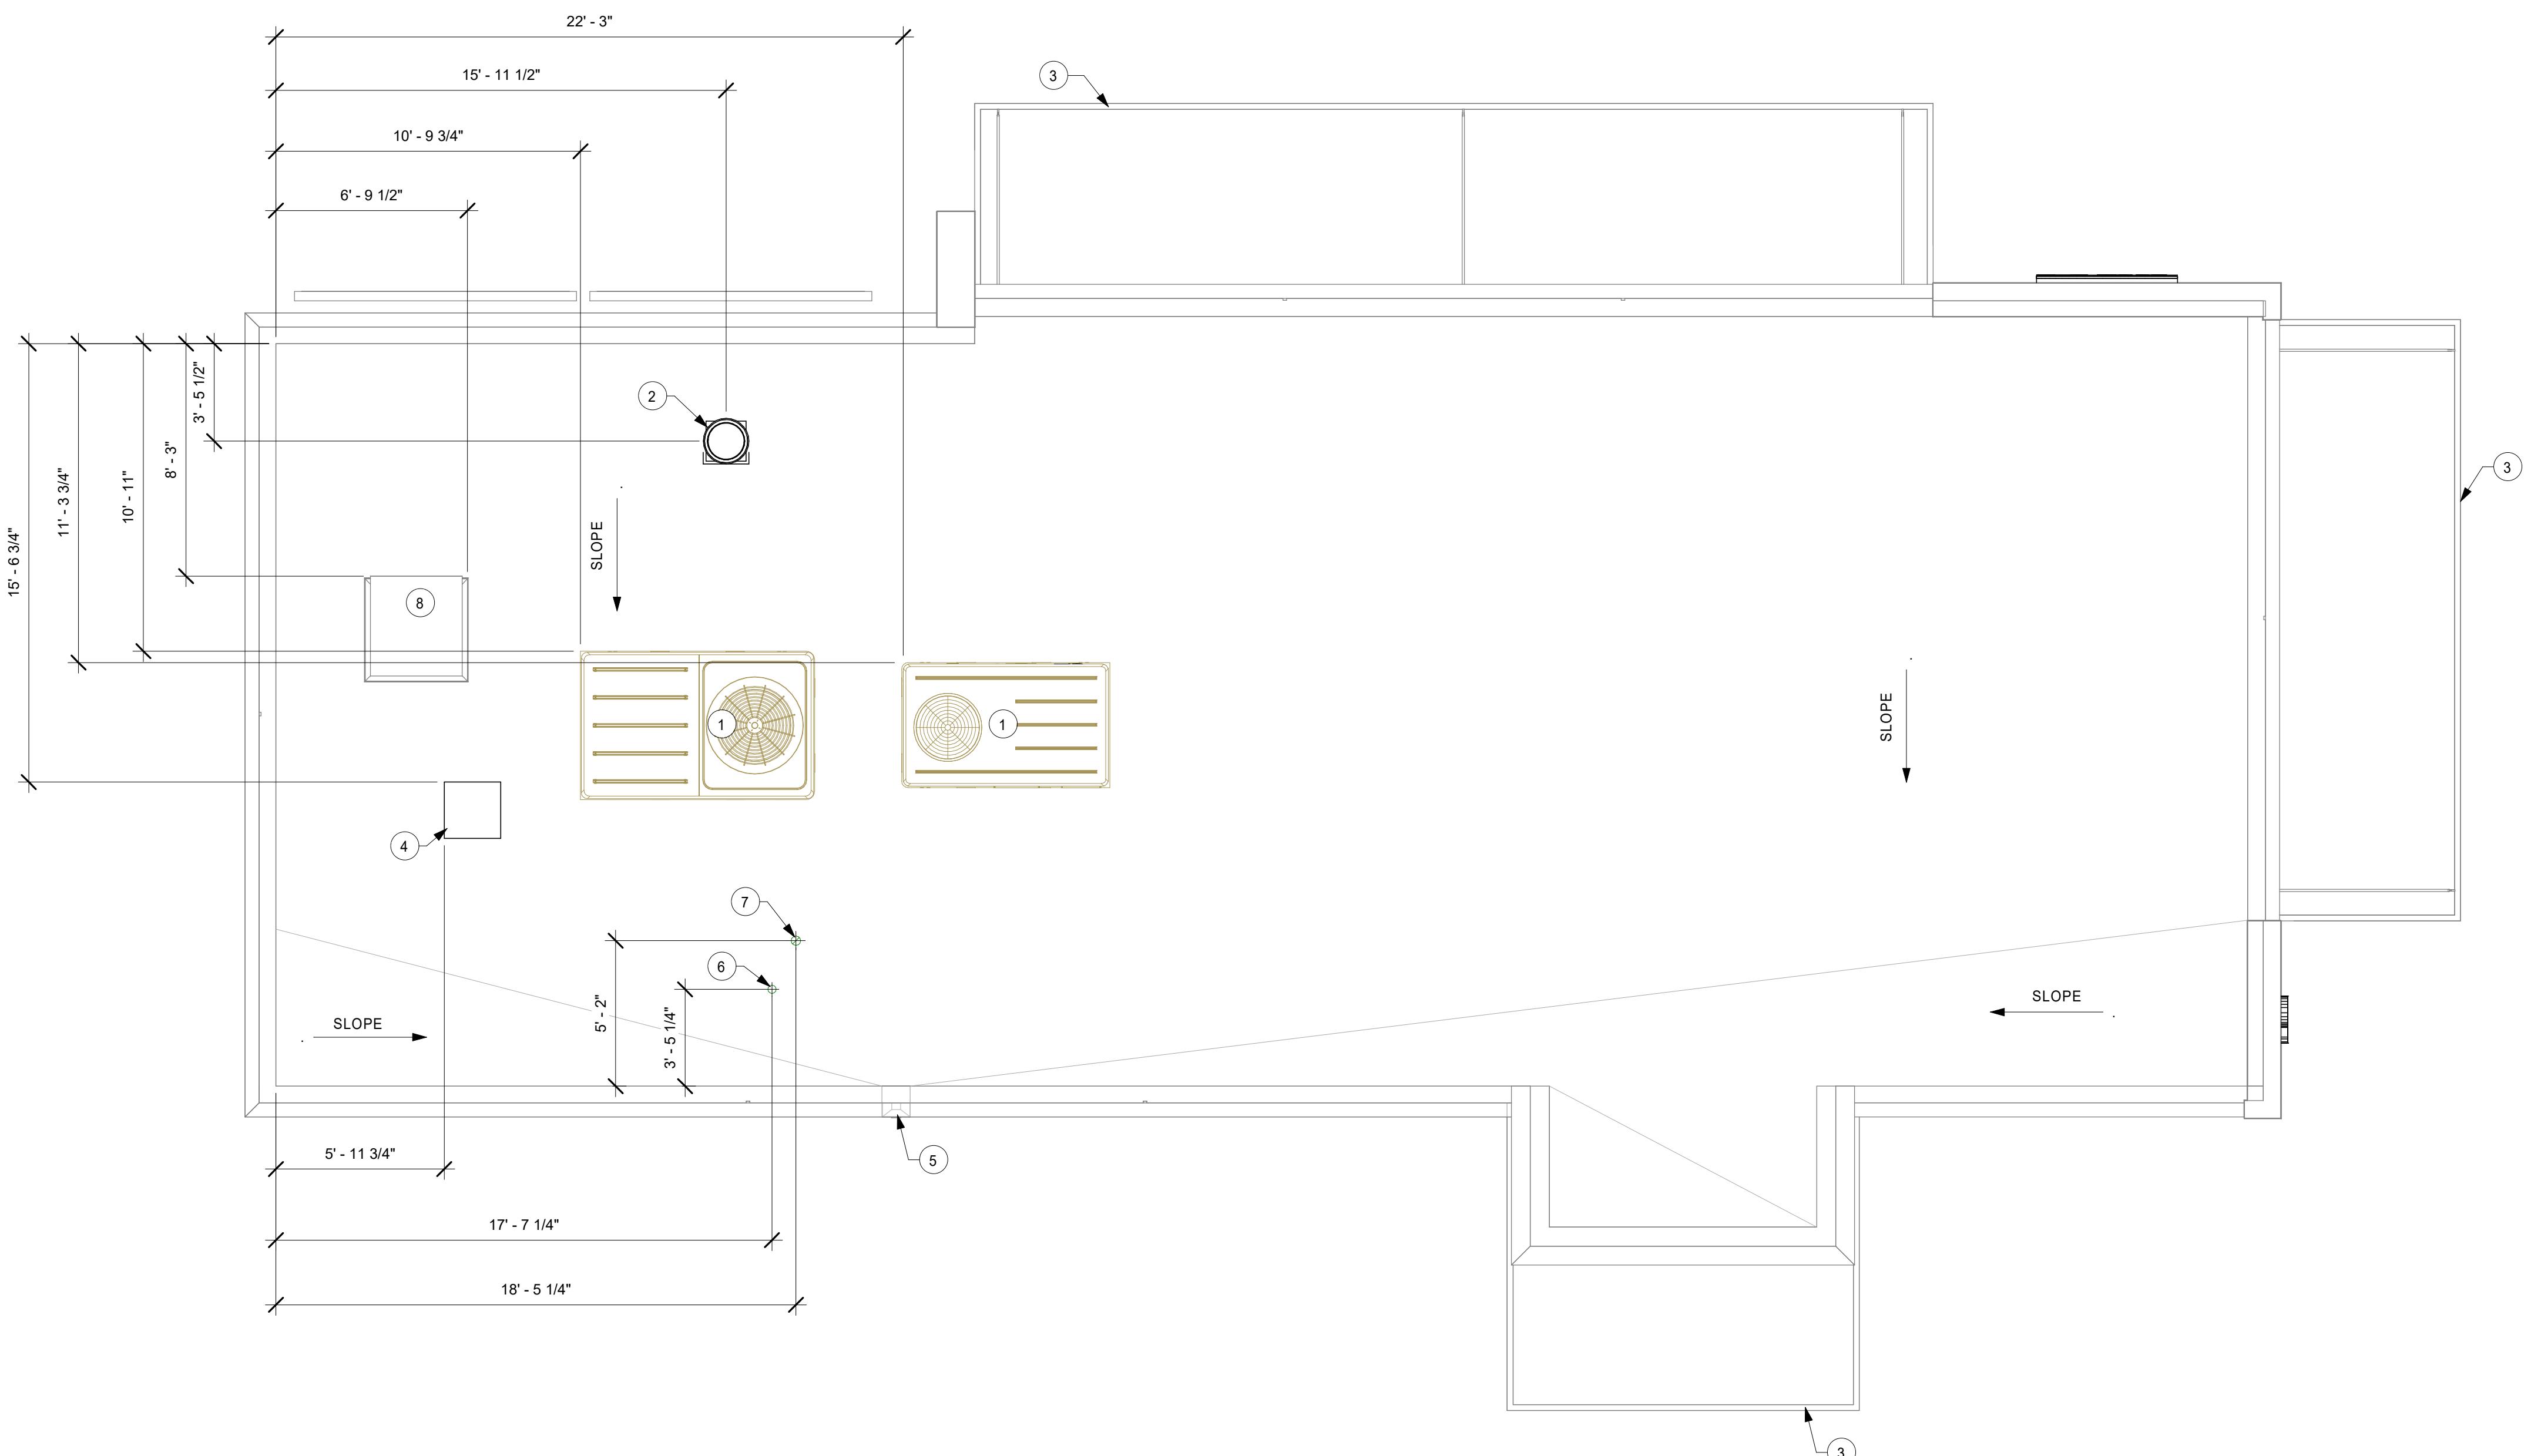
REGISTERED ARCHITECT
• MARK S. SALOPEK •
STATE OF OREGON 1/31/2020
• REG. NO. 6036
• D.L. Salopek, AIA
REGISTRATION NO. 6036

PROJECT NAME:
HWY 101 - COOS BAY
PROJECT ADDRESS:
101, COOS BAY VILLAGE
COOS BAY, OR 97420

STORE #: 60983
PROJECT #: 84073-001
ISSUE DATE: 01-29-20 - 100 percent
DESIGN MANAGER: RYAN WONG
PRODUCTION DESIGNER: GPD
CHECKED BY: TC

Revision Schedule			
Rev	Date	By	Description

SHEET TITLE:
BUILDING ROOF PLAN
SCALE: AS SHOWN
SHEET NUMBER:
A103



1ST FLOOR - ROOF PLAN

Scale: 1/4" = 1'-0"





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REGISTERED ARCHITECT
• MARK S. SALOPEK
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NO. 6036
STATE OF OREGON 1/31/2020
Mark Salopek

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PROJECT ADDRESS:
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COOS BAY, OR 97420

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DESIGN MANAGER: RYAN WONG
PRODUCTION DESIGNER: GPD
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Revision Schedule

Rev	Date	By	Description

SHEET TITLE:
**BUILDING EXTERIOR
ELEVATIONS**
SCALE: AS SHOWN

SHEET NUMBER:


A201

KEYED NOTES

1. GC TO PROVIDE J-BOX W/ PULL STRING FOR FUTURE BUILDING SIGNAGE. COORDINATE LOCATION OF J-BOX W/ SIGNAGE VENDOR PRIOR TO INSTALL.
2. PROVIDE 3/4" MARINE GRADE PLYWOOD BLOCKING FOR EXTERIOR SIGNAGE. EXTEND BLOCKING 8" (205MM) MIN. BEYOND EDGE OF SIGNAGE.
3. SIGNAGE BY STARBUCKS.
4. SIGNAGE UNDER SEPARATE PERMIT. GC TO COORDINATE REQUIRED ATTACHMENT WITH GM AND SIGNAGE VENDOR.
5. LL TO FURNISH AND INSTALL SECURITY LIGHT ABOVE ENTRY DOOR.
6. EXTERIOR TRELLIS BY LL.
7. EXTERIOR FURNITURE, TYP.
8. HOSE BIBB LOCATION.
9. BIKE RACK BY LL.
10. DRIVE-THRU CANOPY BY LL.
11. EXTERIOR SCONCE LIGHT BY LL, TYP.


GENERAL NOTES

- A. GENERAL CONTRACTOR TO COORDINATE AND SCHEDULE SIGNAGE INSTALLATION WITH THE SIGNAGE CONTRACTOR PROVIDING A MINIMUM SCHEDULING NOTICE OF 4 WEEKS AND 1 WEEK PRIOR TO SCHEDULED DATE OF INSTALLATION. CONSTRUCTION MANAGER TO PROVIDE GENERAL CONTRACTOR WITH SIGNAGE CONTRACTOR CONTACT INFORMATION.
- B. GENERAL CONTRACTOR SHALL COORDINATE WITH ELECTRICAL CONTRACTOR TO FURNISH AND INSTALL ELECTRICAL CIRCUITS INCLUDING ALL CONDUIT, WIRE, CONNECTIONS AND BREAKER AT PANEL BOARD NECESSARY TO SERVE SIGNAGE.
- C. GENERAL CONTRACTOR TO PROVIDE FIRE TREATED WOOD STUD BLOCKING OR EQUIVALENT TO SUPPORT SIGNAGE.
- D. SIGNAGE CONTRACTOR SHALL VERIFY SIZE AND LOCATION OF ANY AND ALL ALLOWABLE MONUMENT OR POLE SIGNAGE AND PROVIDE SHOP DRAWING(S) PRIOR TO FABRICATION TO THE STARBUCKS DESIGNER FOR APPROVAL.
- E. SIGNAGE CONTRACTOR TO INSTALL SIGNAGE IN COMPLIANCE WITH LOCAL CODES AND OBTAIN PERMIT.
- F. SIGNAGE CONTRACTOR TO SUPPLY SHOP DRAWINGS TO CONSTRUCTION MANAGER AND TO THE GENERAL CONTRACTOR AS NEEDED. GENERAL CONTRACTOR TO NOTIFY CONSTRUCTION MANAGER IMMEDIATELY IF SHOP DRAWINGS OR INSTALLATION IS IN DISCREPANCY WITH ARCHITECTURAL DRAWINGS.
- G. GENERAL CONTRACTOR TO CLEAN, PATCH AND REPAIR EXISTING EXTERIOR AS REQUIRED.

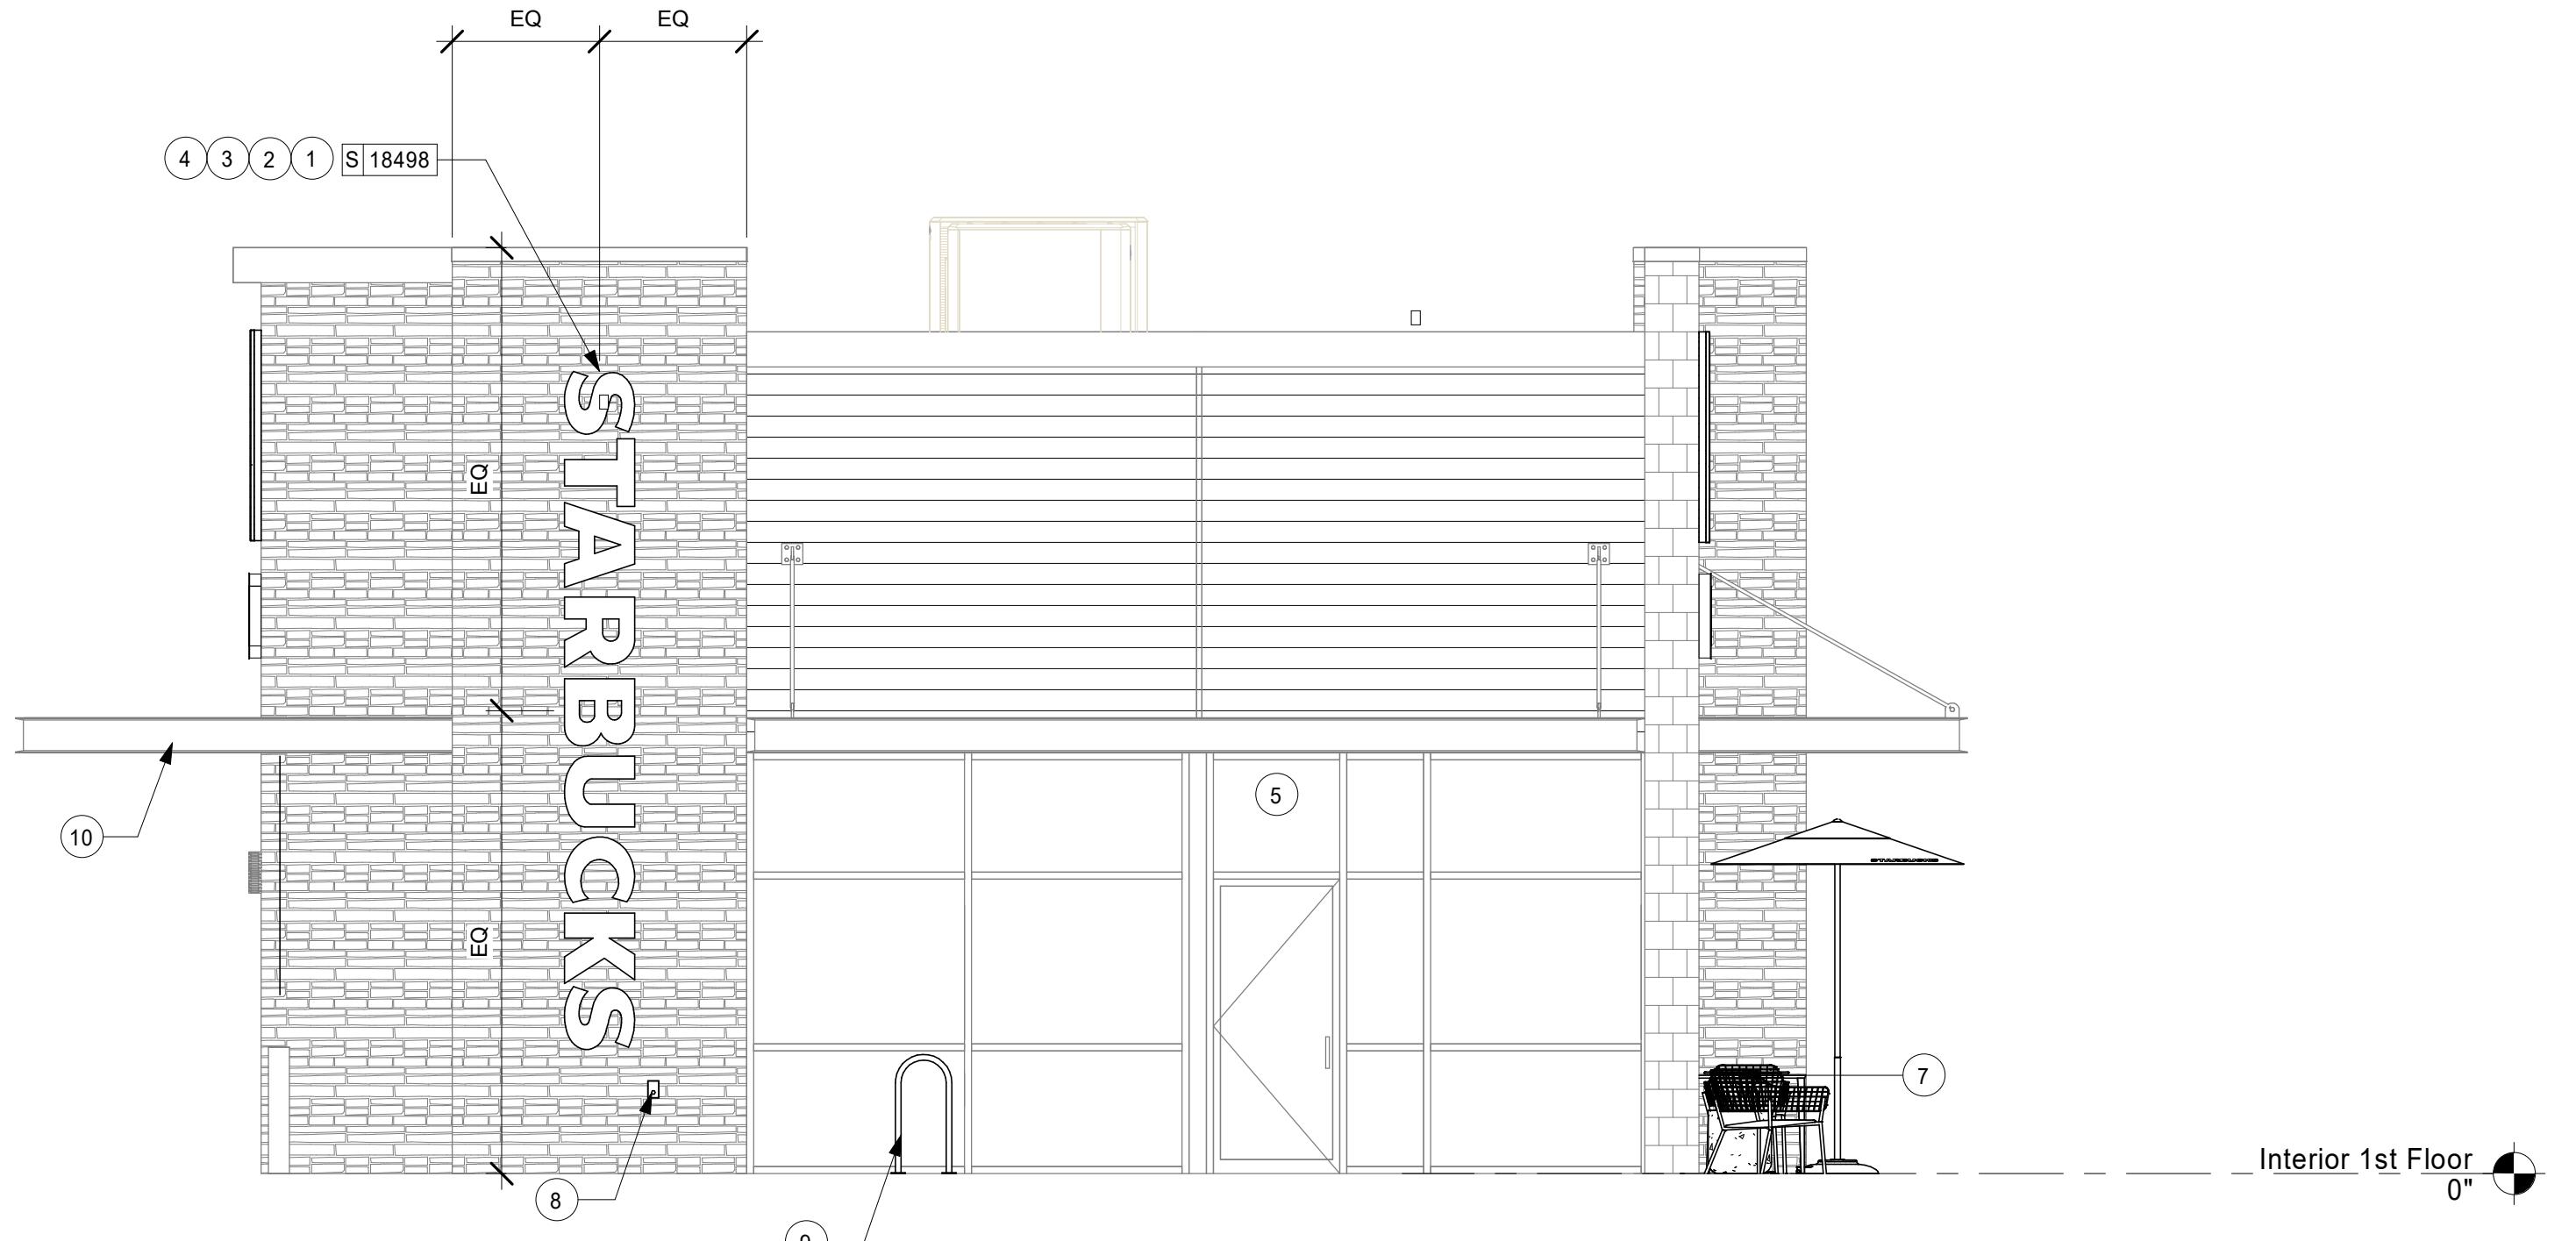

2 Exterior B

Scale: 1/4" = 1'-0"

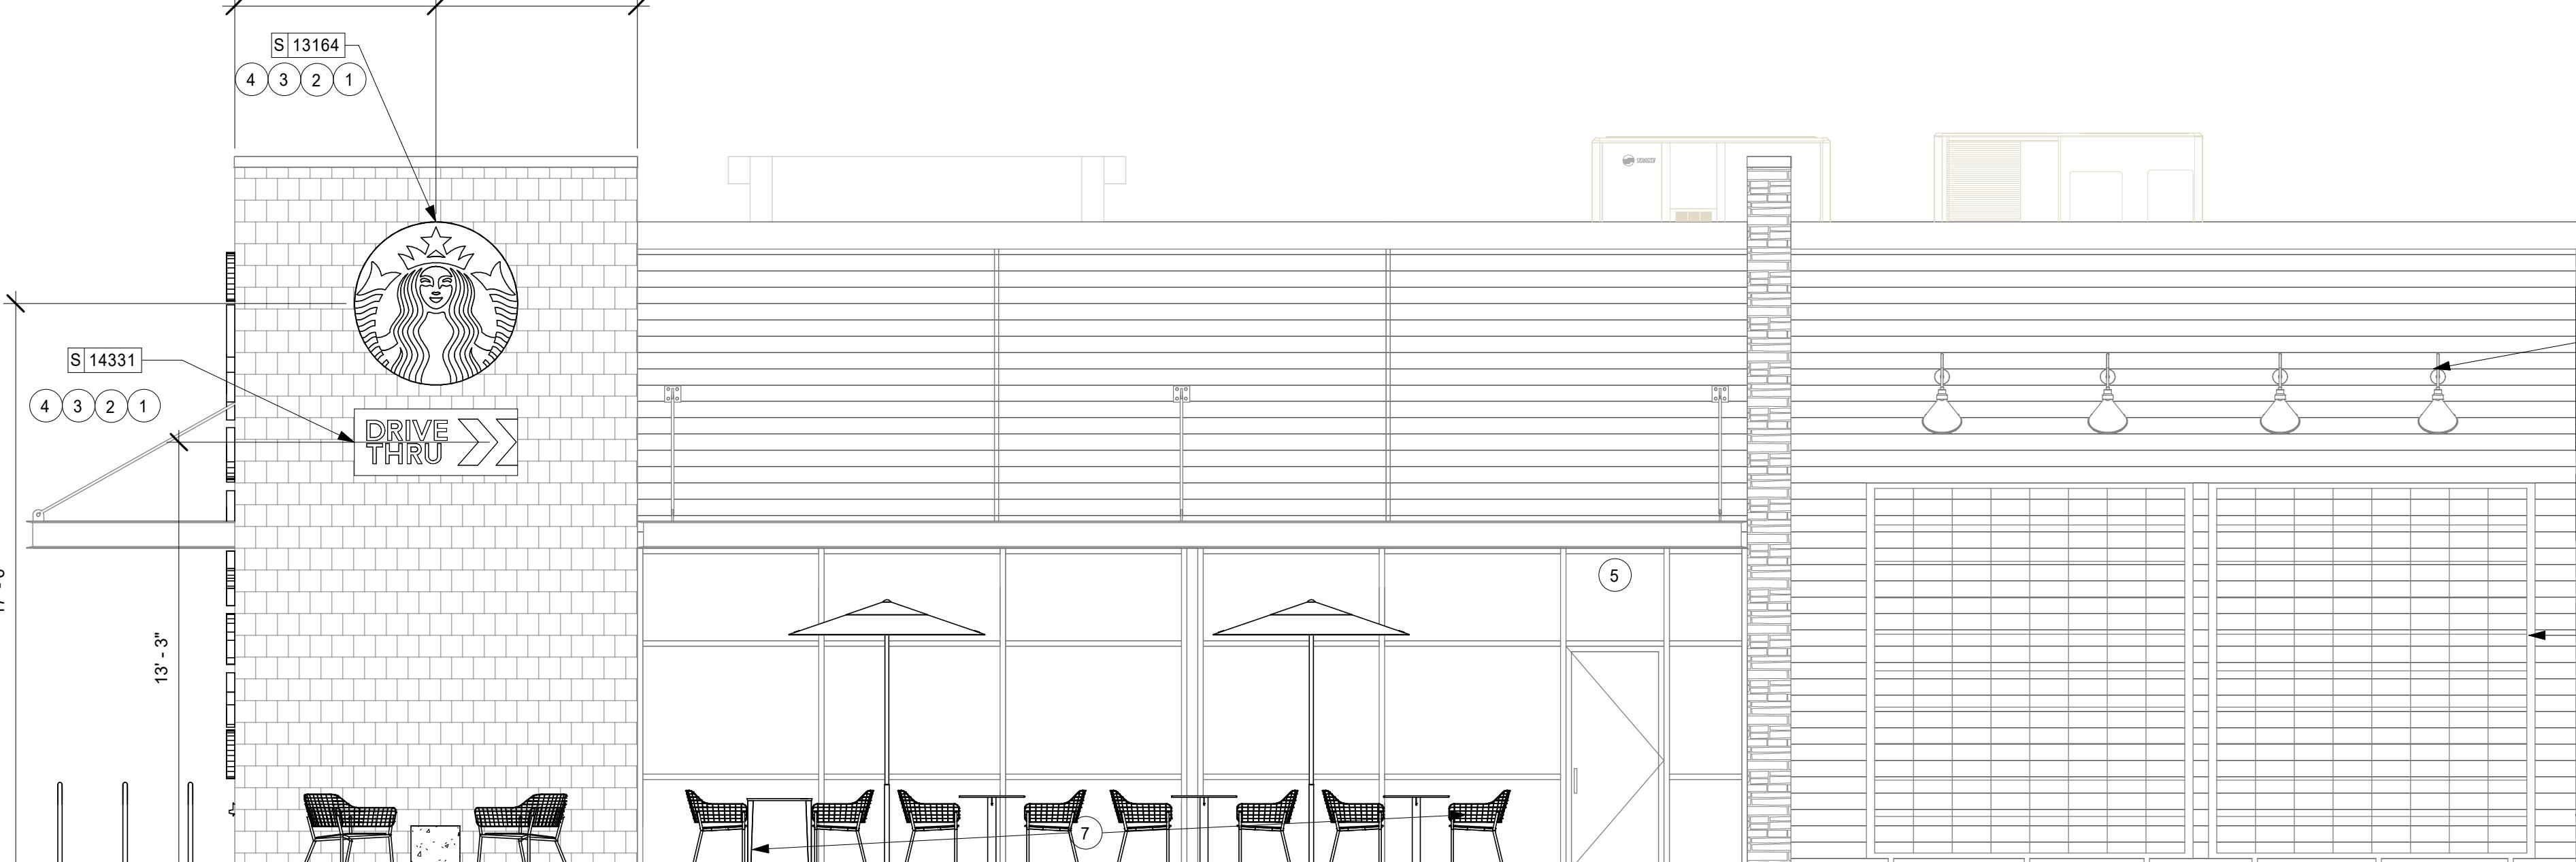

1 Exterior A

Scale: 1/4" = 1'-0"




Scale: 1/4" = 1'-0"



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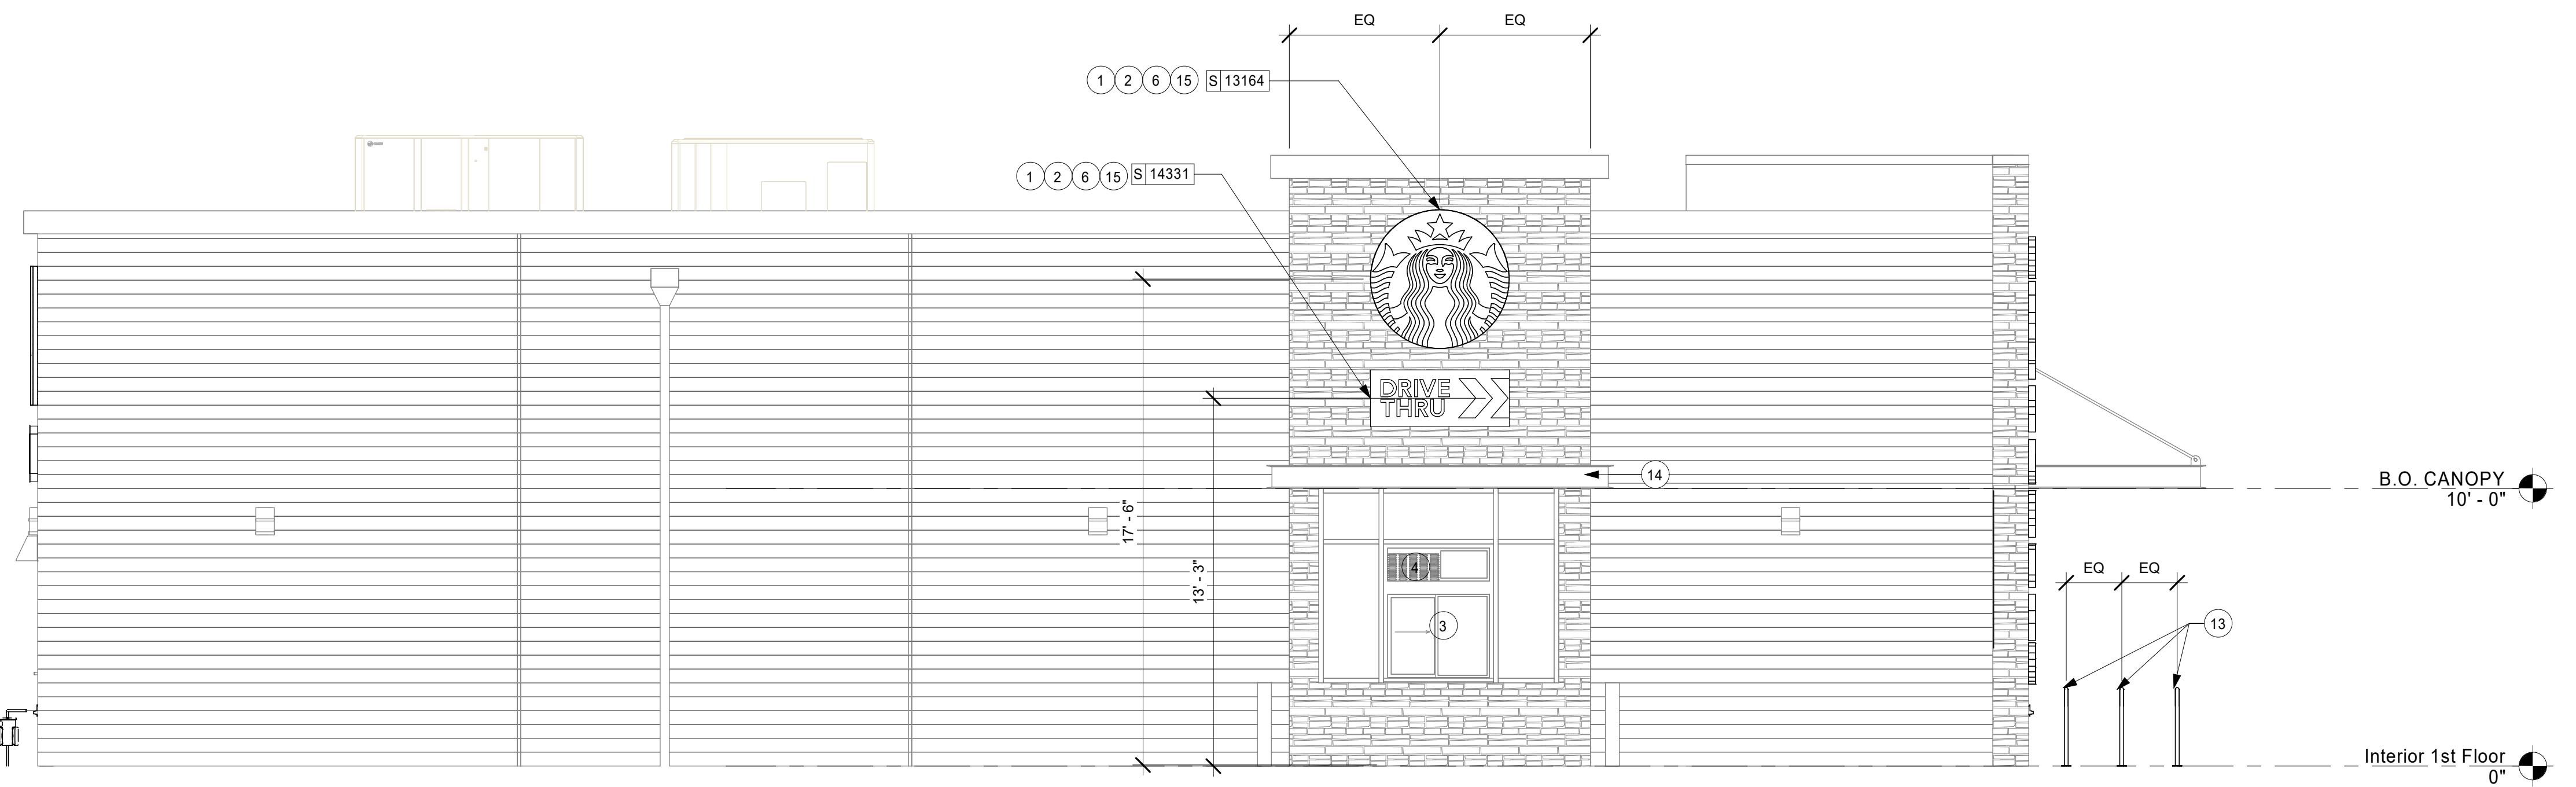
**SIGNAGE TO BE SUBMITTED UNDER
SEPARATE PERMIT BY OTHERS -
SHOWN FOR REFERENCE ONLY.**

DIMENSIONS OF BUILDING SHELL FOR REFERENCE ONLY

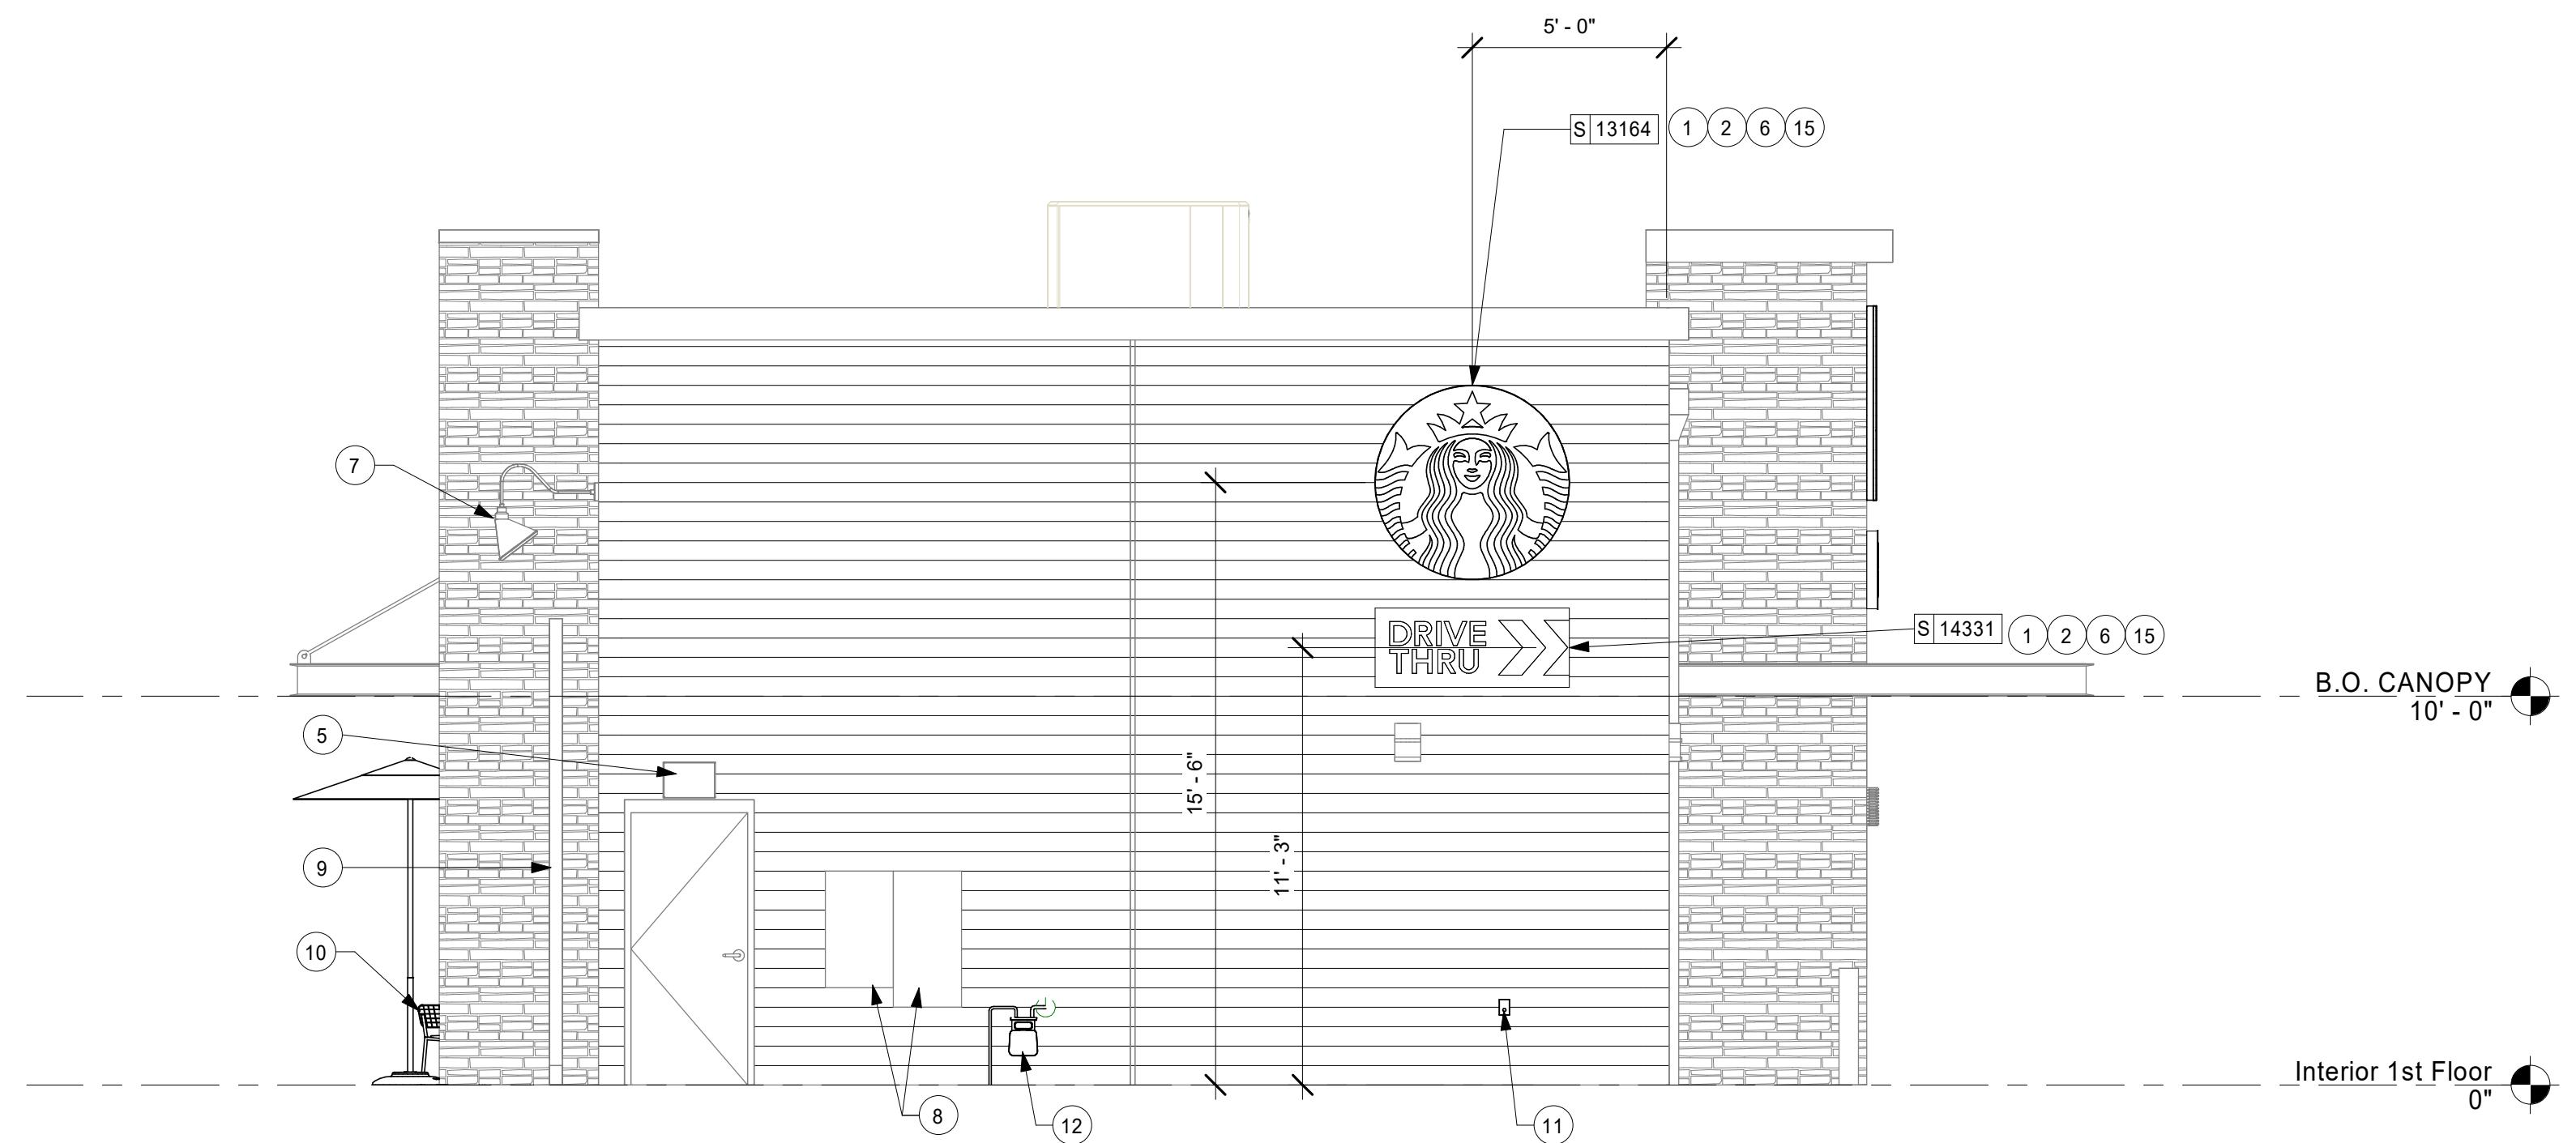

2 Exterior D

L Scale: 1/4" = 1'-0"



1 Exterior C

Scale: 1/4" = 1'-0"

KEYED NOTES

1. GC TO PROVIDE J-BOX W/ PULL STRING FOR FUTURE BUILDING SIGNAGE. COORDINATE LOCATION OF J-BOX W/ SIGNAGE VENDOR PRIOR TO INSTALL.
 2. PROVIDE 3/4" MARINE GRADE PLYWOOD BLOCKING FOR EXTERIOR SIGNAGE. EXTEND BLOCKING 8" (205MM) MIN. BEYOND EDGE OF SIGNAGE.
 3. LL TO FURNISH AND INSTALL TENANT SPECIFIED DRIVE THRU SERVICE WINDOW WITH ALL CONNECTIONS.
 4. LL TO FURNISH AND INSTALL AIR CURTAIN AND FLY FAN AT DRIVE THRU WINDOW.
 5. LL TO FURNISH AND INSTALL SECURITY LIGHT ABOVE SERVICE DOOR.
 6. SIGNAGE BY STARBUCKS.
 7. EXTERIOR LIGHT BY LL.
 8. ELECTRIC METER AND CT CABINET LOCATION.
 9. EXTERIOR TRELLIS BY LL.
 10. EXTERIOR FURNITURE, TYP.
 11. HOSE BIBB LOCATION.
 12. GAS METER. LOCATION.
 13. BIKE RACK BY LL.
 14. DRIVE-THRU CANOPY BY LL.
 15. SIGNAGE UNDER SEPARATE PERMIT. GC TO COORDINATE REQUIRED ATTACHMENT WITH GM AND SIGNAGE VENDOR.

GENERAL NOTES

- A. GENERAL CONTRACTOR TO COORDINATE AND SCHEDULE SIGNAGE INSTALLATION WITH THE SIGNAGE CONTRACTOR PROVIDING A MINIMUM SCHEDULING NOTICE OF 4 WEEKS AND 1 WEEK PRIOR TO SCHEDULED DATE OF INSTALLATION. CONSTRUCTION MANAGER TO PROVIDE GENERAL CONTRACTOR WITH SIGNAGE CONTRACTOR CONTACT INFORMATION.
 - B. GENERAL CONTRACTOR SHALL COORDINATE WITH ELECTRICAL CONTRACTOR TO FURNISH AND INSTALL ELECTRICAL CIRCUITS INCLUDING ALL CONDUIT, WIRE, CONNECTIONS AND BREAKER AT PANEL BOARD NECESSARY TO SERVE SIGNAGE.
 - C. GENERAL CONTRACTOR TO PROVIDE FIRE TREATED WOOD STUD BLOCKING OR EQUIVALENT TO SUPPORT SIGNAGE.
 - D. SIGNAGE CONTRACTOR SHALL VERIFY SIZE AND LOCATION OF ANY AND ALL ALLOWABLE MONUMENT OR POLE SIGNAGE AND PROVIDE SHOP DRAWING(S) PRIOR TO FABRICATION TO THE STARBUCKS DESIGNER FOR APPROVAL.
 - E. SIGNAGE CONTRACTOR TO INSTALL SIGNAGE IN COMPLIANCE WITH LOCAL CODES AND OBTAIN PERMIT.
 - F. SIGNAGE CONTRACTOR TO SUPPLY SHOP DRAWINGS TO CONSTRUCTION MANAGER AND TO THE GENERAL CONTRACTOR AS NEEDED. GENERAL CONTRACTOR TO NOTIFY CONSTRUCTION MANAGER IMMEDIATELY IF SHOP DRAWINGS OR INSTALLATION IS IN DISCREPANCY WITH ARCHITECTURAL DRAWINGS.
 - G. GENERAL CONTRACTOR TO CLEAN, PATCH AND REPAIR EXISTING EXTERIOR AS REQUIRED.

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STARBUCKS TEMPLATE VERSION: i2019-10-25



**GPD Engineering and Architecture
Professional Corporation**

SOUTH MAIN ST, SUITE 2531
AKRON, OH 44311
0-572-2100 F: 330-572-2101

GPD PROJECT NO: 2019355.20

FRED ARG

REGISTRATION OF ARCHITECT • STATE OF OREGON
MARK S. SALOPEK
AKRON, OH
NO. 6036
Date: 1/31/2020
Mark Salopek, AIA

PROJECT NAME:
HWY 101 - COOS BAY

PROJECT ADDRESS:
101, COOS BAY VILLAGE
COOS BAY, OR 97420

STORE #:	60983
PROJECT #:	84073-001
ISSUE DATE:	01-29-20 - 100 percent
DESIGN MANAGER:	RYAN WONG
PRODUCTION DESIGNER:	GPD

Environ Biol Fish (2010) 89:1–10

**SHEET TITLE:
BUILDING EXTERIOR
ELEVATIONS
SCALE: AS SHOWN**

SHEET NUMBER:

A202




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GENERAL NOTES


- A. STARBUCKS VENDOR TO PROVIDE DOOR HARDWARE COMPONENTS. GC TO INSTALL.
- B. SEE SHEET A101 FOR TAGGED LOCATION OF EXTERIOR DOORS AND WINDOWS.
- C. EGRESS SHALL NOT PASS THROUGH KITCHENS, STORAGE ROOMS, CLOSETS OR SIMILAR SPACES. (1014.2)
- D. PANIC AND FIRE EXIT HARDWARE, WHERE INSTALLED ON DOORS IN THIS BUILDING SHALL SATISFY THE FOLLOWING (1008.1.10):
 - a) THE ACTUATION PORTION OF THE RELEASING DEVICE SHALL EXTEND AT LEAST ONE-HALF OF THE DOOR LEAF WIDTH.
 - b) THE MAXIMUM UNLATCHING FORCE DOES NOT EXCEED 15 POUNDS (6.8 KG).
 - c) PIVOTED OR BALANCED DOORS SHALL BE OF THE PUSH-PAD TYPE WHERE PANIC HARDWARE IS REQUIRED AND THE PAD SHALL NOT EXTEND ACROSS MORE THAN ONE-HALF OF THE DOOR WIDTH, MEASURED FROM THE LATCH SIDE.
 - d) PANIC HARDWARE LISTED IN ACCORDANCE WITH UL 305.
 - e) FIRE EXIT HARDWARE LISTED IN ACCORDANCE WITH UL 10C AND UL 305.

WINDOW LEGEND



INTERIOR DOOR SCHEDULE - "D".									
DESIGN ID	MARK	DESCRIPTION	WIDTH	HEIGHT	HARDWARE SET	FURN BY	INST BY	COMMENTS	
Exterior									
X10190	03	DOOR - HM SINGLE FLUSH - 42 IN - SINGLE SERVICE	3' - 0"	7' - 0"	42	LL	LL		
10205	01	DOOR - STOREFRONT METAL FRAME SINGLE - TYPE B	3' - 0"	7' - 0"	2	LL	LL		
10205	02	DOOR - STOREFRONT METAL FRAME SINGLE - TYPE B	3' - 0"	7' - 0"	2-A	LL	LL		
3									
Interior									
10190	04	DOOR - SINGLE FLUSH - 36IN	3' - 0"	7' - 0"	6	GC	GC		
10190	05	DOOR - SINGLE FLUSH - 36IN	3' - 0"	7' - 0"	6	GC	GC		
10086	06	DOOR - SINGLE IMPACT DOUBLE ACTING - 36IN 915MM	3' - 0"	7' - 0"	11	GC	GC		
3									

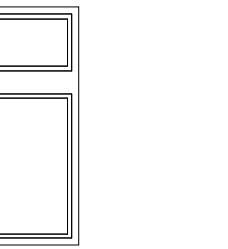DOOR LEGEND

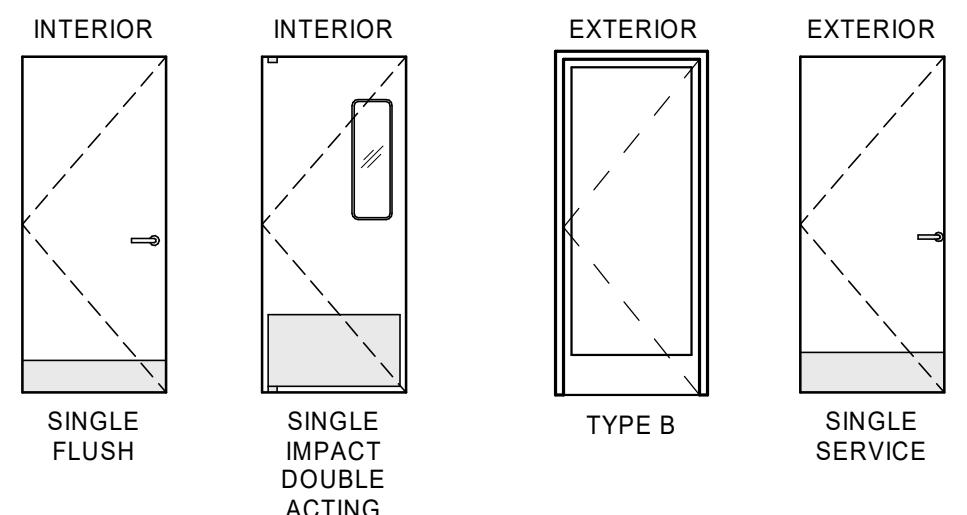

DOOR HARDWARE SET NO. 6 - For restroom door with lever and privacy lock				
No.	Item	Description	Manufacturer	Finish
3	Hanging Items	TA2714/MPB79 Hinge MacPro Bearing 4.5 x 4.5	McKinney	626
1	Securing Devices	PB5425LN Lock, Shallow Coin Turn, Privacy PB5425LN-693-497 1-3/4	Yale Lock	626
1	Closing Devices	8916 Door Closer 8916 AF89P	Dorma	689
2	Protective Trim Units	K1050 B4E Kickplate 8" x 34" Each Side 32D	Rockwood	630
3	Accessories	GJ64 Rubber Silencer	Glynn Johnson	Gray
1	Stops and Holders	473 Door Stop w/ Hook	Rockwood	626

DOOR HARDWARE SET NO. 11 - For workroom door at backbar				
No.	Item	Description	Manufacturer	Finish
1	Traffic Door Package	SCP8 36" x 84"	Eliason	As Selected

DOOR HARDWARE SET NO. 2 - For new single aluminum main entry/exit door				
No.	Item	Description	Manufacturer	Finish
3	Hanging Devices	TH2314/MPB91	McKinney	630
1	Securing Devices	MS1851S Deadbolt	Adams Rite	628
1	Sign	Vinyl Sign: "THIS DOOR MUST REMAIN UNLOCKED WHEN BUILDING IS OCCUPIED"	Seton	--
2	Securing Devices	C607 7-Pin Core Combined "A" Keyway	Falcon Lock	626
1	Securing Devices	KB609-2 Cut Control Key "A" Keyway	Falcon Lock	--
9	Securing Devices	KB632-2 Cut User Key "A" Keyway	Falcon Lock	--
2	Securing Devices	C987 7-Pin Mortise Cylinder Housing w/AR Cam 26D	Falcon Lock	626
2	Securing Devices	AO8794-003 Adjustable Ring, Mortise Cyl. 5/16-13/32	Falcon Lock	626
1	Operating Trim	108 Door Pull Handle 32D	Rockwood	630
1	Operating Trim	48 Push Bar x 31	Rockwood	630
1	Closing Devices	8916 Door Closer 8916 AF89P	Dorma	689
1	Stops and Holders	473 Door Stop w/Hook	Rockwood	626
1	Threshold	325 Half Saddle Threshold	National Guard	--

DOOR HARDWARE SET NO. 2-A - For new single aluminum secondary entry/exit door (50 or more occupancy)				
No.	Item	Description	Manufacturer	Finish
3	Hanging Devices	TH2314/MPB91	McKinney	630
1	Securing Devices	CD35A-NL-OP Panic Device	Von Duprin	628/630
2	Securing Devices	C607 7-Pin Core Combined "A" Keyway	Falcon Lock	626
1	Securing Devices	KB609-2 Cut Control Key "A" Keyway	Falcon Lock	--
9	Securing Devices	KB632-2 Cut User Key "A" Keyway	Falcon Lock	--
1	Securing Devices	C953 7-Pin Rim Cylinder Housing	Falcon Lock	626
1	Securing Devices	C987 7-Pin Mortise Cylinder Housing w/AR Cam	Falcon Lock	626
1	Securing Devices	A08794-003 Adjustable Ring, Mortise Cyl. 5/16-13/32	Falcon Lock	626
1	Operating Trim	108 Door Pull Handle	Rockwood	630
1	Closing Devices	8916 Door Closer 8916 AF89P	Dorma	689
1	Stops and Holders	473 Door Stop w/ Hook	Rockwood	626
1	Threshold	325 Half Saddle Threshold	National Guard	--
1	Sign	Vinyl Sign: "THIS DOOR MUST REMAIN UNLOCKED WHEN BUILDING IS OCCUPIED"	Seton	--

WINDOW SCHEDULE - "W"						
DESIGN ID	COUNT	DESCRIPTION	FURN. BY	INST. BY	COMMENTS	
WINDOW	1	WINDOW - DT WITH SPLIT TRANSOM - 48X60IN 1205X1510MM - ALUMINUM	LL	LL	USE IN CONJUNCTION WITH AA100 FLYFAN	

REGISTERED ARCHITECT
MARK S. SALOPEK, AIA, LEED AP
AKRON, OH
NO. 6036
GPD PROJECT NO. 2019355.20
1/31/2020
Mark Salopek, AIA, LEED AP

PROJECT NAME:
HWY 101 - COOS BAY
PROJECT ADDRESS:
101, COOS BAY VILLAGE
COOS BAY, OR 97420
STORE #: 60983
PROJECT #: 84073-001
ISSUE DATE: 01-29-20 - 100 percent
DESIGN MANAGER: RYAN WONG
PRODUCTION DESIGNER: GPD
CHECKED BY: TC

Revision Schedule
Rev Date By Description
1/31/2020
SHEET TITLE:
WINDOW AND DOOR SCHEDULES & DETAILS
SCALE: AS SHOWN
SHEET NUMBER:
A602



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STARBUCKS TEMPLATE VERSION: i2019-10-25



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ISSUE DATE: 01-29-20 - 100 percent
DESIGN MANAGER: RYAN WONG
PRODUCTION DESIGNER: GPD
CHECKED BY: TC

Revision Schedule			
Rev	Date	By	Description

SHEET TITLE:
CASEWORK PLAN

SCALE: AS SHOWN

SHEET NUMBER:
I102

KEYED NOTES



1. DO NOT CAULK TRASH RINGS TO COUNTERTOPS.
2. INSTALL CASEWORK, COUNTERTOPS, SHELVES, CUBBIES, FINISHES, TRIM AND TABLE TOPS THROUGHOUT. REFERENCE FINISH SCHEDULE AND MANUFACTURER'S SPECIFICATIONS FOR ADDITIONAL INFORMATION.
3. ALL COUNTERTOPS UTILIZED FOR CUSTOMER TRANSACTIONS, INCLUDING BAR, CONDIMENTS AND SALES COUNTERTOPS SHALL BE INSTALLED AT 2'-10" (860 MM) MAXIMUM A.F.F.
4. PROVIDE COUNTERTOP TASK LIGHTING. MOUNT TO UNDERSIDE OF SHELVES. SEE INTERIOR ELEVATIONS AND ELECTRICAL FOR ADDITIONAL INFORMATION.
5. VARIABLE WIDTH FILLER CABINET / COUNTERTOP REQUIRED TO FILL GAP (FIELD VERIFY DIMENSION). VENDOR TO COORDINATE EXACT DIMENSION WITH GC PRIOR TO INSTALLATION.
6. FLOOR SINK BELOW. CASEWORK MANUFACTURER TO COORDINATE DESIGN TO INSURE THIS AREA IS READILY ACCESSIBLE FOR CLEANING AND FREE OF COUNTERTOP SUPPORT.
7. CEILING CASEWORK ABOVE

GENERAL NOTES

- A. GENERAL CONTRACTOR TO NOTIFY CONSTRUCTION MANAGER IMMEDIATELY IF A DISCREPANCY EXISTS BETWEEN CASEWORK SHOP DRAWINGS, EXITING SITE CONDITIONS, ARCHITECTURAL DRAWINGS OR BUILT FIXTURES. ALL DIMENSIONS SHALL BE FIELD VERIFIED BY GC PRIOR TO SHOP DRAWINGS PRODUCTION.
- B. STARBUCKS CONSTRUCTION MANAGER TO COORDINATE AND SCHEDULE CASEWORK DELIVERY DATE. GENERAL CONTRACTOR TO CONFIRM CASEWORK DELIVERY DATE WITH CASEWORK MANUFACTURER AT FOUR (4) WEEKS PRIOR AND THEN ONE (1) WEEK PRIOR TO SCHEDULED DATE OF DELIVERY.
- C. STARBUCKS CONTRACTS DIRECTLY WITH CASEWORK VENDOR TO SUPPLY CASEWORK LISTED IN THE CASEWORK SCHEDULE, UNLESS OTHERWISE NOTED.
- D. CASEWORK VENDOR TO PROVIDE COMPLETE SHOP DRAWINGS AND INSTALLATION PACKAGE TO GENERAL CONTRACTOR TO FACILITATE PROPER INSTALLATION.
- E. ALL CASEWORK BOX BASE / TOE KICKS SHALL BE SET AND LEVELED USING 1/4" (6 MM) NON-ABSORBENT PLASTIC SHIMS PROVIDED BY CASEWORK VENDOR.
- F. SEE INTERIOR FINISH ELEVATIONS AND SCHEDULES FOR LOCATION AND TAGGING OF WALL TREATMENTS BY CV AND OTHERS.
- G. SEE REFLECTED CEILING PLAN FOR CASEWORK SOFFIT LOCATIONS.
- H. REFERENCE PLUMBING AND ELECTRICAL PLANS FOR PLACEMENT OF ELECTRICAL, DATA AND PLUMBING ON FRONT AND BACKLINE OF BAR.
- I. PROVIDE ACCENT LIGHTING AT FRONT EDGE OF BAR. SEE INTERIOR ELEVATIONS AND ELECTRICAL FOR ADDITIONAL INFORMATION.
- J. CASEWORK VENDOR TO ENGINEER PROPER COUNTERTOP SUPPORT AT ESPRESSO BAR AND OTHER WORKSTATIONS PER STARBUCKS MINIMUM PERFORMANCE REQUIREMENTS.

LEGEND

- [Solid Surface Counter] INDICATES SOLID SURFACE (SS) COUNTERTOP
[Casework Tag] CASEWORK TAG

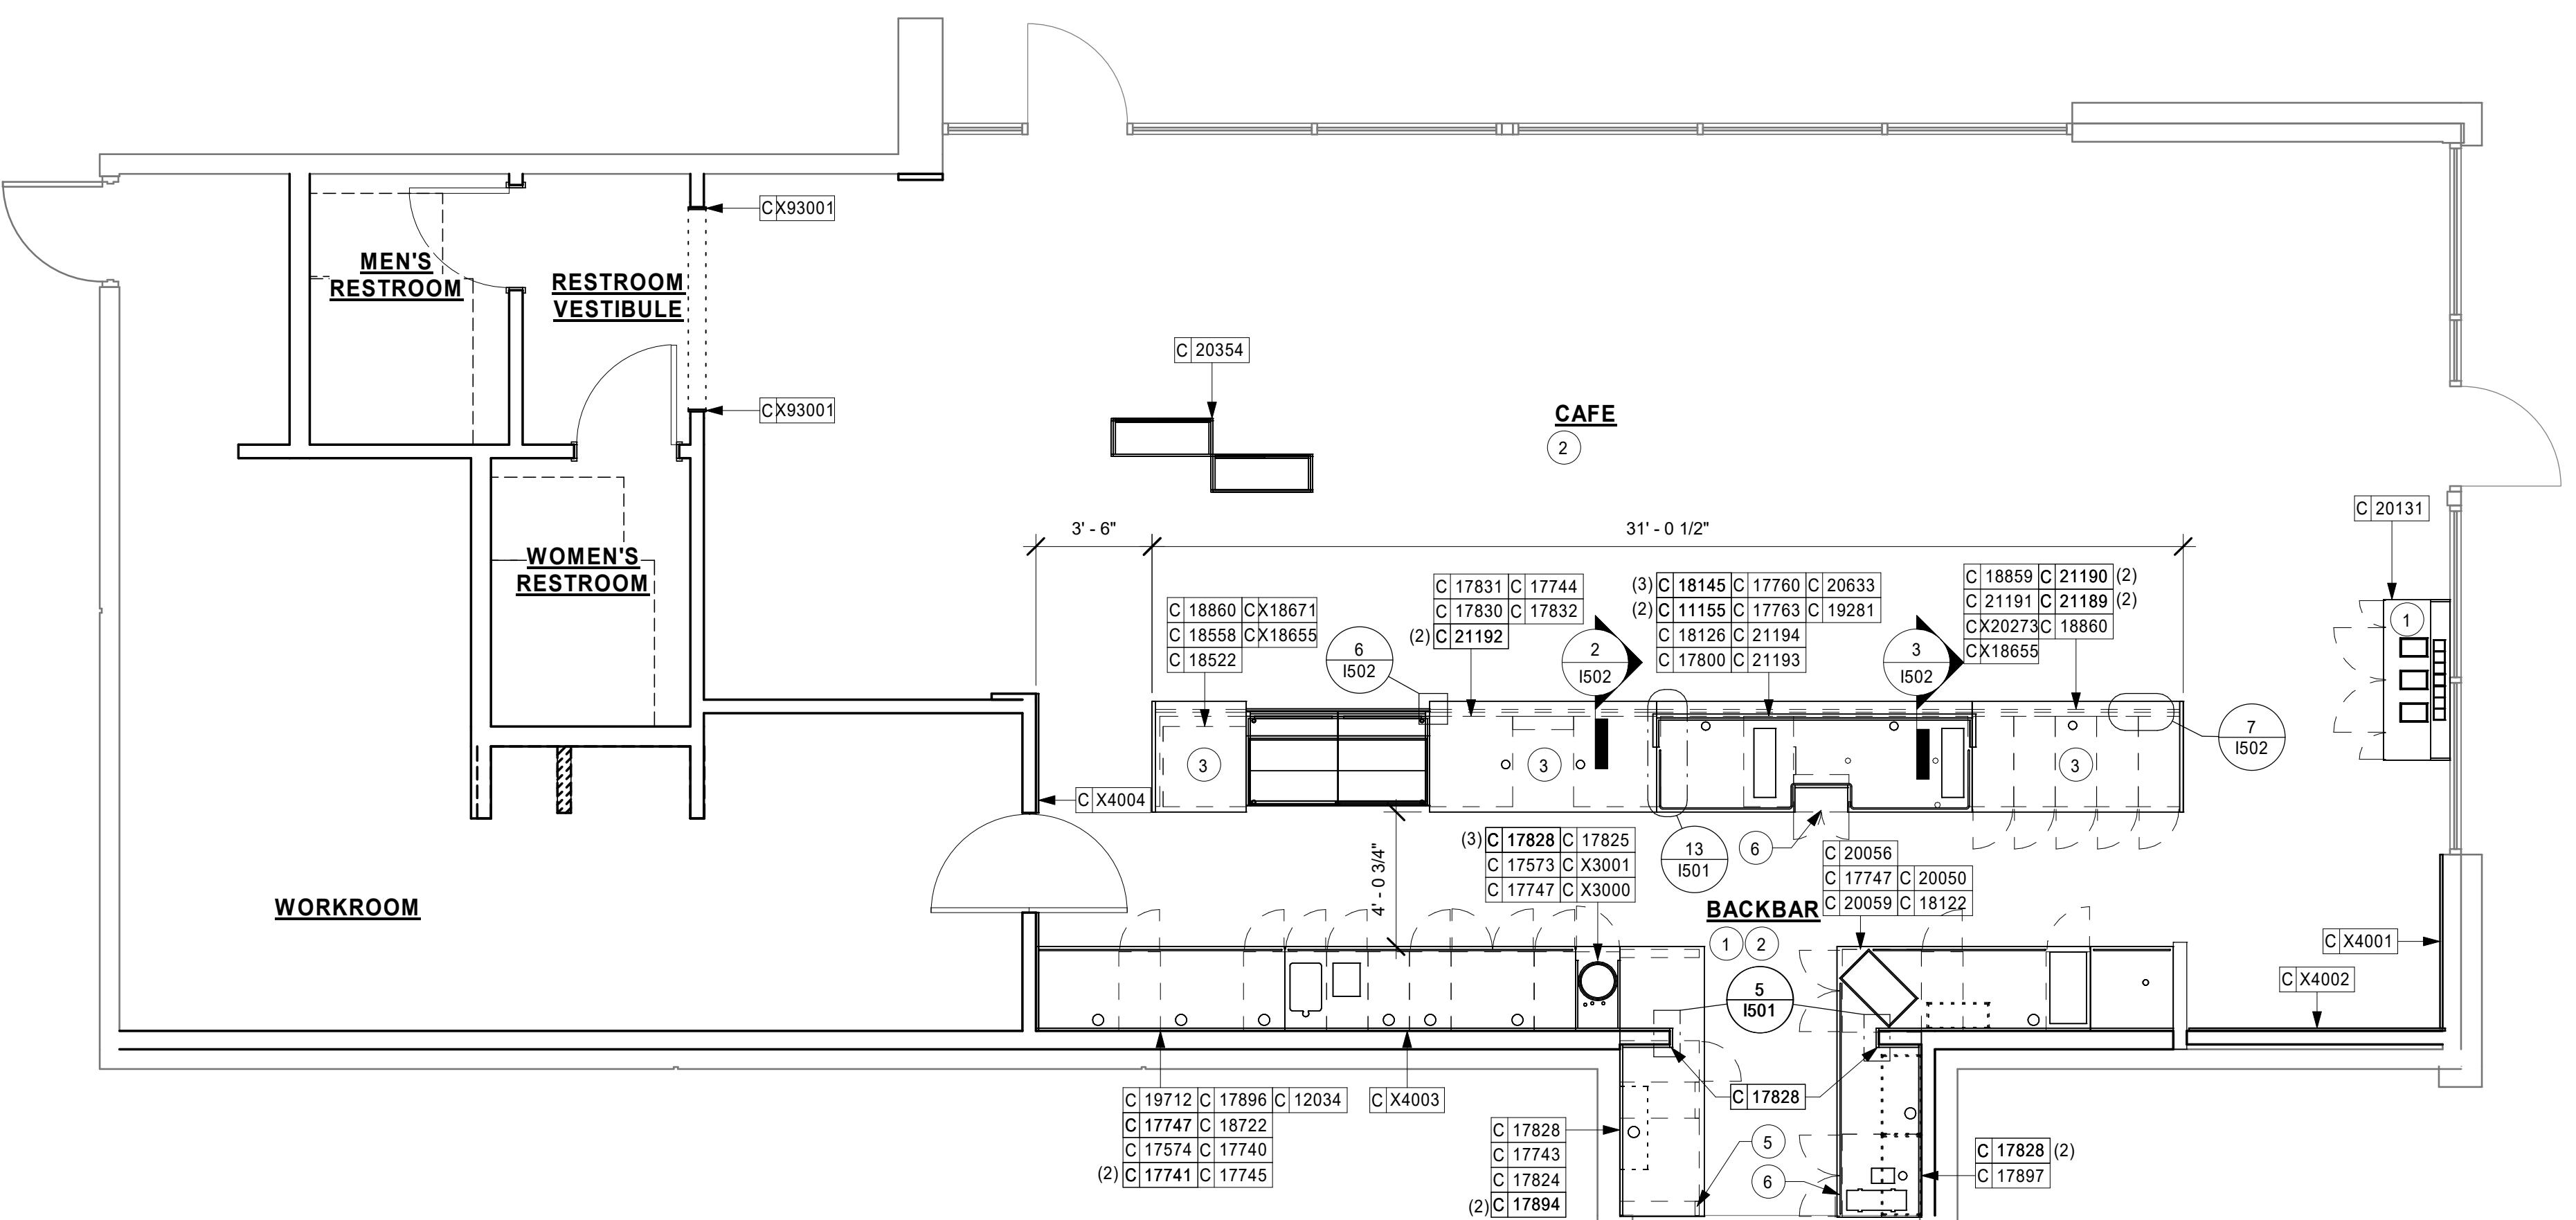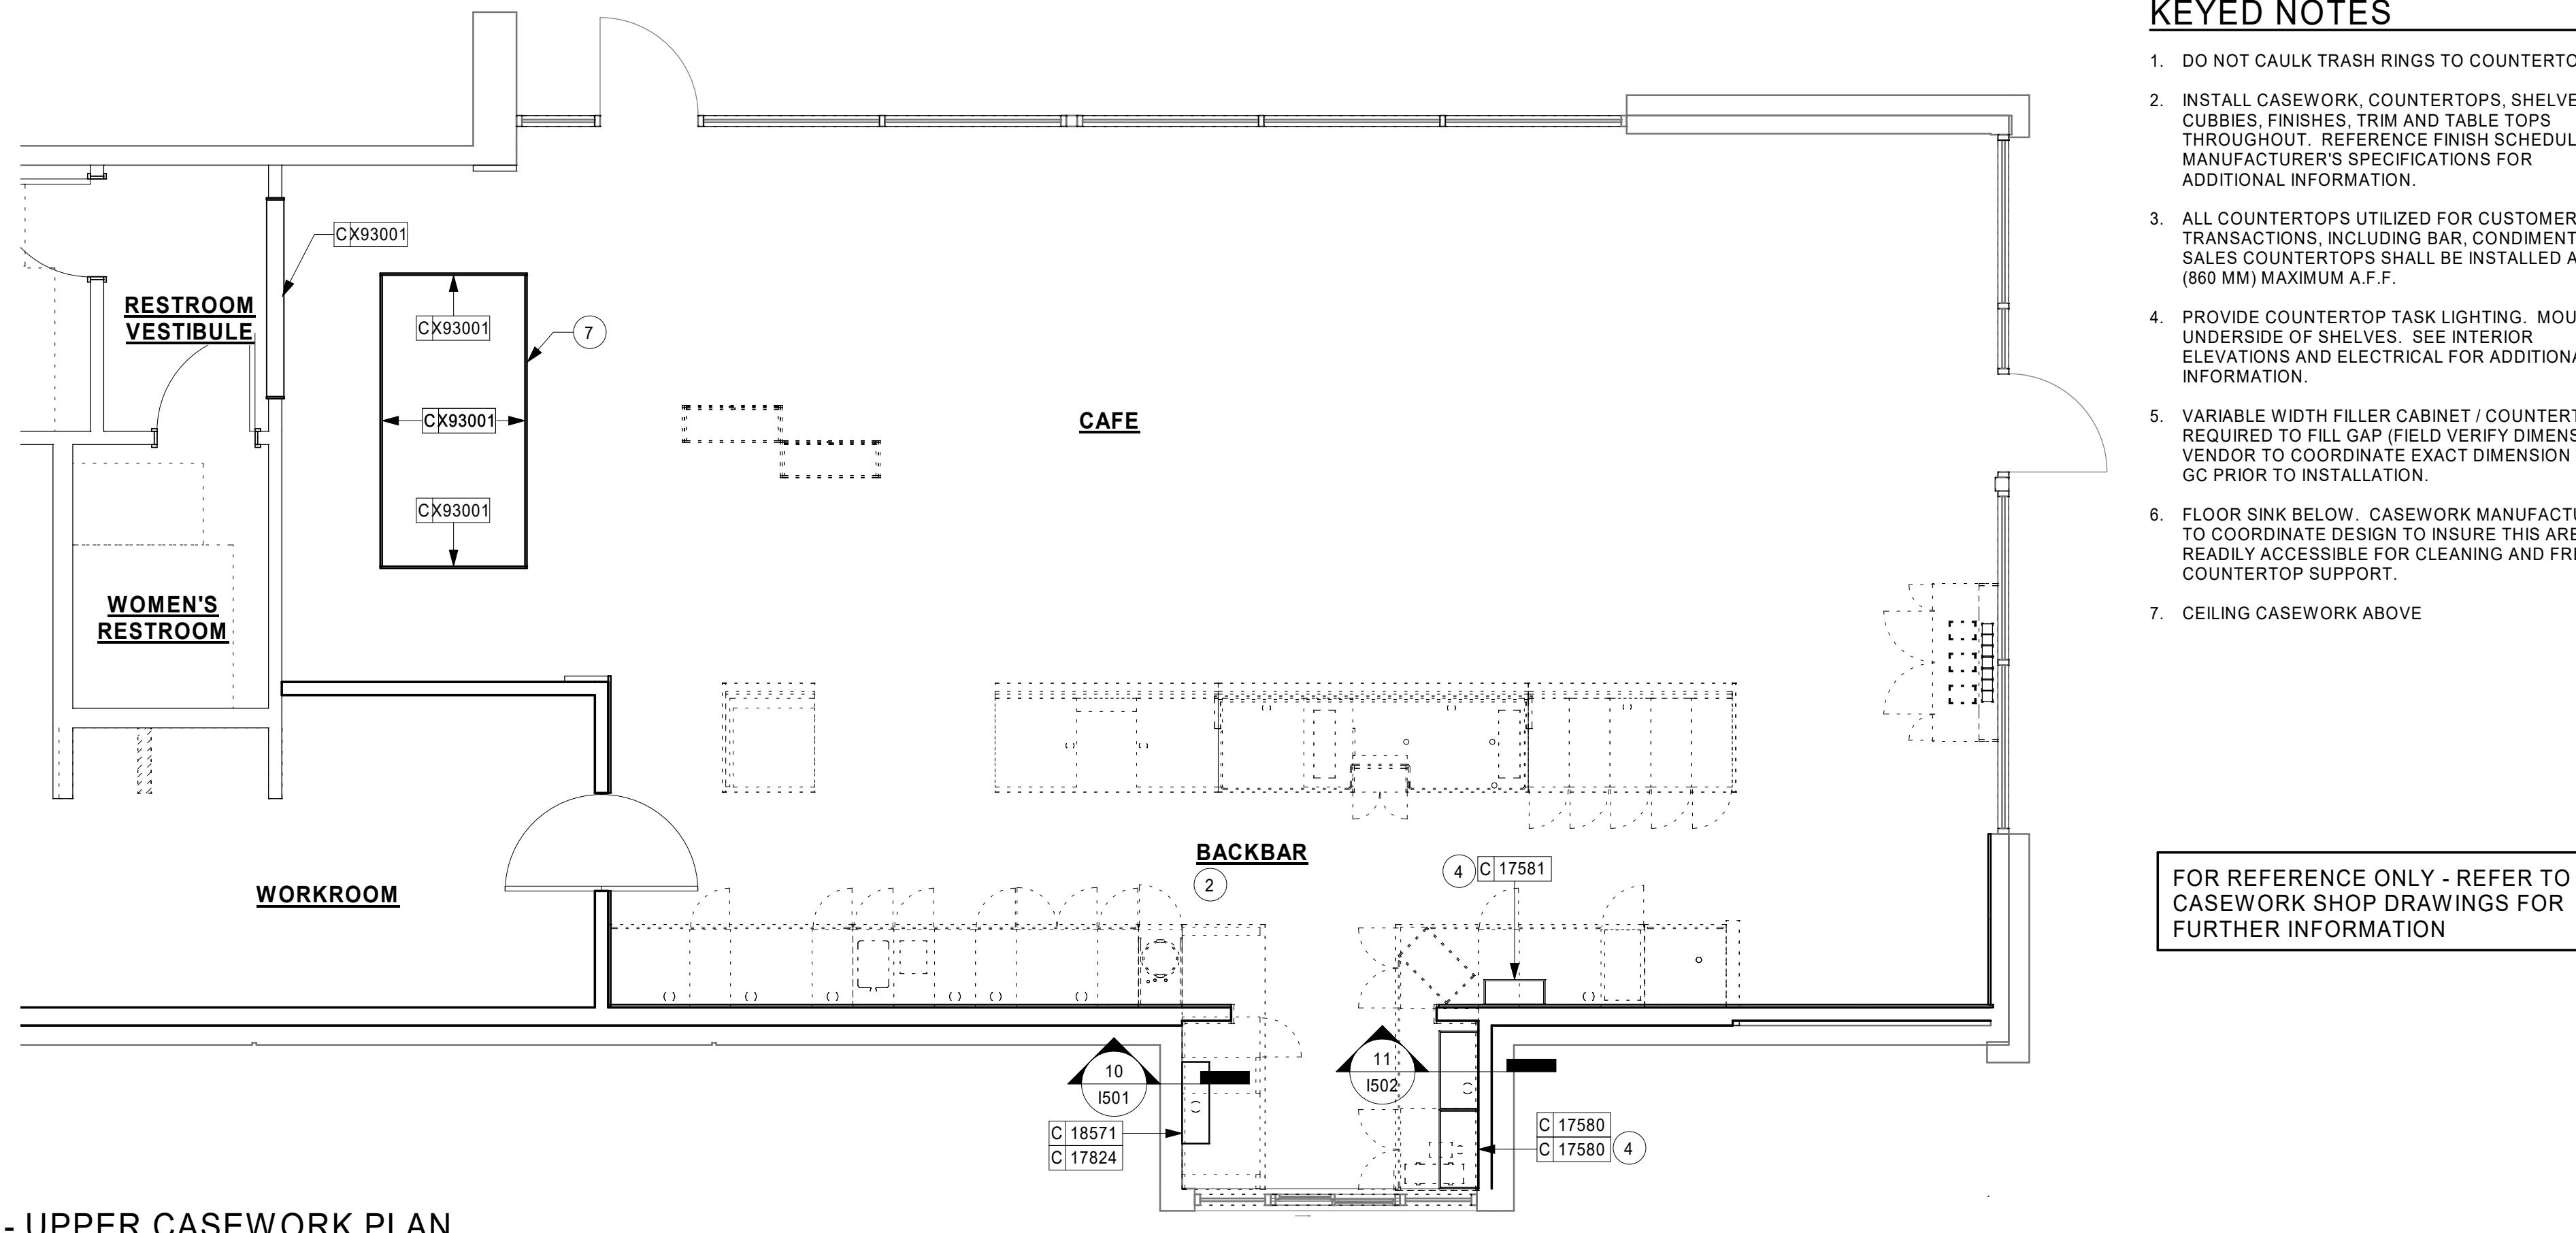



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STARBUCKS TEMPLATE VERSION: i2019-10-25



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P: 330-572-2100 F: 330-572-2101

GPD PROJECT NO: 2019355.20



MARK S. SALOPEK
AKRON, OH
NO. 6036

1/31/2020

GENERAL NOTES

- A. IF REQUIRED BY LOCAL CODE, GENERAL CONTRACTOR TO PROVIDE SEMI-RECESSED SPRINKLER HEADS WITH POLISHED CHROME ESCUTCHEONS CENTERED IN ACOUSTICAL CEILING TILE. IF PENDANT HEADS ARE REQUIRED IN GWB SOFFIT OVER FRONTBAR, CONCEAL SUPPLY PIPING WITHIN SOFFIT. GENERAL CONTRACTOR TO SUBMIT SPRINKLER LAYOUT TO STARBUCKS' CONSTRUCTION MANAGER FOR APPROVAL PRIOR TO INSTALLATION.
- B. LEAVE TEN (10) ADDITIONAL RETAIL CEILING TILES TO MATCH RETAIL CEILING PAINT COLOR ABOVE THE WORKROOM CEILING AT MANAGER'S DESK FOR FUTURE USE.
- C. PROVIDE GROMMET IN ACOUSTIC CEILING PENETRATIONS FOR FIXTURES OF SUPPORTS.
- D. HEATING, VENTILATING AND AIR CONDITIONING SHOWN ON THIS PLAN PROVIDED FOR REFERENCE ONLY. SEE MECHANICAL DRAWINGS FOR ADDITIONAL INFORMATION.
- E. DIFFUSERS AND RETURNS IN ACOUSTICAL CEILING TILE TO BE CENTERED IN TILE AND PAINTED TO MATCH ADJACENT FINISHES (TYP.).
- F. PAINT ALL EXPOSED HVAC DUCTS, HVAC DIFFUSERS, LIGHT TRIM RINGS, PIPING, CONDUIT AND JUNCTION BOXES THE SAME COLOR AS SPECIFIED ON SURROUNDING CEILING OR SOFFIT UNLESS OTHERWISE NOTED. TYPICAL THROUGHOUT RETAIL AREA OF STORE.
- G. PAINT SUBSTITUTIONS ARE NOT ALLOWED. USE STARBUCKS' NATIONAL ACCOUNT "COLOR CODE" WHEN ORDERING PAINTS.
- H. DATA CABLING ABOVE HEAD SHALL BE IN PLenum WHEN AVAILABLE.
- I. DATA CABLING AT EXPOSED CEILING SHALL BE INSTALLED IN METAL CONDUIT OR PER LOCAL CODE REQUIREMENT.

KEYED NOTES

1. BOTTOM OF TRACK TO BE 14'- 3"
2. GWB CEILING. PAINT CEILING DIFFUSERS AS INDICATED.
3. WASHABLE CEILING TILE LOCATED IN BACK OF HOUSE
4. OPEN TO STRUCTURE ABOVE. PAINT BOTTOM OF DECK AND TRUSS SW9140-ES
5. PLATFORM FOR HEATER AND WATER FILTRATION. PROVIDE SOFFIT AND LIFT CEILING THIS AREA ONLY TO INSURE ADEQUATE CLEARANCE FOR SERVICING.
6. 2X4 LIGHT TROFFER, SEE ELECTRICAL, TYP.
7. ACOUSTIC PANEL ATTACHED TO DECKING. PAINTED SW9140-ES. PANEL NOT TO EXTEND PAST FACE OF BAR BELOW
8. EXIT LIGHTING. SEE ELECTRICAL, TYP.
9. ROOF LADDER AND ACCESS HATCH TO BE PROVIDED BY LANDLORD - COORDINATE INSTALLATION.
10. PENDANT LIGHTING - SEE INTERIOR ELEVATIONS FOR MOUNTING HEIGHT
11. MOUNT CEILING SPEAKER FLUSH WITH CEILING
12. PENDANT SPEAKER, MOUNTED 15'-0" A.F.F.
13. COORDINATE SOFFIT EXTENT BASED ON DETAIL AT TRUSS

LEGEND

	ELEVATION DATUM
	TRACK LIGHTING
	PENDANT LIGHT
	RECESSED CAN LIGHT
	TROFFER
	EXIT SECURITY LIGHT
	MUSIC SYSTEM PENDANT SPEAKER
	WIFI ACCESS POINT (WAP)

PROJECT NAME:
HWY 101 - COOS BAY

PROJECT ADDRESS:
101, COOS BAY VILLAGE
COOS BAY, OR 97420


STORE #: 60983
PROJECT #: 60983-001
ISSUE DATE: 01-29-20 - 100 percent
DESIGN MANAGER: RYAN WONG
PRODUCTION DESIGNER: GPD
CHECKED BY: TC

Revision Schedule			
Rev	Date	By	Description

SHEET TITLE:
**REFLECTED CEILING
PLAN**

SCALE: AS SHOWN

SHEET NUMBER:
1103

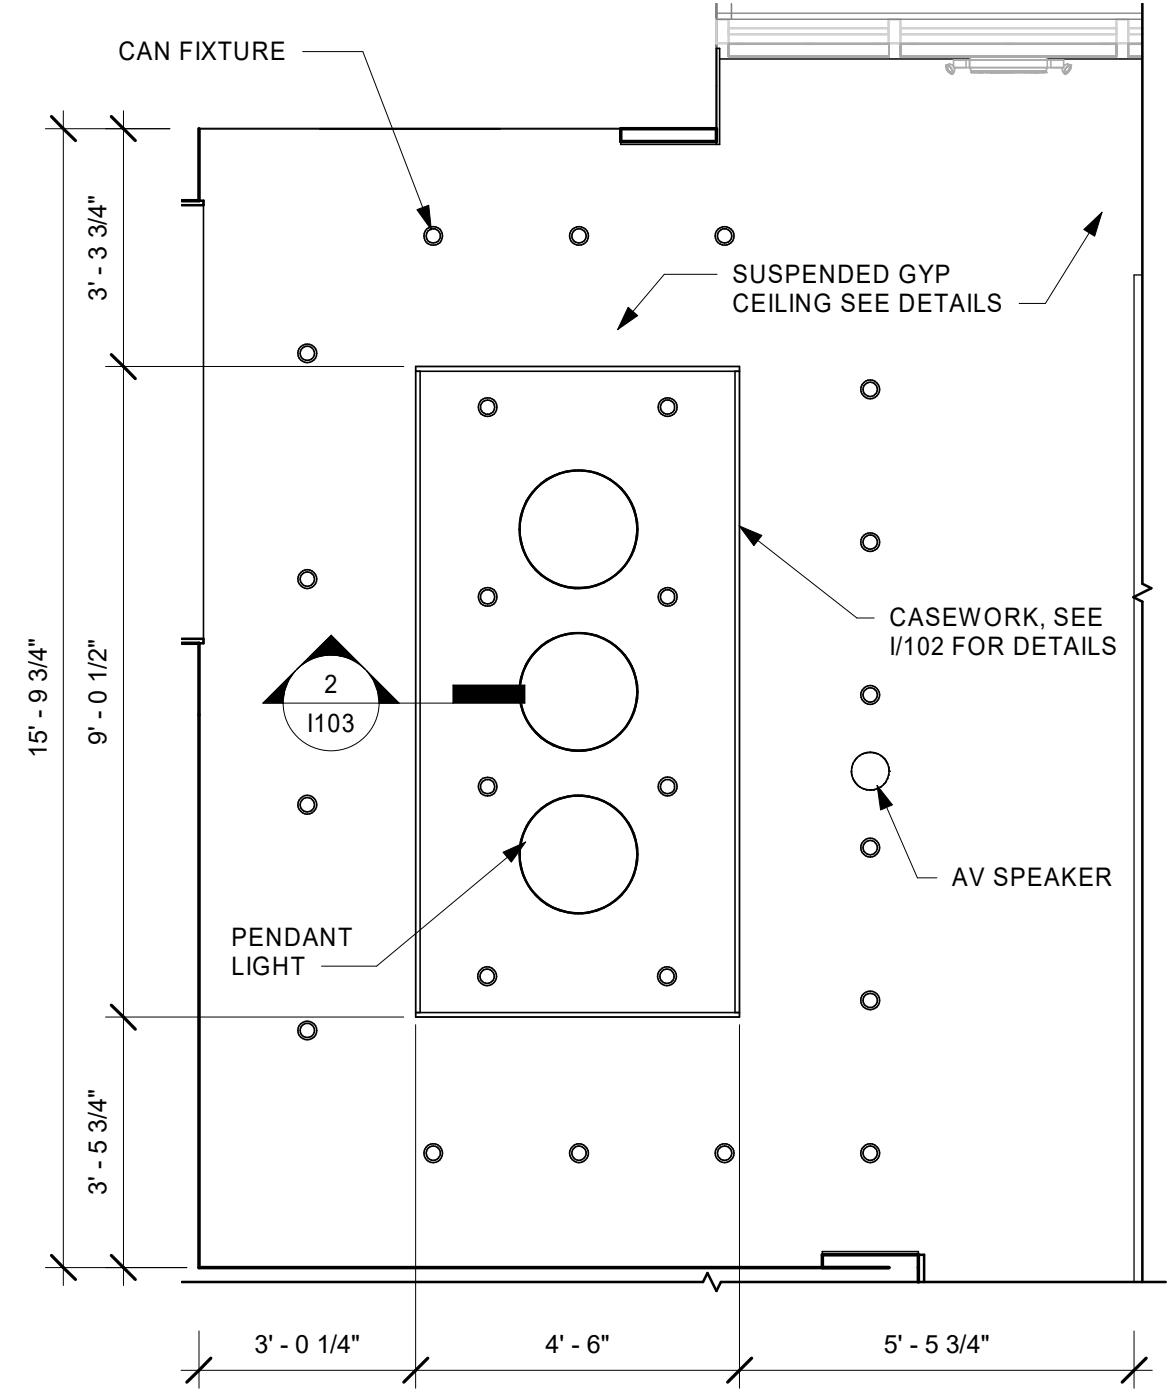


2 COMMUNITY TABLE CEILING CASEWORK

Scale: 1 1/2" = 1'-0"

3 COMMUNITY TABLE SOFFIT DIMENSIONS

Scale: 3/8" = 1'-0"

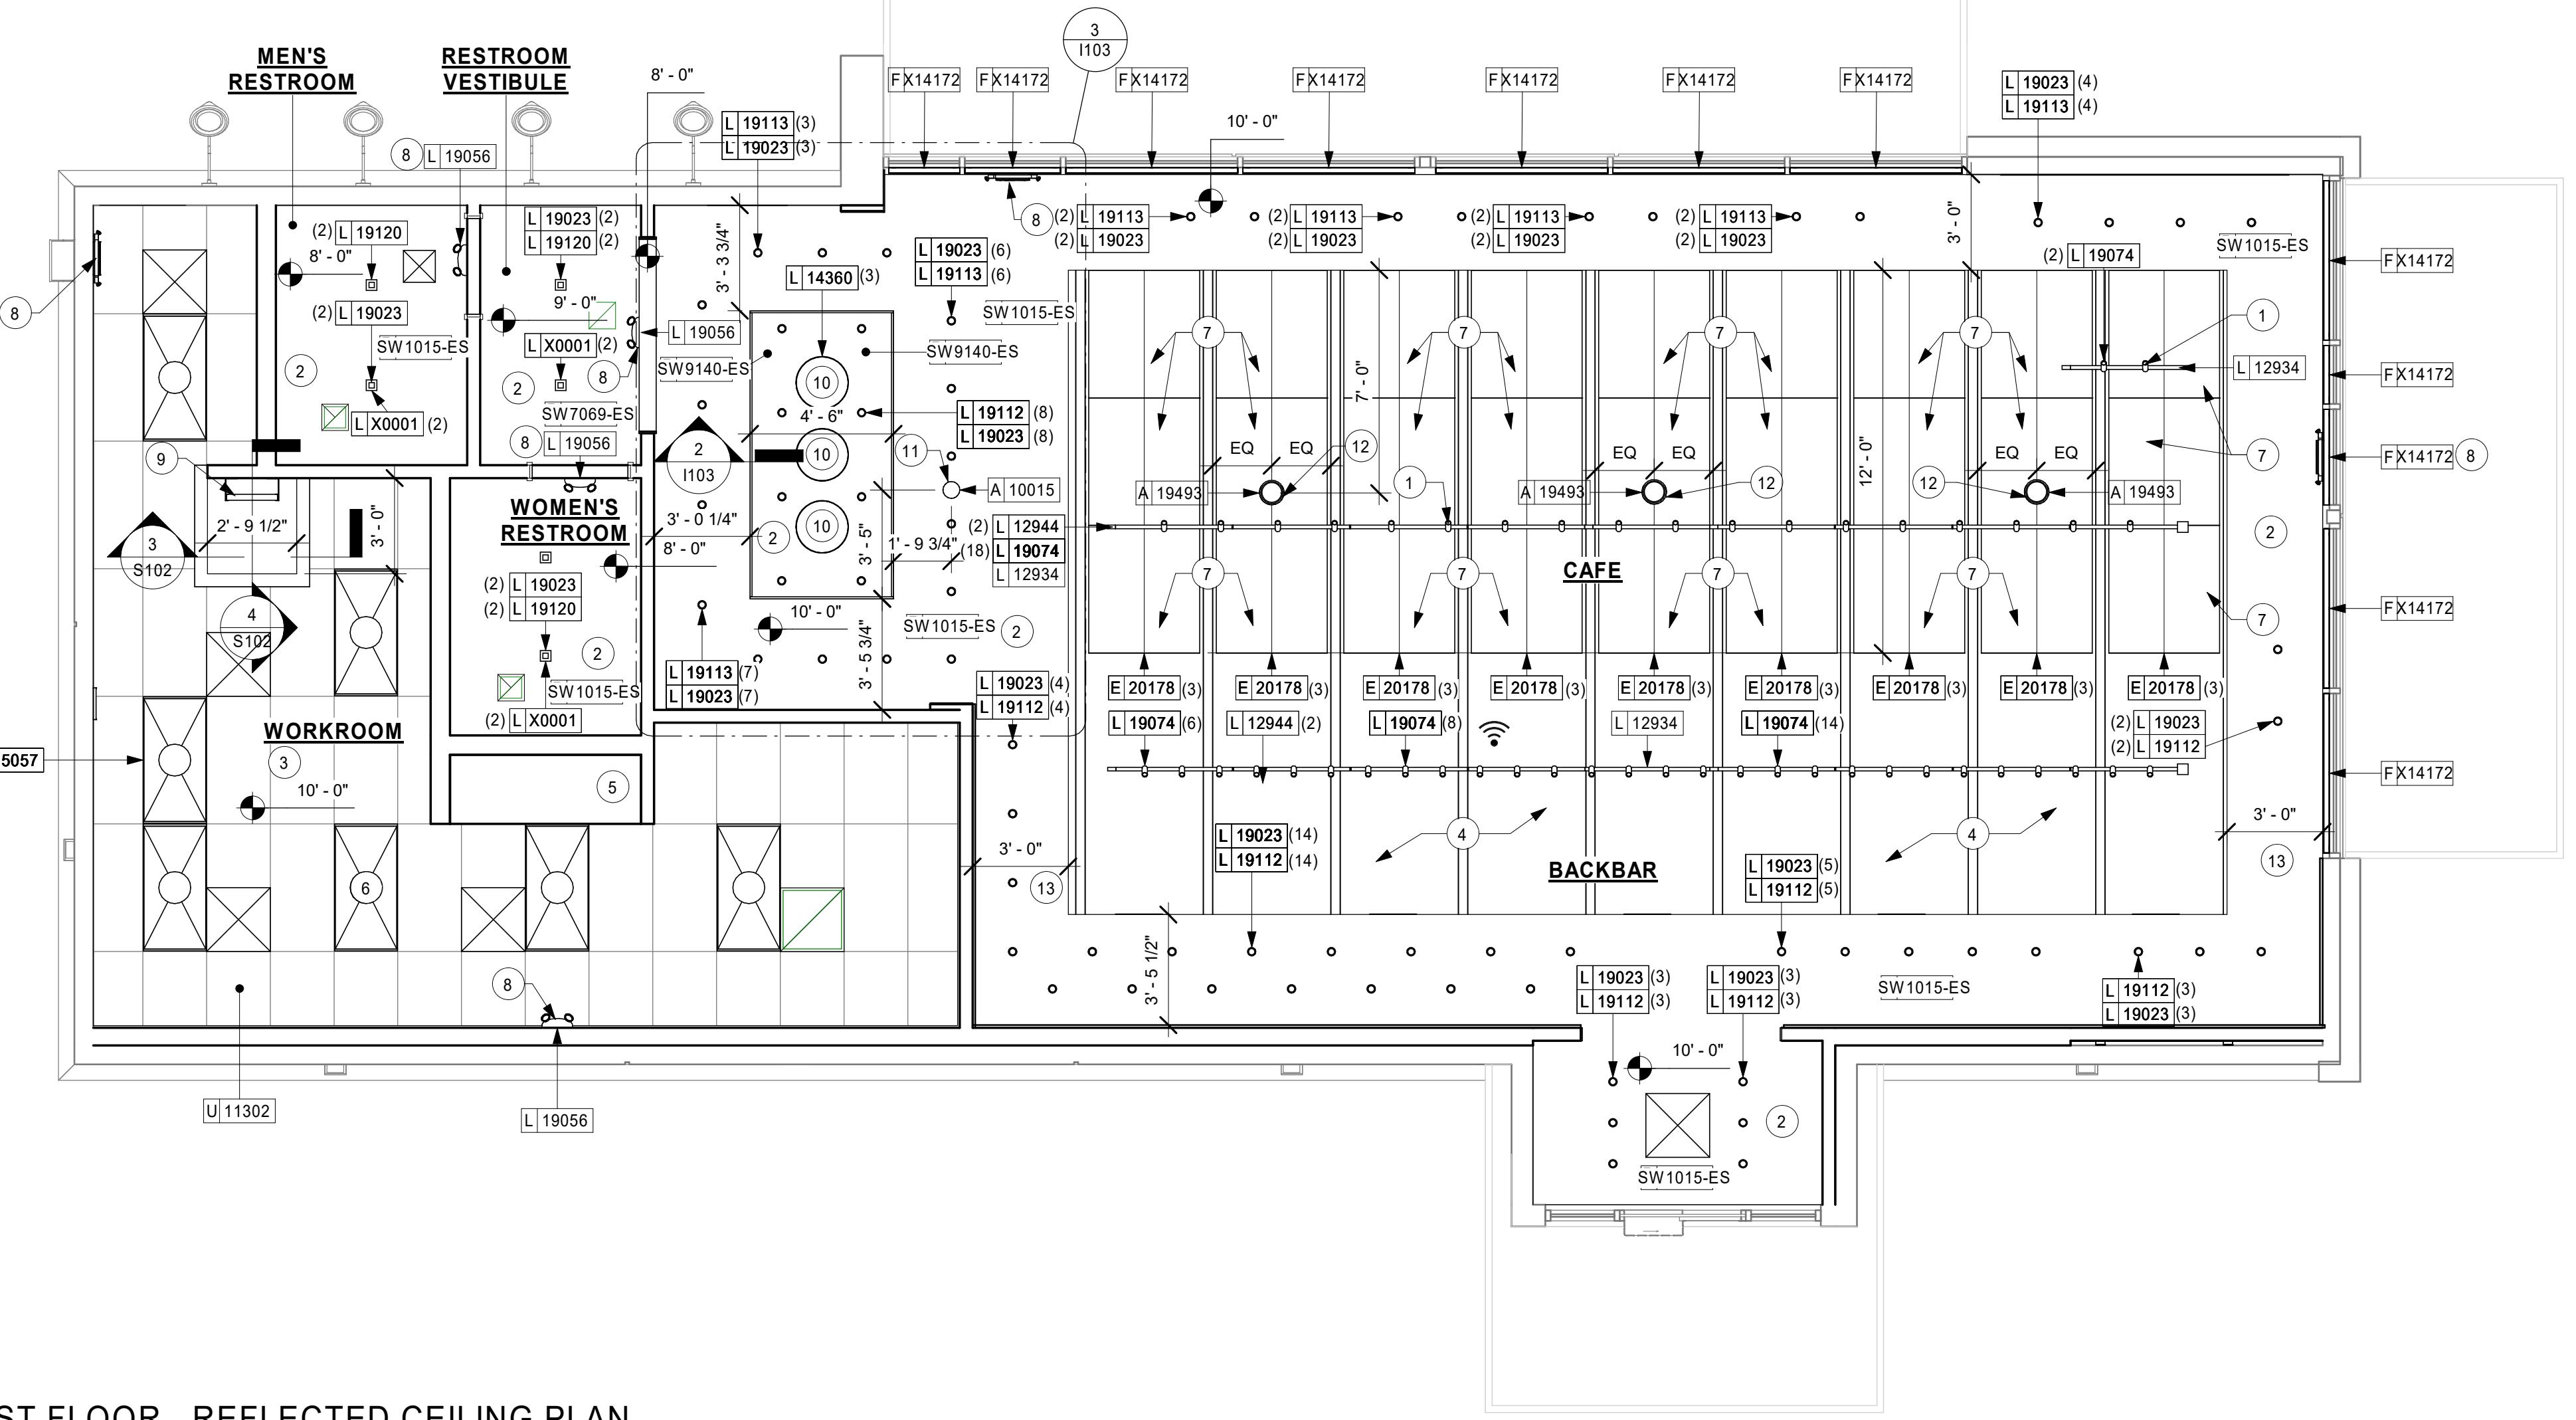


RESPONSIBILITY LEGEND

GC GENERAL CONTRACTOR
LL LANDLORD
SB STARBUCKS



Scale: 1/4" = 1'-0"

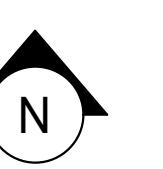



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REGISTERED ARCHITECT
• MARK S. SALOPEK
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STATE OF OREGON 1/31/2020
Mark Salopek

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CHECKED BY: TC

Revision Schedule

Rev	Date	By	Description

SHEET TITLE:
LIGHTING PLAN
SCALE: AS SHOWN
SHEET NUMBER:
I103B

LIGHTING PLAN NOTES

- A. IF REQUIRED BY LOCAL CODE, GENERAL CONTRACTOR TO PROVIDE SEMI-RECESSED SPRINKLER HEADS WITH POLISHED CHROME ESCUTCHEONS CENTERED IN ACOUSTICAL CEILING TILE. IF PENDANT HEADS ARE REQUIRED IN GYPSUM SOFFIT OVER FRONTBAR, CONCEAL SUPPLY PIPING WITHIN SOFFIT. GENERAL CONTRACTOR TO SUBMIT SPRINKLER LAYOUT TO STARBUCKS' CONSTRUCTION MANAGER FOR APPROVAL PRIOR TO INSTALLATION.
- B. GENERAL CONTRACTOR TO PROVIDE AND LOCATE SPRINKLERS PER LOCAL CODES. CONTACT STARBUCKS CONSTRUCTION MANAGER IF DESIGN INTENT IS AFFECTED.
- C. WHERE ACOUSTICAL CEILING MEETS WALL, PROVIDE ANGLE WALL MOLDING FOR REVEAL. MATCH CEILING GRID COLOR WHEN APPLICABLE.
- D. LEAVE (10) ADDITIONAL RETAIL CEILING TILES, TO MATCH RETAIL CEILING PAINT COLOR, ABOVE THE WORKROOM CEILING AT MANAGER'S DESK FOR FUTURE USE.
- E. PROVIDE GROMMET AT ALL CEILING PENETRATIONS FOR FIXTURES OR SUPPORTS.
- F. HEATING, VENTILATING, AND AIR CONDITIONING (HVAC) SHOWN FOR DESIGN INTENT ONLY. CONTACT PROJECT MANAGER IF CHANGED.
- G. DIFFUSERS AND RETURNS AT BACKBAR IN ACOUSTICAL CEILING TILE TO BE CENTERED IN TILE, PAINTED TO MATCH ADJACENT FINISHES, TYPICAL.
- H. PAINT ALL EXPOSED HVAC DUCTS, HVAC DIFFUSERS, RECESSED SPEAKERS, LIGHT TRIM RINGS, PIPING, CONDUIT AND JUNCTION BOXES THE SAME COLOR AS SPECIFIED ON SURROUNDING CEILING OR SOFFIT UNLESS NOTED OTHERWISE. TYPICAL THROUGHOUT RETAIL AREA OF STORE.
- J. PAINT SUBSTITUTIONS ARE NOT ALLOWED. USE STARBUCKS' NATIONAL ACCOUNT "COLOR CODE" WHEN ORDERING PAINTS.
- K. SEE LIGHTING DESIGN PLAN FOR LIGHTING SCHEDULE, FIXTURE TYPES AND DIMENSIONED LOCATIONS.
- L. ADJUST EACH TRACK HEAD AT MENU BOARD LIGHTING SO LIGHT BEAMS ARE POINTING CONSISTENTLY, JUST BELOW THE CENTER OF EACH MENU BOARD PANEL.. ADJUST FOCUS OF ALL TRACK AND RECESSED DIRECTIONAL LIGHTING TO FULLY ILLUMINATE ALL ARTWORK, MENU BOARDS, AND MERCHANDISE BAYS.
- M. ALL FIXTURES IN FOOD PREPARATION AREA SHALL HAVE SHATTERPROOF LAMPS IF THE FIXTURE IS NOT LENSED.
- N. CENTER EMERGENCY/EXIT LIGHTS ABOVE DOORS, UON.

SHEET NOTES

1. OPEN STRUCTURE ABOVE
2. EXPOSED STRUCTURE AND DUCTWORK TO BE PAINTED AS SCHEDULED

LIGHTING LEGEND



- ▲ TRACK HEAD: FLOOD (2" HOUSING DID 19074)
- CAN FIXTURE: SPOT (2", DID 19112)
- CAN FIXTURE: NARROW FLOOD (2" DID 19113)

RESPONSIBILITY LEGEND

- GC GENERAL CONTRACTOR
LL LANDLORD
SB STARBUCKS



Scale: 1/4" = 1'-0"

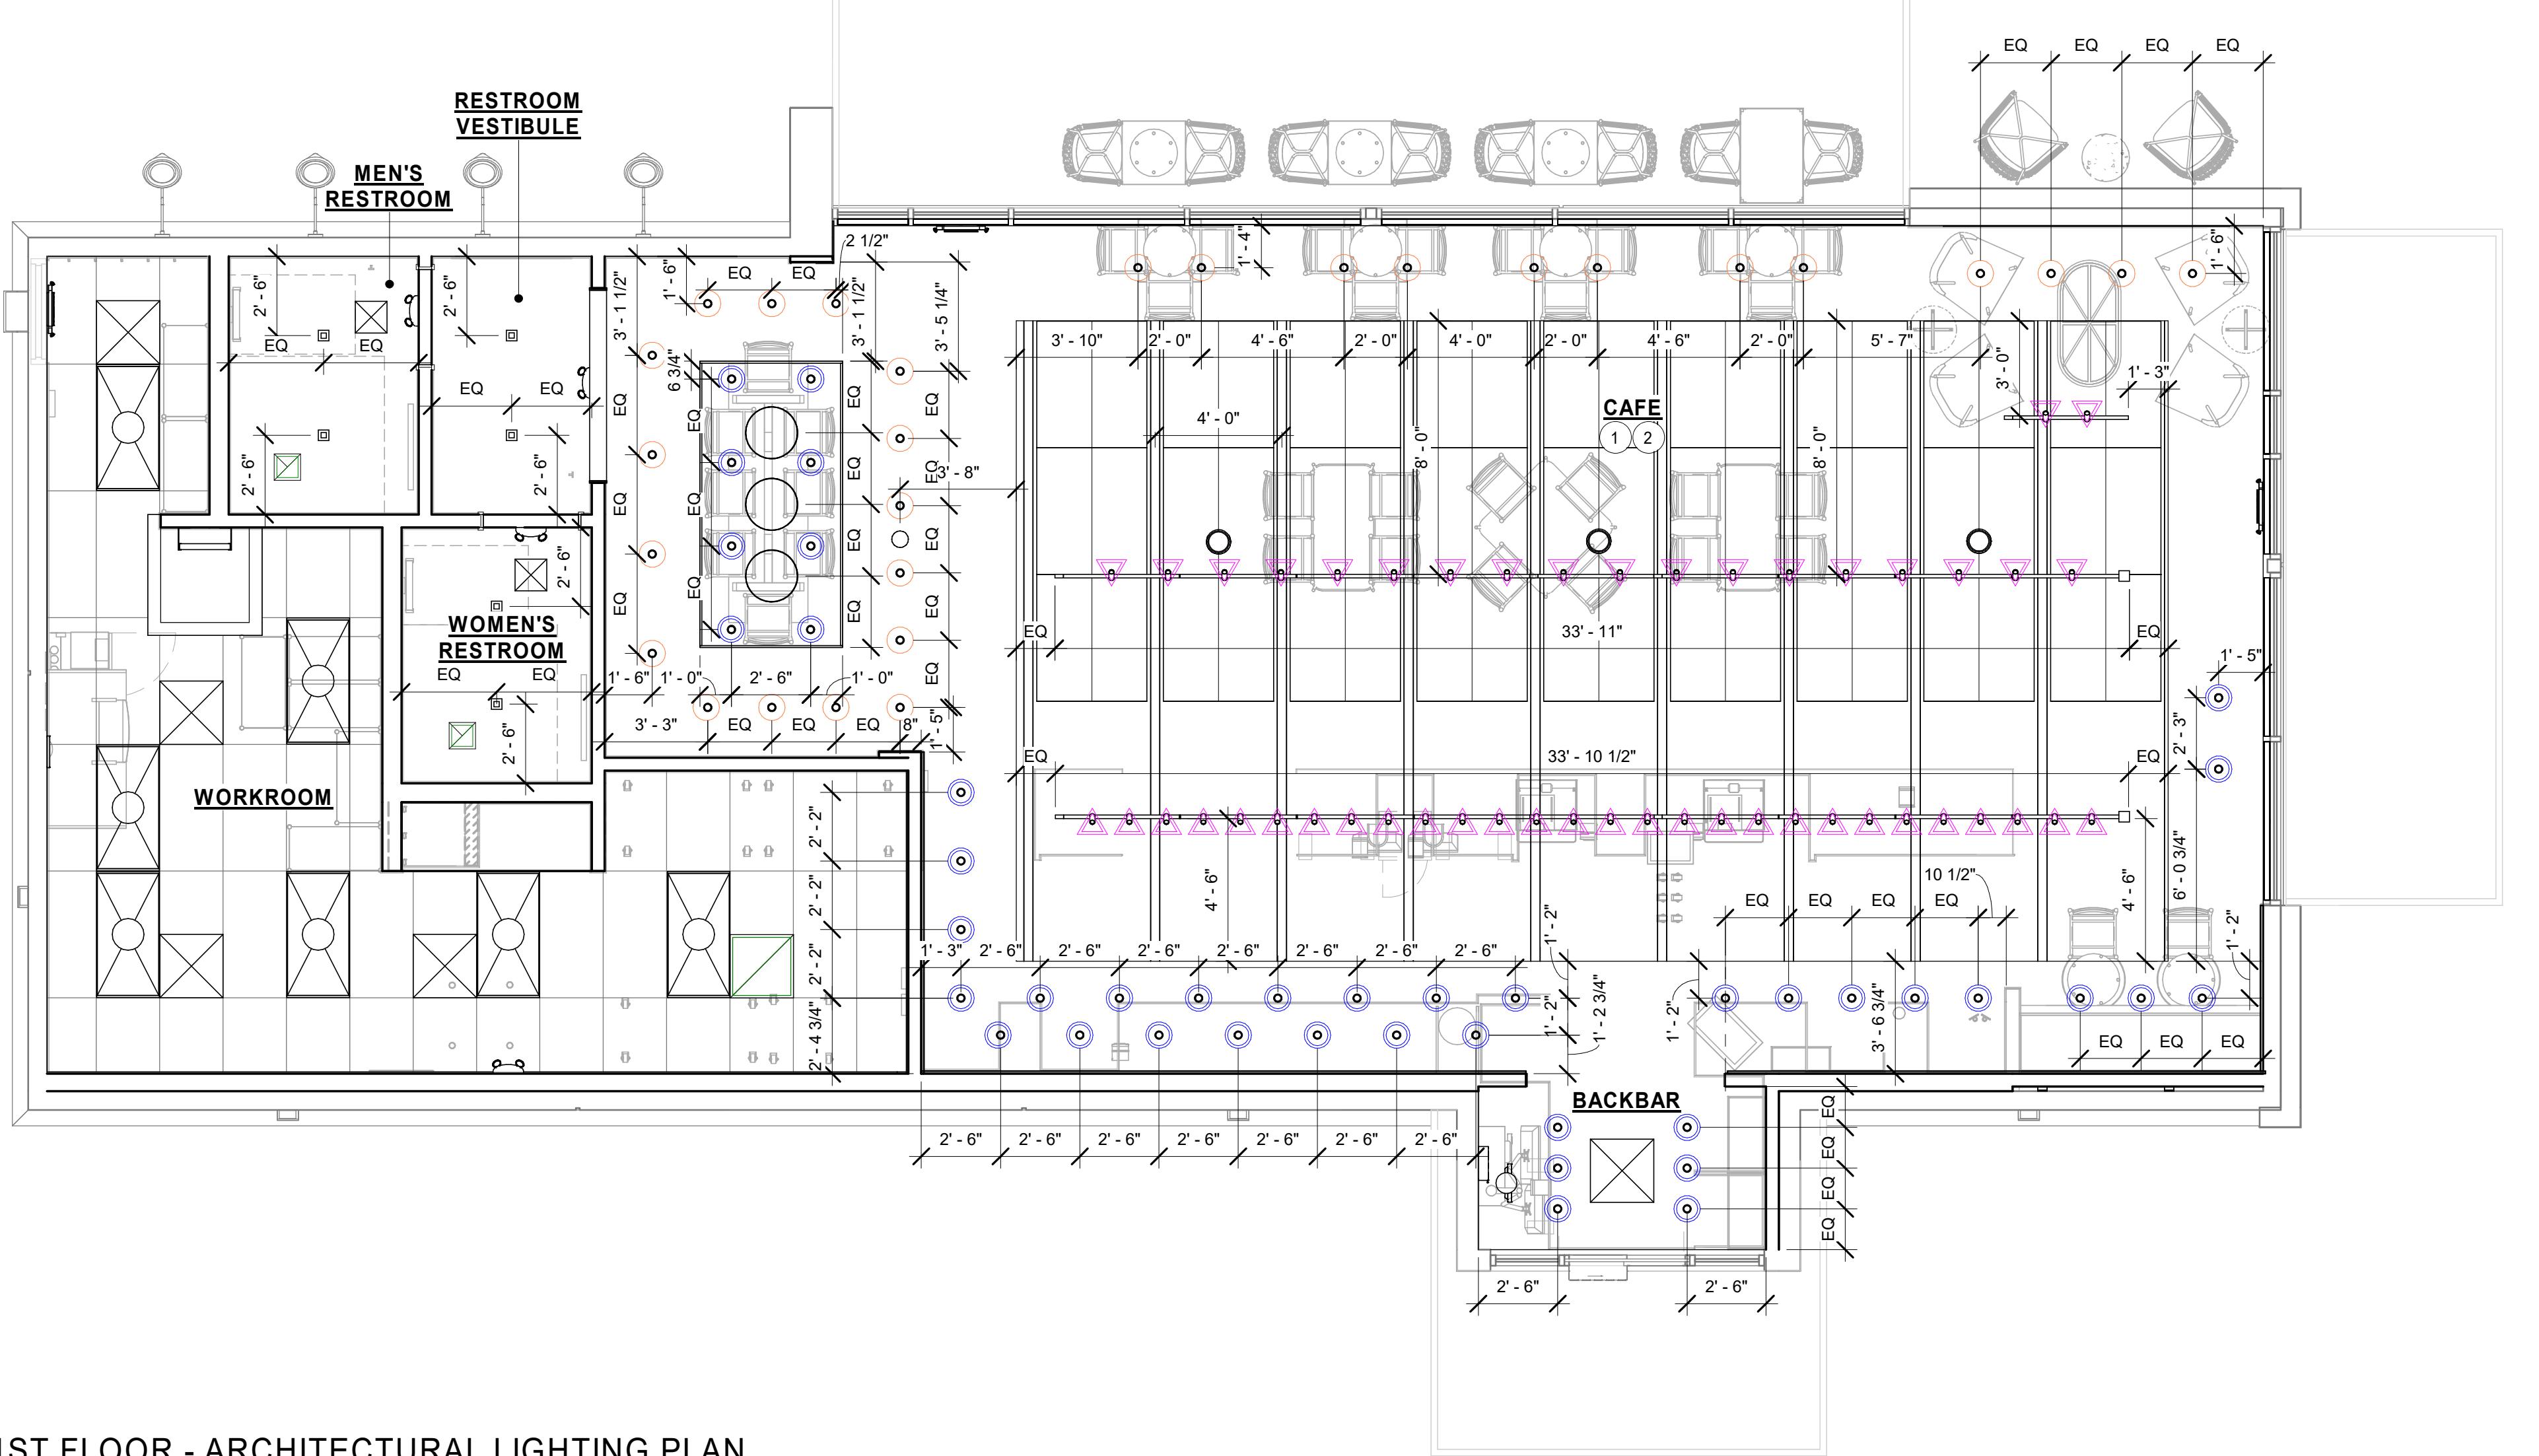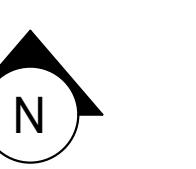



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CONCRETE FINISH NOTES

FINISHING PROCESS FOR CONCRETE SLAB

- INTEGRAL GRINDING WILL BEGIN AT A MINIMUM OF 36 HYBRID BOND DIAMOND Grit. AFTER A UNIFORM SCRATCH PATTERN HAS BEEN DEVELOPED IN THE SURFACE OF THE CONCRETE; BEGIN GRINDING THE FLOOR UP TO A DIAMOND Grit ACCEPTABLE FOR DENSIFYING, LEVEL OF FINISH TO BE [OPEN AGGREGATE, SALT & PEPPER, LIGHT SAND], GC TO HAND GRIND OR USE A STAND-UP EDGER FOR GRINDING/POLISHING EDGE AND INSIDE CORNER CONDITIONS.
- CLEAN FLOOR WITH VEXCON CERTI-SHINE CLEAR DENSIFIER APPLIED IN MULTIPLE COATS.
- AFTER THE DENSIFIER HAS CURED, RINSE THE FLOOR WITH VEXCON CERTI-SHINE FIXATIVE, REMOVING UN-REACTIONED SILICATES FROM THE SURFACE OF THE CONCRETE AND IMPROVING THE CHEMICAL AND STAIN RESISTANCE OF THE POLISHED CONCRETE SYSTEM.
- ONCE THE RINSE HAS BEEN COMPLETED CONTINUE POLISHING THE FLOOR UP TO A 400 Grit POLISH.
- CLEAN FLOOR AGAIN AND APPLY A VEXCON CERTI-SHINE FINISH COAT ULTRA WB IN MULTIPLE COATS. ALLOWING FOR OPTIMAL PENETRATION.
- AFTER THE STAIN PROTECTANT HAS CURED, BURNISH THE FLOOR WITH A HIGH SPEED BUFFER.

POLISHING PROCEDURE :

- ADHERE TO INDUSTRY STANDARD POLISHING PROCEDURES FOR DRY AND WET GRINDING/POLISHING IS ACCEPTABLE WHEN INDUSTRY STANDARD POLISHING PROCEDURES ARE ADHERED TO.
- SCRUB AND RINSE SLAB SURFACE WITH CLEAN WATER AND VACUUM WITH AUTO-SCRUBBER BETWEEN AND AFTER FINAL POLISHING PASSES..
- SEQUENTIAL PROGRESSION OF DIAMOND POLISHING STEPS SHALL BE REQUIRED AND LIMITED TO NO MORE THAN DOUBLE THE GRIT VALUE OF THE PREVIOUS DIAMONDS USED.
- OVERLAP ADJACENT POLISHING PASSES BY 25 PERCENT
- PERFORM EACH PASS PERPENDICULAR TO THE OTHER PASS NORTH/SOUTH THEN EAST/WEST; MULTIPLE PASSES MAY BE NEEDED.
- PROGRESSIVELY GRIND AND POLISH THE SLAB SURFACE UTILIZING APPROVED DIAMOND SEGMENTS AS NECESSARY TO PRODUCE FINISHING REQUIREMENTS.

PREPARATION :

- Clean dirt, dust, oil, grease and other contaminants that interfere with penetration or performance of specified product from surfaces. Use appropriate concrete cleaners approved by the concrete surface treatment manufacturer where necessary. Rinse thoroughly using pressure water spray to remove cleaner residues. Allow surfaces to dry completely before application of product.
- Repair, patch and fill cracks, voids, defects and damaged areas in surface as approved by the Architect. Allow repair materials to cure completely before application of product.
- Variations in substrate texture and color will affect final appearance and should be corrected prior to application of sealer/hardener system and the polishing steps.
- Protect surrounding areas prior to application of densifiers and stains. If products are accidentally misapplied to adjacent surfaces, flush with water immediately before material dries.
- Avoid contact in areas not to be treated. Avoid contact with metal, glass and painted surfaces.
- Apply specified sealants and caulking and allow complete curing before application of penetrating concrete hardener/densifier.
- Test surfaces with droplets of water. If water beads and does not penetrate surface, or penetrates only in some areas, profile surfaces by grinding, sanding, or abrasive blasting. Retest and continue profiling surface until water droplets immediately darken and uniformly penetrate concrete surfaces.

KEYED NOTES

1. FLOOR SINK LOCATION. SEE BUILDING FLOOR PENETRATION PLAN ON SHEET A102 AND PLUMBING FOR ADDITIONAL INFORMATION.
2. RECESSED WALK-OFF MAT AT ENTRY. SEE INTERIOR DETAIL SHEETS FOR TRANSITION.
3. MOP SINK WHERE INDICATED. SEE PLUMBING PLANS FOR MORE INFORMATION.
4. GREASE INTERCEPTOR, SEE PLUMBING PLANS FOR MORE INFORMATION.

GENERAL NOTES

- A. WORKROOM TO BE FINISHED PER LOCAL CODE REQUIREMENTS.
- B. FLOORS, WALLS AND CEILING FINISHES IN FOOD PREPARATION AREAS SHALL BE SMOOTH, NON-TOXIC, NON-ABSORBENT, DURABLE AND EASILY CLEANABLE. PAINT SHALL BE WASHABLE; SEMI-GLOSS OR HIGH-GLOSS FINISH.
- C. STARBUCKS TO SUPPLY FLOORING AND BASE FOR FRONT AND BACK OF HOUSE AS NOTED IN SCHEDULES. GENERAL CONTRACTOR TO INSTALL. GENERAL CONTRACTOR TO SUPPLY WORKROOM TILE AND BASE AND INSTALL. GENERAL CONTRACTOR TO SUPPLY AND INSTALL MORTAR, ADHESIVE, AND GROUT. GENERAL CONTRACTOR TO INSPECT ALL TILES AND REJECT DAMAGED OR SUBSTANDARD TILES PRIOR TO INSTALLATION.
- D. ALIGN TILE TRANSITIONS ON WHOLE TILES AS SHOWN.

- E. ALL FLOOR AND WALL JUNCTIONS IN STORAGE AND FOOD PREPARATION AREAS SHALL HAVE A 6" COVED BASE.

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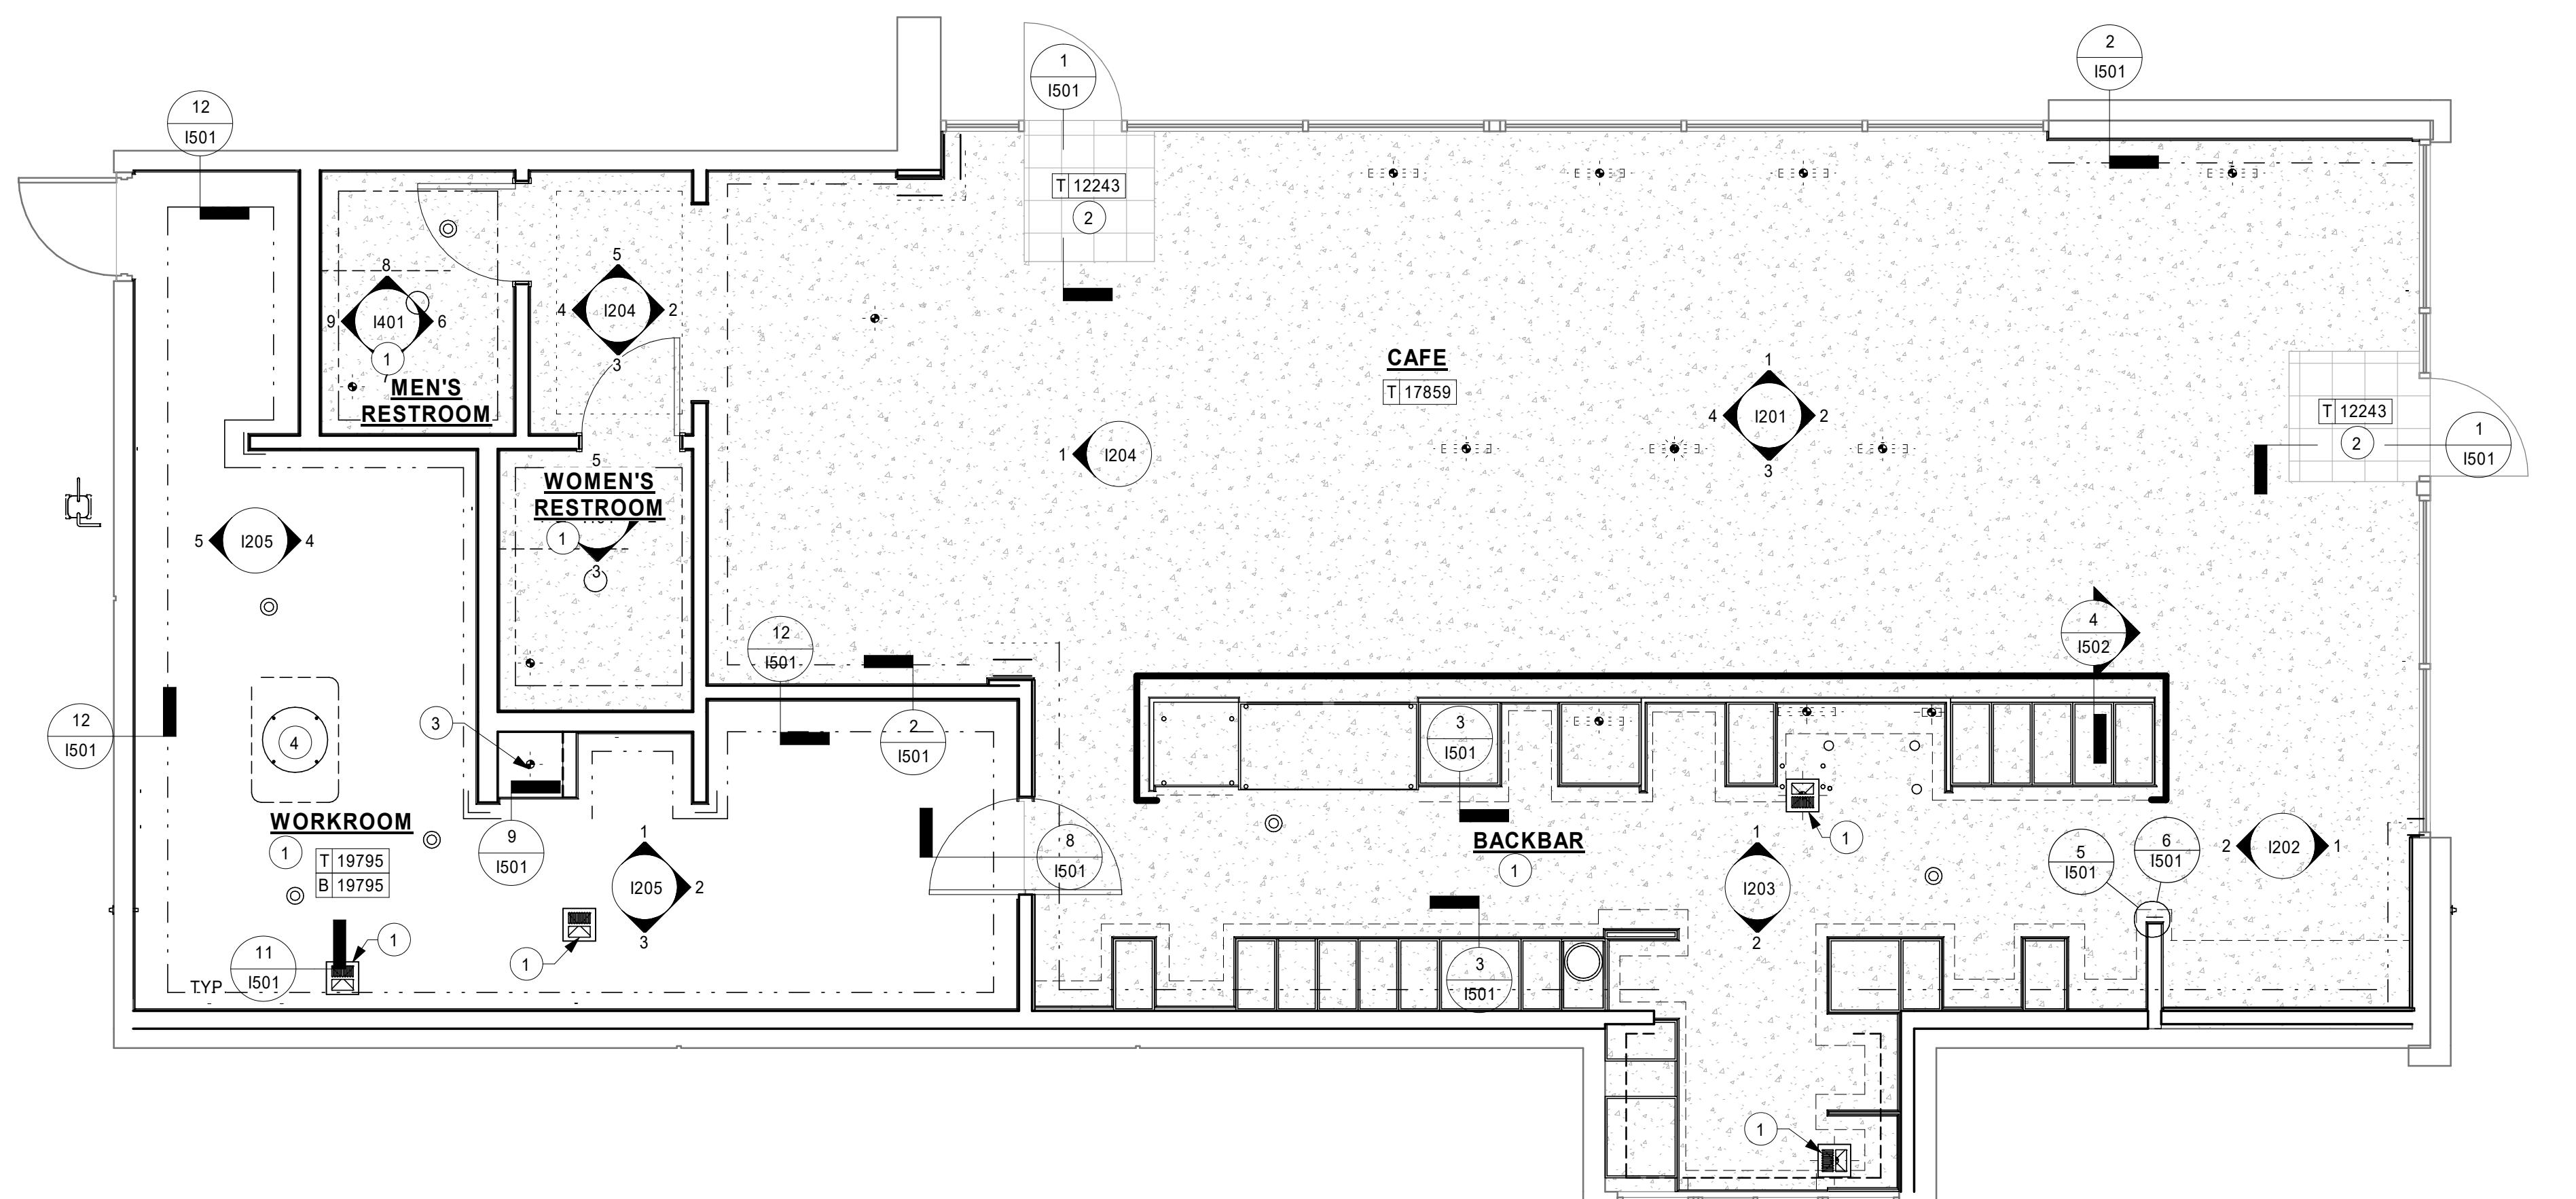
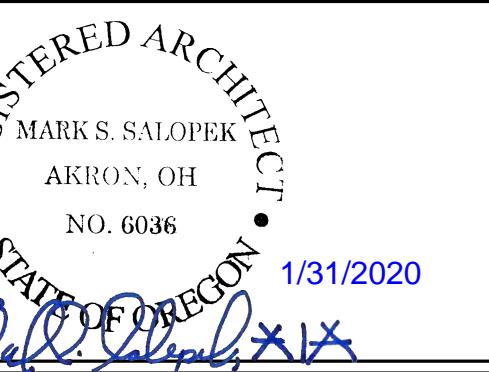
STARBUCKS TEMPLATE VERSION: I2019-10-25



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GPD PROJECT NO: 2019355.20



1 1ST FLOOR - FLOOR FINISH PLAN

Scale: 1/4" = 1'-0"

LEGEND

- — — — — INDICATES LAMINATE MOTTLED BLACK (DID : PL019)*
- — — — — INDICATES FULL HEIGHT FRP PANELING ABOVE TILE BASE (WHITE FRP - DID: 11469)*
- — — — — INDICATES WALL COVERING - RUSHMORE 2VRM-14 GEMSTONE ABOVE TILE BASE (DID : X2000)*
- — — — — INDICATES RESTROOM WALL TILE PRO ARCHITECTURA GREY- 4X12IN ABOVE TILE BASE (DID : 14744)**
- — — — — INDICATES PAINT SW7069 - IRON ORE ABOVE TILE BASE (DID : SW7069-ES)*
- — — — — INDICATES WOOD CLADDING OVER TALL BACKSPLASH (WD0073)*
- — — — — INDICATES TILE BASE 6X12IN (DID : 14770) GRAPHITE
- — — — — INDICATES METAL END CAP (MT0011).
- — — — — INDICATES METAL BASE (MT0011).
- — — — — INDICATES STAINLESS STEEL CORNER GUARD FOR BOH OR HOT ROLLED STEEL CORNER GUARD FOR CAFE SPACE. INSTALL 6" (150mm) TO 42" (1065mm) A.F. UNLESS OTHERWISE NOTED.

*SEE INTERIOR FINISH ELEVATIONS FOR TAGGED LOCATION OF WALL FINISH MATERIAL.

**SEE RESTROOM PLAN & ELEVATIONS FOR TAGGED LOCATION OF WALL FINISH MATERIAL

RESPONSIBILITY LEGEND

GC GENERAL CONTRACTOR
LL LANDLORD
SB STARBUCKS

0 2' 4' 8'
Scale: 1/4" = 1'-0"



PROJECT NAME:
HWY 101 - COOS BAY

PROJECT ADDRESS:
101, COOS BAY VILLAGE
COOS BAY, OR 97420

STORE #: 60983
PROJECT #: 84073-001
ISSUE DATE: 01-29-20 - 100 percent
DESIGN MANAGER: RYAN WONG
PRODUCTION DESIGNER: GPD
CHECKED BY: TC

Revision Schedule

Rev	Date	By	Description

SHEET TITLE:
INTERIOR FINISH PLAN

SCALE: AS SHOWN

SHEET NUMBER:
1104



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STARBUCKS TEMPLATE VERSION: i2019-10-25



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GPD PROJECT NO: 2019355.20

REGISTERED ARCHITECT
• MARK S. SALOPEK
STATE OF OREGON 1/31/2020
• NO. 6036
Mark Salopek

PROJECT NAME:
Hwy 101 - COOS BAY
PROJECT ADDRESS:
101, COOS BAY VILLAGE
COOS BAY, OR 97420

STORE #: 60983
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Revision Schedule

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SHEET TITLE:
**INTERIOR FINISH
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SCALE: AS SHOWN



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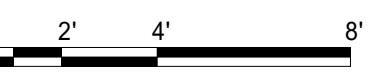
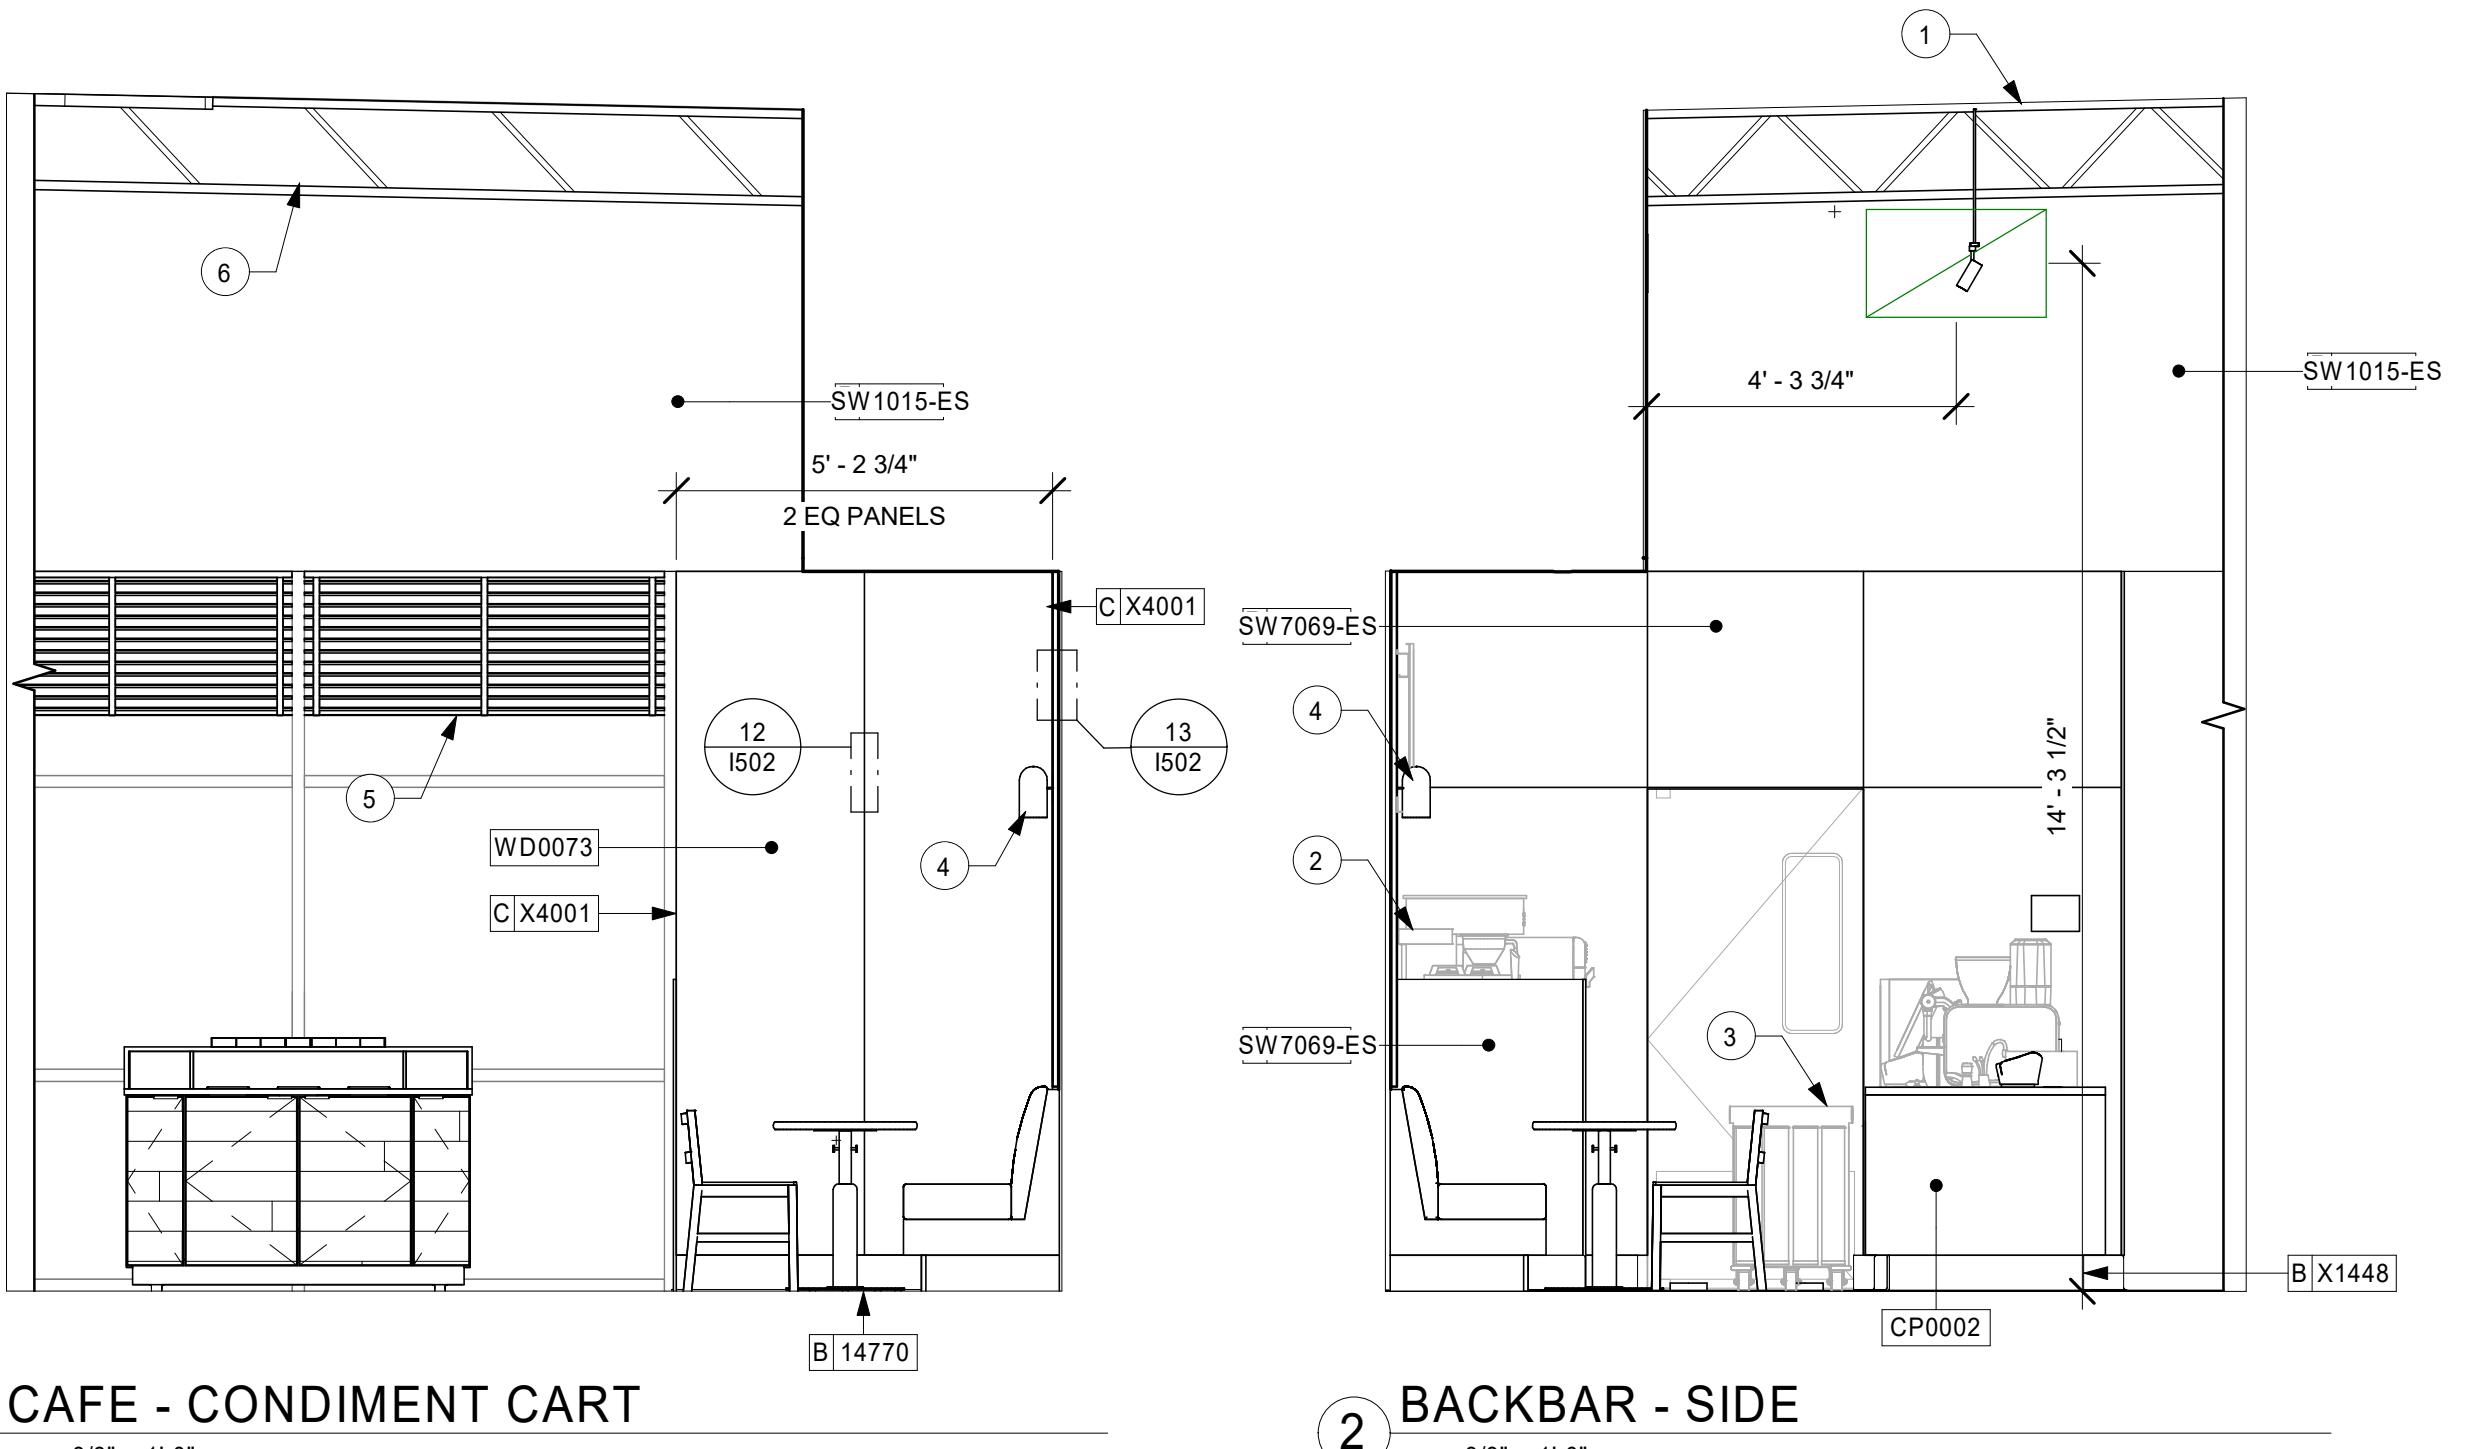
1202

KEYED NOTES

1. ACOUSTIC PANEL ATTACHED TO DECKING. PAINTED SW140-ES. PANEL NOT TO EXTEND PAST FACE OF BAR BELOW
2. SHELVING FOR CBE STATION AS SHOWN. G.C. TO PROVIDE WALL BLOCKING FOR FASTENERS.
3. CUP DISPENSERS. SEE FF & E PLAN ON SHEET I101 FOR ADDITIONAL INFORMATION.
4. WALL SCONCE LIGHT FIXTURE (SEE REFLECTED CEILING PLAN ON SHEET I103 AND LIGHTING PLAN ON SHEET E102 FOR ADDITIONAL INFORMATION).
5. WINDOW SHADES, TYP.
6. EXPOSED STRUCTURE TO BE PAINTED AS SCHEDULED

GENERAL NOTES

- A. FOR GRAPHICS SCHEDULE, REFER TO THE FURNITURE, FIXTURES, AND EQUIPMENT (FF & E) SCHEDULES ON SHEET I101.
- B. REFER TO MANUFACTURER'S INSTRUCTIONS INCLUDED WITH ARTWORK/GRAFICS FOR PROPER INSTALLATION.
- C. CHANGE PAINT COLOR ONLY AT INSIDE CORNERS UNLESS OTHERWISE INDICATED.
- D. PAINT FINISHES SHALL BE APPLIED AS FOLLOWS, UNLESS NOTED OTHERWISE:
 - 1) WOODS AND METAL SURFACES SHALL BE SEMI-GLOSS OR EQUAL
 - 2) ACCENT AND TRIM PAINTS TO BE SEMI-GLOSS OR EQUAL
 - a. WALL AND CEILING PAINTS TO BE EGGSHELL OR EQUAL
 - 3) PAINTS IN BOH, RESTROOM(S) OR CAFE BAR SHALL BE SEMI-GLOSS OR EQUAL
- E. PAINT SUBSTITUTIONS ARE NOT ALLOWED. USE STARBUCKS NATIONAL ACCOUNT COLOR CODE WHEN ORDERING PAINTS.
- F. FLOORS, WALLS AND CEILING FINISHES IN FOOD PREPARATION AREAS SHALL BE SMOOTH, NON-TOXIC, NON-ABSORBENT, DURABLE AND EASILY CLEANABLE. PAINT SHALL BE WASHABLE; SEMI-GLOSS OR HIGH GLOSS FINISH.
- G. ALL WOOD SURFACES (DOORS, TRIM, SHELVES, CABINETRY) SHALL BE SEALED.
- H. REFER TO CASEWORK FINISH SCHEDULE ON THE CASEWORK FINISH PLAN ON SHEET I102 FOR CASEWORK FINISH MATERIAL INFORMATION.
- I. ALIGN TILE TRANSITIONS ON WHOLE TILES AS SHOWN.
- J. ALL FLOOR AND WALL JUNCTIONS IN STORAGE AND FOOD PREPARATION AREAS SHALL HAVE A 6" COVED BASE.
- K. ALL FOOD STORAGE SHALL BE 6" (150MM) A.F.F.
- L. INSTALL BLOCKING AND HANGERS FOR WALL SHELVING BEFORE INSTALLING BACK BAR TILE.
- M. GENERAL CONTRACTOR TO PROVIDE AND INSTALL WORKROOM WALL FINISHES.



SHEET NUMBER:

1202



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STARBUCKS TEMPLATE VERSION: i2019-10-25



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GPD PROJECT NO: 2019355.20

REGISTERED ARCHITECT
• MARK S. SALOPEK, E.I.T.C.
STATE OF OREGON
• 1/31/2020
Mark S. Salopek, E.I.T.C.

PROJECT NAME:
HWY 101 - COOS BAY
PROJECT ADDRESS:
101, COOS BAY VILLAGE
COOS BAY, OR 97420

STORE #: 60983
PROJECT #: 84073-001
ISSUE DATE: 01-29-20 - 100 percent
DESIGN MANAGER: RYAN WONG
PRODUCTION DESIGNER: GPD
CHECKED BY: TC

Revision Schedule

Rev	Date	By	Description

SHEET TITLE:
**INTERIOR FINISH
ELEVATIONS**
SCALE: AS SHOWN

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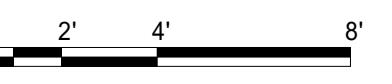
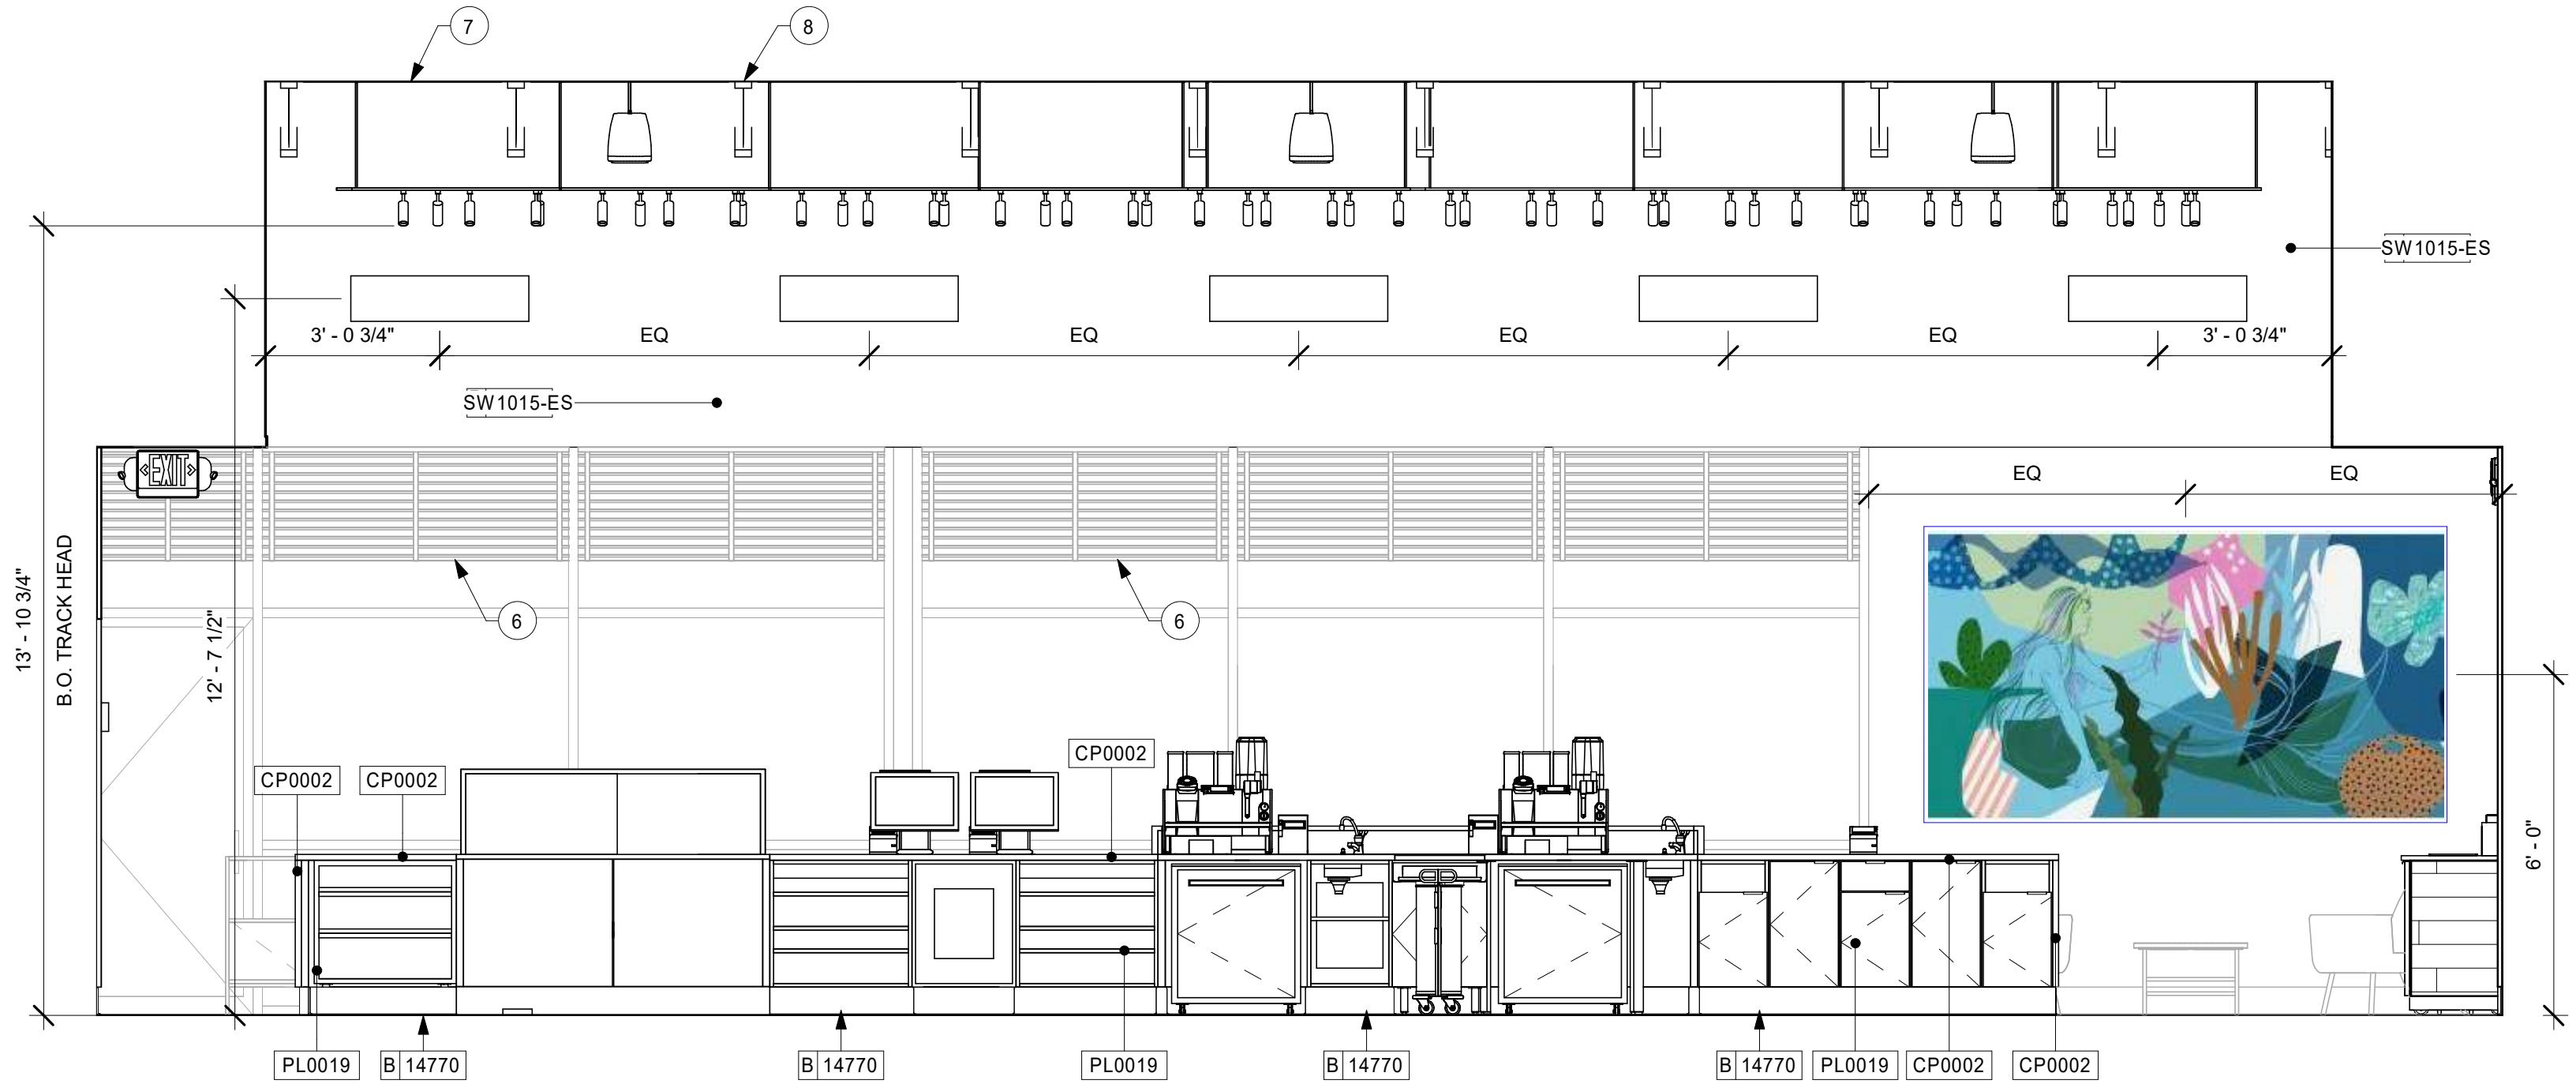
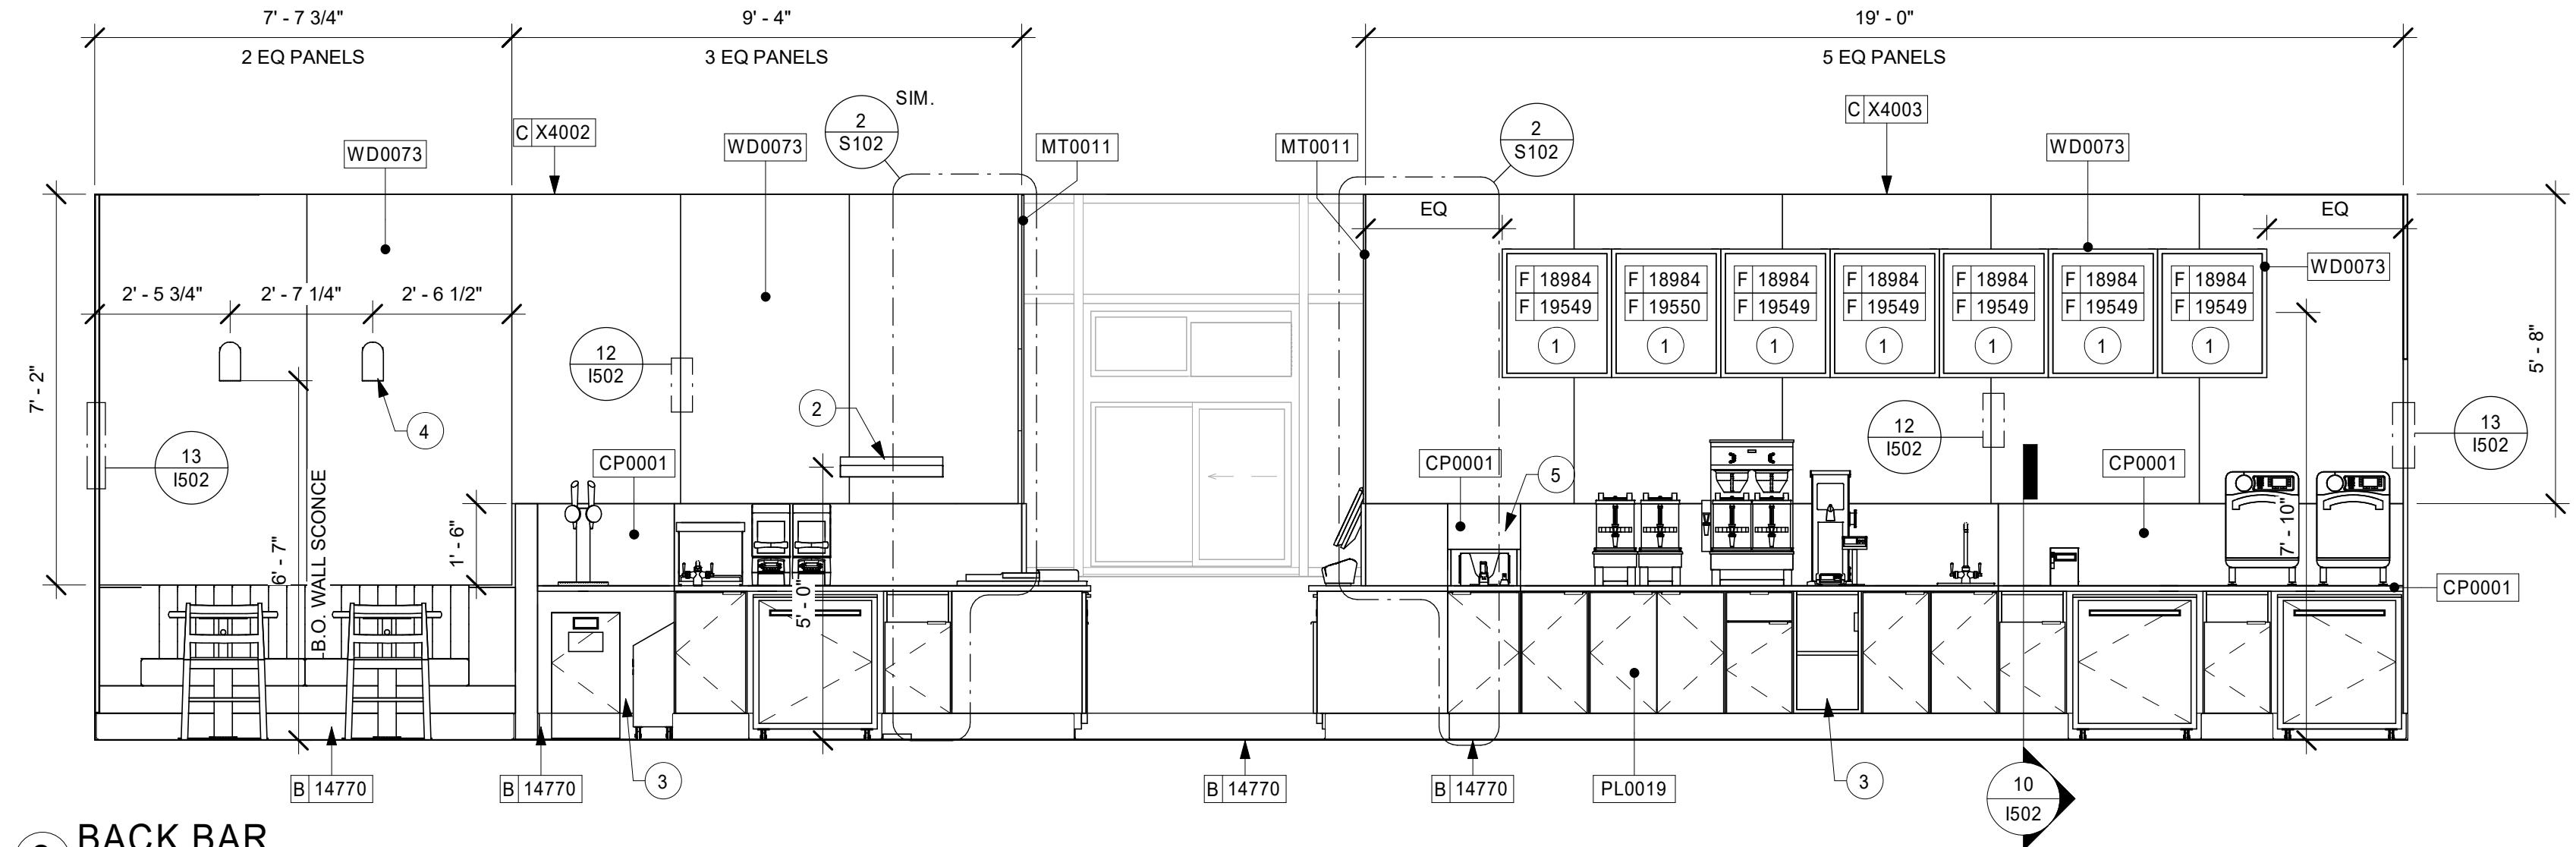
1203

KEYED NOTES

1. ATTACH MENU BOARDS PER INSTALLATION DETAILS.
2. SHELVING FOR CBE STATION AS SHOWN. G.C. TO PROVIDE WALL BLOCKING FOR FASTENERS.
3. WALL FINISH BEHIND EXPOSED CABINETRY AND BELOW UNDERSIDE OF COUNTERTOP SUBSTRATE TO BE FRP.
4. WALL SCONCE (SEE REFLECTED CEILING PLAN ON SHEET I103 AND LIGHTING PLAN ON SHEET E102 FOR ADDITIONAL INFORMATION).
5. PROVIDE 6" (150MM) MIN. INTEGRAL SPLASHGUARD AT HAND SINK PER JURISDICTIONAL REQUIREMENTS.
6. WINDOW SHADES. TYP.
7. ACOUSTIC PANEL, ATTACHED TO DECKING, PAINTED SW9140-ES. PANEL NOT TO EXTEND PAST FACE OF BAR BELOW
8. EXPOSED STRUCTURE TO BE PAINTED AS SCHEDULED

GENERAL NOTES

- A. FOR GRAPHICS SCHEDULE, REFER TO THE FURNITURE, FIXTURES, AND EQUIPMENT (FF & E) SCHEDULES ON SHEET I601.
- B. REFER TO MANUFACTURER'S INSTRUCTIONS INCLUDED WITH ARTWORK/GRAFICS FOR PROPER INSTALLATION.
- C. CHANGE PAINT COLOR ONLY AT INSIDE CORNERS UNLESS OTHERWISE INDICATED.
- D. PAINT FINISHES SHALL BE APPLIED AS FOLLOWS, UNLESS NOTED OTHERWISE:
 - 1) WOODS AND METAL SURFACES SHALL BE SEMI-GLOSS OR EQUAL.
 - 2) ACCENT AND TRIM PAINTS TO BE SEMI-GLOSS OR EQUAL.
 - a. WALL AND CEILING PAINTS TO BE EGGSHELL OR EQUAL.
 - 3) PAINTS IN BOH, RESTROOM(S) OR CAFE BAR SHALL BE SEMI-GLOSS OR EQUAL.
- E. PAINT SUBSTITUTIONS ARE NOT ALLOWED. USE STARBUCKS NATIONAL ACCOUNT COLOR CODE WHEN ORDERING PAINTS.
- F. FLOORS, WALLS AND CEILING FINISHES IN FOOD PREPARATION AREAS SHALL BE SMOOTH, NON-TOXIC, NON-ABSORBENT, DURABLE AND EASILY CLEANABLE. PAINT SHALL BE WASHABLE; SEMI-GLOSS OR HIGH GLOSS FINISH.
- G. ALL WOOD SURFACES (DOORS, TRIM, SHELVES, CABINETRY) SHALL BE SEALED.
- H. REFER TO CASEWORK FINISH SCHEDULE ON THE CASEWORK FINISH PLAN ON SHEET I102 FOR CASEWORK FINISH MATERIAL INFORMATION.
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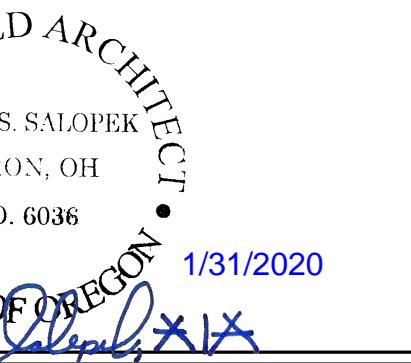
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STARBUCKS TEMPLATE VERSION: i2019-10-25



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GPD PROJECT NO: 2019355.20



• REGISTERED ARCHITECT
MARK S. SALOPEK
AKRON, OH
NO. 6036
1/31/2020
Mark S. Salopek

PROJECT NAME:
HWY 101 - COOS BAY

PROJECT ADDRESS:
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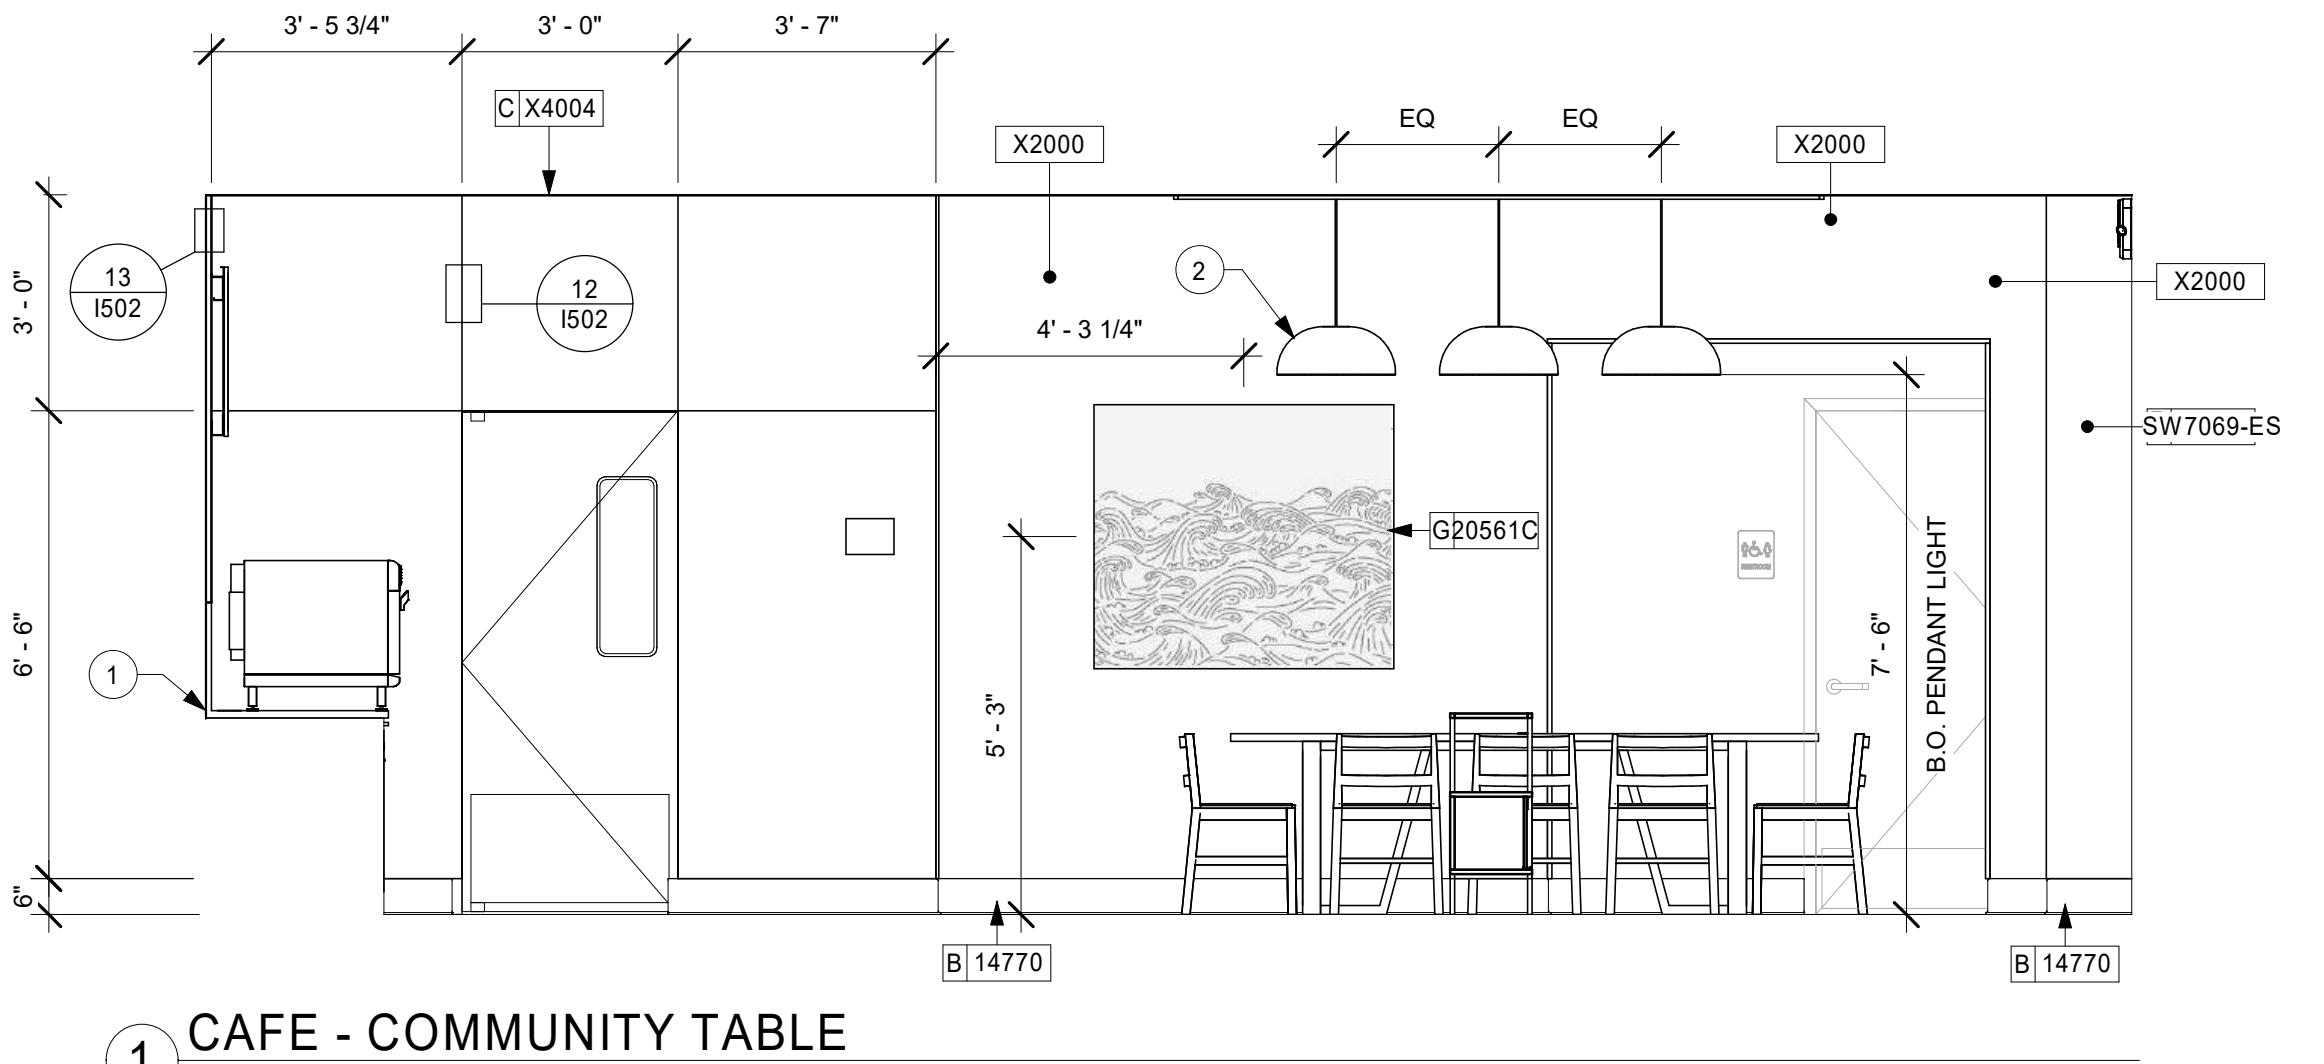
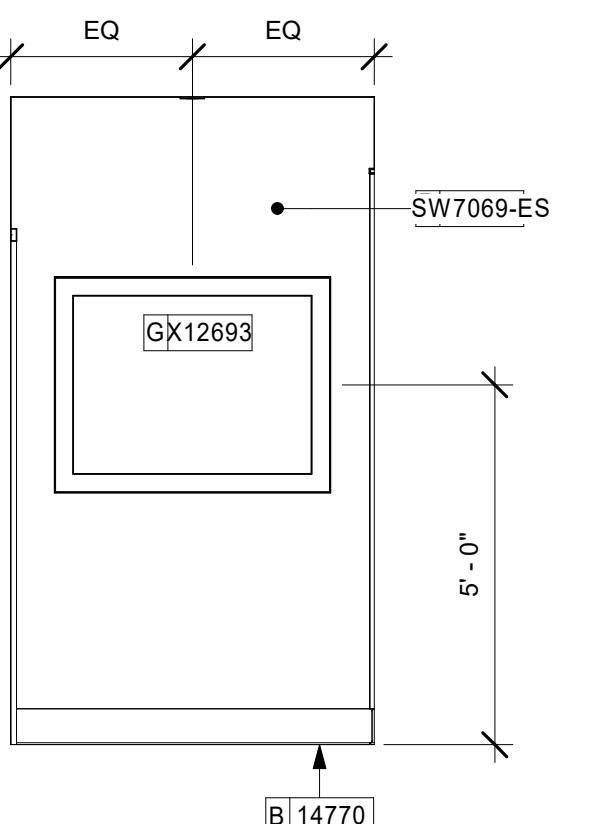
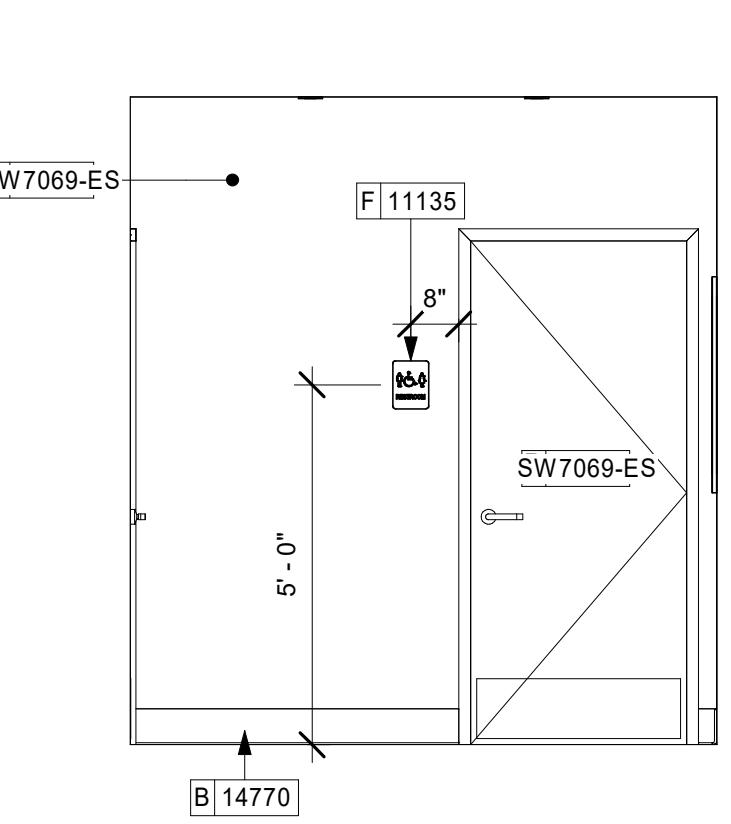
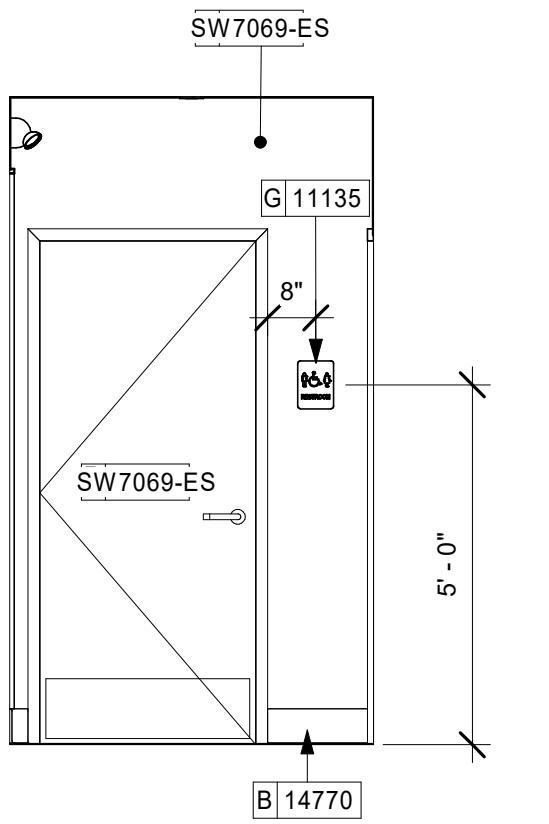
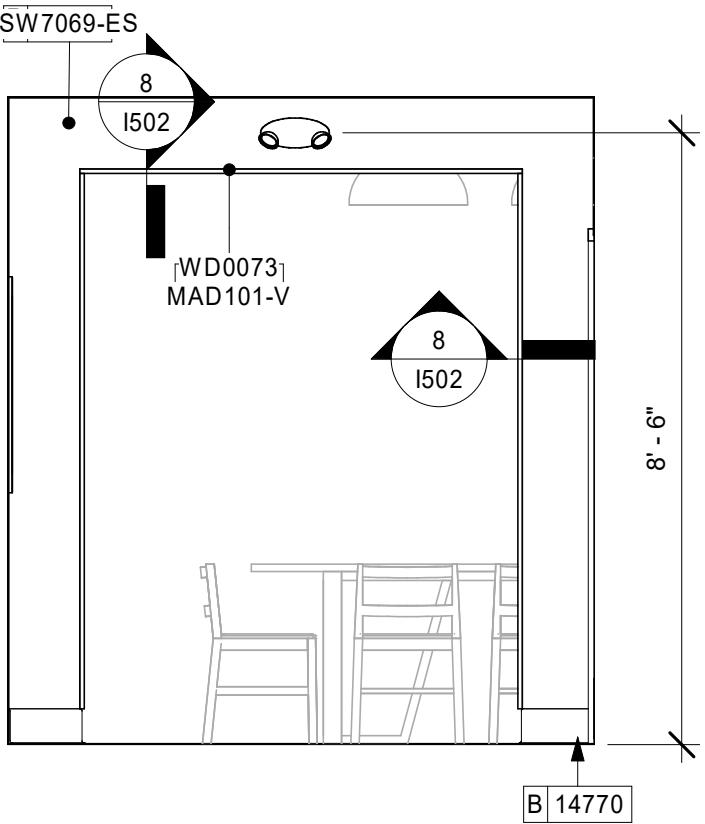
1204

KEYED NOTES

- WALL FINISH BEHIND EXPOSED CABINETRY AND BELOW UNDERSIDE OF COUNTERTOP SUBSTRATE TO BE FRP.
- PENDANT LIGHT FIXTURE (SEE REFLECTED CEILING PLAN ON SHEET I103 AND LIGHTING PLAN ON SHEET E102 FOR ADDITIONAL INFORMATION). DRAWINGS).

GENERAL NOTES

- FOR GRAPHICS SCHEDULE, REFER TO THE FURNITURE, FIXTURES, AND EQUIPMENT (FF & E) SCHEDULES ON SHEET I601.
- REFER TO MANUFACTURER'S INSTRUCTIONS INCLUDED WITH ARTWORK/GRAFICS FOR PROPER INSTALLATION.
- CHANGE PAINT COLOR ONLY AT INSIDE CORNERS UNLESS OTHERWISE INDICATED.
- PAINT FINISHES SHALL BE APPLIED AS FOLLOWS, UNLESS NOTED OTHERWISE:
 - WOODS AND METAL SURFACES SHALL BE SEMI-GLOSS OR EQUAL.
 - ACCENT AND TRIM PAINTS TO BE SEMI-GLOSS OR EQUAL.
 - PAINTS IN BOH, RESTROOM(S) OR CAFE BAR SHALL BE SEMI-GLOSS OR EQUAL.
- PAINT SUBSTITUTIONS ARE NOT ALLOWED. USE STARBUCKS NATIONAL ACCOUNT COLOR CODE WHEN ORDERING PAINTS.
- FLOORS, WALLS AND CEILING FINISHES IN FOOD PREPARATION AREAS SHALL BE SMOOTH, NON-TOXIC, NON-ABSORBENT, DURABLE AND EASILY CLEANABLE. PAINT SHALL BE WASHABLE; SEMI-GLOSS OR HIGH GLOSS FINISH.
- ALL WOOD SURFACES (DOORS, TRIM, SHELVES, CABINETRY) SHALL BE SEALED.
- REFER TO CASEWORK FINISH SCHEDULE ON THE CASEWORK FINISH PLAN ON SHEET I102 FOR CASEWORK FINISH MATERIAL INFORMATION.
- ALIGN TILE TRANSITIONS ON WHOLE TILES AS SHOWN.
- ALL FLOOR AND WALL JUNCTIONS IN STORAGE AND FOOD PREPARATION AREAS SHALL HAVE A 6" COVED BASE.
- ALL FOOD STORAGE SHALL BE 6" (150MM) A.F.F.
- INSTALL BLOCKING AND HANGERS FOR WALL SHELVING BEFORE INSTALLING BACK BAR TILE.
- GENERAL CONTRACTOR TO PROVIDE AND INSTALL WORKROOM WALL FINISHES.





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STARBUCKS TEMPLATE VERSION: i2019-10-25



GPD Engineering and Architecture
Professional Corporation

520 SOUTH MAIN ST, SUITE 2531
AKRON, OH 44311
P: 330-572-2100 F: 330-572-2101

GPD PROJECT NO: 2019355.20

REGISTERED ARCHITECT
• MARK S. SALOPEK
AKRON, OH
NO. 6036
STATE OF OREGON 1/31/2020
Mark S. Salopek

PROJECT NAME:
HWY 101 - COOS BAY

PROJECT ADDRESS:
101, COOS BAY VILLAGE
COOS BAY, OR 97420

STORE #: 60983
PROJECT #: 84073-001
ISSUE DATE: 01-29-20 - 100 percent
DESIGN MANAGER: RYAN WONG
PRODUCTION DESIGNER: GPD
CHECKED BY: TC

Revision Schedule

Rev	Date	By	Description

SHEET TITLE:
INTERIOR FINISH ELEVATIONS
SCALE: AS SHOWN

SHEET NUMBER:






1205

KEYED NOTES

1. WALL MOUNT HAND SINK WITH SOAP AND PAPER TOWEL DISPENSER. G.C. TO PROVIDE BLOCKING FOR FASTENERS.
2. ICE MACHINE (SEE PLUMBING AND ELECTRICAL DRAWINGS FOR ADDITIONAL INFORMATION).
3. MOP SINK. FULL HEIGHT FRP AT ENCLOSURE (SEE PLUMBING PLANS FOR MORE INFORMATION).
4. WATER HEATER ABOVE (SEE PLUMBING DRAWINGS).
5. MANAGER'S DESK (SEE ENLARGED DETAILS).
6. WATER FILTRATION EQUIPMENT (SEE PLUMBING DRAWINGS).
7. ELECTRICAL PANELS

GENERAL NOTES

- A. FOR GRAPHICS SCHEDULE, REFER TO THE FURNITURE, FIXTURES, AND EQUIPMENT (FF & E) SCHEDULES ON SHEET I601.
- B. REFER TO MANUFACTURER'S INSTRUCTIONS INCLUDED WITH ARTWORK/GRAFICS FOR PROPER INSTALLATION.
- C. CHANGE PAINT COLOR ONLY AT INSIDE CORNERS UNLESS OTHERWISE INDICATED.
- D. PAINT FINISHES SHALL BE APPLIED AS FOLLOWS, UNLESS NOTED OTHERWISE:
 - 1) WOODS AND METAL SURFACES SHALL BE SEMI-GLOSS OR EQUAL.
 - 2) ACCENT AND TRIM PAINTS TO BE SEMI-GLOSS OR EQUAL.
 - a. WALL AND CEILING PAINTS TO BE EGGSHELL OR EQUAL.
 - 3) PAINTS IN BOH, RESTROOM(S) OR CAFE BAR SHALL BE SEMI-GLOSS OR EQUAL.
- E. PAINT SUBSTITUTIONS ARE NOT ALLOWED. USE STARBUCKS NATIONAL ACCOUNT COLOR CODE WHEN ORDERING PAINTS.
- F. FLOORS, WALLS AND CEILING FINISHES IN FOOD PREPARATION AREAS SHALL BE SMOOTH, NON-TOXIC, NON-ABSORBENT, DURABLE AND EASILY CLEANABLE. PAINT SHALL BE WASHABLE; SEMI-GLOSS OR HIGH GLOSS FINISH.
- G. ALL WOOD SURFACES (DOORS, TRIM, SHELVES, CABINETRY) SHALL BE SEALED.
- H. REFER TO CASEWORK FINISH SCHEDULE ON THE CASEWORK FINISH PLAN ON SHEET I102 FOR CASEWORK FINISH MATERIAL INFORMATION.
- I. ALIGN TILE TRANSITIONS ON WHOLE TILES AS SHOWN.
- J. ALL FLOOR AND WALL JUNCTIONS IN STORAGE AND FOOD PREPARATION AREAS SHALL HAVE A 6" COVED BASE.
- K. ALL FOOD STORAGE SHALL BE 6" (150MM) A.F.F.
- L. INSTALL BLOCKING AND HANGERS FOR WALL SHELVING BEFORE INSTALLING BACK BAR TILE.
- M. GENERAL CONTRACTOR TO PROVIDE AND INSTALL WORKROOM WALL FINISHES.

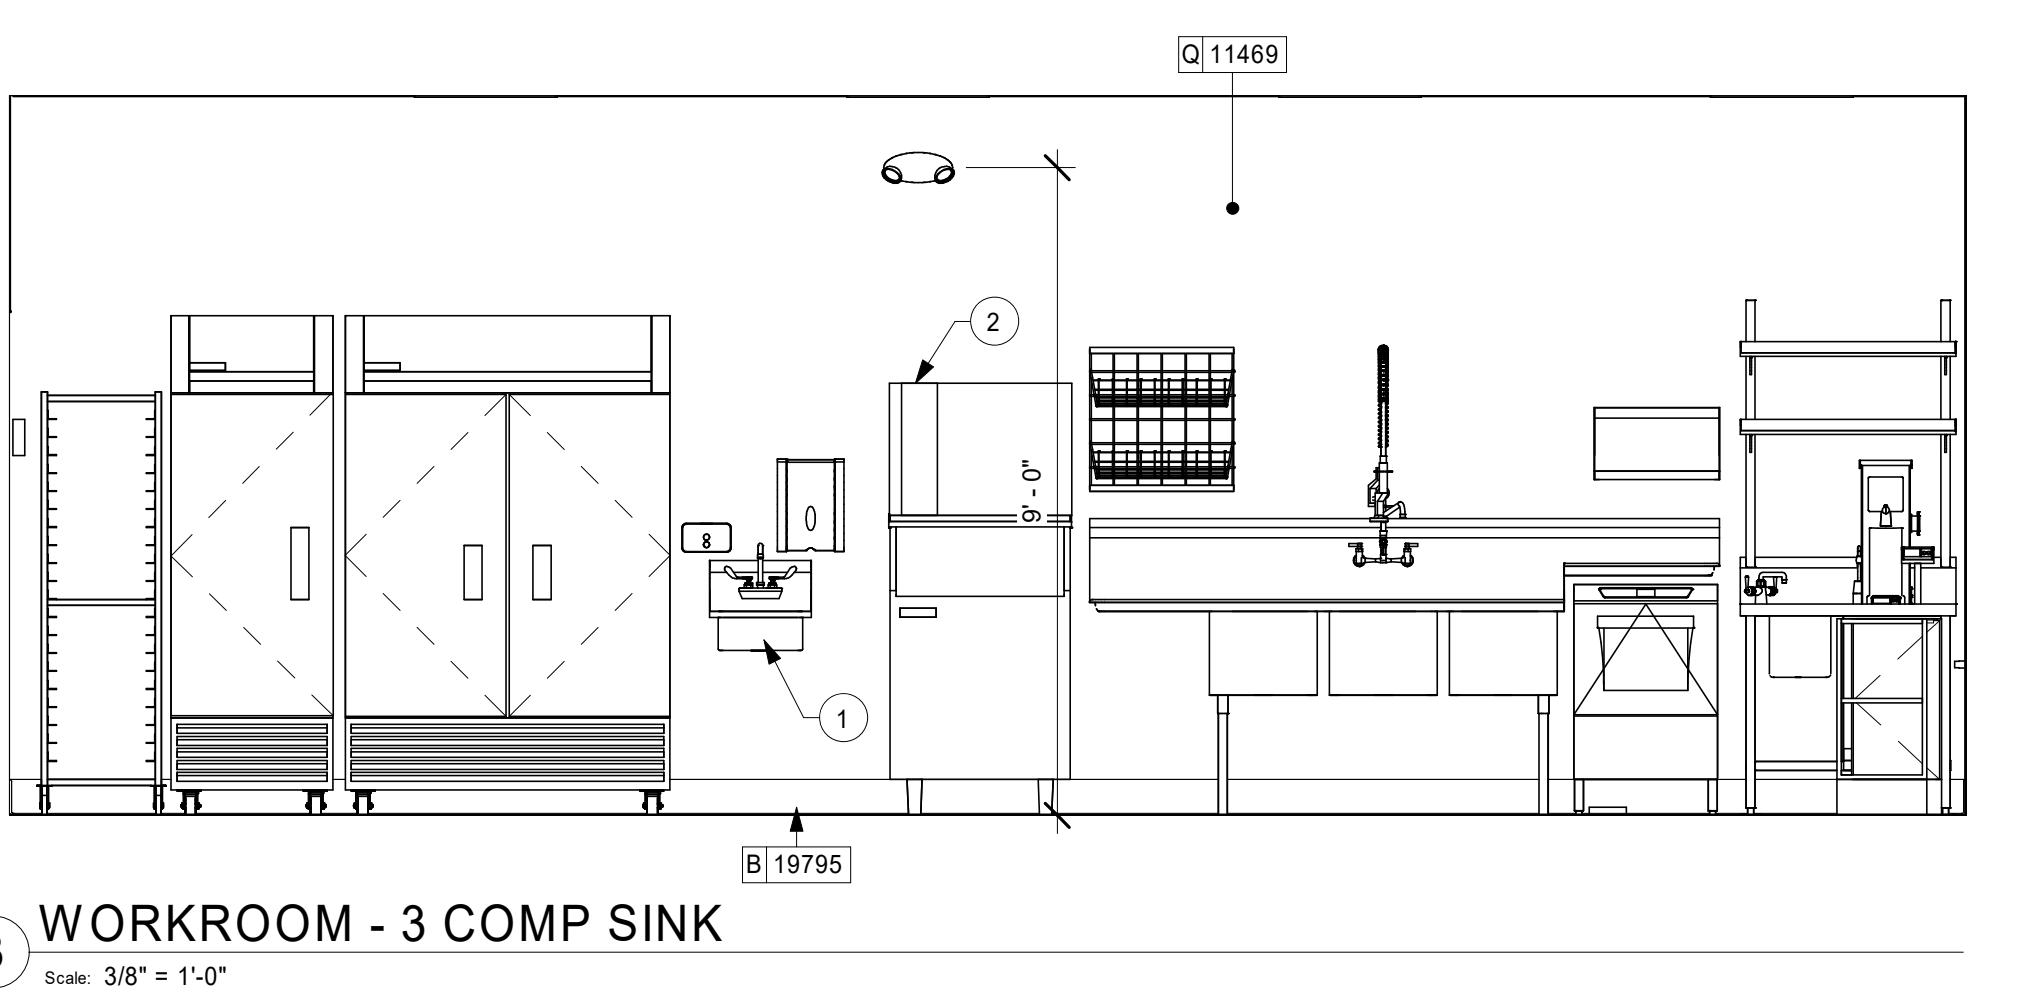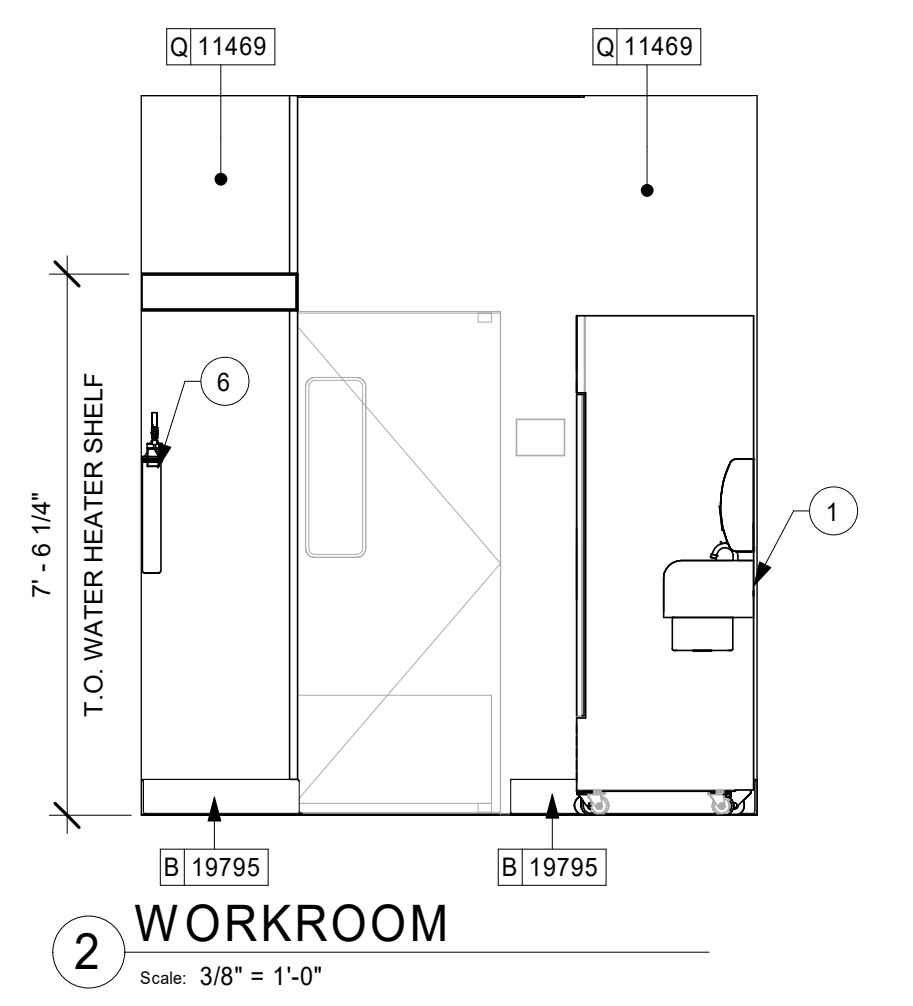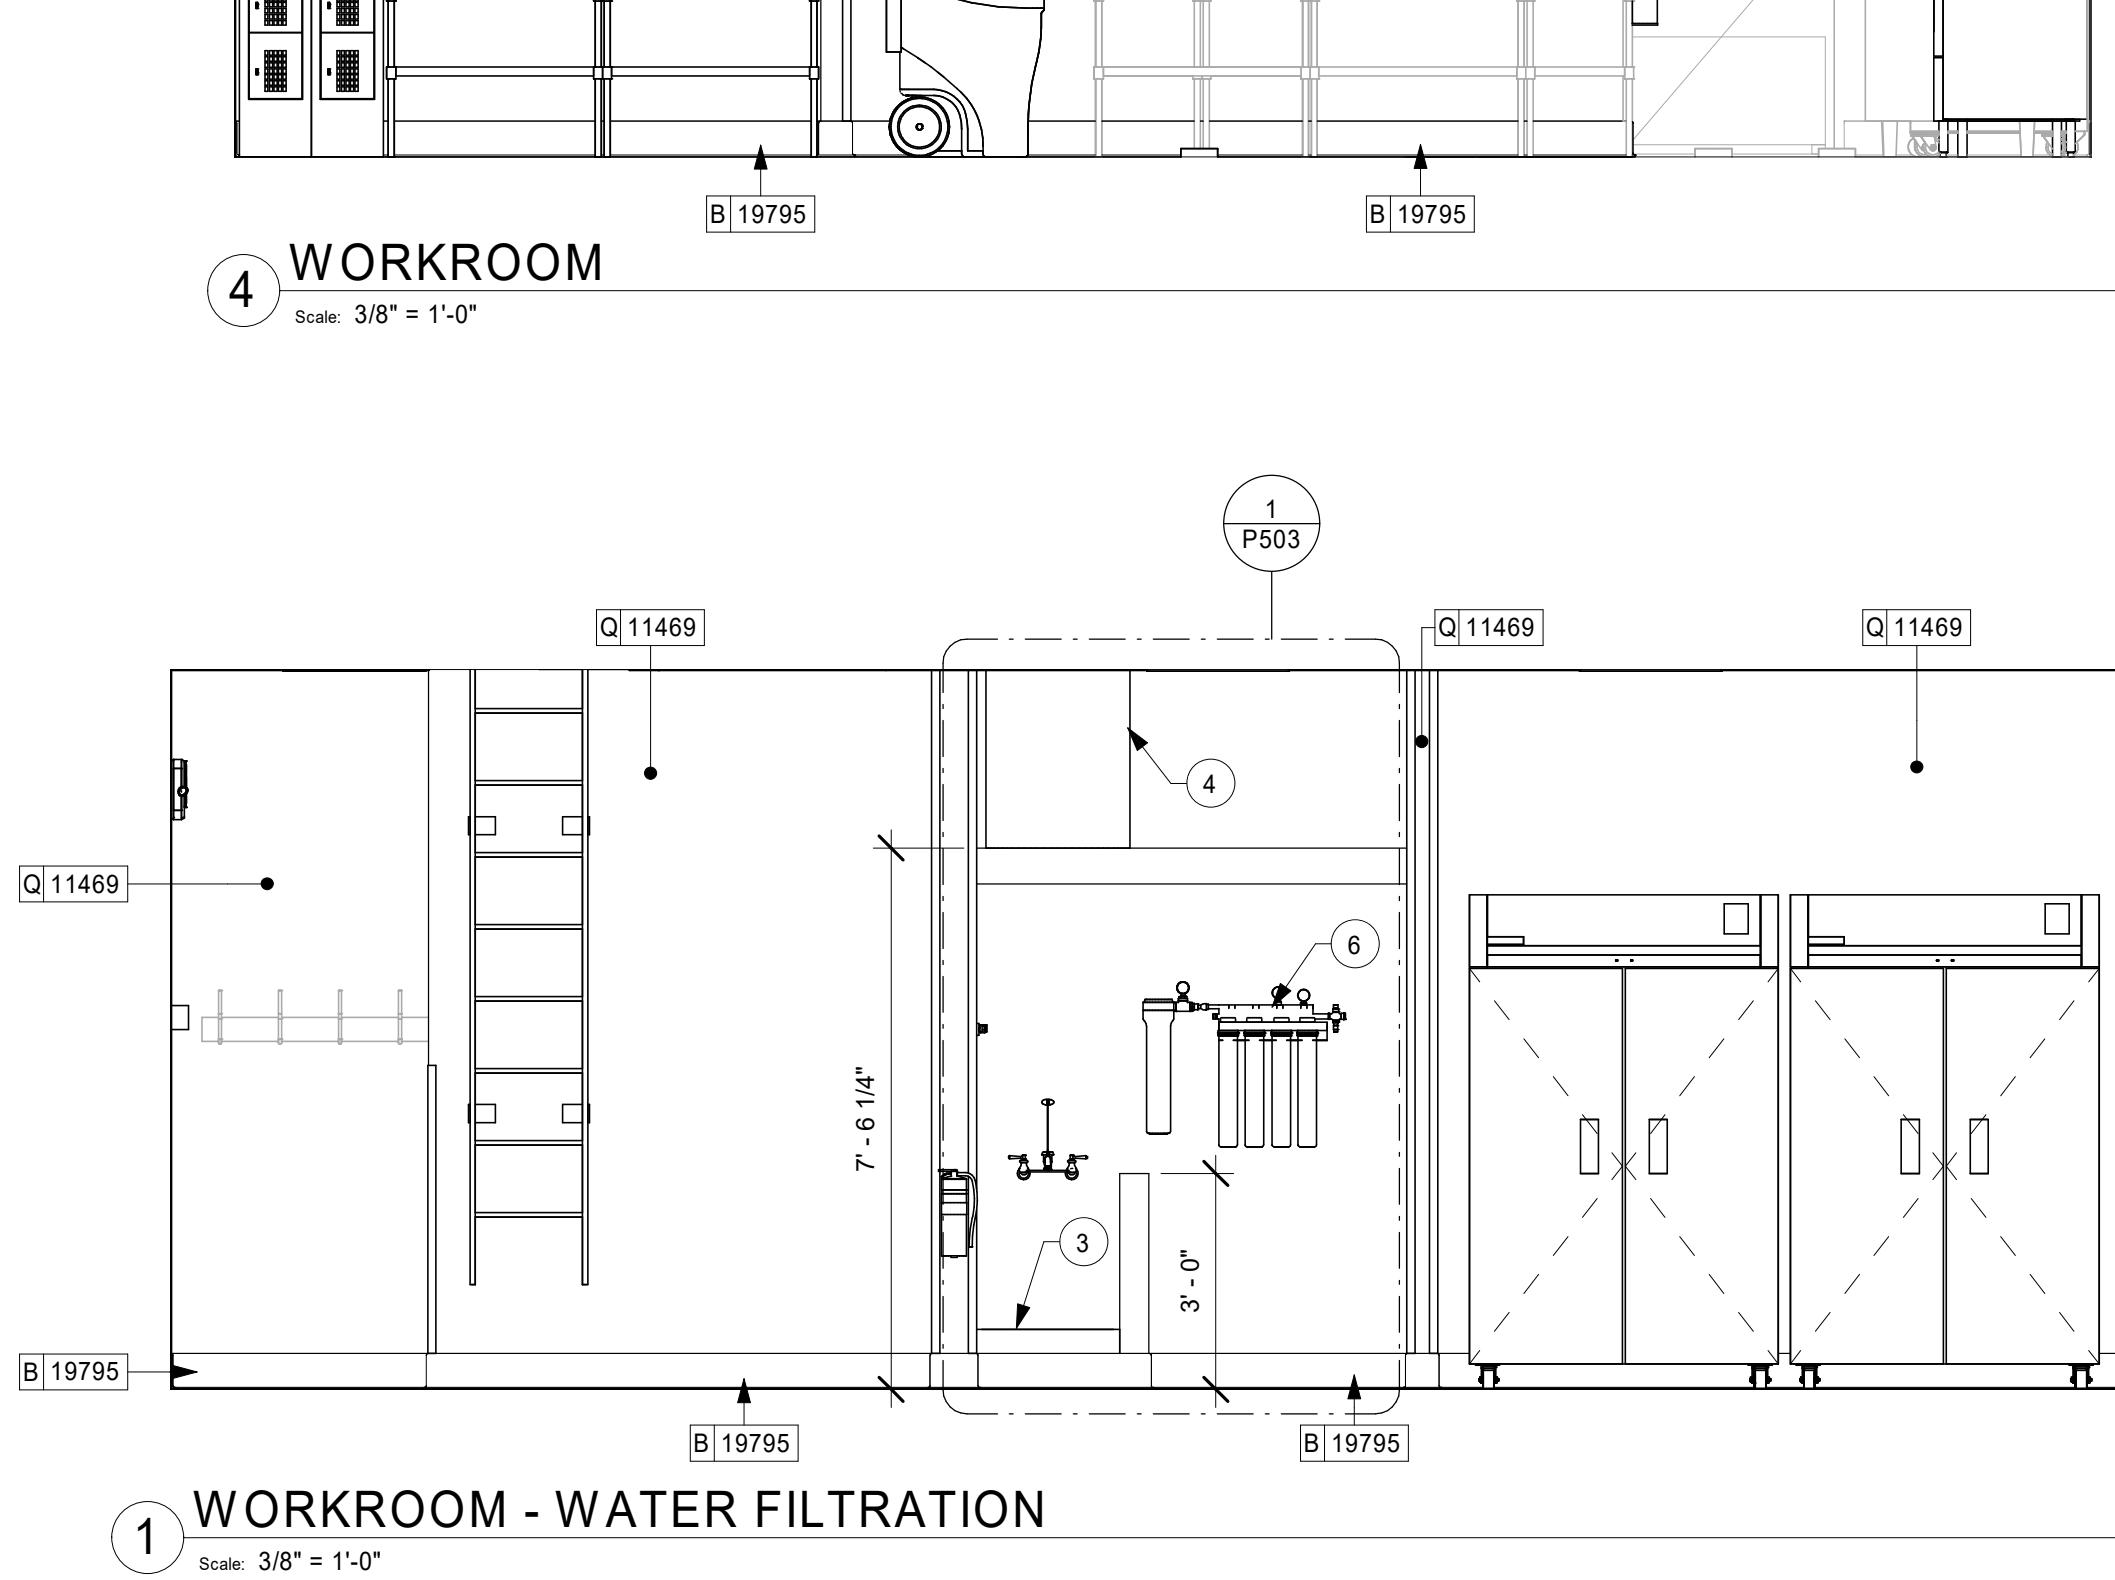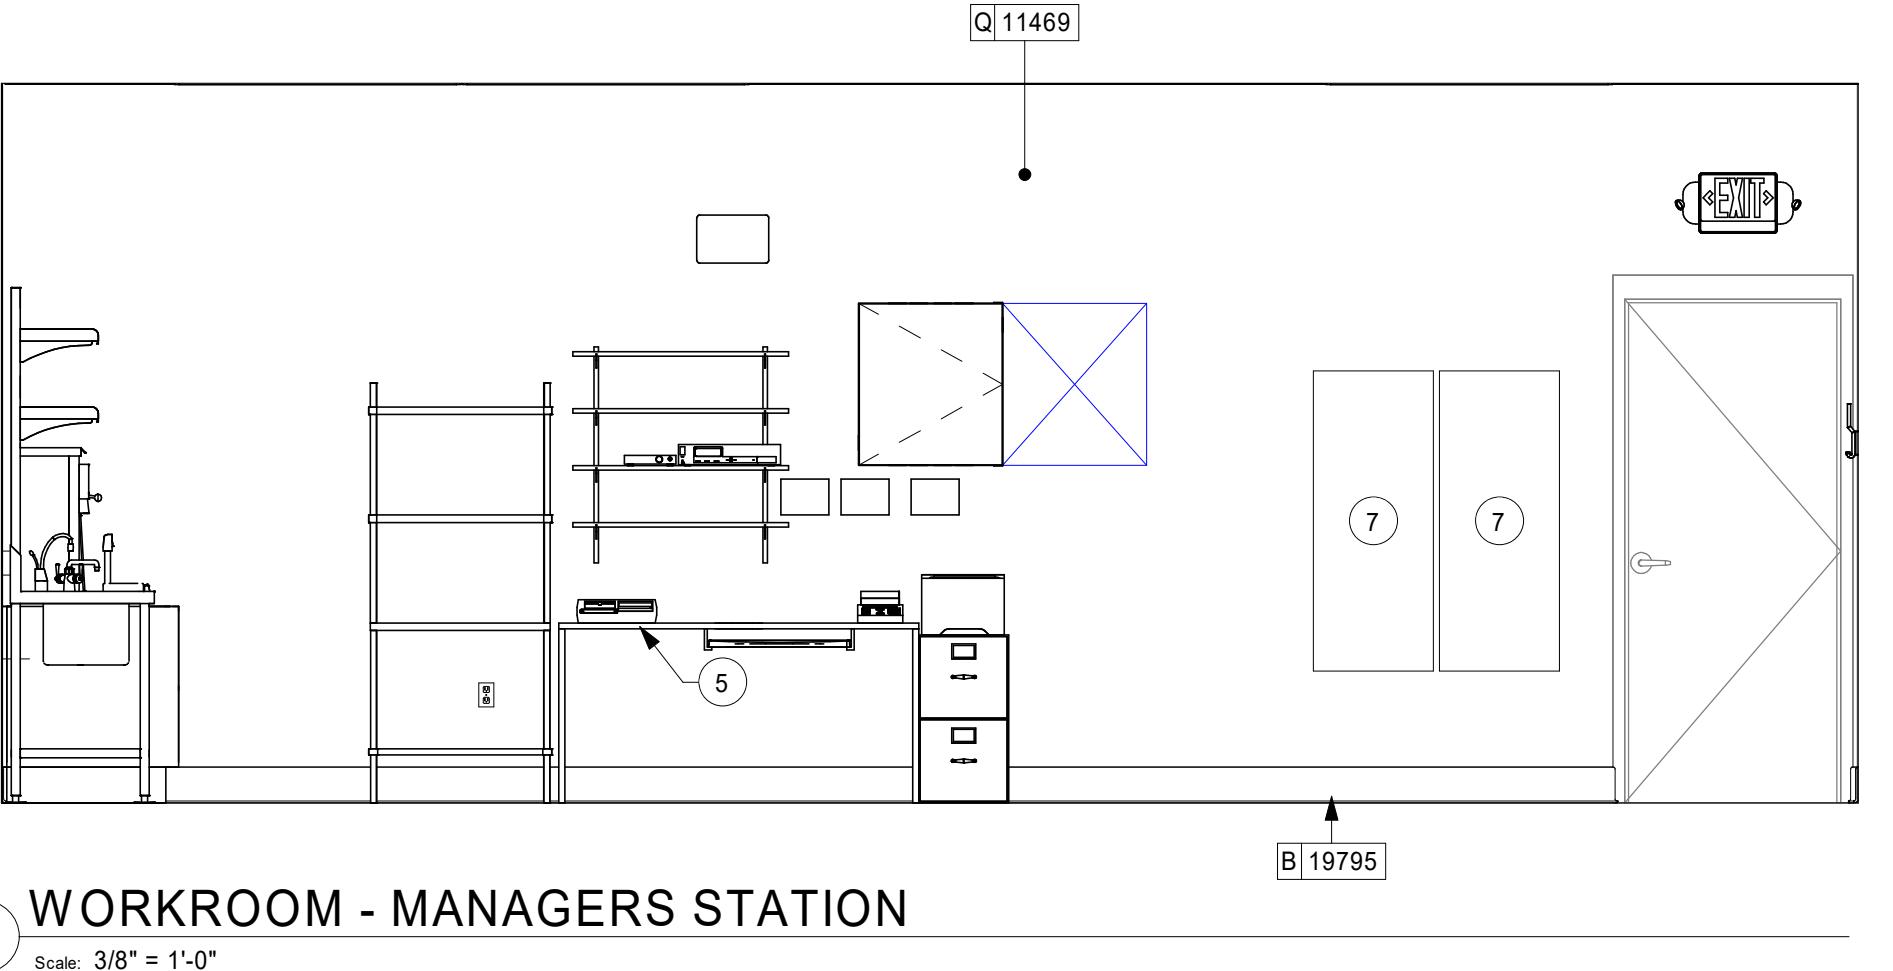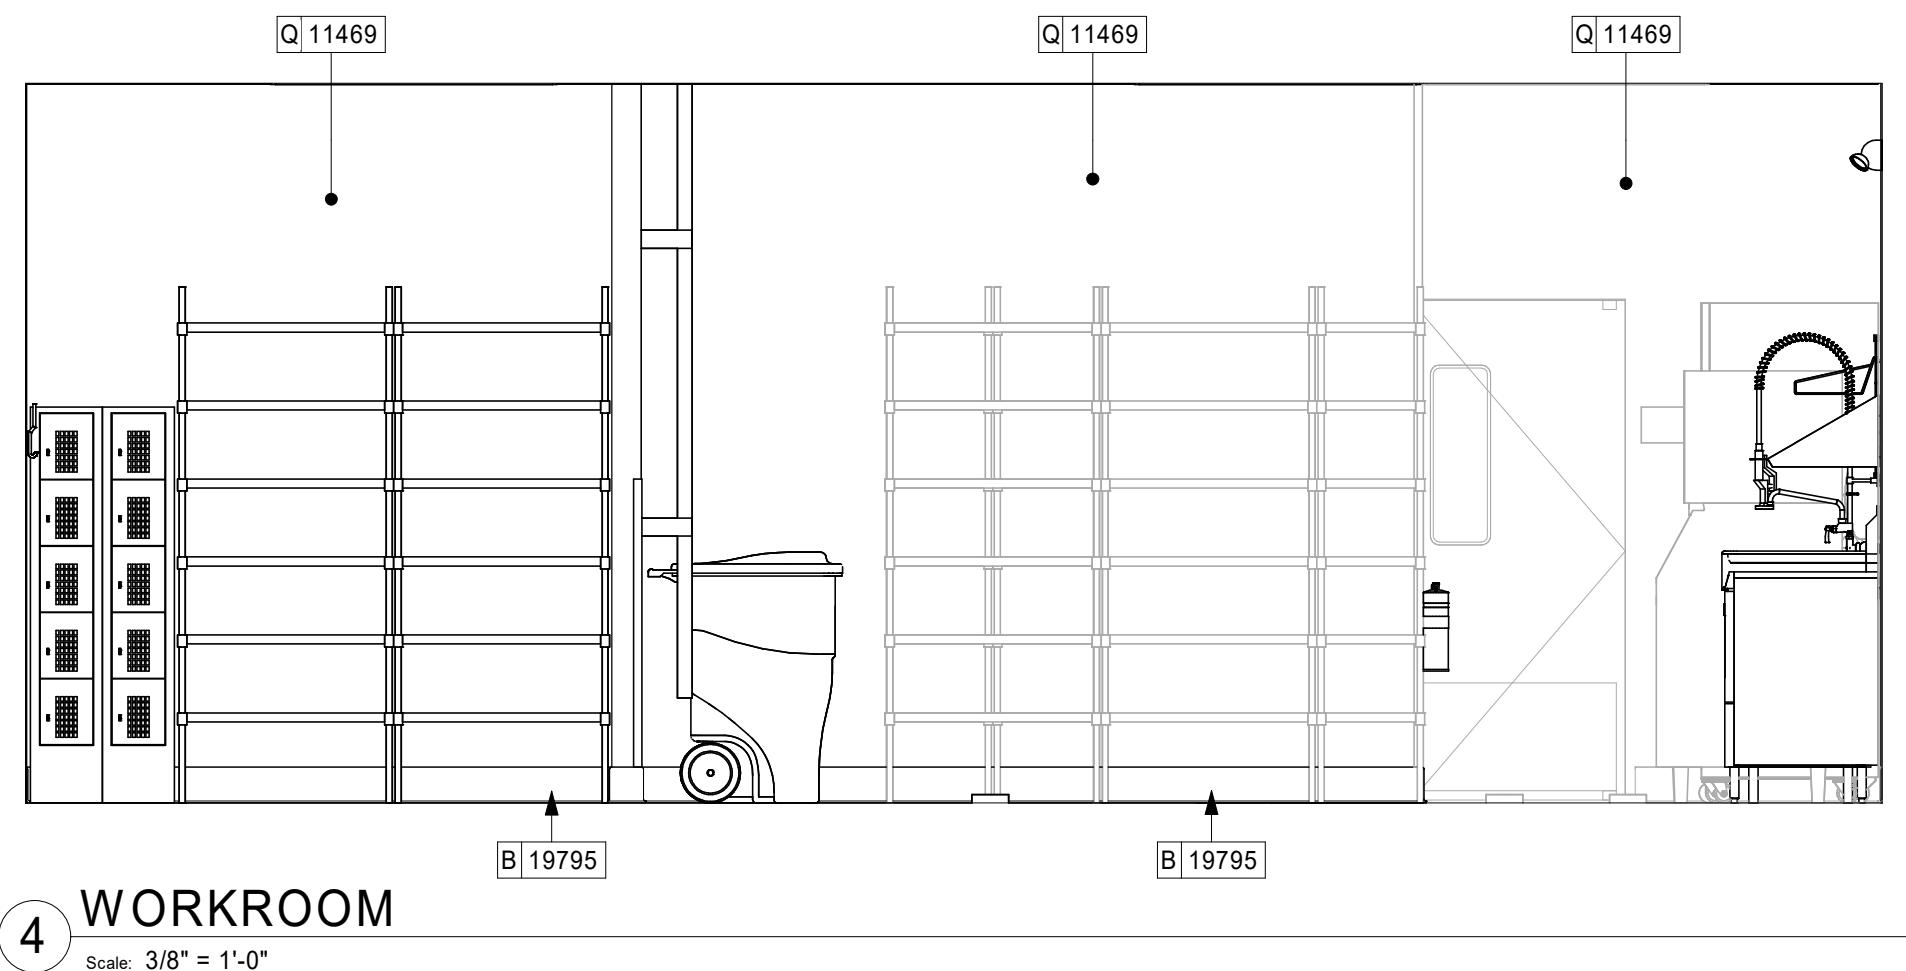



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DESIGN MANAGER: RYAN WONG
PRODUCTION DESIGNER: GPD
CHECKED BY: TC

Revision Schedule

Rev	Date	By	Description

SHEET TITLE:
RESTROOM PLAN & ELEVATIONS
SCALE: AS SHOWN
SHEET NUMBER:


1401

KEYED NOTES

1. 60" (1525mm) ACCESSIBLE TURNING RADIUS.
2. 30" (760mm) X 40" (1015MM) CLEAR FLOOR SPACE.
3. WATER CLOSET CLEAR FLOOR SPACE.
4. BABY CHANGING FIXTURE. GENERAL CONTRACTOR TO PROVIDE BLOCKING PER MANUFACTURER'S RECOMMENDATION.
5. TILE START POINT WHERE INDICATED.
6. WALL MOUNTED LAVATORY INSTALLED WITH INSULATED BOOT AT EXPOSED PIPES.
7. CENTER MIRROR OVER LAVATORY. MOUNT AT 40" (1015MM) MAX. TO BOTTOM EDGE OF REFLECTIVE SURFACE.
8. COAT HOOK. MOUNT AT CENTERLINE OF DOOR.
9. CENTER SCONCE LIGHTING OVER MIRROR (SEE ELECTRICAL).

GENERAL NOTES

- A. GENERAL CONTRACTOR TO VERIFY ALL DIMENSIONS AND NOTIFY STARBUCKS CONSTRUCTION MANAGER OF ANY DISCREPANCIES PRIOR TO CONSTRUCTION.
- B. ALL DIMENSIONS ARE TO BE TAKEN FROM A DESIGNATED DATUM POINT.
- C. DIMENSIONS ARE TO FACE OF FINISHED SURFACE UNLESS OTHERWISE NOTED.
- D. DIAPER CHANGING STATION IS TO BE INSTALLED PER MANUFACTURER'S INSTRUCTIONS. UNIT IS TO BE FASTENED TO STRUCTURE AT ALL SIX CHASSIS ATTACHMENT POINTS.
- E. LOCATE DIAPER CHANGING STATION AS SHOWN TO ALLOW NECESSARY CLEARANCE FOR OPERATION OF ALL RESTROOM FIXTURES. LOCATION SHALL NOT IMPEDE ACCESS, EGREG, OR DOOR SWING.
- F. ALL RESTROOM ACCESSORY MOUNTING HEIGHTS AND CLEARANCES SHALL COMPLY WITH THE ACCESSIBILITY REQUIREMENTS OF THE LOCAL JURISDICTION.

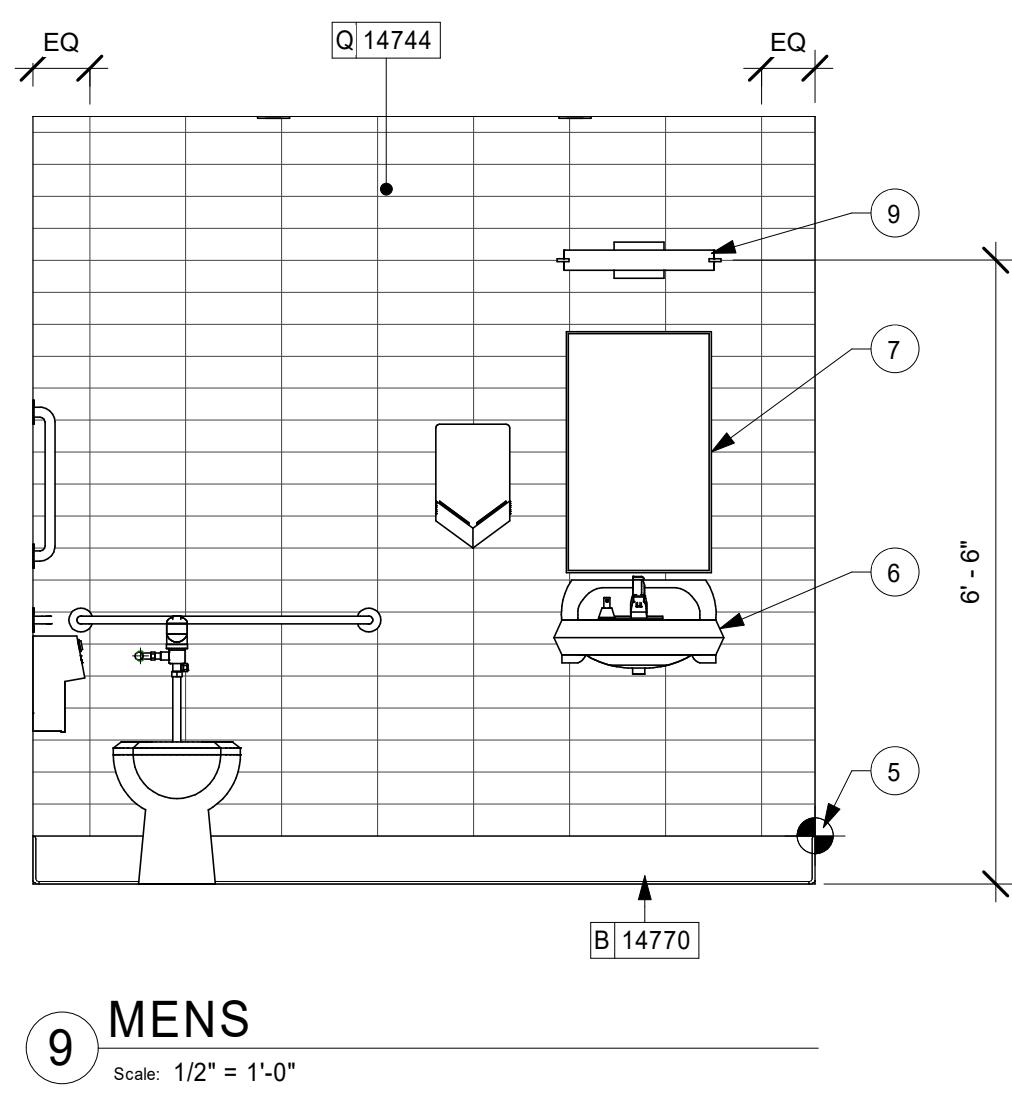

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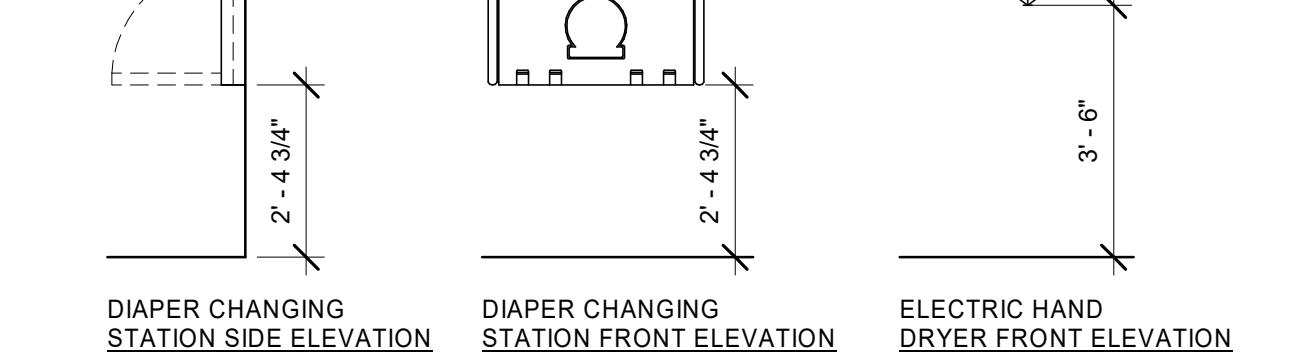
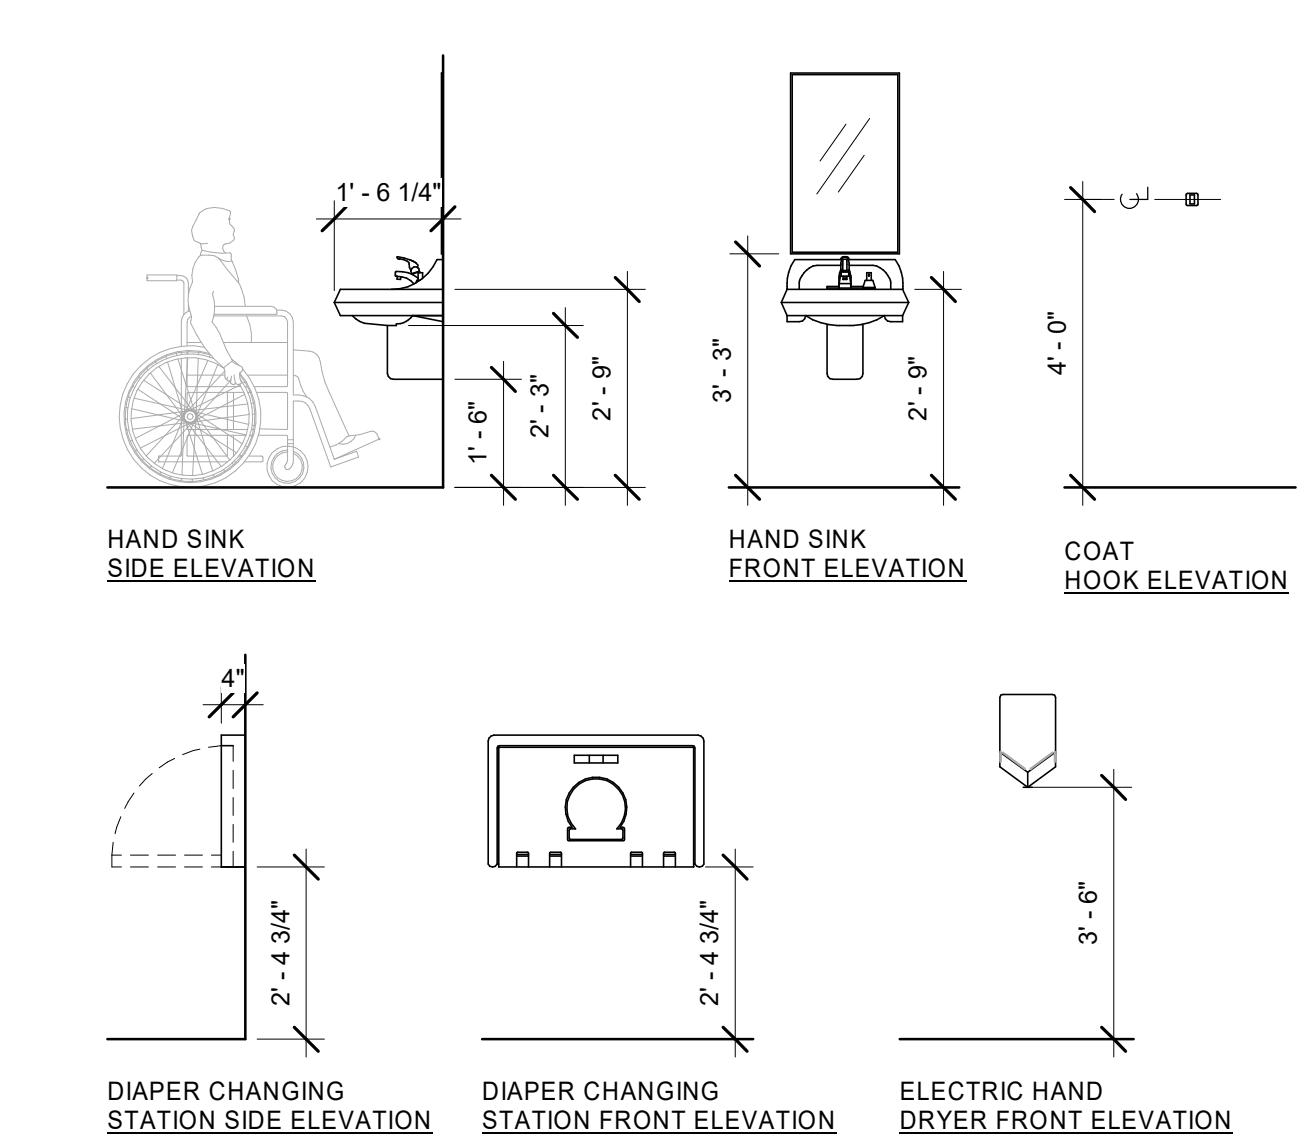
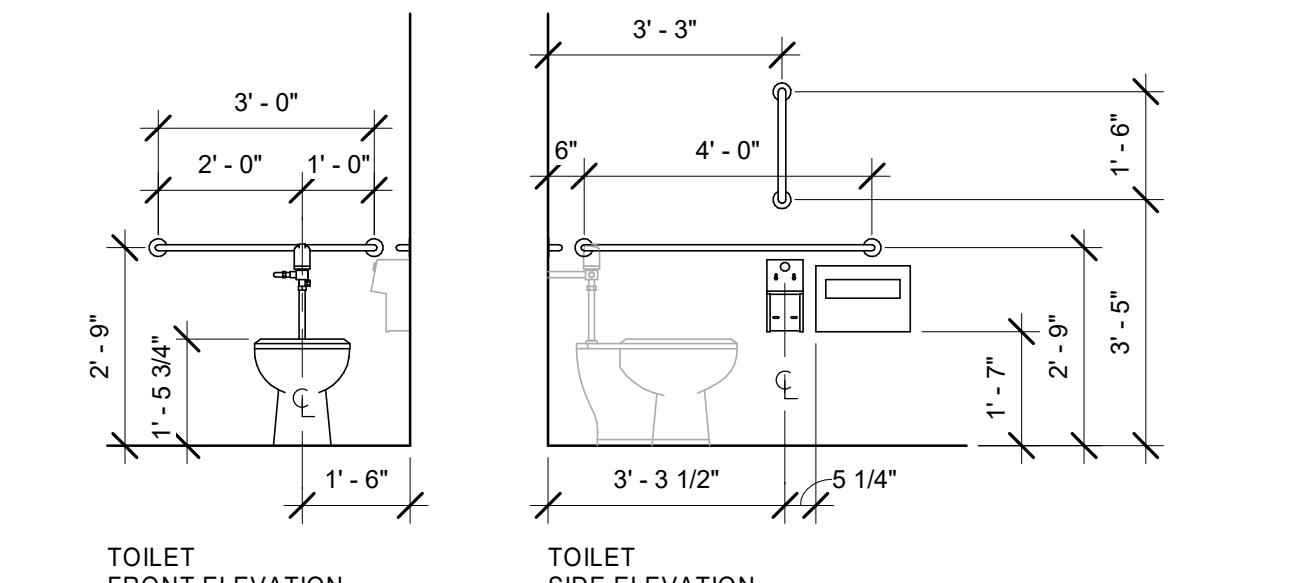
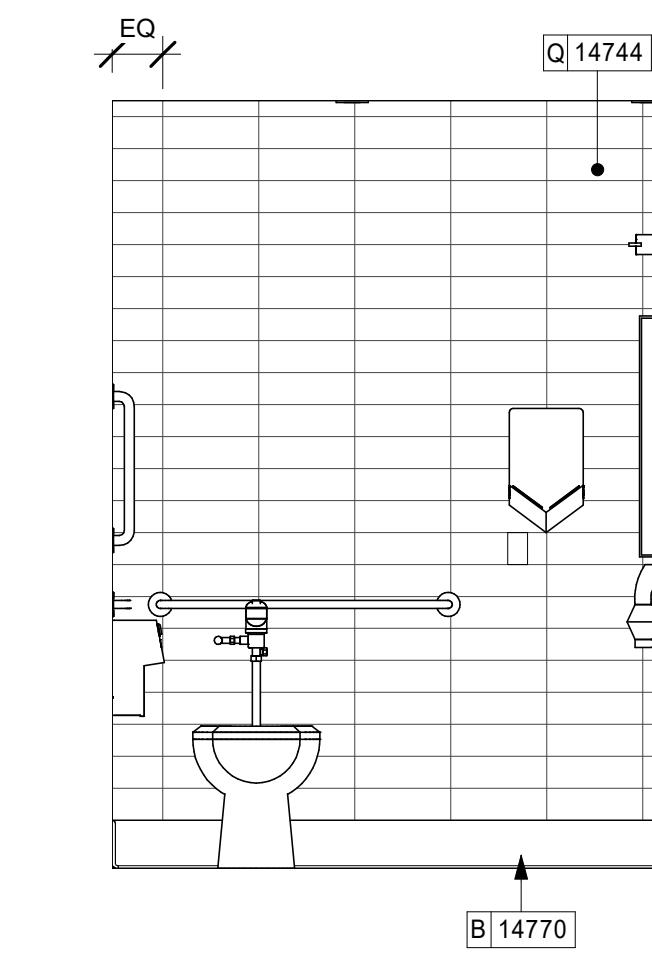
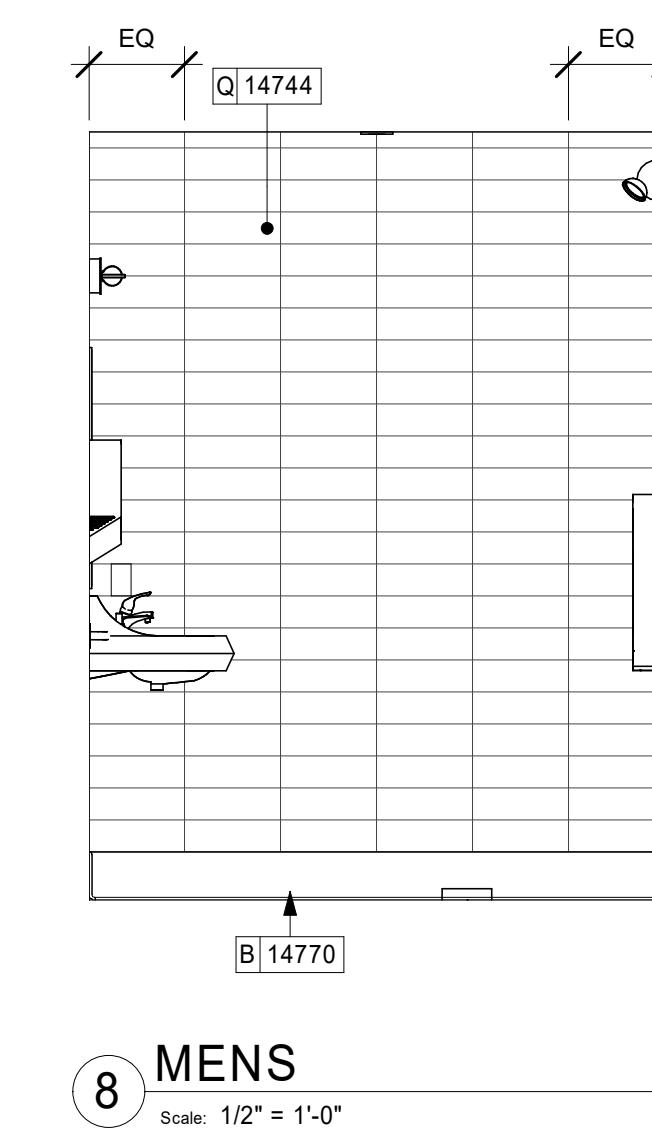
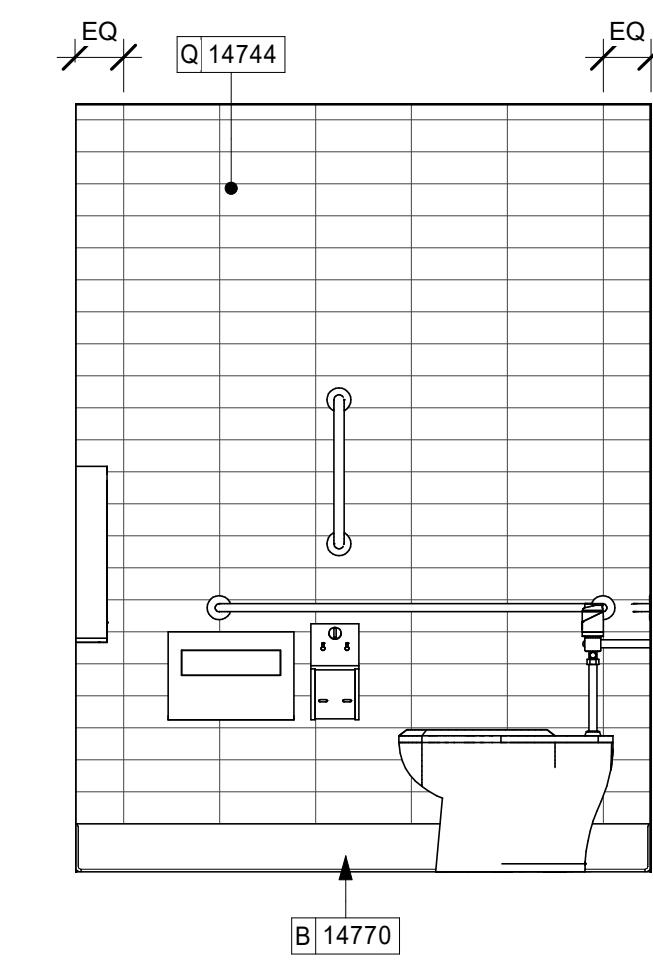
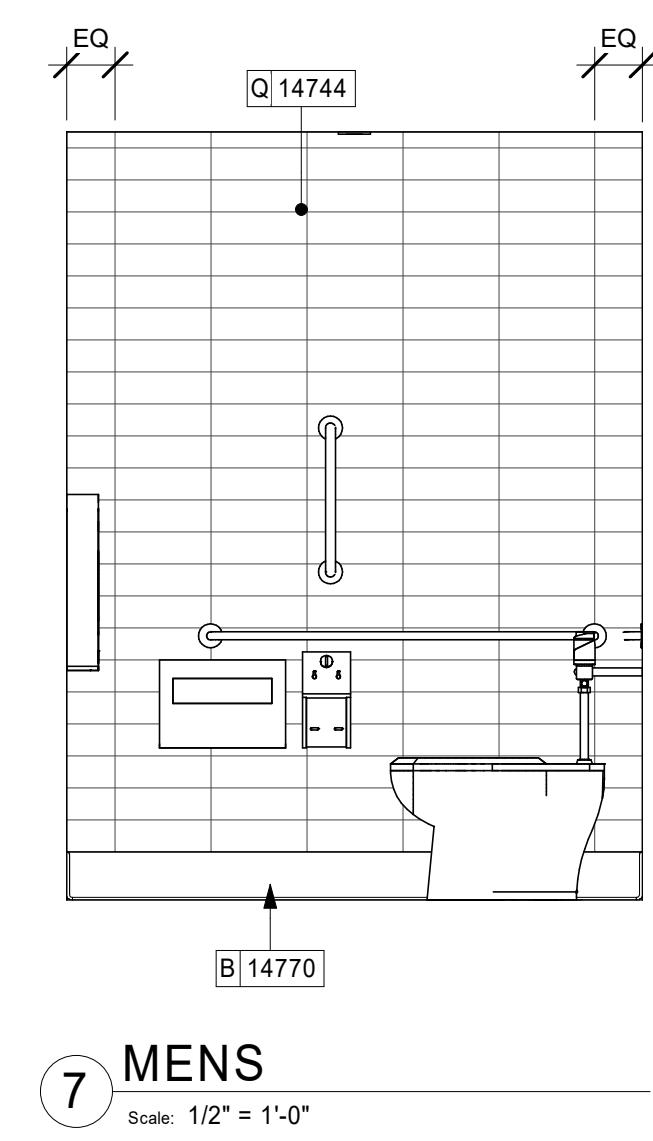
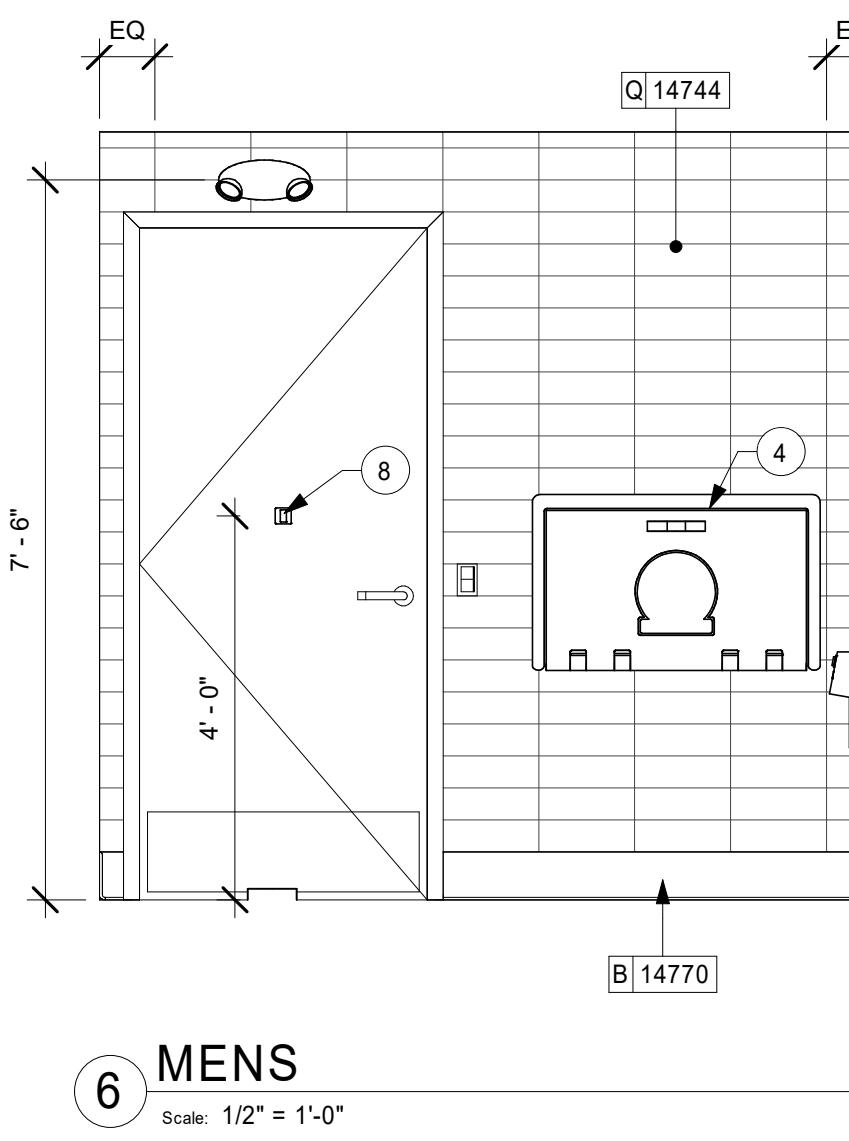
1 1ST FLOOR - ENLARGED RESTROOM PLAN
Scale: 1/2" = 1'-0"

2 WOMENS
Scale: 1/2" = 1'-0"

3 WOMENS
Scale: 1/2" = 1'-0"

4 WOMENS
Scale: 1/2" = 1'-0"

5 WOMENS
Scale: 1/2" = 1'-0"



1/20/2020