

DESIGN CRITERIA:	
PROJECT NAME BUILDING SQUARE FOOTAGE	NORTEX STOCK 1844 CLASSROOM 761 SF
2002 NEC 2003 IBC 2003 IMC 2003 IPC 2003 IECC 1994 TAS USE GROUP:	E
CONSTRUCTION TYPE	EC-V-B
OCCUPANT LOAD:	39
PERMISSIBLE GAS TYPE	<input type="checkbox"/> LP <input type="checkbox"/> NATURAL <input checked="" type="checkbox"/> NA
DESIGN LOADS:	
ROOF LIVE LOAD: FLOOR LIVE LOAD: COM. FLOOR LIVE LOAD: WIND LOAD: EXPOSURE: SEISMIC DESIGN CATEGORY:	30 PFS 100 PFS (SEE BLOCK S-101) 2600 LBS (130 MPH 3-SEC GUST) B C
SPECIAL CONDITIONS AND/OR LIMITATIONS:	
1. HANDICAP ACCESS TO BE PROVIDED PER 1994 TAS AS REQUIRED BY OTHERS. 2. BUILDING TO BE LOCATED PER TABLE 602 OF THE 2003 IBC. 3. ANY REQUIRED ALARM SYSTEM WILL BE INSTALLED ON-SITE BY OTHERS. 4. RESTROOMS TO BE PROVIDED BY OTHERS PER TAS AND EC 5. WATER FOUNTAIN SHALL BE FURNISHED BY OTHERS PER IFC-2003 TABLE 403.1.	
FOUNDATION NOTES:	
1. TIE DOWN ANCHORING SEE SHEET S-101 2. CRAWL SPACE VENTILATION PROVIDED BY SITE INSTALLER PER 1203.3.1 OF 2003 BC	
SCOPE OF WORK:	
NOT INCLUDED IN SCOPE OF WORK: 1. UTILITIES AND UTILITY CONNECTIONS 2. Poured concrete (driveway, sidewalk, slabs, footings, etc.) 3. SITE PREPARATION 4. TAX OF ANY KIND 5. BUILDING PERMITS SITE WORK 1. NO PROVISION FOR SITE WORK HAS BEEN INCLUDED. IT IS PRESUMED THE SITE WILL PROVIDE CLEAR ACCESS FOR TRUCKS AND MODULARS. ADEQUATE DRAINAGE TO BE PROVIDED. 2. ALL ELECTRICAL, PLUMBING, SEWER & GAS SERVICE CONNECTIONS AND ALL CONCRETE WORK ON-SITE TO INCLUDE Poured FOOTINGS, SLABS, FOUNDATIONS, SIDEWALKS, DRIVEWAYS OF WHATEVER KIND ARE THE RESPONSIBILITY OF OTHERS.	
IDENTIFICATION:	
STATE DECAL: TDUR DECAL AND MANUFACTURERS DATA PLATE ON ELECTRICAL PANEL DECAL NORTEX PLACED ON FRONT LEFT OF BUILDING	
FRAME / CHASSIS:	
OUTRIGGERS: 40° O.C. CROSSMEMBERS: 40° O.C. BEAM: 12" JR-I-BEAM HITCH: DETACHABLE HITCH AXLES: (4) WIDEPAKS ON ONE AXLE, DRAG ON THREE Tires: L (12-PLY) FRAME: HEAVY	

FLOOR:	
BOTTOM BOARD INSULATION JOIST SIDEBAND JOIST (RA): DECKING UNDERLAYMENT COVERING BASE COVE	ROLL, POLYETHYLENE FIBER MESH R-22 FACED 2X6 #25YP OR BETTER AT 16" O.C. 2X8 #25YP OR BETTER 3/4" T&G OSB (DRY GUARD), GLUED & ATTACHED W/ MFL 1-1/2" SCREW SHANK NAILS NA 20OZ CARPET=SANDBERGS 4" RUBBER COLOR=GRAY
EXTERIOR WALLS:	
SIDEWALL HEIGHT: 10'-1 1/2"	STUDS: 2X4 #25YP 12" O.C. BOTTOM PLATE: SINGLE 2X4 #3SPF OR BETTER TOP PLATES: DOUBLE 2X4 #3 SPF OR BETTER HEADERS: DOUBLE 2X6 #25YP W/ 7/16" FILLER JACK STUDS: SINGLE EACH SIDE OF CER & XGS 2X4 #25YP AT 36" STI FIRE BLOCKING: 2X4 #3SPF OR BETTER ON EDGE AT THE CEILING LINE INSULATION: R-15 FACED SHEATHING: 7/16" OSB AT END WALLS. SIGN: 3/8" SMART PANEL TRIM 1X4 SMART PANEL SKIRTING: SHIP LOOSE 9 4X12 SHTS SMART PNL PAINTED TO MATCH BODY IF ORDERED IF SKIRTING IS ORDERED, 12"X12" VENTS TO BE SHIPPED WITH MATE 6
INTERIOR WALLS:	
WALL HEIGHT: 10'-1 1/2"	STUDS 2X4 STUD GRADE SPF OR BETTER 16" O.C. BOTTOM PLATE: SINGLE 2X4 #3 SPF OR BETTER TOP PLATES: DOUBLE 2X4 #3 SPF OR BETTER FIRE BLOCKS: 2X4 #3SPF OR BETTER ON EDGE AT CEILING LINE COVERING: 5/8" FIRE-X VCG COLOR: HAMPTON GRAY TRIM: STANDARD VCG BATTENS INSULATION: R-15 UNFACED THROUGHOUT.
WINDOWS:	
SIZE/TYPE: (2) 24"X52" V.S. BRONZE FRAME/CLEAR LOW E GLASS BRAND: HR MN ENERGY VALUES: U-FACTOR=.51 SHGC=.34 COVERING: (2) ALUMINUM MINI-BLINDS COLOR: GRAY MSC: NA	
DOORS:	
EXTERIOR: EXTERIOR HARDWARE INTERIOR: INTERIOR HARDWARE	(2) 36"X80" 18GA STEEL W/ 5"X20" PENCIL WINDOW (NE/P) (2) DEADBOLT (SCHLAGE) 6060 BD + 26D WIC CONSTR. CORE (2) 9305BC x AL NORTEX CLOSURE (2) HOLLOW METAL FRAME (4) PULL PLATES ROCKWOOD #107 x 76C x US28 (2) PEMKO THRESHOLD 17BA-36 (2) PEMKO SWEEP 315C4-36 (2) SET PEMKO WEATHERSTRP 303AV-3070 (1) 36"X80" SC MOHAWK W/STEEL REFRAME IF MIDDLE WALL IS INSTALLED
HVAC:	
HVAC EFFICIENCY: THERMOSTAT: DUCTS: SUPPLY REGISTERS: RETURN REGISTERS: MSC:	(1) 1 TON WITH 10KW HEAT STRP W/ 60AMP OUTSIDE DISCONNECT. BRAND: BARD COLOR: TAN SEER 10.6, EER 9.2 > MINIMUM SEER 9.7 PER 2003 ECO TABLE 803.2.2(1) (1) PROGRAMMABLE DUCT BOARD MAN. FLEX TO GRILLS IN UNCOND. SPACE R-4.1 MIN VALUE AT PLUMIN WALL WITH GRILL-EXTRA WALL OPTION USE 24X24 WITH 12" FLEX TO JUMP WALL FRESH AIR MAKEUP IS PROVIDED BY DAMPER IN HVAC
PLUMBING:	
FURNITURE OR MISC:	
SLD ABC FIRE EXTINGUISHER IN CABINET NEAR ENTRANCE	



ROOF:		
RAFTER RIM SHEATHING COVERING BOTTOM RAFTER SHEATHING ROOF RITCH CEILING INSULATION PLUMA VENTS	2X10 #25YP 16" O.C. 1 3/4" LVL 16" TAPER CUT TO 9 1/4" 7/16" MULSHED FR DECK PANEL C COLOR: WHITE STANDARD .045 MUL-HIDE EPOXY ADHERED WITH MUL-HIDE ACRYLIC WATER BASED BONDING ADHESIVE NET TO HOLD INSULATION 25/12 TRANSVERSE 8'-6" HEIGHT, 2X4 LAY IN PANELS (2) LAYERS R-15 WALL RETURN 1" ABOVE INSULATION	
ELECTRICAL:		
SERVICE LOAD CENTER ENTRANCE WIRING LIGHTS FANS SURGE PROTECT EXIT/EMERG. LIGHT	120/240V SINGLE PHASE (1) 100 AMP, INT MOUNT LOAD CHT. W/ #6 BARE GROUND 2" PIPE DOWN METAL MC CABLE W/ #12 (6G AT HVAC) (8) 40" T-8 (3) TUBE 32 WATT FLUOR. FIXTURES (92 FIXTUREWATTS) (2) PHOTO CELL EXTERIOR 13 WATT @ 860 LUMENS = 66 LUMENS PER WATT OPTIONAL (2) EXIT/EMERGENCY LIGHT BATTERY BACK UP.	
TRANSPORTATION:		
7/16 10-12 LVL 8 10'-1 1/2" 0 3/4" 2X8 2'-6"	ROOF DECK ROOF RAFTER UNDERSIDE RAFTER TALLEST WALL 0 FLOOR DECK FLOOR JOIST TO ROAD APPROX	0.016667 1.5 0 10.1 0 0.0625 0.0041667 2.5
14.000333 FT TOTAL WEIGHT APPROX. 1042 LBS		
ENERGY CODE COMPLIANCE:		
CHECKLIST CERTIFICATES TO BE USED AS CHECKLIST. 3 TUBE LIGHT FIXTURES IS 92 FIXTUREWATTS EXTERIOR LIGHT IS 13 WATT @ 860 LUMENS = 66 LUMENS PER WATT. WINDOWS ARE U=.51 AND SHGC=.34 OR BETTER DOOR U VALUE IS DEFAULT .7		
CONSTRUCTION AREA:		
(1) SIDEWALL = 44' X 10'-0 3/4" = 563.5 SF + PEAK AREA OF 16.3 SF = 579.8 SF (1) ENDWALL = 11'-9" X 10'-0 3/4" = 118 SF SIDEWALL X 2 = 1539.8 SF + ENDWALL X 2 = 236 SF FOR A TOTAL OF 1395.6 SF		
DRAWING INDEX:		
C-001 = COVER A-101 = FLOOR PLAN A-201 = EXTERIOR ELEVATIONS A-301 = SECTION E-101 = ELECTRICAL PLAN M-101 = MECHANICAL(HVAC) PLAN P-101 = NOT USED SF-101 = FLOOR FRAMING PLAN SF-102 = FLOOR DECKING/WALL LAYOUT PLAN SF-103 = ROOF FRAMING PLAN SF-201 = ROOF FRAMING LONG. SECTION S-101 = BLOCKING PLAN		
NOTE: ALL NAILING PATTERNS SHOWN ON SF PAGES SHALL OVERRIDE DESIGN MANUAL.		
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ltr	revision	by	date	drawn by:	project:	title:	dwg#	sheet:
				REW	NORTEX 1844 CLASSROOM STOCK	1844 STOCK COVER		G-001
				DATE: 12/21/07	SCALE: N/A		1844STK	

AREA SCHEDULE						
DESIGNATION	DESCRIPTION	FLOOR AREA	FLOOR	WALL	CEILING	BASE
100	CLASSROOM	781	CARPET	8' VINYL COVERED GYPSUM TYPE X	2'X4' LAY IN	4" RUBBER BASE

WINDOW SCHEDULE			
DESIGNATION	DESCRIPTION	RD	DTY
VI	2044 ALUHINUM BRONZE FRAME, DOUBLE INSULATED LOW E GLASS W/ ALUHINUM MINI BLINDS	24 $\frac{1}{2}$ " x 52 $\frac{1}{2}$ "	2

DOOR SCHEDULE					
DESIGNATION	SIZE	DOOR MATERIAL	FRAME	RD	QTY
D1	306BL	STEEL W/ PENCIL VISION	STEEL	40 $\frac{1}{2}$ " X 82 $\frac{1}{2}$ "	1
D2	306BR	STEEL W/ PENCIL VISION	STEEL	40 $\frac{1}{2}$ " X 82 $\frac{1}{2}$ "	1
D3,OPT.	306BL	1-3/4" SC HORAVIC	STEEL	37 $\frac{1}{2}$ " X 81 $\frac{1}{2}$ "	1

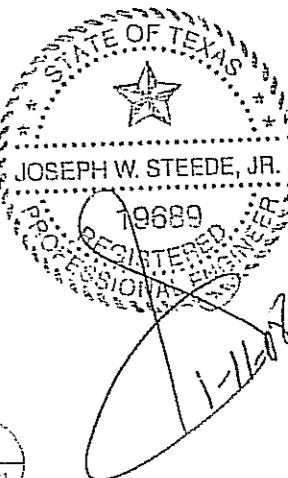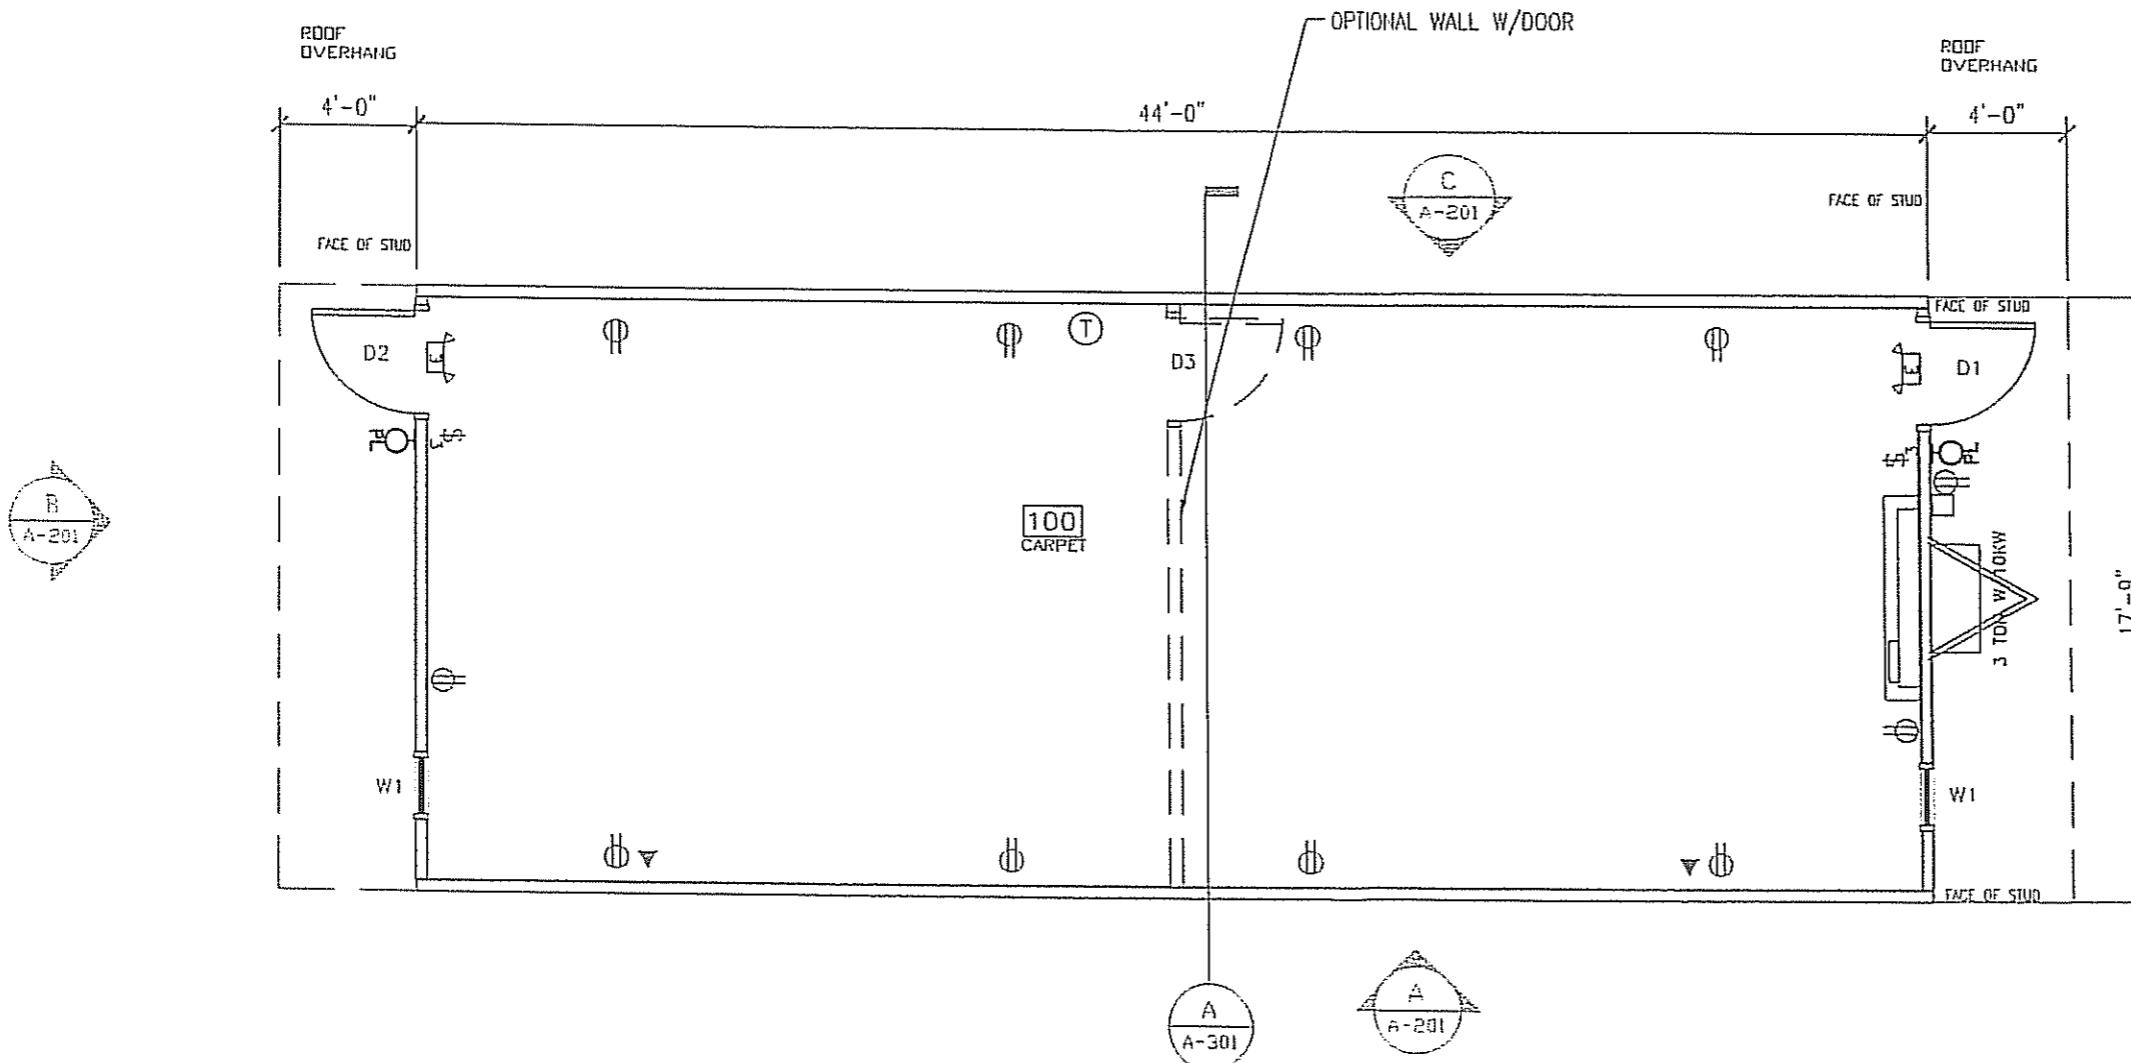

OPTIONAL WALL NOTES:

1. ADD EXIT LIGHTS ON BOTH SIDES OF DOOR.
2. CUSTOMER TO SUPPLY A SIGN THAT THE DOOR MUST REMAIN UNLOCKED DURING BUSINESS HOURS.
3. LIGHTS ARE TO BE CHANGED TO SINGLE POLE SWITCH, EACH CONTROLLING (4) LIGHTS IN IT'S RESPECTIVE HALF.


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IHDRA 7


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FLOOR PLAN

$$3/16^{\circ} = 1^{\circ} - 8'$$




C BACK ELEVATION
3/16" = 1'-0"

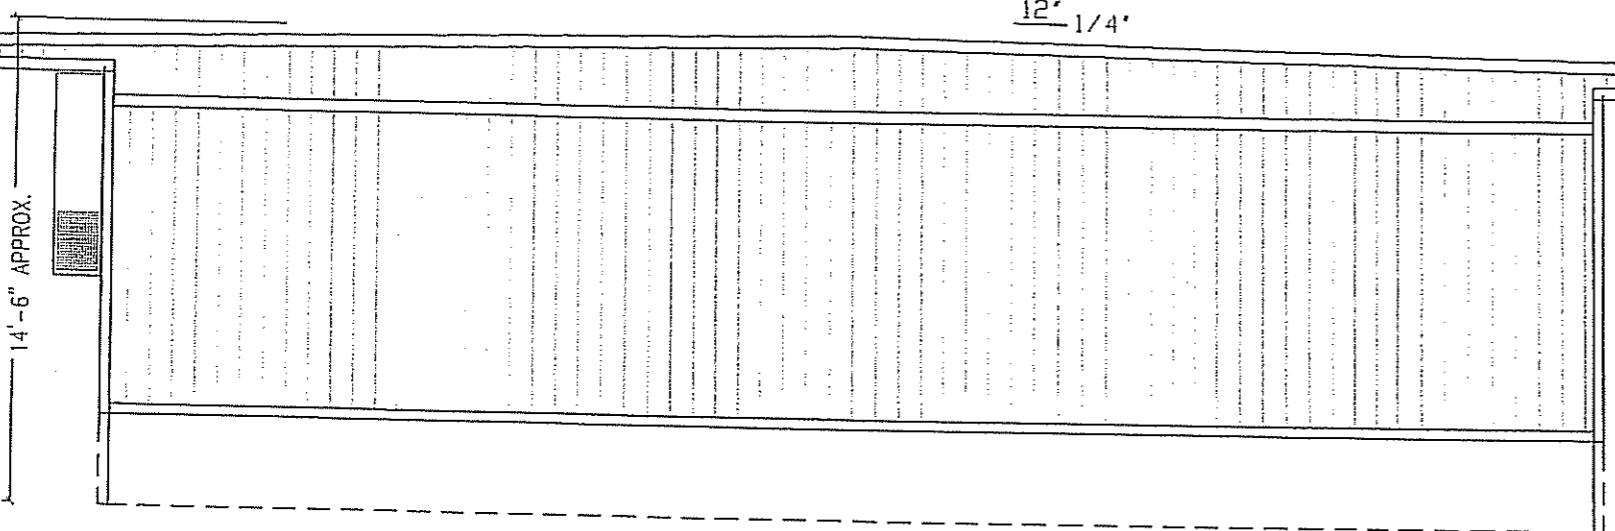

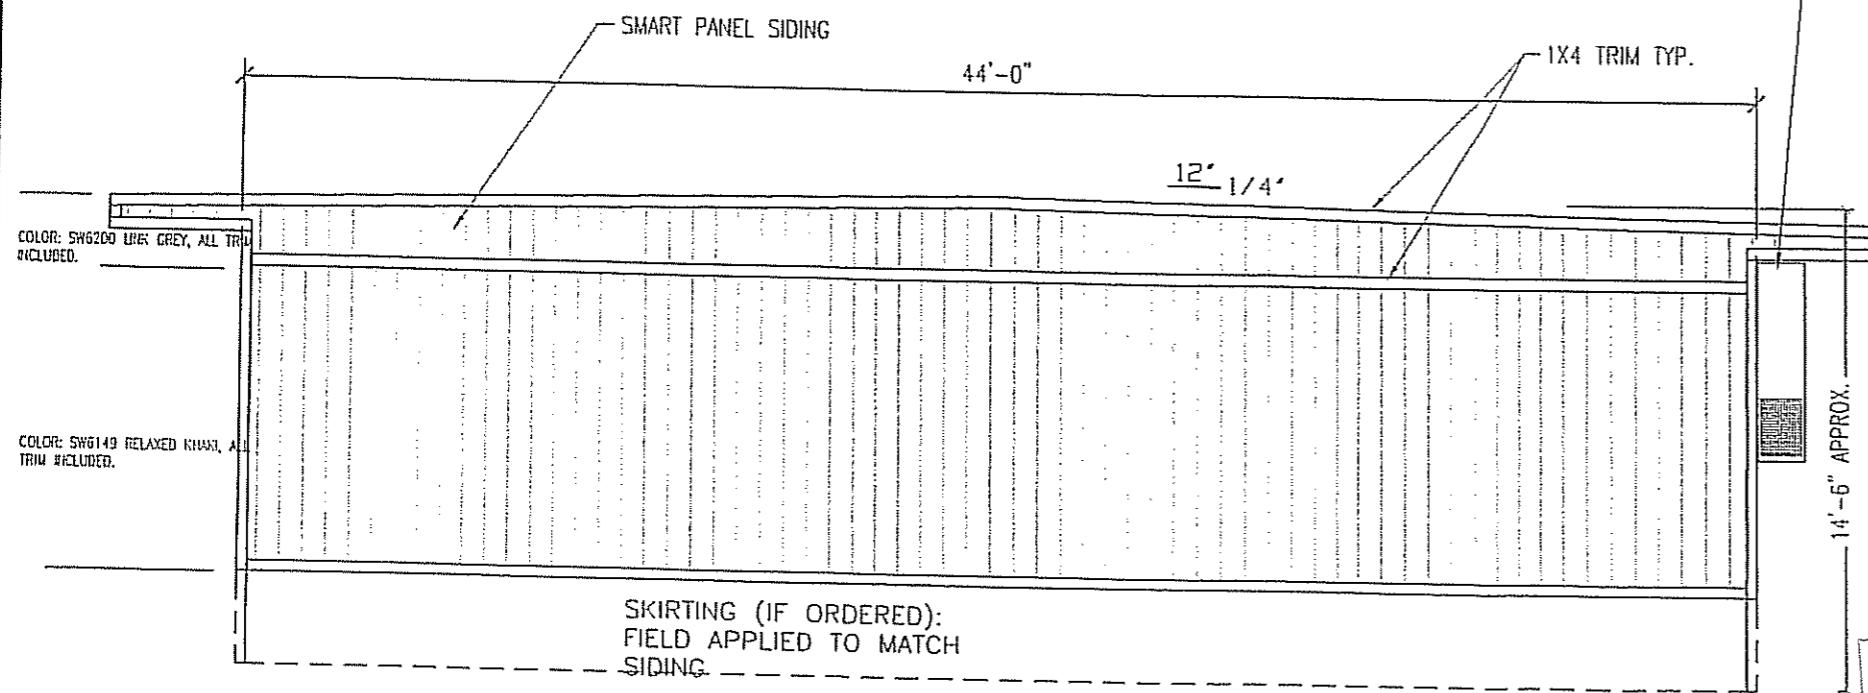
"A" FRONT ELEVATION

A BACK ELEVATION
3/16" = 1'-0"


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				REW	NORTEX 1844 CLASSROOM STOCK	1844 STOCK ELEVATIONS		
				DATE: 12/21/07	SCALE: 3/16" = 1'-0"		1844STK	A-201

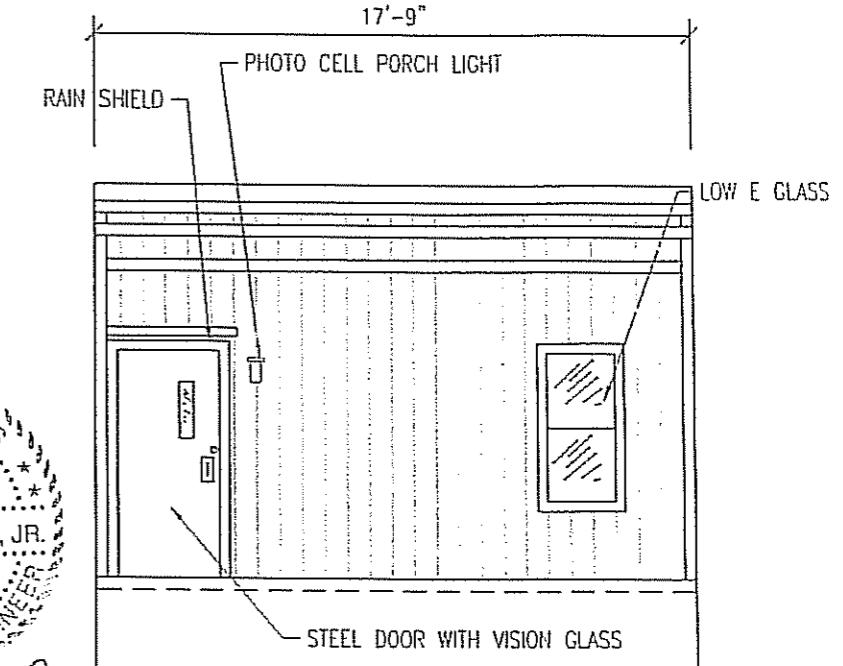

C BACK END ELEVATION
3/16" = 1'-0"

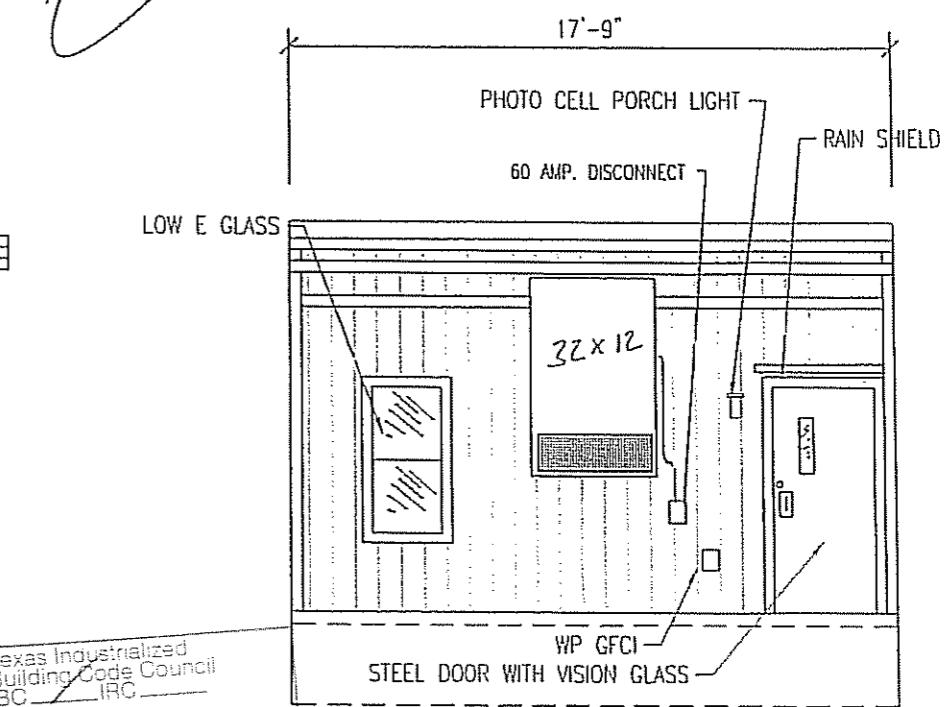


D BACK END ELEVATION
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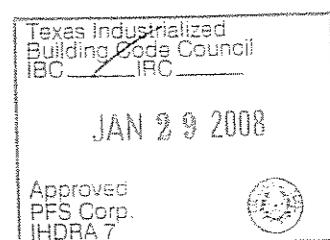
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A CROSS SECTION
1/4" = 1'-0"

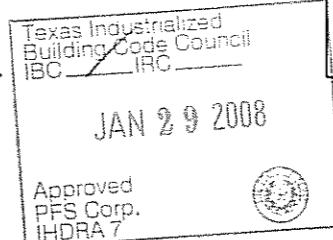

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LTR	REVISION	BY	DATE	DRAWN BY: REW	PROJECT: NORTEX 1844 CLASSROOM STOCK	TITLE: 1844 STOCK SECTION	DWG# 1844STK	SHEET: A-301	NORTEX MODULAR SPACE 555 JUBILEE LANE LEWISVILLE, TX 75056 PHONE: 972-492-4040 FAX: 972-492-2704
				DATE: 12/21/07	SCALE: 1/4" = 1'-0"				

PANEL HOOKUP, WIRE AND BREAKER SIZING.

MIN WIRE SIZE		100 AMP 2-POLE 120V/240V MAIN BREAKER						MIN WIRE SIZE
		"A"		"B"				
BREAKER	LEG	CKT	CKT	LEG	BREAKER			
60	A	1	2	A	20	LIGHTS	12	
2P	B	3	4	B	20	RECEPTS, PORCH, EMEG.	12	
12							12	
RECEPTS	20	A	5	6	A	20		
WP RECEPT	20	B	7	8	B	20		
NOT USED	20	A	9	10	A	20		
NOT USED	20	B	11	12	B	20		
NOT USED	A	13	14	A		NOT USED		
NOT USED	B	15	16	B		NOT USED		
NOT USED	A	17	18	A		NOT USED		
NOT USED	B	19	20	B		NOT USED		
NOT USED	A	21	22	A		NOT USED		
NOT USED	B	23	24	B		NOT USED		

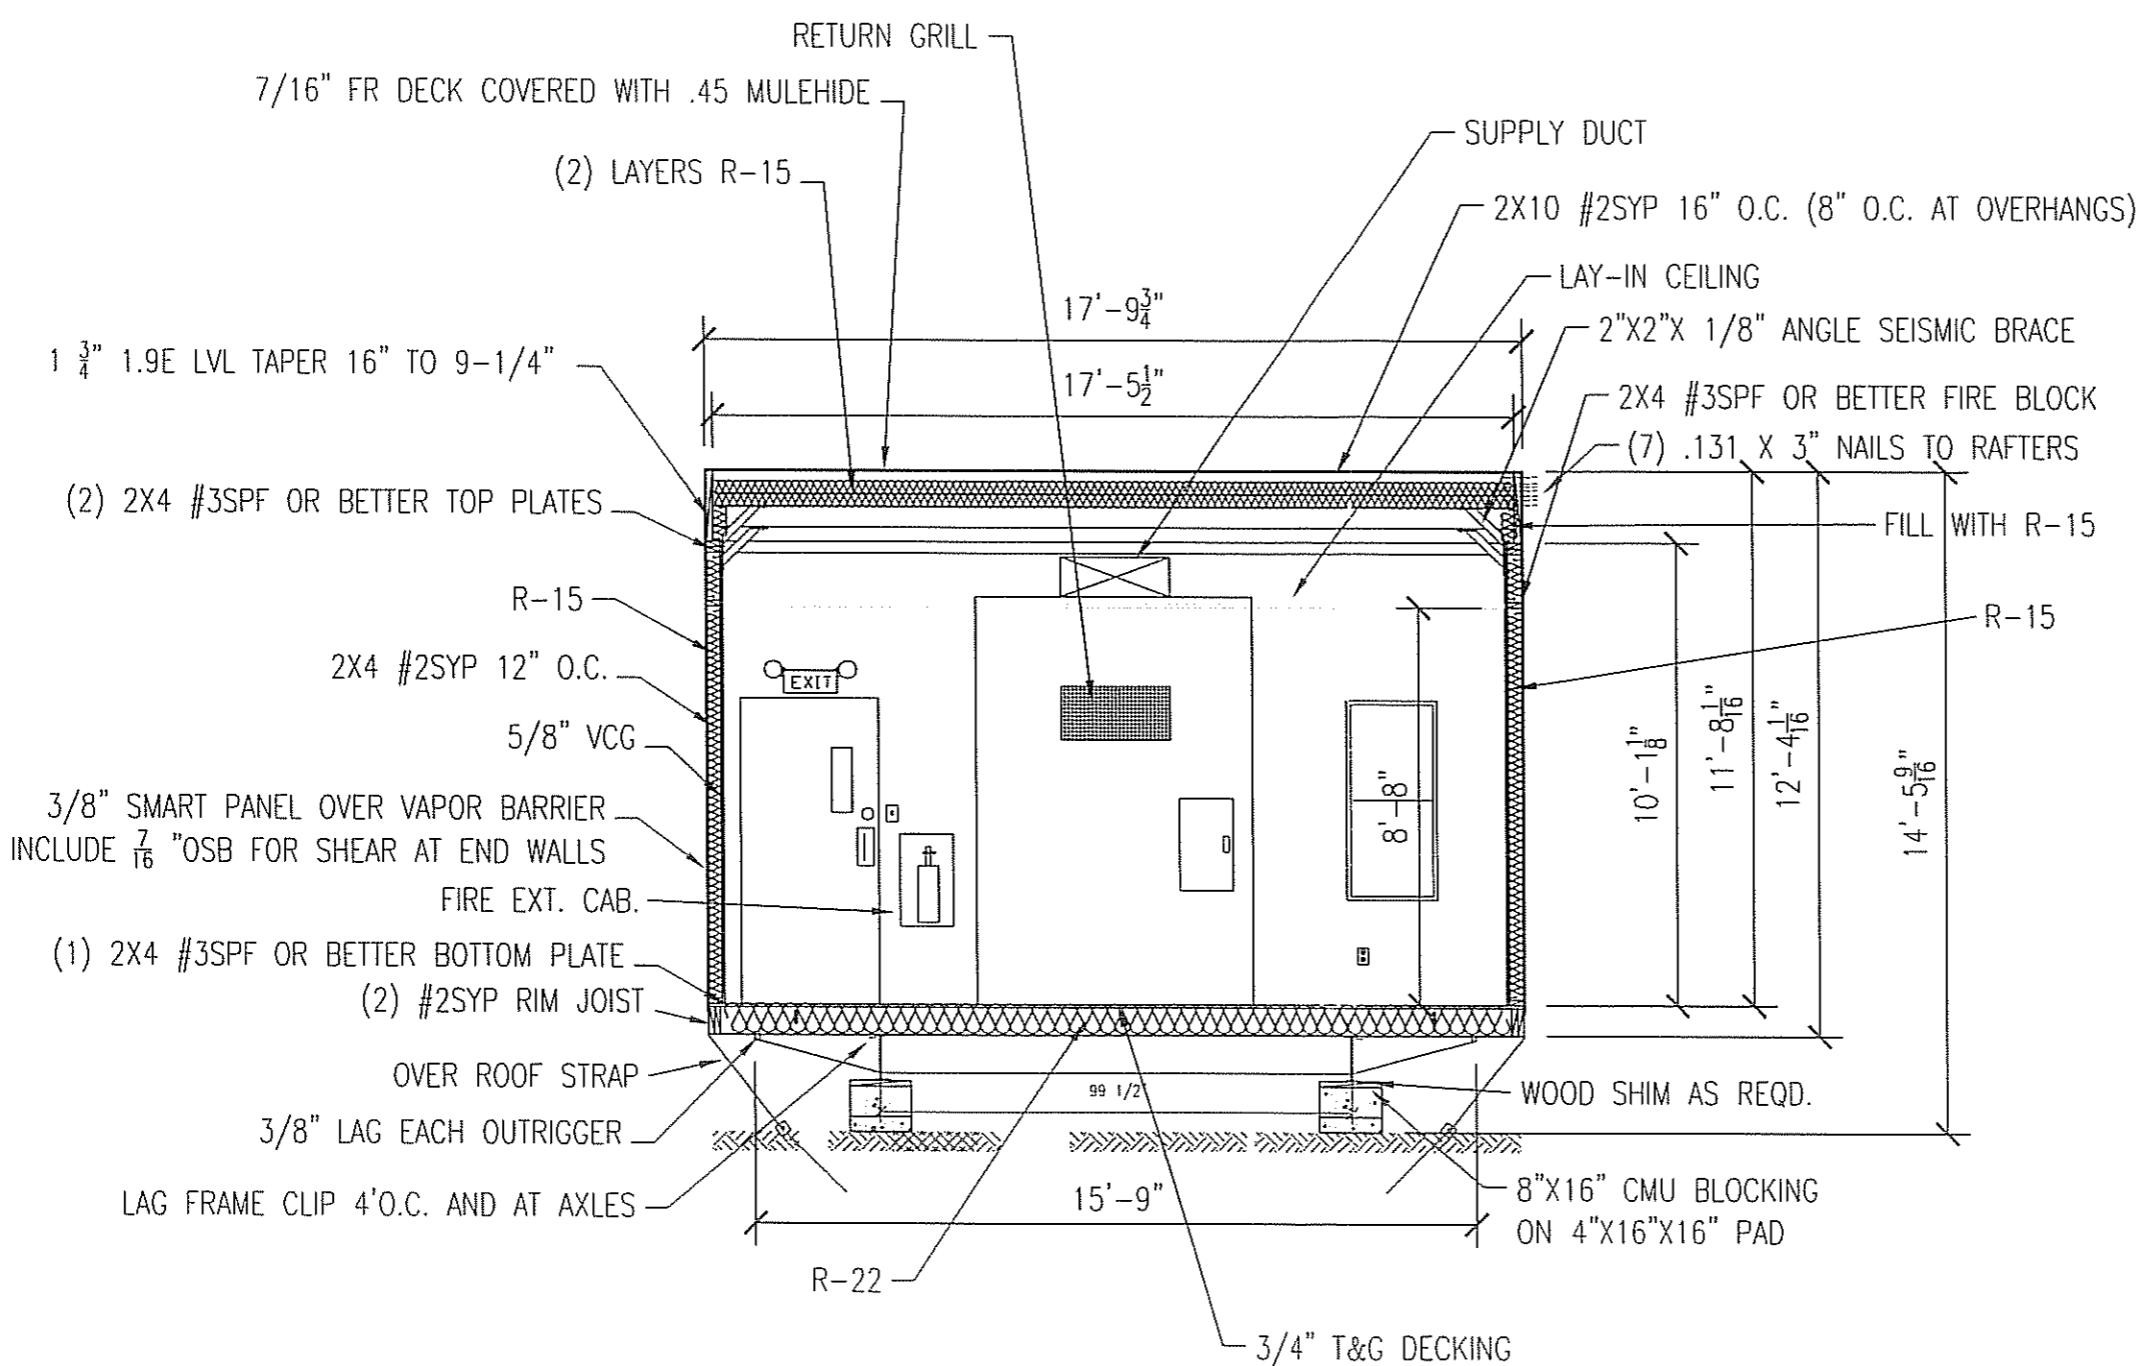	AMPS EA.	ITEM	WATTS EA
	1.5	RECEPTS	100
BULBS	0.77	LIGHTS 2X4' 3-TUBE T-8	92
	0.8	90 CFM EXHAUST FAN	96
BULBS	0.31	LIGHT 2X2' U-TUBE T-8	38
	0.033333	EMERGENCY/EXT	4
	0.108333	PORCH LIGHT	13
	22.9	EeMAX	2633.5
	59	HVAC	7000
			0
			0
			0

SS SURGE PROTECTOR

CAN LIGHT LIGHT

2'X4' TROFFER LIGHT T-8
ELEC. BALLAST, 3-BULB

EMERGENCY EXIT LIGHT

PORCH LIGHT

\$ SINGLE POLE LIGHT SWITCH

\$ OS OCCUPANCY SENSOR SWITCH

\$ D DIMMER SWITCH

\$ 3WAY SWITCH

DUPLEX OUTLET

SURGE BLOCK OUTLET

SBO WEATHER PROOF DUPLEX GROUND
WP FAULT INTERRUPT OUTLET
GFCI

CEILING OUTLET

CO



DATA DROP

VOICE DROP

PANEL SP-1 100 AMP 2-POLE 120V/240V SINGLE LOAD PHASE MAIN BREAKER

CALCULATIONS

LEG	CKT	DESCRIPTION	LEG A-AMPS	LEG B-AMPS	LEG A-WATTS	LEG B-WATTS
A	1	HVAC	59.00	-	7,080.00	-
A	2	LIGHTS	6.16	-	739.20	-
B	3	HVAC	59.00	-	7,080.00	-
B	4	RECEPTS,PORCH,EMG	-	7.05	-	941.52
A	5	RECEPTS	7.50	-	900.00	-
A	6		-	-	-	-
B	7	WP RECEPT	-	1.50	-	100.00
B	8		-	-	-	-
A	9		-	-	-	-
A	10		-	-	-	-
B	11		-	-	-	-
B	12		-	-	-	-
			72.66	60.35	8,719.20	8,201.52
		AMPS	72.66		TOTALS	16,920.72 WATTS
		W/20%	87.19			20,304.86 W/20%
		100AMP	OK		DIFF B-A	517.68 WATTS
					+/20%	2.55% OK
						84.60 AMPS
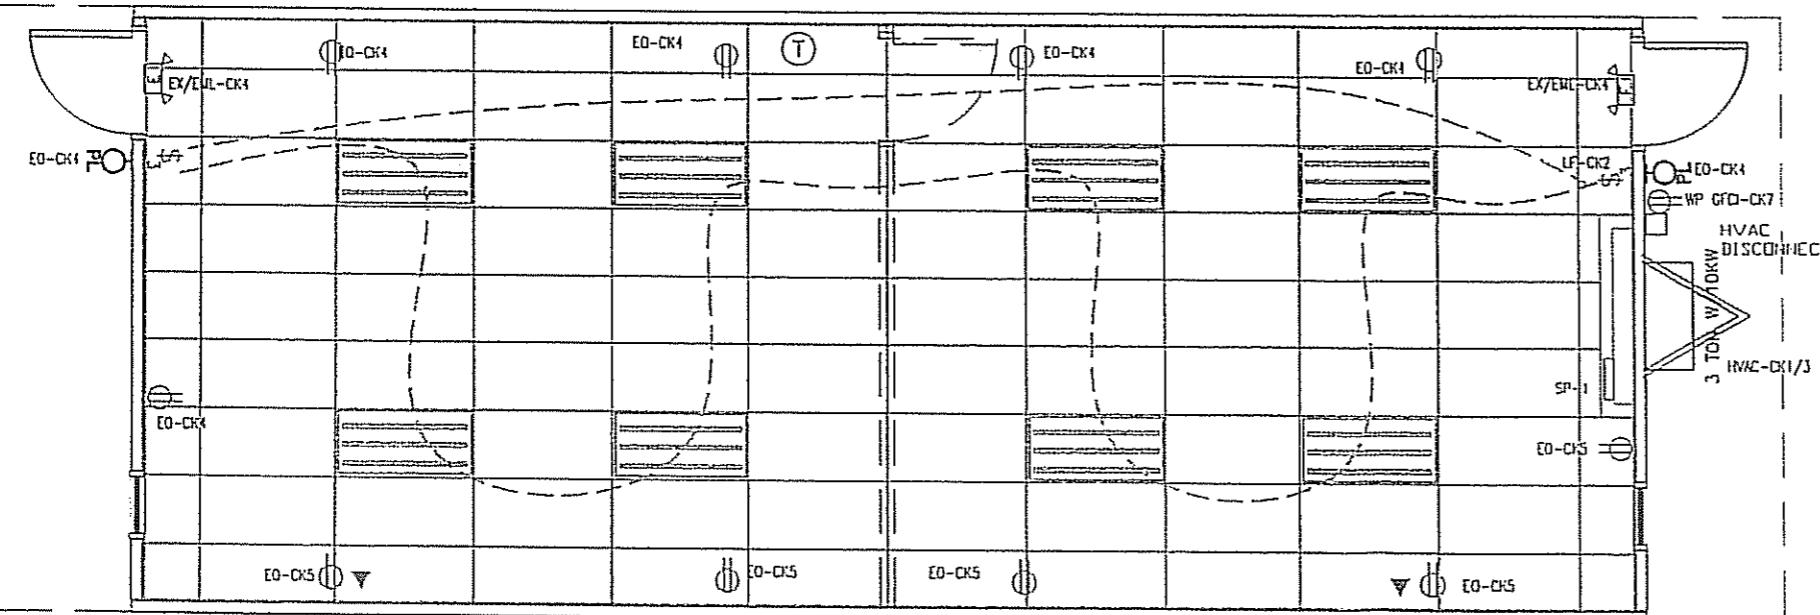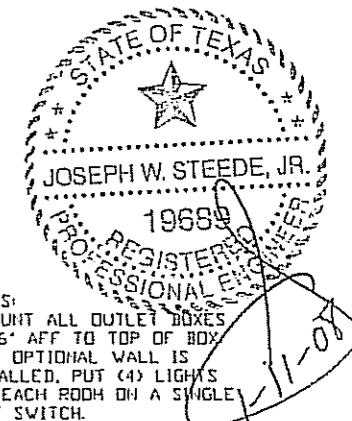
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JAN 29 2008

Approved
PFS Corp.
IHRA 7

NOTES:
1. MOUNT ALL OUTLET BOXES TO 16' AFF TO TOP OF BOX
2. IF OPTIONAL WALL IS INSTALLED, PUT (4) LIGHTS FOR EACH ROOM ON A SINGLE POLE SWITCH.
3. INSTALL JUNCTION BOXES IN THE CEILING FOR POSSIBLE EXIT LIGHTS ON BOTH SIDES OF DOOR OR CIRCUIT #4 IF DIVIDER WALL IS INSTALLED.
4. 3-TUBE LIGHT FIXTURE IS FIGURED AS 92 FIXTURE WATTS AND THE (1) TUBE FIXTURE AS 38 WATTS.

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ELECTRICAL PLAN




3/16" = 1'-0"

LTR	REVISION	BY	DATE	DRAWN BY:	PROJECT:	TITLE:	
				REW	NORTEX 1844 CLASSROOM STOCK	1844 STOCK ELECTRICAL PLAN	
				DATE:	12/21/07	SCALE:	

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DWG#	1844STK	SHEET:	E-101
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MECHANICAL SCHEDULE		
DESIGNATION	DESCRIPTION	COMMENTS
SAI	2X2 SUPPLY AIR REGISTER	ADJUSTABLE
RA1	RETURN GRILL AT PLENUM WALL	HOLE
RA2	OPTIONAL RETURN JUMP 2'X2' WITH 12" FLEX	
T	THERMOSTAT	PROGRAMMABLE
3 TON W/10KW	BARD MODEL	



NOTES:
 1. PLENUM CAVITY ABOVE LAY IN CEILING.
 2. PLENUM WALL TO HAVE OPENINGS CUT AND GYBED TO ACROSS 30X16 AREA.
 3. OFFICE WALLS AND 2X6 WALL TO HAVE OPENING FOR DUCT TO PASS THRU FABRICATED INTO TRADING.
 4. FLEX DUCIS NOT TO BE CUT INTO MAIN DUCT LESS THAN 12" FROM A TRAVERS.
 5. ALL DUCIS TO HAVE A R-4.3 MINIMUM VALUE.
 6. AREA OPEN AROUND 16X10 DUCT THROUGH WALL WILL SERVE AS THE RETURN OF AIR FROM ROOM 103.

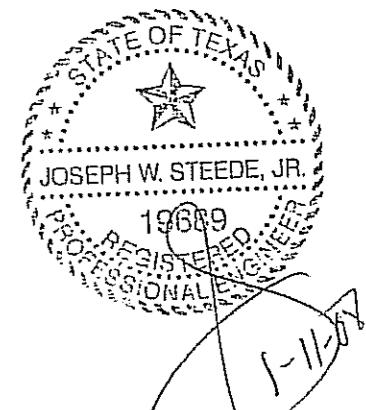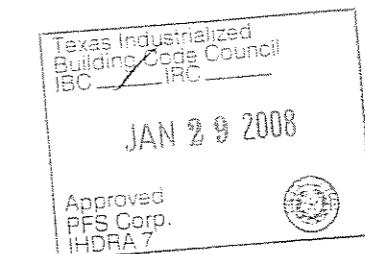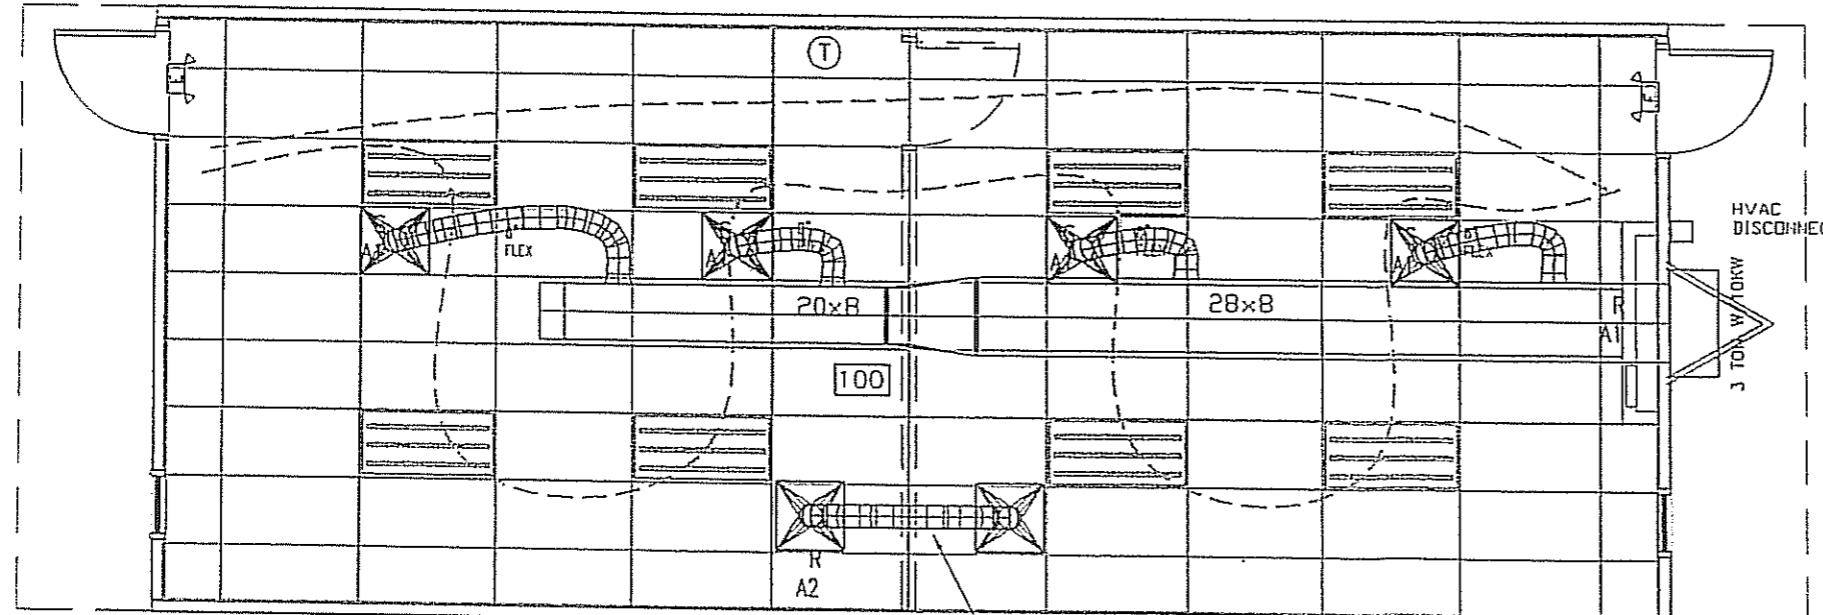
MECHANICAL PLAN

3/16" = 1'-0"

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				REW	NORTEX 1844 CLASSROOM STOCK	1844 STOCK MECHANICAL PLAN	1844STK	M-101
				DATE: 12/21/07	SCALE: 3/16" = 1'-0"			


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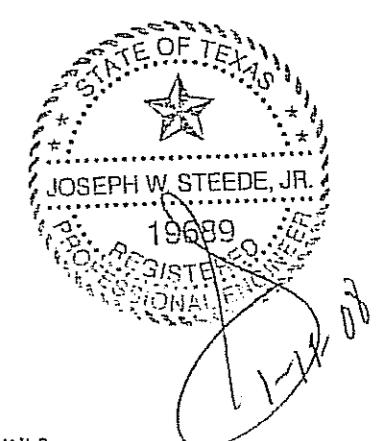


FLOOR JOIST PLAN

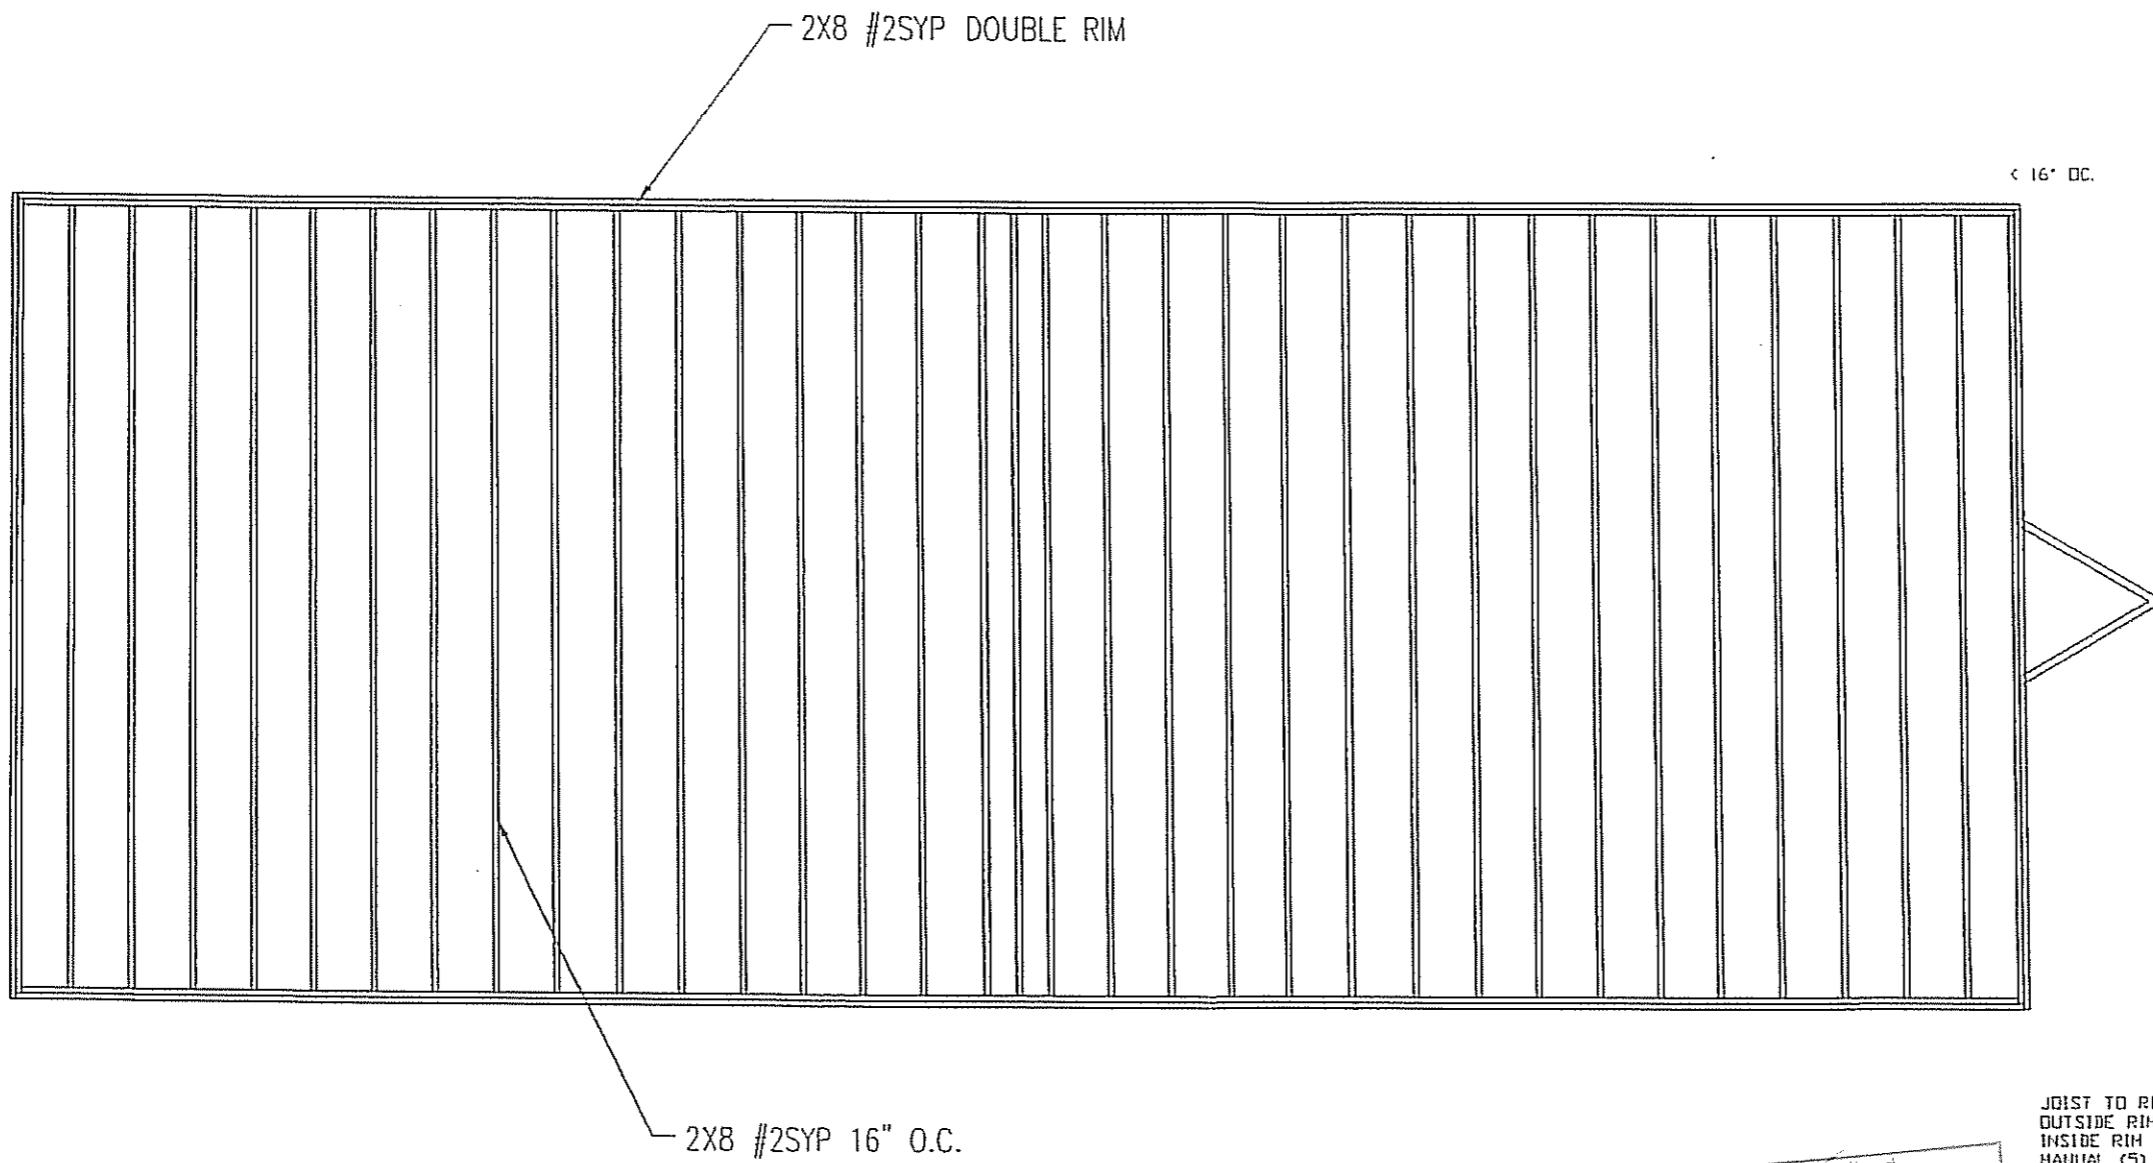1/4" = 1'-0"



JOIST TO RIM: (5) .131X3" NAILS
OUTSIDE RIM TO ACT AS SPLICE BLOCK FOR
INSIDE RIM JOINTS. FOLLOW NAIL PATTERN IN
MANUAL (5) EACH SIDE OF JOINT.

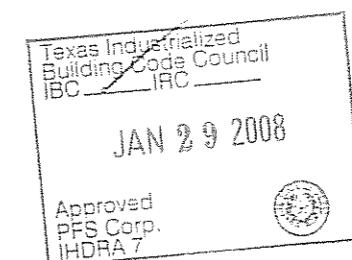

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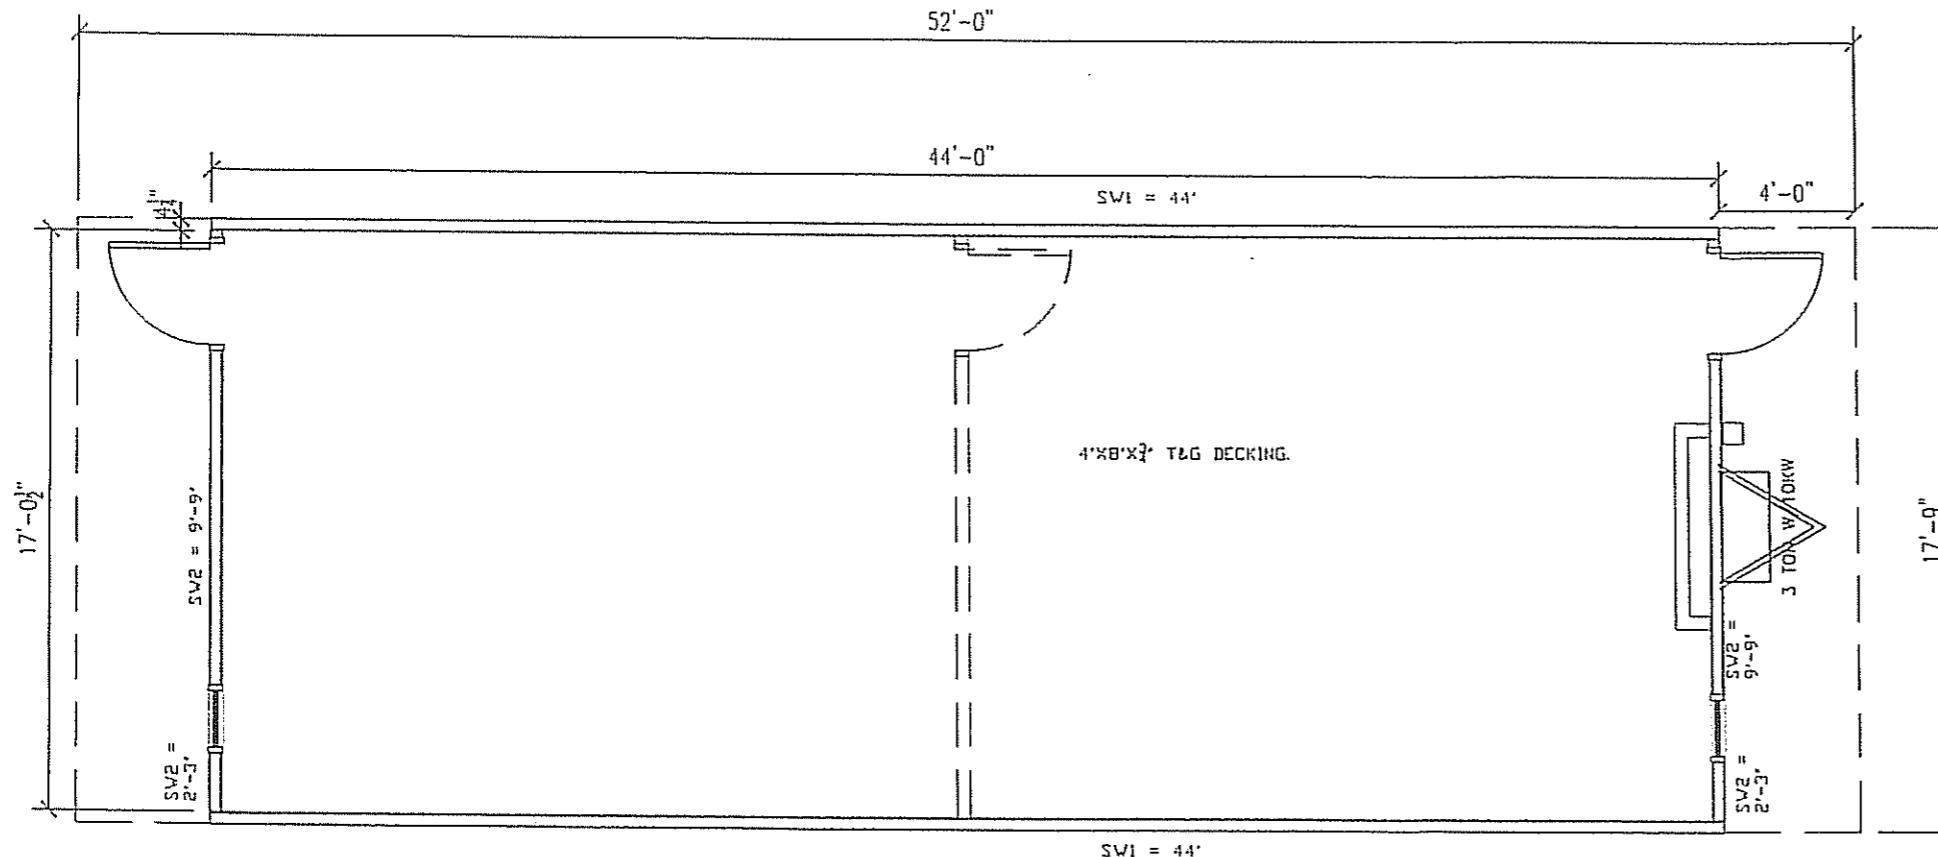
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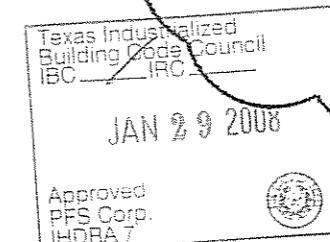
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				REW	NORTEX 1844 CLASSROOM STOCK	1844 STOCK FLOOR JOIST PLAN		
				DATE: 12/21/07	SCALE: 1/4" = 1'-0"		1844STK	SF-101

SHEARWALL SCHEDULE					
MARK	MATERIAL	FASTEN STUDS TO SIDING	FASTEN BOTTOM PLATE TO DECK	FASTEN TOP PLATE TO RAFTERS	FASTEN END TO SIDEWALLS
SW1	3/8" SMARTPANEL ONE SIDE 5/8" VCG OTHER SIDE	NAIL WITH .090 X 2 ¹ / ₂ " FOR 3/8" SMART PANEL AND 2" OSB AT 6" OC EDGE/12" OC FIELD. ADHESIVE VCG ON INTERIOR	.131 X 3" NAILS 16" O.C.	.131 X 3" NAILS 16" O.C.	.131 X 3" NAILS 16" O.C.
SW2	3/8" SMARTPANEL ONE SIDE OVER 7/16" OSB, 5/8" VCG OTHER SIDE	NAIL WITH .090 X 2 ¹ / ₂ " FOR 3/8" SMART PANEL 6"12" AND 2" OSB WITH .131 X 3" AT 4" OC EDGE/8" OC FIELD. ADHESIVE VCG ON INTERIOR	.131 X 3" NAILS 16" O.C.	.131 X 3" NAILS 16" O.C.	.131 X 3" NAILS 16" O.C.

TOP AND BOTTOM EDGE OF SIDING SHALL BE NAILED WITH .090 X 2¹/₂" NAILS 2¹/₂" O.C. TO THE RIM JOIST/LVL.



- NOTES:
1. ADHESIVE TO BE USED ON DECKING TO JOIST.
 2. ALL EDGES ARE UNBLOCKED.
 3. NAIL FLOOR DECKING 6" O.C. EDGES, 12" FIELD WITH 2 1/2" SCREW SHANK NAILS.
 4. ALL WALLS 2X4 #2SYP
 5. (2) KING STUDS ON EACH SIDE OF DOOR OPENINGS.
 6. WALL FRAMING SHALL BE 12" O.C.





FLOOR DECK/ WALL LAYOUT PLAN

3/16" = 1'-0"

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DALLAS, TX 75250 PHONE 972-238-1611

LTR	REVISION	BY	DATE	DRAWN BY:	PROJECT:	TITLE:	SCALE:	DWG#	SHEET:	STAMP
				REW	NORTEX 1844 CLASSROOM STOCK	1844 STOCK FLOOR DECK PLAN	3/16" = 1'-0"	1844STK	SF-102	
				DATE: 12/21/07	SCALE: 3/16" = 1'-0"					


NORTEX MODULAR SPACE
55 JUBILEE LANE
LEWISVILLE, TX 75056
PHONE: 972-492-4040
FAX: 972-492-2704

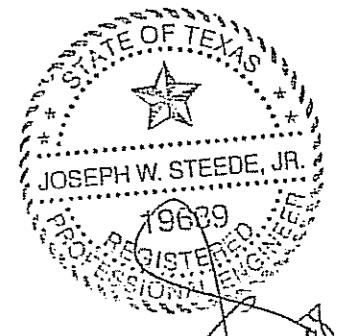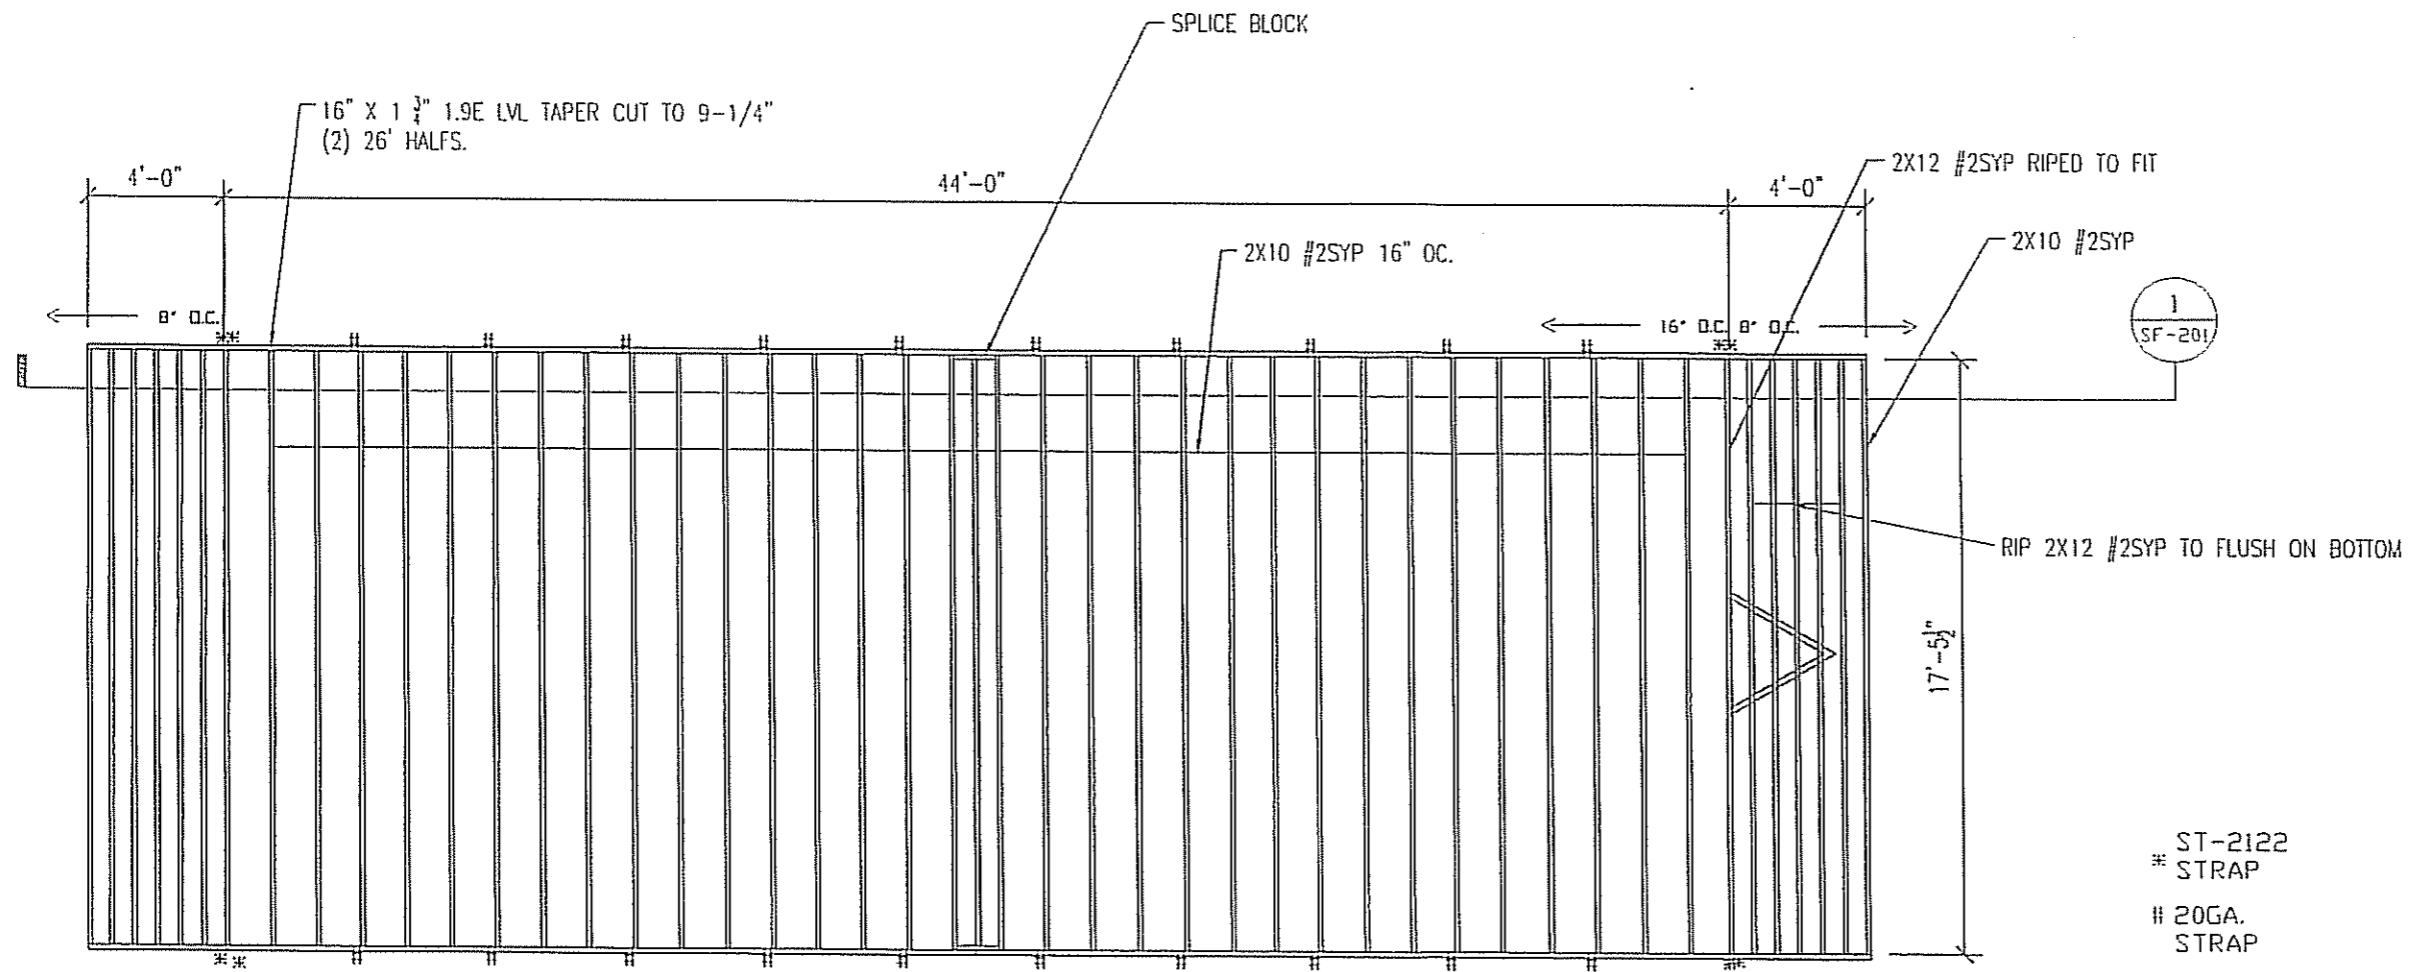

1-11-08

ROOF JOIST LAYOUT

$\frac{3}{16}$ " = 1'-0"

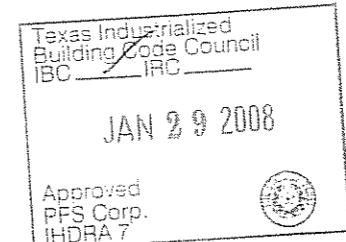




- NOTES:
1. FILL CAVITY WITH 2-LAYERS R-15.
 2. BOTTOM OF JOIST TO BE NET COVERED.
 3. ROOF DECK TO BE FR $\frac{7}{8}$ " DECK PANEL.
 4. ROOF DECK NAILING TO BE 4"OC EDGE & 8"OC IN FIELD WITH MIN. #10-21" SCREWS OR 2 $\frac{3}{8}$ " SCREW SHANK NAILS.
 5. NAIL JOIST TO LVL RIMS (7) .131 X 3"
 6. SPLICE BLOCKS (15) .131 X 3" EA. SIDE.
 7. TOE NAIL LVL RIM TO TOP WALL PLATES WITH .131 X 3" AT 16" O.C. OUTER SIDE ONLY.
 8. STRAP WITH ST-2122 AS SHOWN. USE 20 GAUGE STRAPS AT APPROX. 4" O.C. ALONG WALL TO STUDS WITH (4) 1" STAPLES EACH SIDE.

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LTR	REVISION	BY	DATE	DRAWN BY:	PROJECT:	TITLE:	DWG#	SHEET:
				REW	NORTEX 1844 CLASSROOM STOCK	1844 STOCK ROOF JOIST PLAN	1844STK	SF-103





ALL LUMBER TO BE #2SYP

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LTR	REVISION	BY	DATE	DRAWN BY:	PROJECT:	TITLE:	DWG#	SHEET:
				REW	NORTEX 1844 CLASSROOM STOCK	1844 STOCK LONG SECT.	1844STK	SF-201

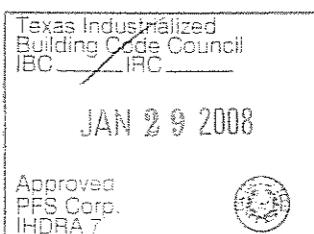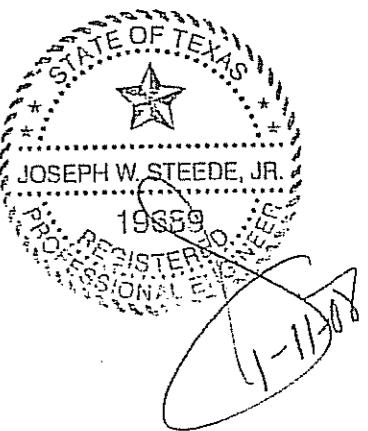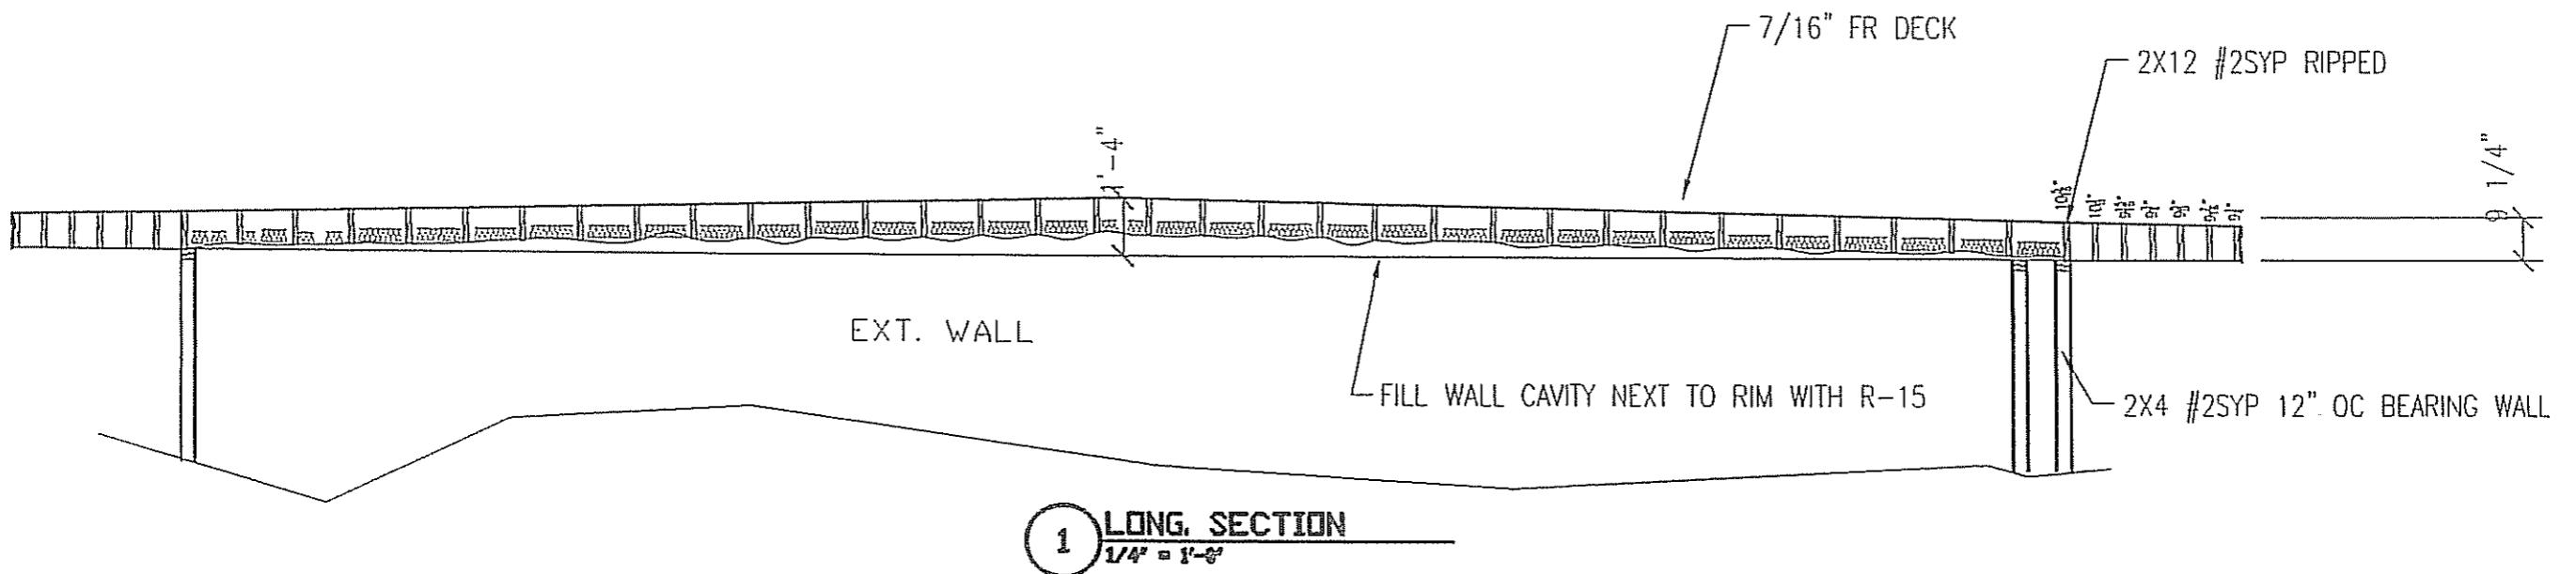

BLOCKING PLAN

248 = 1-0
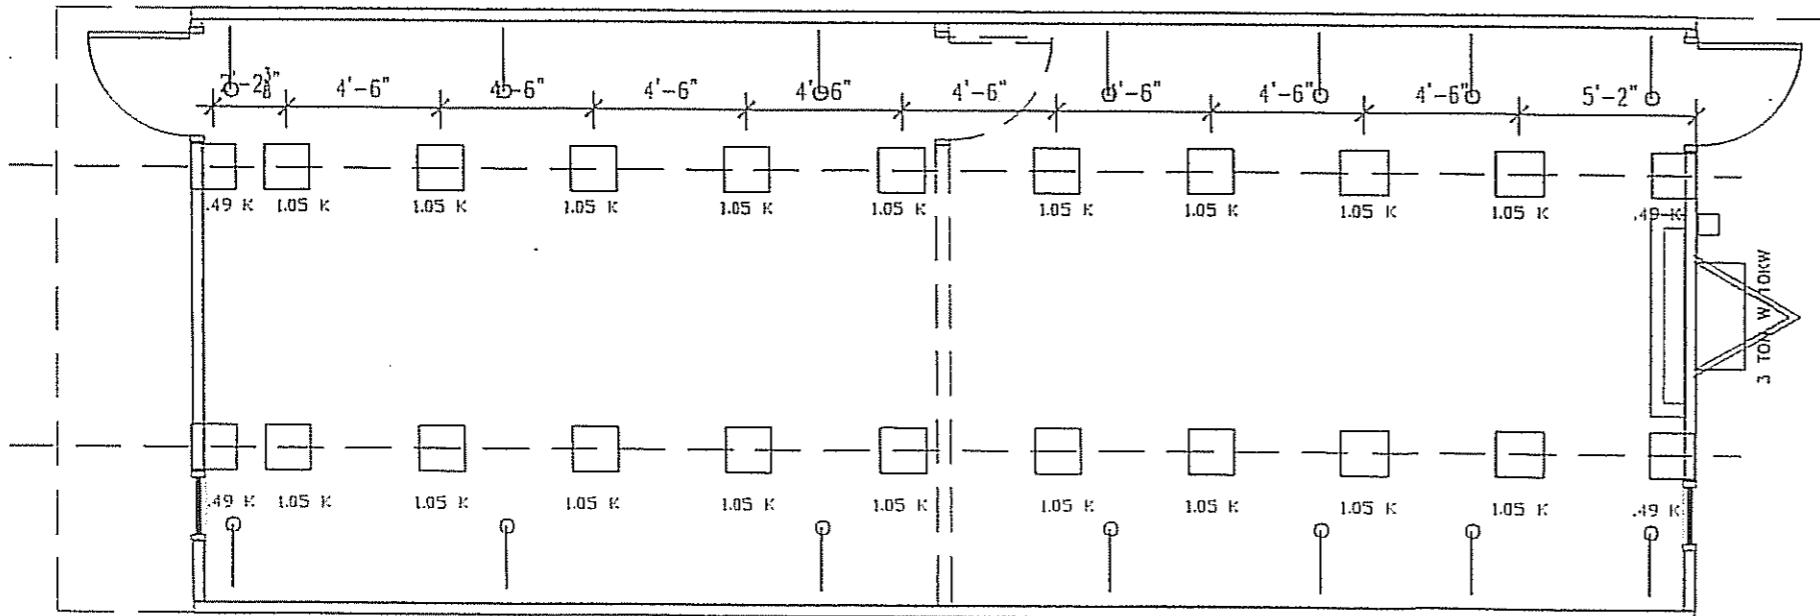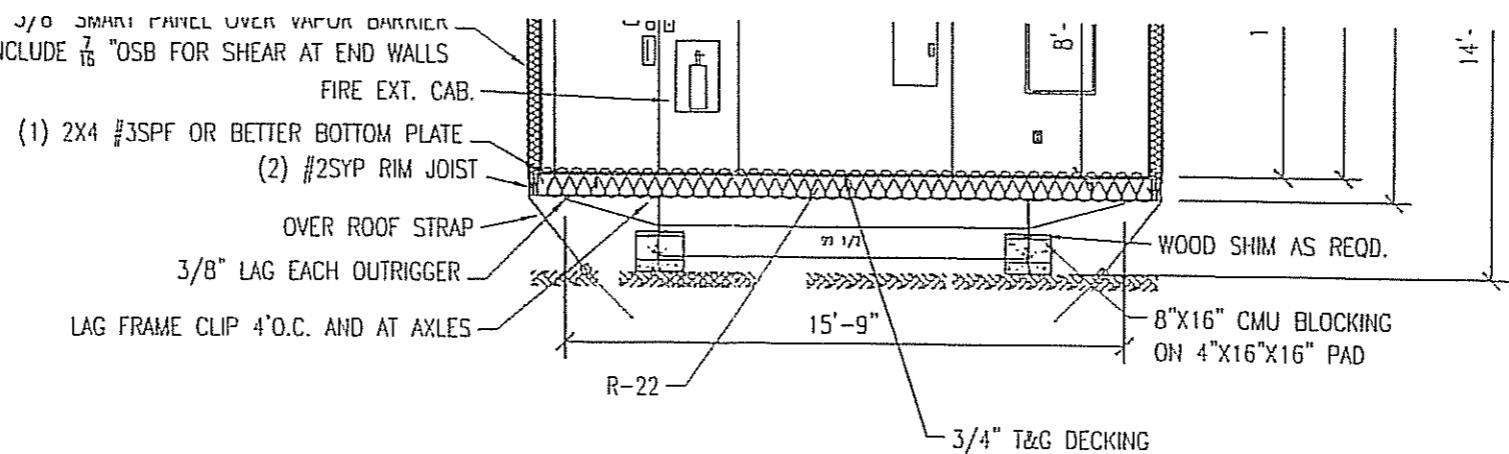
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