

DESIGN CRITERIA:	
PROJECT NAME:	NORTEX STOCK 1844 OFFICE
BUILDING SQUARE FOOTAGE	281 SF
2002 NEC	
2003 IBC	
2003 IMC	
2003 IPC	
2003 IECG	
1994 TAS	
USE GROUP:	B
CONSTRUCTION TYPE:	BC, V-B
OCCUPANT LOAD:	6
PERMISSIBLE GAS TYPE	<input type="checkbox"/> LP <input type="checkbox"/> NATURAL <input checked="" type="checkbox"/> N/A

	DESIGN LOADS:
ROOF LIVE LOAD:	30 PFS
FLOOR LIVE LOAD:	100PFS (SEE BLOCKING S-101)
CONC. FLOOR LIVE LOAD:	2000 LBS
WIND LOAD:	(130 MPH 3-SEC GUST)
EXPOSURE:	B
SEISMIC DESIGN CATEGORY:	C

SPECIAL CONDITIONS AND/OR LIMITATIONS:
1. HANDICAP ACCESS TO BE PROVIDED PER 1994 TAS AS REQUIRED BY OTHERS.
2. BUILDING TO BE LOCATED PER TABLE 602 OF THE 2003 IBC.
3. ANY REQUIRED ALARM SYSTEM WILL BE INSTALLED ON SITE BY OTHERS.
4. ADULT RESTROOMS IN ADA CENT BUILDING
5. ADULT WATER FOUNTAIN SHALL BE FURNISHED BY OTHERS PER PC-2003 TABLE 403.1.

FOUNDATION NOTES:
1. THE DOWN ANCHORING SEE SHEET S-101
2. CRAWL SPACE VENTILATION PROVIDED BY SITE INSTALLER PER 1203.3.1 OF 2003 IBC.

SCOPE OF WORK:
1. UTILITIES AND UTILITY CONNECTIONS
2. POURED CONCRETE (DRIVEWAY, SIDEWALK, SLABS, FOOTINGS, ECT)
3. SITE PREPARATION
4. TAX OF ANY KIND
5. BUILDING PERMITS
SITE WORK
1. NO PROVISION FOR SITE WORK HAS BEEN INCLUDED. IT IS PRESUMED THE SITE WILL PROVIDE CLEAR ACCESS FOR TRUCKS AND MODULARS.
ADEQUATE DRAINAGE TO BE PROVIDED.
2. ALL ELECTRICAL, PLUMBING, SEWER, & GAS SERVICE CONNECTIONS AND ALL CONCRETE WORK ON SITE. TO INCLUDE POURED FOOTINGS, SLABS, FOUNDATIONS, SIDEWALKS, DRIVEWAYS OF WHATEVER KIND ARE THE RESPONSIBILITY OF OTHERS.

IDENTIFICATION
DECALS: TOLR, MANUFACTURERS DATA PLATE, MBI AND NORTEX UNIT PLATE
LOCATION: PLATE WITH DECALS ATTACHED ON FRONT LEFT OF BUILDING
FRAME/CHASSIS:
OUTRIGGERS:
CROSSMEMBERS:
BEAM:
HITCH:
AXLES:
TIRES:
FRAME:

FLOOR:	
BOTTOM BOARD:	ROLL POLYETHYLENE FIBER MESH
INSULATION:	R-22 FACED
JOIST:	2X8 #2SYP OR BETTER AT 16" O.C.
SIDE AND JOIST (RM):	2X8 #2SYP OR BETTER
DECKING:	3/4" T&G OSB, GLEUED & ATTACHED W/ MIN. 2-1/2" SCREW SPACING NAILS
UNDERLAYMENT:	N/A
COVERING:	CARPET TILES
BASE COVE:	4" RUBBER COLOR= GREY

EXTERIOR WALLS:	
SIDEWALL HEIGHT: 10'-1 1/8"	
STUDS: 2X4 #2SYP 16" O.C. OR BETTER	
BOTTOM PLATE: SINGLE 2X4 #3SFP OR BETTER	
TOP PLATES: DOUBLE 2X4 #3 SFP OR BETTER	
HEADERS:	DOUBLE 2X6 #2SYP W/ 7/16" FILLER
JACK STUDS: SINGLE EACH SIDE OF OPENINGS 2X4 #2SYP KING STUDS (2) ON EACH SIDE OF OPENINGS.	
FIRE BLOCKING: 2X4 #3SFP OR BETTER ON EDGE AT THE CEILING LINE	
INSULATION: R-15 FACED	
SHEATHING: 7/16" OSB AT END WALLS	
SIDING: 3/8" SMART PANEL	COLOR: SEE SHEET A-201
TRIM: 1X4 SMART PANEL	COLOR: SEE SHEET A-201
SKIRTING: SHIP LOOSE	9 4X12 SHTS SMART PNL PAINTED TO MATCH BODY. IF ORDERED
IF SKIRTING IS ORDERED, 12"X12" VENTS TO BE SHIPPED WITH WATER	6

INTERIOR WALLS:	
WALL HEIGHT: 10'-1 1/8"	
STUDS: 2X4 STUD GRADE SFP OR BETTER 16" O.C.	
BOTTOM PLATE: SINGLE 2X4 #3 SFP OR BETTER	
TOP PLATES: DOUBLE 2X4 #3 SFP OR BETTER	
FIRE BLOCKS: 2X4 #3SFP OR BETTER ON EDGE AT CEILING LINE	
COVERING: 5/8" FIRE X VOG	COLOR: HAMTOM GRAY
BATHROOM: SAME AS ROOM EXCEPT: FRP 4" HIGH ON MFG. PSUMON 2 ADA ADJCENT WALLS TO WATER CLOSET.	
TRIM: STANDARD VOG BATTENS	
INSULATION: R-15 UNFACED THROUGHOUT.	

WINDOWS:	
SIZE/TYPE: (2) 24'X52" V.S. BRONZE FRAME/CLEAR LOW E GLASS	
BRAND:	HR
COVERING:	MIN. ENERGY VALUES: U-FACTOR = .51 SHGC=.34
MISC:	COLOR: GRAY

DOORS:	
EXTERIOR: HARDWARE	(1) 36"X80" 18GA STEEL W/ 5'X20" PENCIL WINDOW (TEMP)
EXTERIOR: HARDWARE	(1) DEADBOLT (SCHLAGE) B660 BD X 28D W/IC CONSTR. CORE
	(1) 3905BDC X AL NORTON CLOSURER
	(1) HOLLOW METAL FRAME
	(2) ROLL PLATES ROCKWOOD #107 X 70C X US28
	(1) PERMO THRESHOLD 170A-36
	(1) PEAKO SWEEP 3150N-36
	(1) SET PERMO WEA THRESHTRIP 303AV-.3070
	(1) BEST COMPATIBLE - SEVEN FN
INTERIOR:	(1) 36"X80" SC MONA W/IC STEEL RED FRAME NO VISION PANEL.
INTERIOR HARDWARE: LEVER HANDLES IF OPTIONAL DOOR INSTALLED.	

ROOF:	
RAFTER:	2X10 #2SYP 16" O.C.
RIM:	1 3/4" LVL 16" TAB CUT TO 9 1/4"
SHEATHING:	7/16" MULE HIDE FR DECK PANEL C
COVERING:	COLOR= WHITE
BOTTOM RAFTER SHEATHING:	STANDARD .045 MULE-HIDE EPDM ADHERED WITH MULE-HIDE ACRYLIC WATER BASED BONDING ADHESIVE NET TO HOLD INSULATION
ROOF FITCH:	2.5/12 TRANSVERSE
CEILING:	8'-7" HEIGHT: 2X4 LAY IN PANELS
INSULATION:	(2) LAYERS R-15
PLUMBING:	WALL RETURN GRILL TO BE 8" OFF FLOOR TO THE BOTTOM
VENTS:	1" ABOVE INSULATION

ELECTRICAL:	
SERVICE:	120/240V SINGLE PHASE
LOAD CENTER:	(1) 125 AMP INT MOUNT LOAD CNT. W/ #6 BARE GROUND
ENTRANCE:	2" NPLR DOWN METAL
WIRING:	MC CABLE W/ #12 (#6 AT HVAC)
LIGHTS:	(8) 48" T-8 (3) TUBE 32 WATT FLOOR, FIXTURES (92 FIXTURE WATTS)
	(2) PHOTO CELL EXTERIOR 13 WATT @ 860 LUMENS = 66 LUMEN PER WATT
FANS:	90 CFM IN RESTROOM DUCTED TO OUTSIDE
SURGE PROTECT:	N/A
EXT/EMERG. LIGHT:	(1) EXT/EMERGENCY LIGHT BATTERY BACK UP
HOT WATER:	E-MAX INSTANT HOT WATER WITH PRESET LIMIT OF 105 DEGREE
RECEPTS:	(8) STD. 120V DUPLEX RECP
	(1) W/P EXT. GFCI 120V RECEPTACLE
	(1) GFCI AT COUNTER
SWITCHES:	(3) 1-POLE 120V SWITCHES (ROOM LIGHTS TO BE ON
J-BOXES:	ALL PLATES TO BE IVORY
ALARM:	N/A
MISC:	GROUNDING ON SITE TO BE PER NEC 2002, 250-96

PLUMBING:	
WATER SUPPLY:	TYPE "L" COPPER
WASTE:	PVC SCHEDULE 40
WATER HEATER:	(1) E-MAX SFP5 SUPPLY TO BOTH SINKS WITH SET OF 105-110F DEGREE
WATER CLOSET:	(1) HANDCAP FLUSH VALVE & LONGATED LHANDLE
SINK:	HANDICAP COUNTER SINK, COVER UNDERNEATH HANDLES
ACCESSORIES:	36" AND 42" GRAB BARS, TOILET PAPER HOLDER.
NOTE:	ALL FIXTURE MOUNTING PER TAS 1994

HVAC:	
HVAC:	(1) 3 TON WITH 10KV HEAT STRIP W/ 60AMP OUTSIDE DISCONNECT.
EFFICIENCY:	BRAND: BARD
	SEER 10.6, EER 9.2 > MINIMUM SEER 9.7 PER 2003 IECC TABLE 803.2.2(1)
THERMOSTAT:	(1) PROGRAMABLE
DUCTS:	DUCT BOARD MAIN, FLEX TO GRILLS IN UNCOND. SPACE. R-5 MIN. VALUE
SUPPLY REGISTERS:	24X24 W/ ADJUSTABLE DIFFUSERS
RETURN REGISTERS:	AT PLUMBING WALL WITH WALL GRILL
MISC:	FRESH AIR MAKEUP IS PROVIDED BY DAMPER IN HVAC.
DISCONNECT:	EXTERIOR 60AMP WITHIN 6' OF REACH.
BALANCE:	SYSTEM TO BE BALANCED IN THE FELD BY OTHERS.
FURNITURE OR MISC:	
6' OF WALL CABINETS, 6' OF COUNTER TOP (30 AFF), 12" BASE AND 24" BASE 30" TALL MAX.	
5LB ABC FIRE EXTINGUISHER IN CABINET NEAR ENTRANCE.	

TELECOM:	
STUBB J BOXES ABOVE CEILING GRID.	
TELECOM BY OTHERS	

TRANSPORTATION:	
7/16	ROOF DECK
18-12 LVL	ROOF RAFTER
0	UNDERSIDE RAFTER
10'-1 1/8"	TALLEST WALL
0	
3/4"	FLOOR DECK
2X8	FLOOR JOIST
2'-6"	TO ROAD APPROX
TOTAL	
14'-9 1/2" APPROX.	
WEIGHT APPROX.	
18424 LBS	

ENERGY CODE COMPLIANCE	
COMCHECK CERTIFICATES TO BE USED AS CHECKLIST.	
3 TUBE LIGHT FIXTURE IS 92 FIXTURE WATTS	
EXTERIOR LIGHT IS 13 WATT @ 860 LUMENS = 66 LUMEN PER WATT.	
WINDOWS ARE U-.51 AND SHGC=.34 OR BETTER	
DOOR U VALUE IS DEFAULT 7	

DRAWING INDEX:	
G-001	= COVER
A-101	= FLOOR PLAN
A-201	= EXTERIOR ELEVATIONS
A-301	= SECTION
A-601	= ADA
E-101	= ELECTRICAL PLAN
M-101	= MECHANICAL(HVAC) PLAN
P-101	= PLUMBING
SF-101	= FLOOR FRAMING PLAN
SF-102	= FLOOR DECKING/WALL
SF-103	= ROOF FRAMING PLAN
SF-201	= ROOF FRAMING LONG. SECTION
S-101	= BLOCKING PLAN

LTR	REVISION	BY	DATE	DRAWN BY:	PROJECT:	SCALE:	SALES PERSON:	TITLE:	DWG#	SHEET:
				JPW	NORTEX 1844 STK OFFICE	3/16" = 1'-0"		COVER	1844STKOFFICE	G-001




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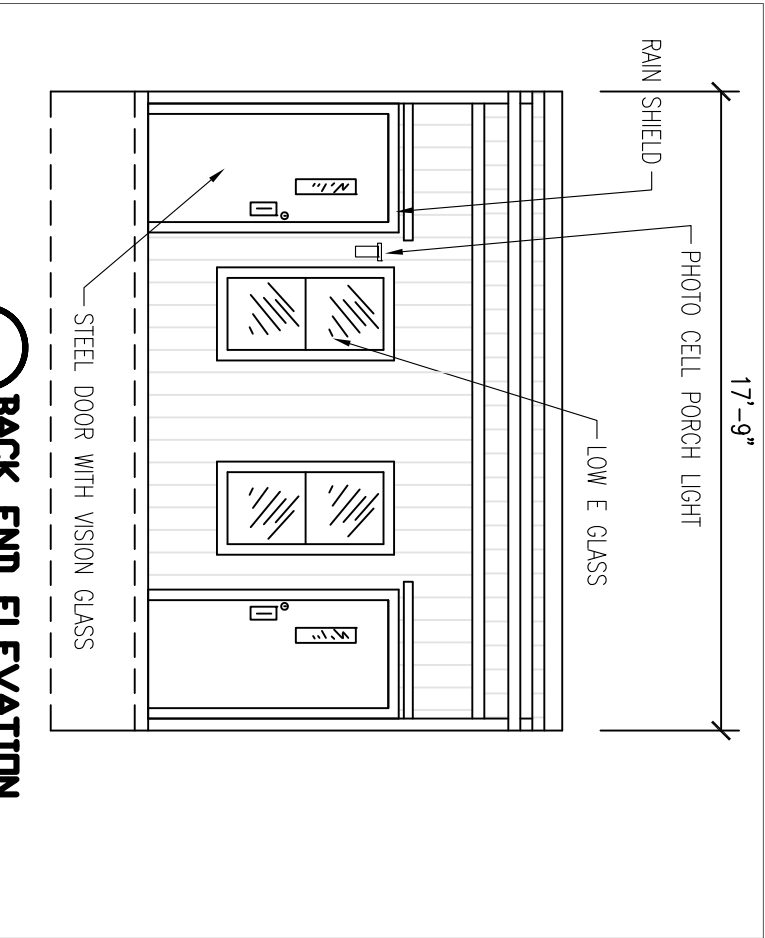
NORTEX MODULAR SPACE

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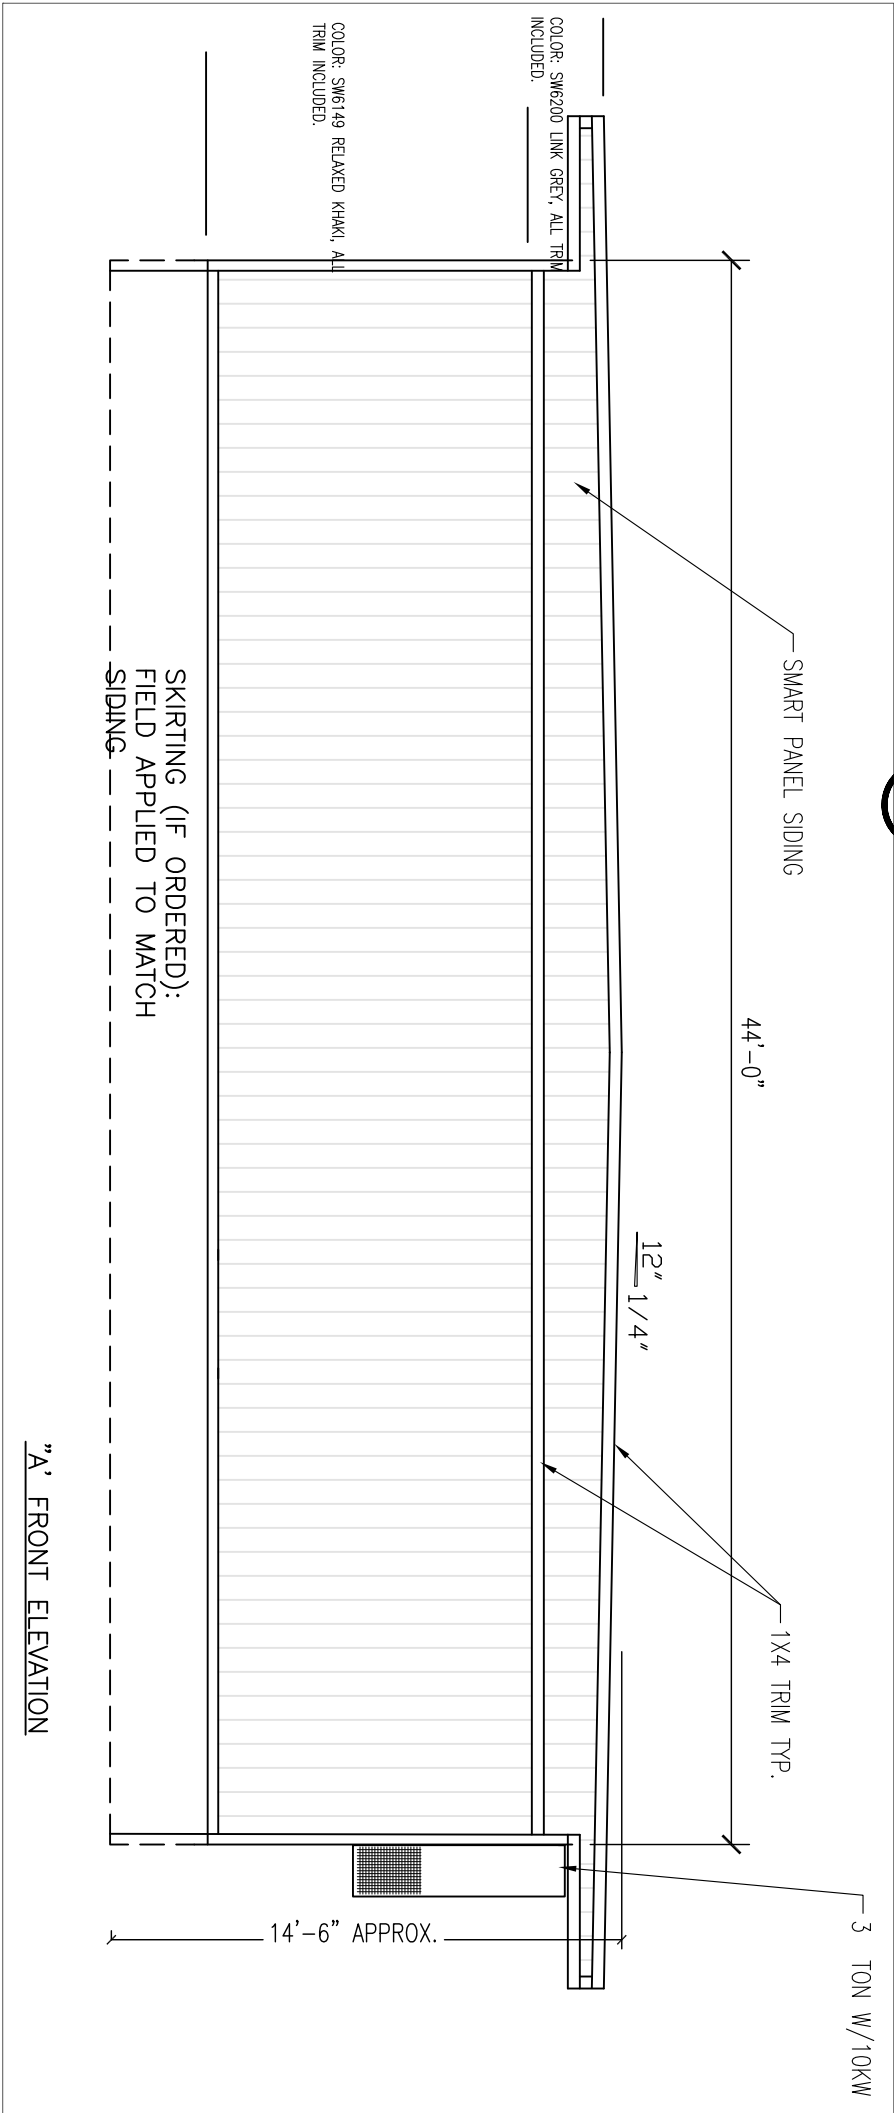
NOTE: ALL MAILING PATTERNS SHOWN ON SF PAGES SHALL
OVERRIDE DESIGN MANUAL.




C BACK ELEVATION
3/16" = 1'-0"

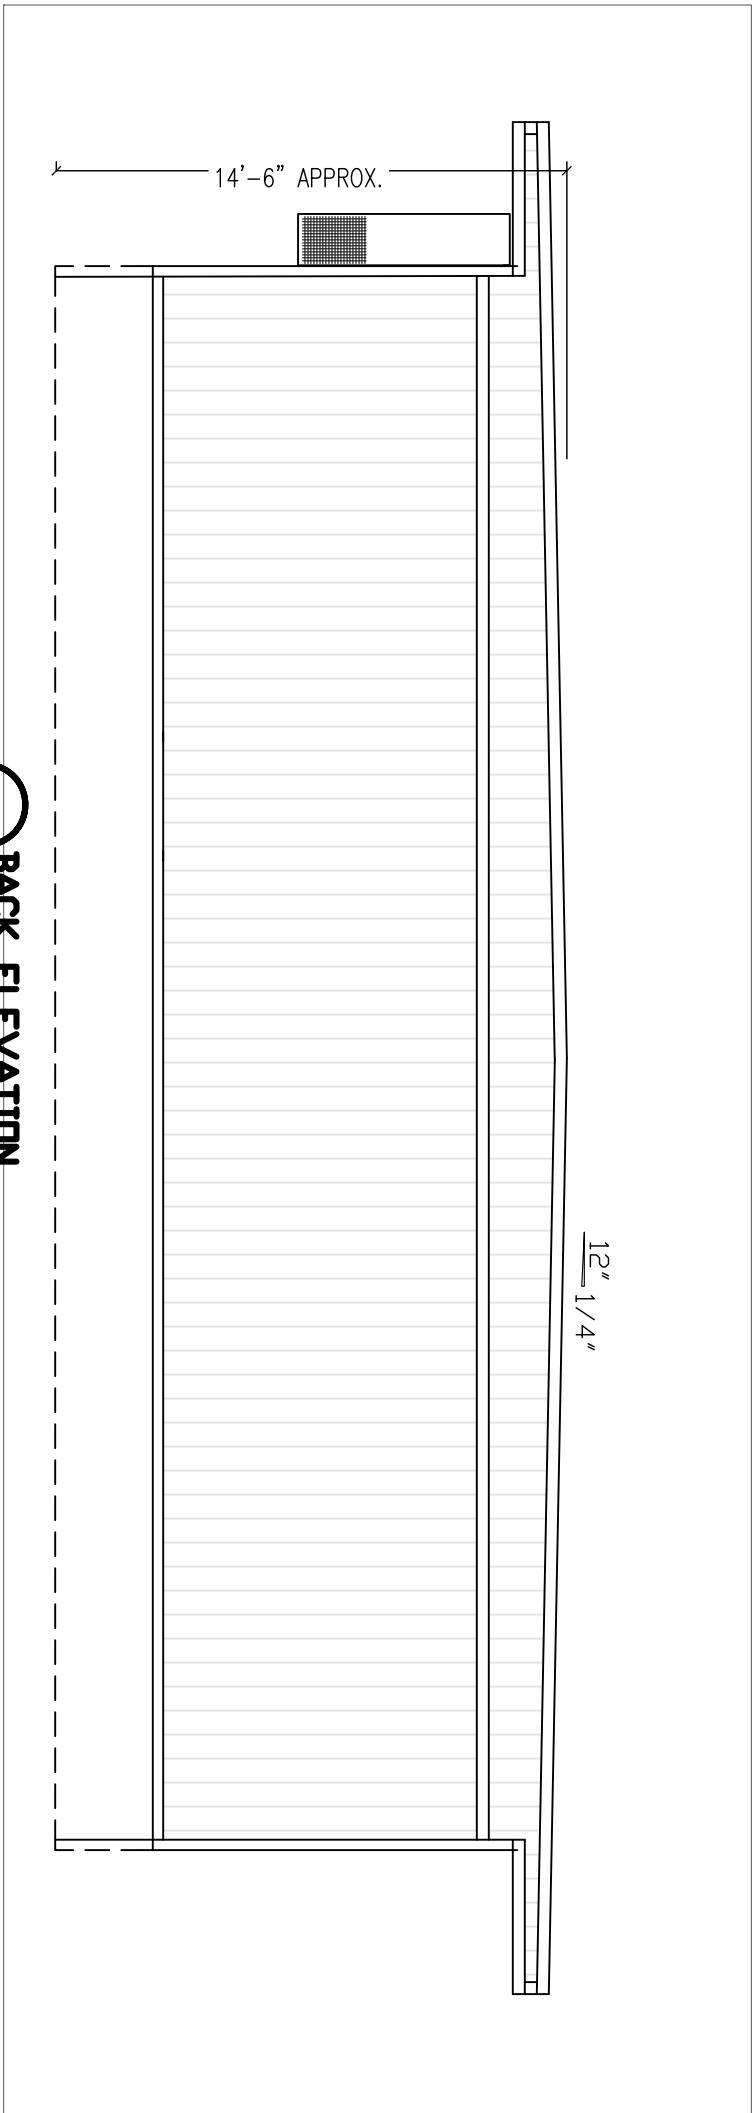

C BACK END ELEVATION
3/16" = 1'-0"



"A" FRONT ELEVATION

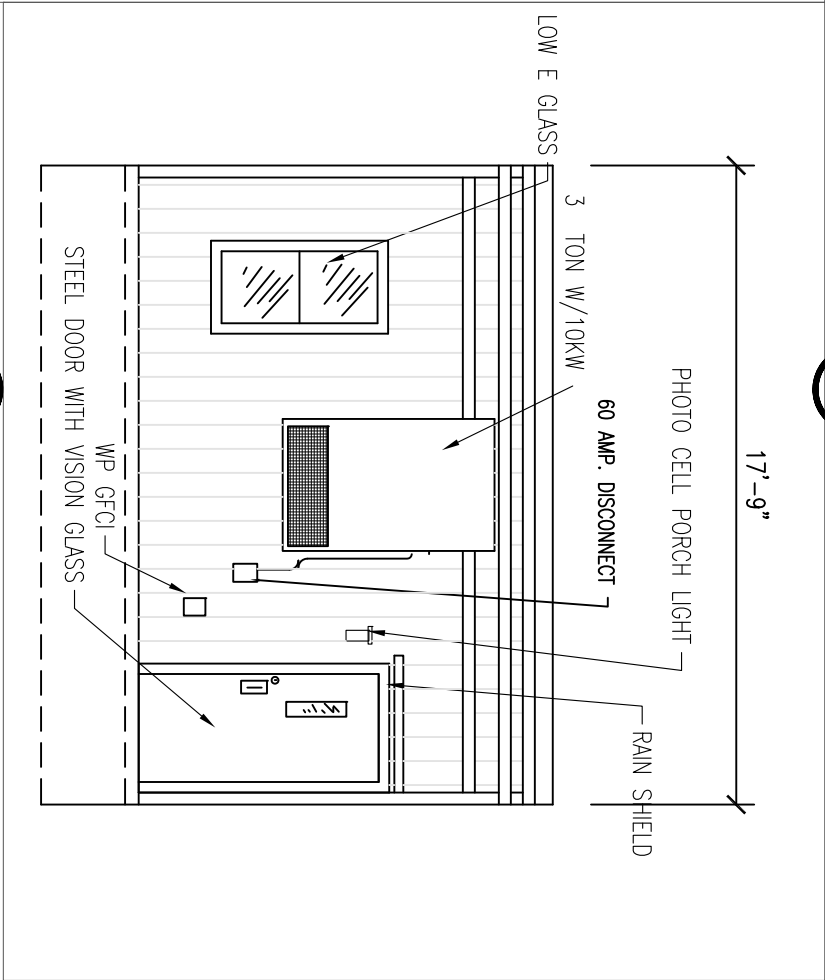

D BACK END ELEVATION
3/16" = 1'-0"


A BACK ELEVATION
3/16" = 1'-0"

LTR	REVISION	BY	DATE	DRAWN BY:	PROJECT:	TITLE:
				JPW	NORTEX 1844 STK OFFICE	ELEVATIONS
				DATE:	SCALE:	SHEET:
				04/17/08	3/16" = 1'-0"	A-201
					SALES PERSON:	



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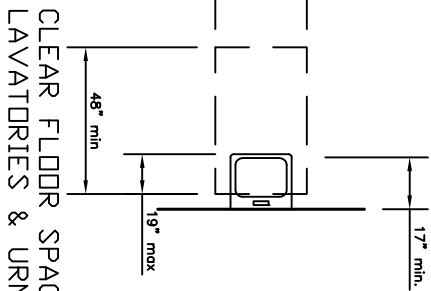
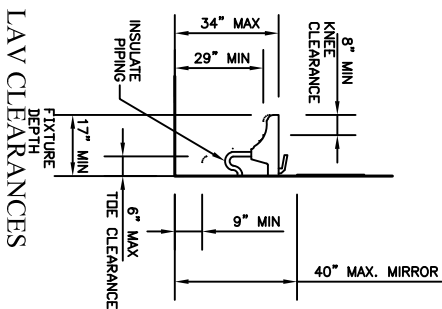
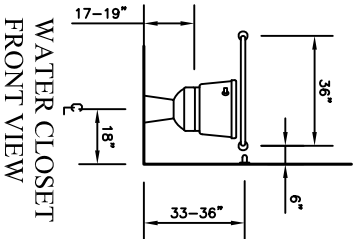
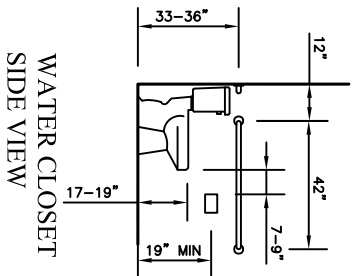
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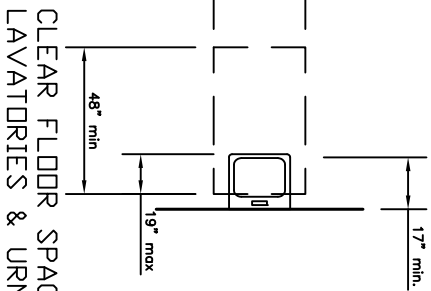
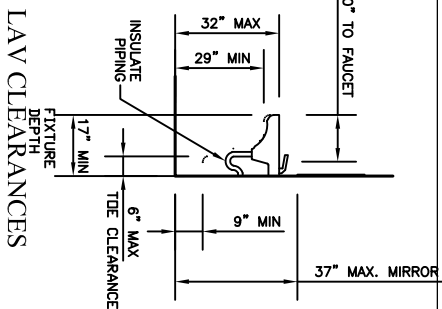
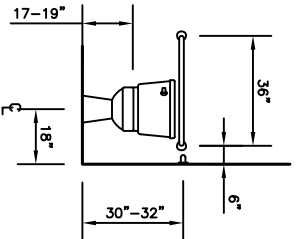
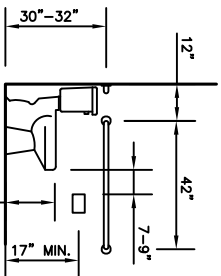
A **CROSS SECTION**
1/4" = 1'-0"

LTR											 NORTEX MODULAR SPACE 555 JUBILEE LANE LEWISVILLE, TX 75056 PHONE: 972-492-4040 FAX: 972-492-2704
	REVISION	BY	DATE	DRAWN BY: JPW	PROJECT: NORTEX 1844 STK OFFICE		TITLE: CROSS-SECTION				
			DATE: 04/17/08		SCALE: 3/16" = 1'-0"	SALES PERSON:					
						DWG# 1844STKOFFICE	SHEET: A-301				




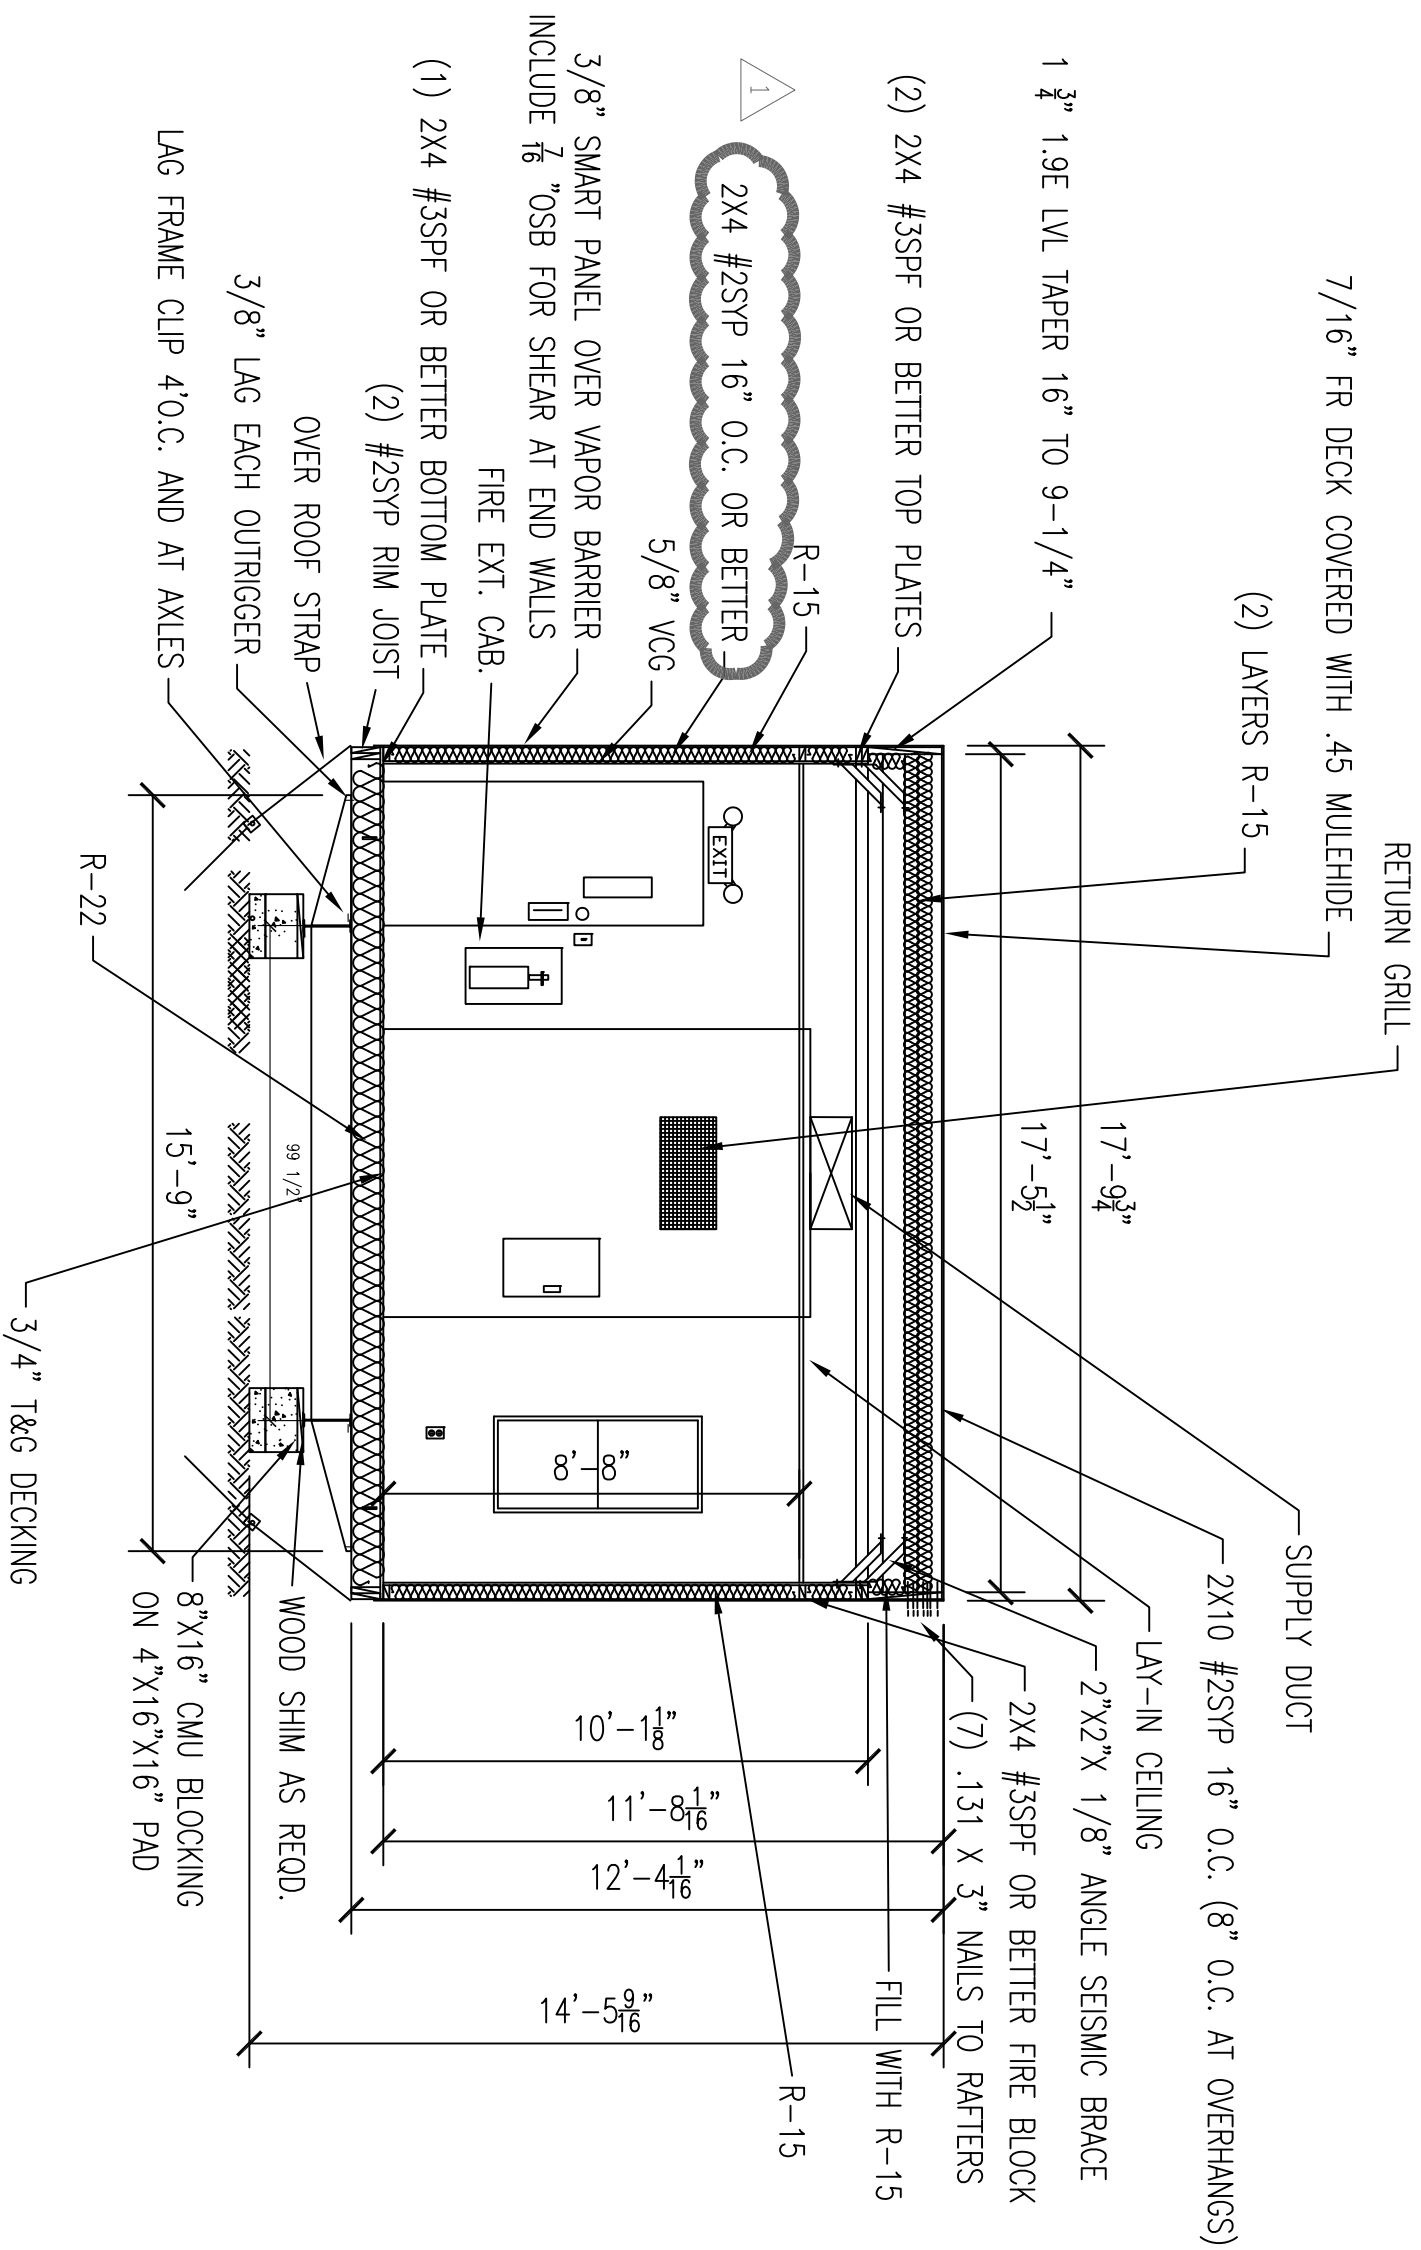
ADULTS OR 16 YEARS
OLD AND ABOVE



CHILDREN 11-15
YEARS OLD



CHILDREN 4-11 YEARS
OLD

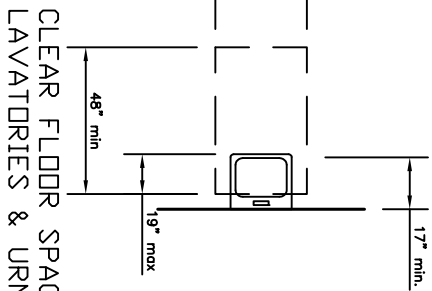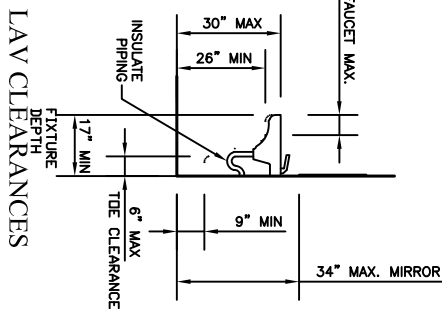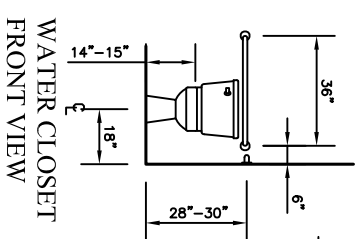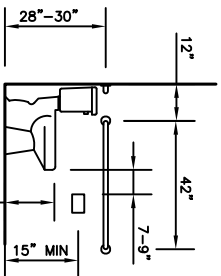

LTR	REVISION	BY	DATE	DRAWN BY:	PROJECT:	TITLE:
				JPW	NORTEX 1844 STK OFFICE	ADA-TAS
				DATE: 04/17/08	SCALE: 3/16" = 1'-0"	SHEET: A-601
					SALES PERSON:	DWG# 1844STKOFFICE




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PANEL MARKUP, WIRE AND BREAKER SIZING.

MIN WIRE SIZE		<div> <div>125 AMP 2-POLE</div> <div>120V/240V</div> <div>MAIN BREAKER</div> <div>SINGLE PHASE</div> </div>										MIN WIRE SIZE	
6	HVAC	BREAKER	LEG	OKT	OKT	LEG	BREAKER						
		60	A	1	2	A	20	LIGHTS					12
		2P	B	3	4	B	20	RECEPTS, PORCH, EMEG.					12
		20	A	5	6	A	60						
12	RECEPTS	20	A	5	6	A	60	E-MAX					10
12	W/P RECEPT	20	B	7	8	B	2P						

AMPS EA.	ITEM	WATTS EA
1.5	RECEPTS	180
0.77	LIGHTS 2X4'3-TUBE T-8	92
0.8	90 CFM EXHAUST FAN	96
0.31	LIGHT 2X2' U-TUBE T-8	38
0.03333333	EMERGENCY/EXT	4
0.10833333	PORCH LIGHT	13
22.9	EeMAX	2633.5
59	HVAC	7080



ELECTRICAL PLAN

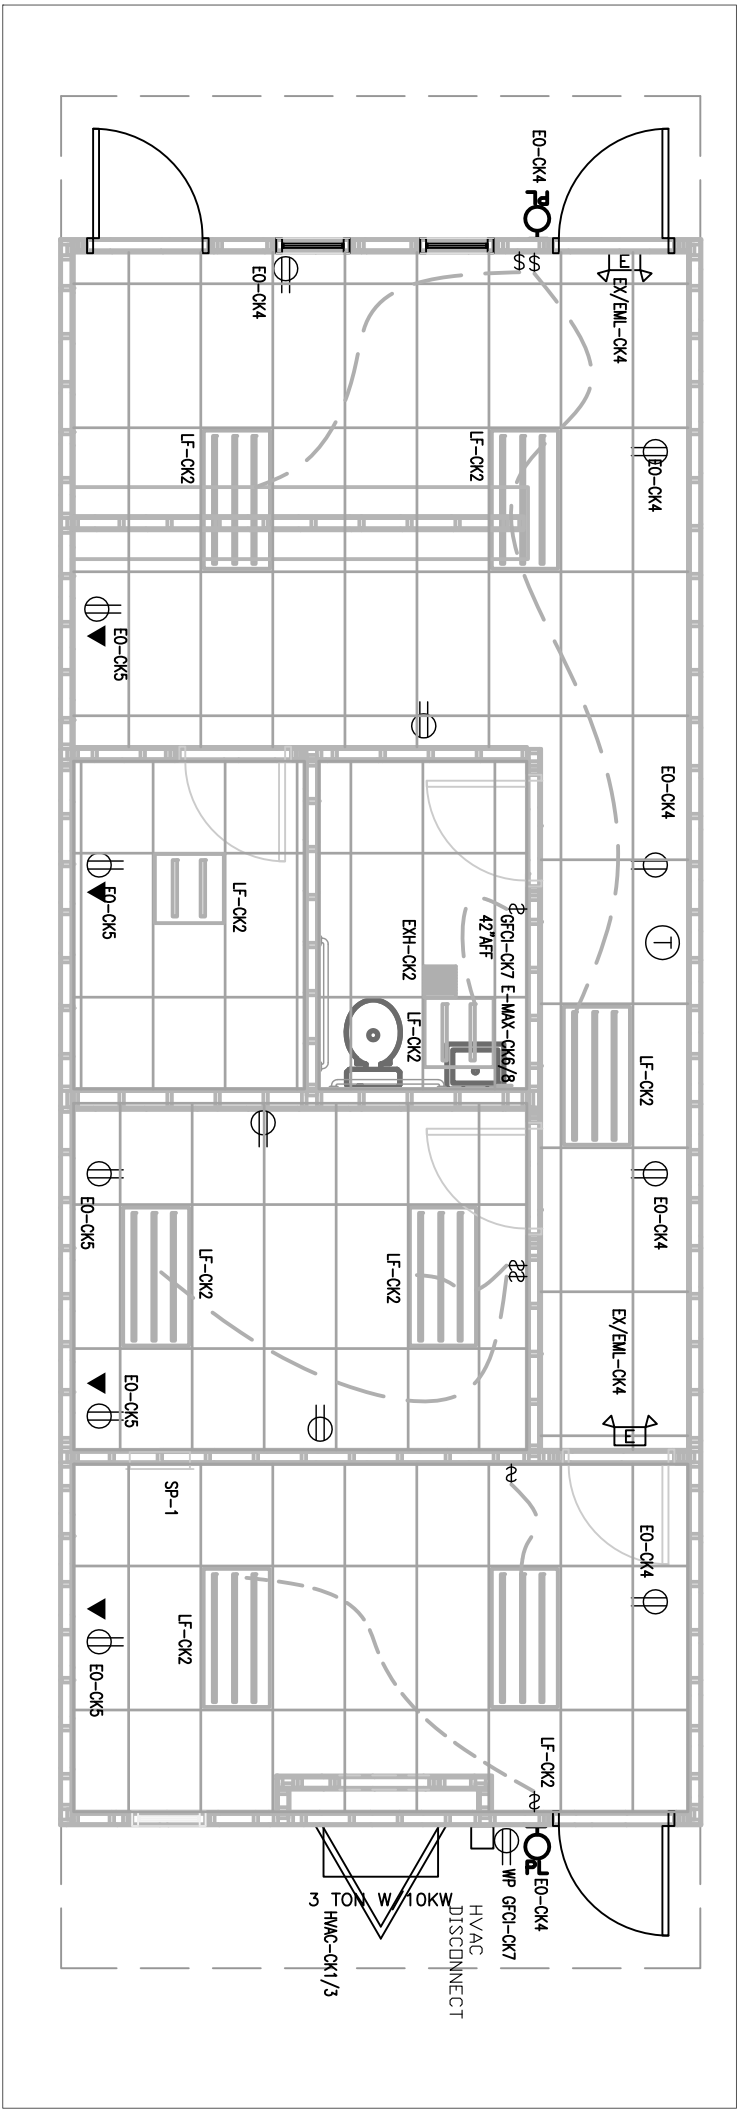LTR		BY	DATE	DRAWN BY:	PROJECT:
	REVISION			JPW	NORTEK 1844 STK OFFICE
				DATE:	SCALE:
				04/17/08	3/16" = 1'-0"
					SALES PERSON:

SS SURGE PROTECTOR

⌘ CAN LIGHT LIGHT

2'X4' TRUSSER LIGHT T-8
ELEC. BALLAST, 3-BULB

EMERGENCY EXIT LIGHT

⌘ PORCH LIGHT

\$ SINGLE POLE LIGHT SWITCH

\$as OCCUPANCY SENSOR SWITCH

\$d DIMMER SWITCH

\$ 3WAY SWITCH

⊖ DUPLEX OUTLET

⊖ SURGE BLOCK OUTLET
SBD

⊖ WEATHER PROOF DUPLEX GROUND
WP FAULT INTERRUPT OUTLET
GFCI

⊖ CEILING OUTLET
CD

▲ DATA DROP

▼ VOICE DROP

LF-CK2

EO-CK4

WP GFCI-CK7

HVAC DISCONNECT

HMC-CK1/3

EO-CK5

TITLE: ELECTRICAL

DWG# 1844STKOFFICE

SH

PANEL SP-1 125 AMP 2-POLE 120V/240V SINGLE LOAD					
PHASE MAIN BREAKER CALCULATIONS					
LEG	DESCRIPTION	LEG A-AMPS	LEG B-AMPS	LEG A-WATTS	LEG B-WATTS
CTK					
A	1 HVAC	59.00		7,080.00	
A	2 LIGHTS	6.16	-	739.20	-
B	3 HVAC		59.00		7,080.00
B	4 RECEPTS,PORCH,EMG	-	7.85	-	941.52
A	5 RECEPTS	8.30		996.00	
A	6 E-MAX	22.90	-	2,748.00	-
B	7 GFCI		3.00	-	360.00
B	8 E-MAX		22.90		2,748.00
A	9	-		-	
A	10	-	-	-	-
B	11	-	-	-	-
B	12		-		-
		96.36	92.75	11,563.20	11,129.52
	AMPS	96.36	TOTALS	22,692.72	WATTS
	W /20%	115.63		27,231.26	W/ 20%
	125AMP	OK	DIFF B-A	433.68	WATTS
			+/- 20%	1.59%	OK

NOTES:
1. MOUNT ALL OUTLET BOXES TO 16" AFF TO TOP OF BOX.
2. 3-TUBE LIGHT FIXTURE IS FIGURED AS 92 FIXTURE WATTS AND THE (DU) TUBE FIXTURE AS 38 WATTS.

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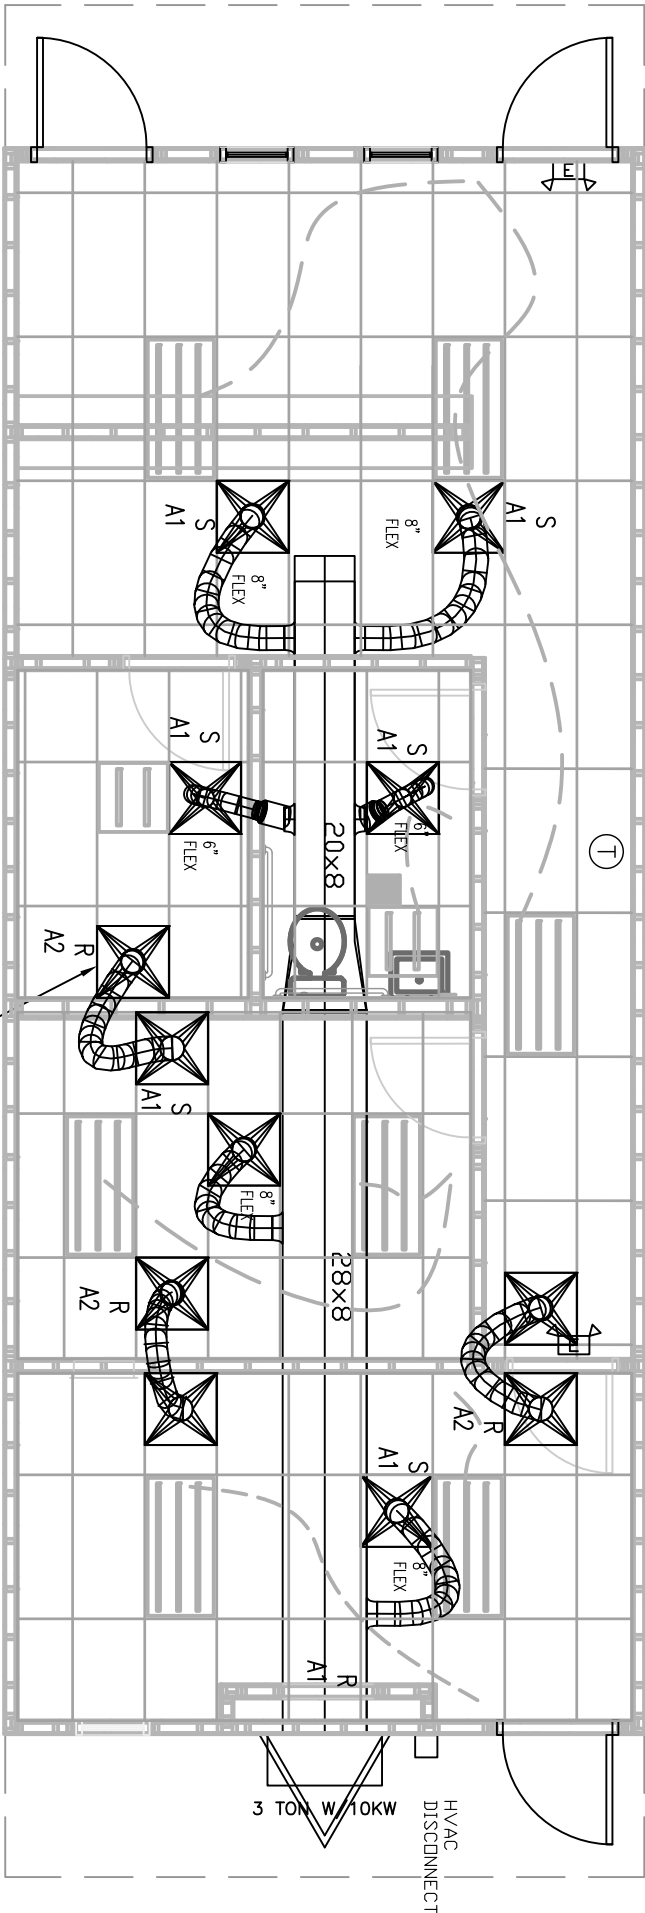
NORTEX MODULAR SPACE



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MECHANICAL SCHEDULE		
DESIGNATION	DESCRIPTION	COMMENTS
SA1	2X2 SUPPLY AIR REGISTER	ADJUSTABLE
RA1	RETURN GRILL AT PLENUM WALL	NONE
RA2	OPTIONAL RETURN JUMP 2'X2' WITH 12' FLEX	
T	THERMOSTAT	PROGRAMMABLE
3 TON W/10KW	BARD MODEL	

OCCUPANTS	6
CFM REQ'D EACH	15 CFM
TOTAL OUTSIDE REQ'D	90 CFM



MECHANICAL PLAN
3/16" = 1'-0"

LTR	REVISION	BY	DATE	DRAWN BY: JPW	PROJECT: NORTEX 1844 STK OFFICE	TITLE: MECHANICAL	SHEET: M-101
				DATE: 04/17/08	SCALE: 3/16" = 1'-0"	SALES PERSON:	DWG# 1844STKOFFICE




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2X8 #2SYP DOUBLE RIM

< 16" O.C.



2X8 #2SYP 16" O.C.

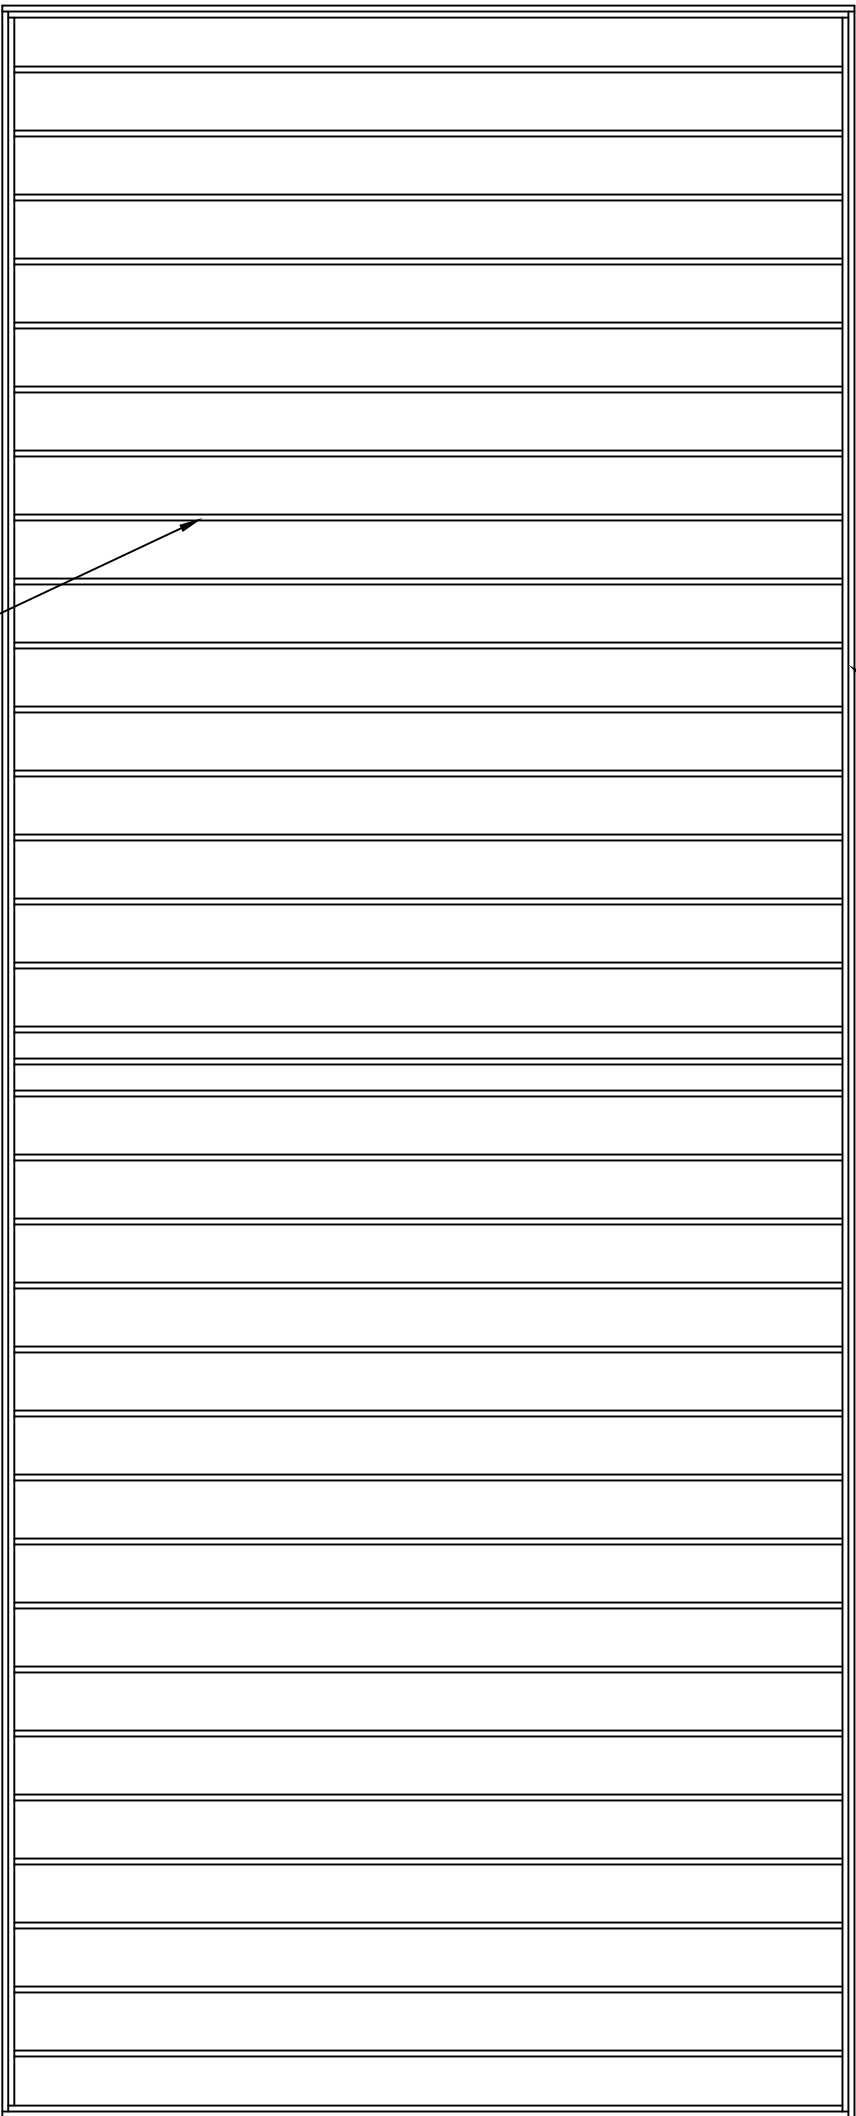JOIST TO RIM: (5) .131X3" NAILS
OUTSIDE RIM TO ACT AS SPLICE BLOCK FOR
INSIDE RIM JOINTS. FOLLOW NAIL PATTERN IN
MANUAL (5) EACH SIDE OF JOINT.

FLOOR JOIST PLAN
1/4" = 1'-0"

LTR	REVISION	BY	DATE	DRAWN BY:	PROJECT:	TITLE:	SHEET:
				JPW	NORTEX 1844 STK OFFICE	FLOOR JOIST PLAN	
				DATE: 04/17/08	SCALE: 3/16" = 1'-0"	DWG# 1844STKOFFICE	SF-101
					SALES PERSON:		




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SHEARWALL SCHEDULE					
MARK	MATERIAL	FASTEN STUDS TO SIDING	FASTEN BOTTOM PLATE TO DECK	FASTEN TOP PLATE TO RAFTERS	FASTEN END TO SIDEWALLS
SW1	3/8" SMARTPANEL ONSIDE 5/8" VCG OTHER SIDE	NAIL WITH .090 X 2 3/8" FOR 3/8" SMART PANEL AND 7/8" OSB AT 6"DC EDGE/12" DC FIELD. ADHESIVE VCG ON INTERIOR	.131 X 3" NAILS 16" D.C.	.131 X 3" NAILS 16" D.C.	.131 X 3" NAILS 16" D.C.
SW2	3/8" SMARTPANEL ONE SIDE OYER 7/8" OSB, 5/8" VCG OTHER SIDE	NAIL WITH .090 X 2 3/8" FOR 3/8" SMART PANEL 6"12" AND 7/8" OSB WITH .131 X 3" AT 4"DC EDGE/8" DC FIELD. ADHESIVE VCG ON INTERIOR	.131 X 3" NAILS 16" D.C.	.131 X 3" NAILS 16" D.C.	.131 X 3" NAILS 16" D.C.

TOP AND BOTTOM EDGE OF SIDING SHALL BE NAILED WITH .090 X 2 3/8" NAILS 2 1/2" D.C. TO THE RIM JOIST/LVL .



FLOOR DECK/ WALL LAYOUT PLAN

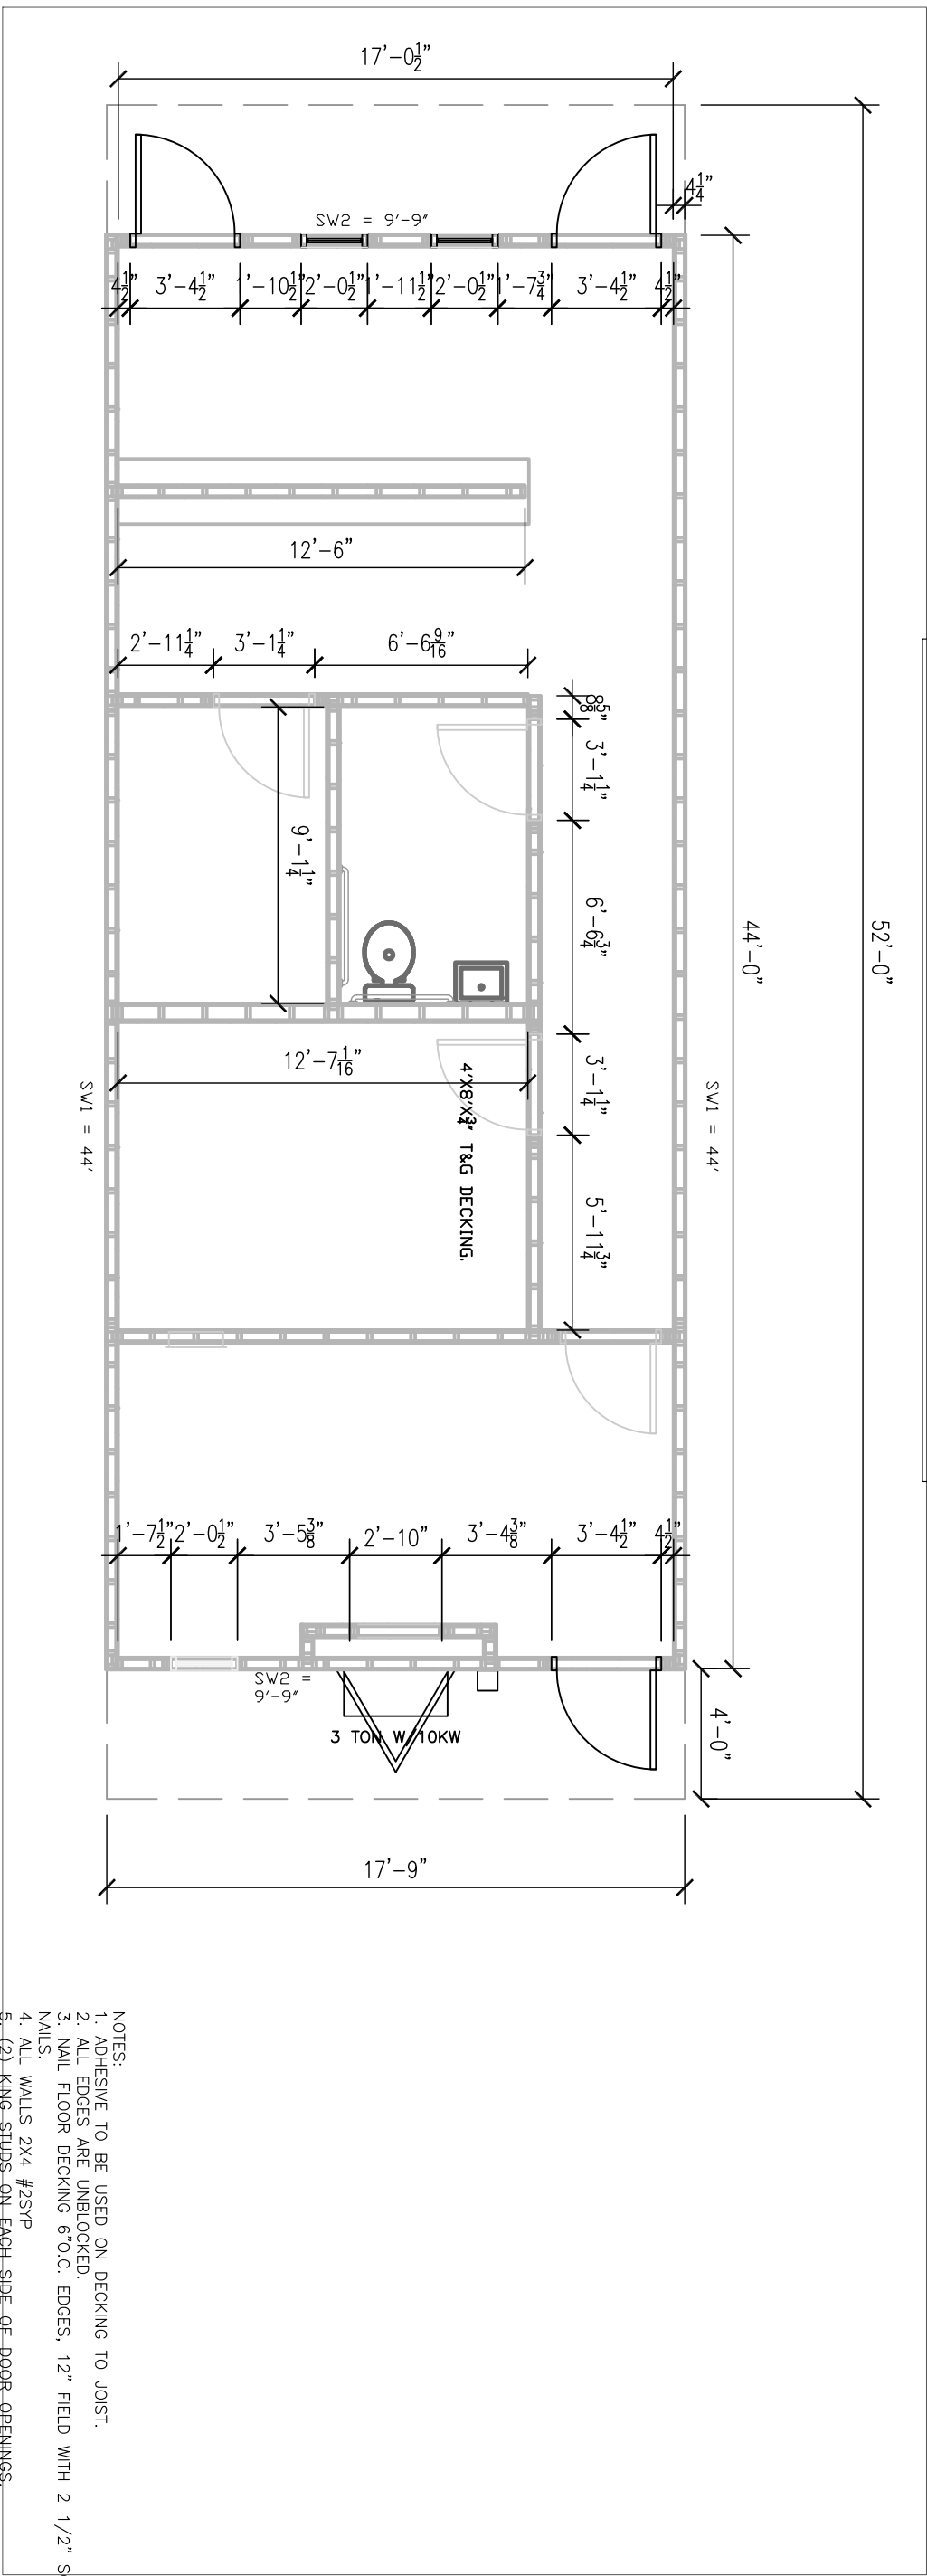3/16" = 1'-0"


LTR	REVISION	BY	DATE	DRAWN BY:	PROJECT:	TITLE:	SHEET:
2	STUD SPACING AT 16" D.C.	REW	02/19/08	JPW	NORTEX 1844 STK OFFICE	FLOOR DECK PLAN	SF-102
				DATE: 04/17/08	SCALE: 3/16" = 1'-0"	SALES PERSON:	
						DWG# 1844STKOFFICE	



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
NORTEX MODULAR SPACE

555 JUBILEE LANE
LEWISVILLE, TX 75056
PHONE: 972-492-4040
FAX: 972-492-2704

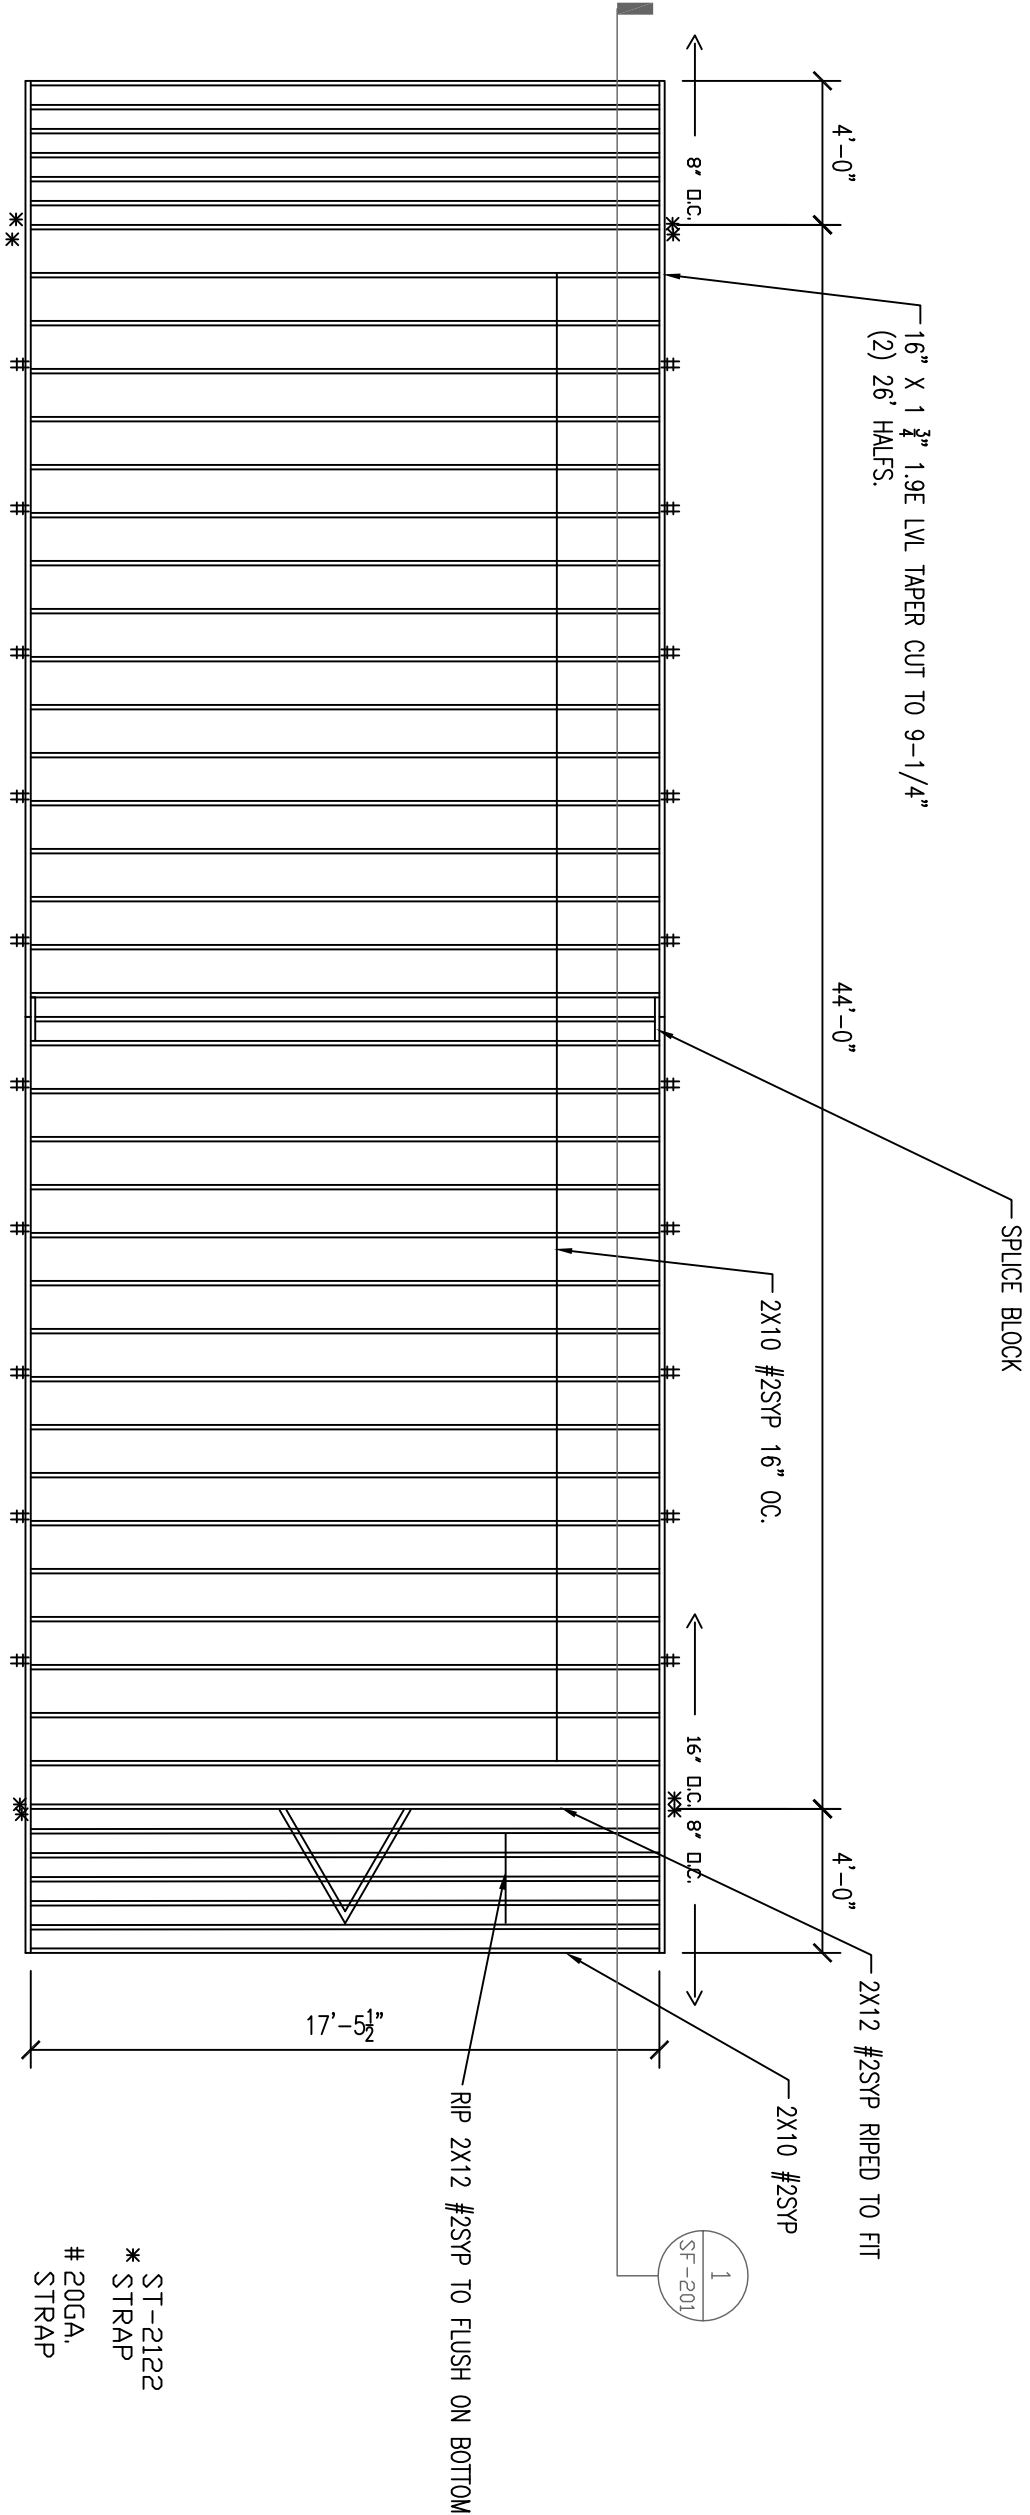


ROOF JOIST LAYOUT
3/16" = 1'-0"

- NOTES:
1. FILL CAVITY WITH 2-LAYERS R-15.
 2. BOTTOM OF JOIST TO BE NET COVERED.
 3. ROOF DECK TO BE FR $\frac{7}{8}$ " DECK PANEL.
 4. ROOF DECK NAILING TO BE 4"OC EDGE & 8"OC IN FIELD WITH MIN. #10-24" SCREWS OR 2 $\frac{1}{2}$ " SCREW SHANK NAILS.
 6. NAIL JOIST TO LVL RIMS (7) .131 X 3"
 7. SPLICE BLOCKS (15) .131 X 3" EA. SIDE.
 8. TOE NAIL LVL RIM TO TOP WALL PLATES WITH .131 X 3" AT 16" O.C. OUTER SIDE ONLY.
- STRAP WITH ST-2122 AS SHOWN. USE 20 GAUGE STRAPS AT APPROX. 4' O.C. ALONG WALL TO STUDS WITH (4) 1" STAPLES EACH SIDE.

LTR	REVISION	BY	DATE	DRAWN BY: JPW	PROJECT: NORTEx 1844 STK OFFICE	TITLE: ROOF JOIST PLAN	SHEET: SF-103		NORTEx MODULAR SPACE 555 JUBILEE LANE LEWISVILLE, TX 75056 PHONE: 972-492-4040 FAX: 972-492-2704
				DATE: 04/17/08	SCALE: 3/16" = 1'-0"	SALES PERSON:	DWG# 1844STKOFFICE		

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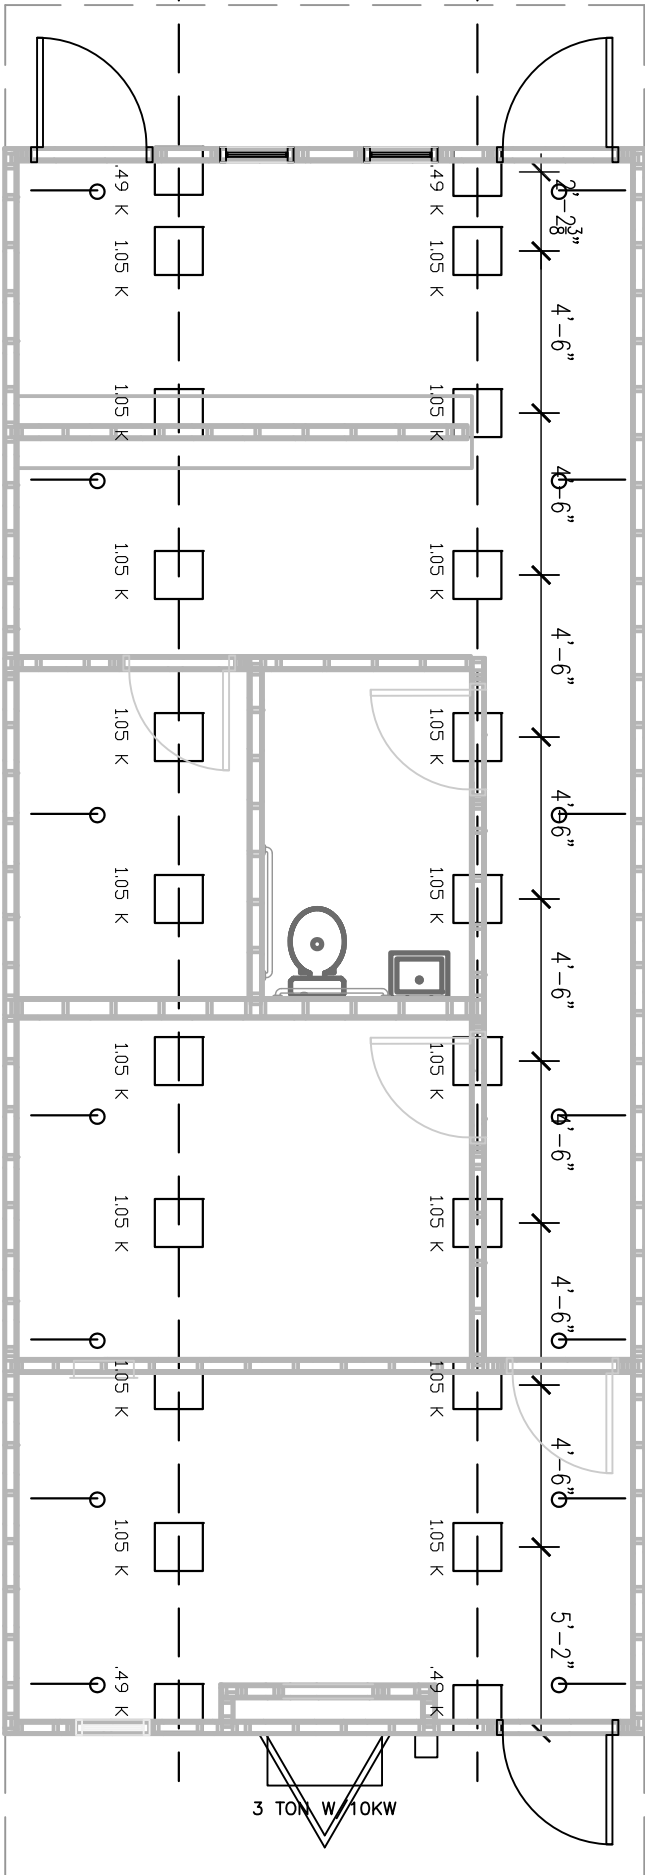
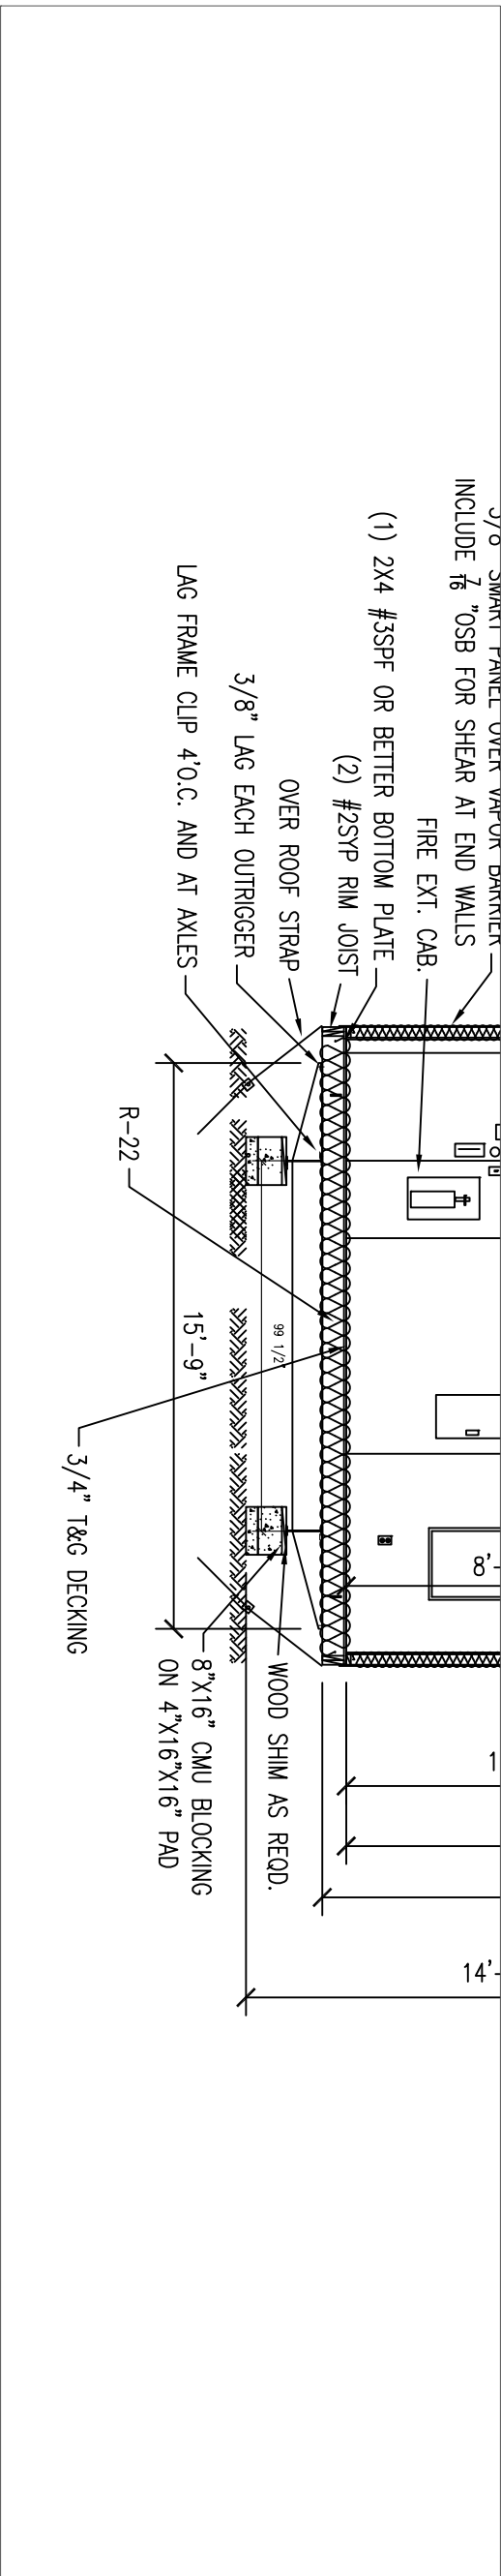
ALL LUMBER TO BE #2SYP

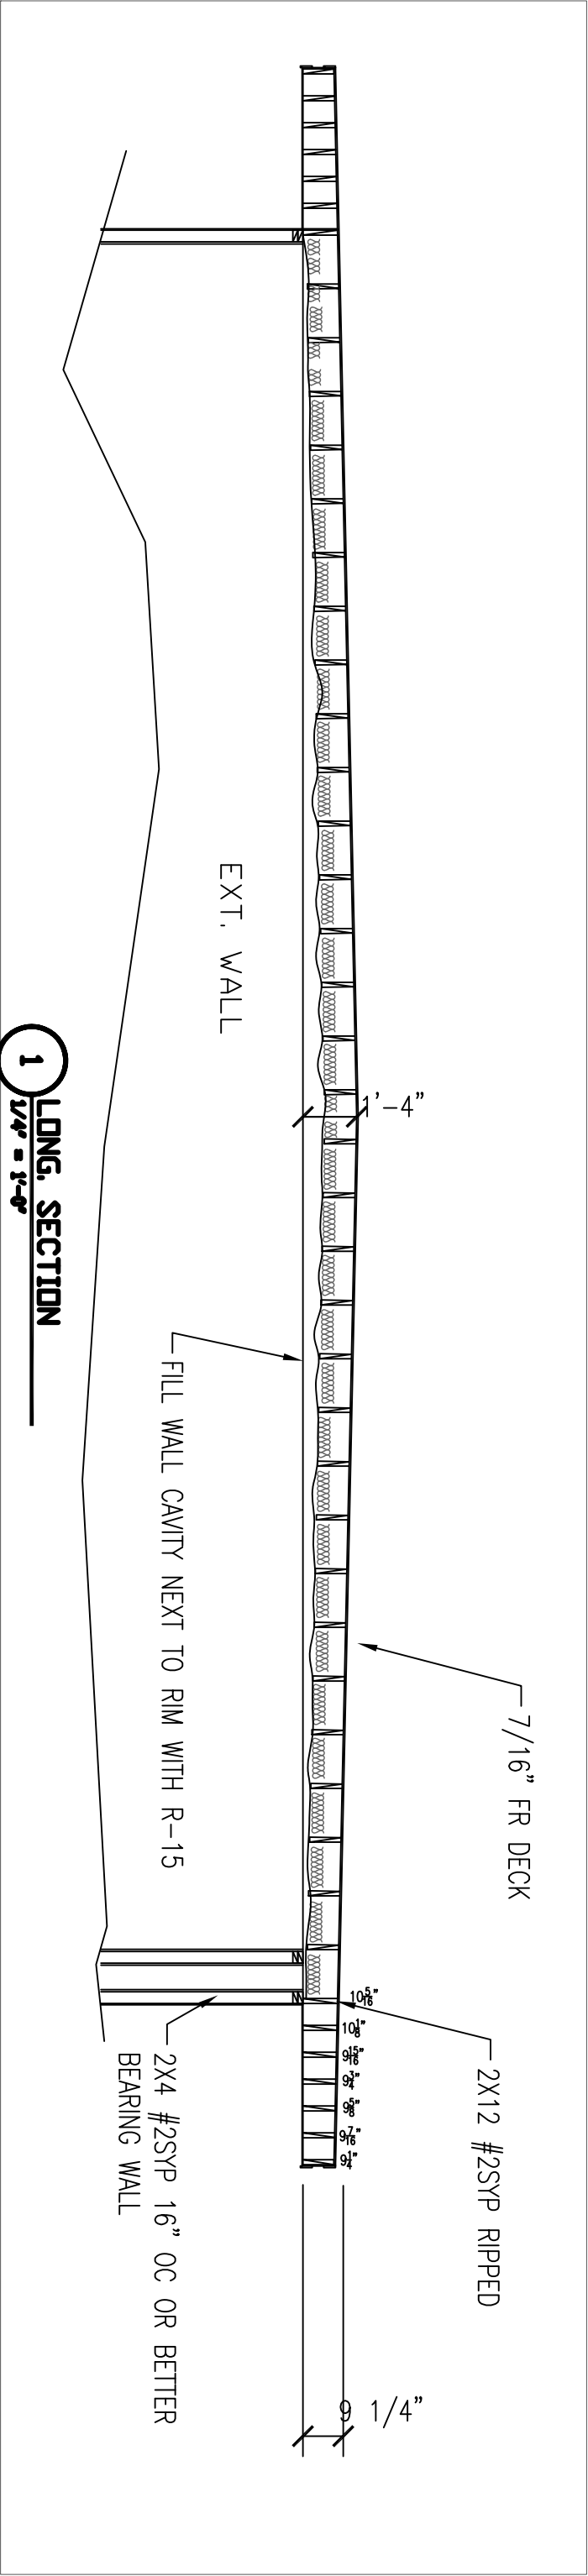LTR	REVISION	BY	DATE	DRAWN BY:	PROJECT:	TITLE:	SHEET:
1	16" DC STUD SPACING	REVI	02/19/08	JPW	NORTECH 1844 STK OFFICE	LONG SECTION	SF-201
				DATE: 04/17/08	SCALE: 3/16" = 1'-0"	SALES PERSON:	
						DWG# 1844STKOFFICE	



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NORTECH MODULAR SPACE
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FAX: 972-492-2704



- NOTES:
1. SOIL ASSUMED AT 2500PSI
2. PAD SPACING SHOWN IS FOR 50PSF FLOOR LOADS. 100PSF=3' D.C.
3. ANY ADDITIONAL TIE STRAPS REQUIRED BY LOCAL AUTHORITIES WILL BE FRAME TIE STRAPS.
4. STRAPS ARE (7) PER SIDE STARTING APPROX 2' FROM EACH END, THEN EQUALLY SPACED AND MAY BE +/- 1'-0"

BLOCKING PLAN
3/16" = 1'-0"

LTR	REVISION	BY	DATE	DRAWN BY:	PROJECT:	TITLE:
				JPW	NORTEX 1844 STK OFFICE	FOUNDATION PLAN
				DATE: 04/17/08	SCALE: 3/16" = 1'-0"	SHEET: S-101
					SALES PERSON:	



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