

NORTEX MODULAR
NORPLEX "VO" SERIES
14 X 64 (60)
PROJECT -NTX - VO

THE FOLLOWING UNITS ARE TO BE CONSTRUCTED INDIVIDUALLY BY THE FACTORY:

NOA- (RIGHT SIDE UNIT)
NOO - (CENTER SECTION UNIT)
NOR - (REST ROOM UNIT)

NORPLEX UNITS ARE DESIGNED TO BE MANUFACTURED INDIVIDUALLY. MODULES ARE DESIGNED TO ALLOW SEVERAL DIFFERENT COMPLEX CONFIGURATIONS IN THE FIELD WITH A MINIMUM OF TWO (2) OUTSIDE UNITS. CONFIGURATIONS OF ANY COMPLEX SHALL NOT EXCEED SQUARE FOOTAGE LIMITATIONS SET FORTH IN "TABLE 503" (use group B, type VB) OF THE 2006 Ed. I.B.C. EGRESS REQUIRMENTS MUST BE MET IN ALL CONFIGURATIONS IN ACCORDANCE WITH CHAPTER 10 OF THE 2006 Ed. OF THE I.B.C. THE MINIMUM REQUIRED PLUMBING FIXTURES MUST BE OBTAINABLE IN ALL CONFIGURATIONS ACCORDING TO THE 2006 Ed. IPC.

General Construction Specifications

FRAME CONSTRUCTION:

QUANTITY AND SIZE: (3) 14 60
TYPE: Outtrigger and crossmember at 48" O.C.
Main beams to be 99 1/2" O.C.
12" Jr. I-beam
BEAM SIZE: Quad 6000# rated with (2) brake (2) tag
AXLES: Detachable underslung
HITCH: 8x14.5 14 ply rated
TIRES:

FLOOR CONSTRUCTION:

FLOOR JOIST: 2X6 #2 SYP equal or better
FRAMING TYPE: Transverse
JOIST SPACING: 16" O.C.
FLOOR DECKING: Single layer 3/4" Sturd-I-floor.
Hold back decking (1 1/2") inches at each side of the mate line.
R-21 fiberglass batt
INSULATION: Mobilflex or equal
BOTTOM BOARD: 1/8" commercial grade tile.
FLOOR COVERINGS: Tile to be CHECKERBOARD AND 50% OFFSET.
Hold back tile (4 1/2") inches at each side of mate line. Tile color to be(White #51899)

26 oz. (or equal) carpet in Offices Only.
Carpet color to be: (#30551 SLIPPERY ROCK)

EXT. WALL CONSTRUCTION:

FRAMING: 2X4 #2 SYP or better at 16" O.C.
Double 2X4 #2 SYP or better top plate
Single 2X4 #2 SYP or better bottom
INSULATION: R-15 Kraft back fiberglass batt
SIDINGS: 3/8" LP Smart Panel over a single layer of Tyvek or equal house wrap.
Body color to be: (Relaxed Khaki SW-6149)
Trim color to be: (Relaxed Khaki SW-6149)
False Mansard color to be: (Link Grey Sw-6200)
WALL COVERINGS: 1/2" vinyl covered gypsum with wrapped battens.
Color to be: (Hampton Gray)
Covering Length 204 FT
Covering Height 9 FT

INT. WALL CONSTRUCTION:

FRAMING: 2X4 #2 SYP or better at 16" o.c.
Double 2X4 #2 SYP or better top plate
Single 2x4 #2 SYP or better bottom plate
OVERALL LENGTH: 244 FT
OVERALL HEIGHT: 8 FT
WALL COVERINGS: 1/2" vinyl covered gypsum with wrapped battens.
Color to be: (Hampton Gray)
and 7/16" OSB (SEE FLOOR PLAN)
Covering Length 488 FT
Covering Height 9 FT

Standard (White) FRP panels over 1/2" MR gypsum
Covering Length 68 FT
Covering Height 4 FT

BASE TRIM: 4" vinyl cove Color to be: (#663 Sky Gray)
INT. TRIM: 4993-1695 (Gray)
SUPPORT POSTS: (3)

ROOF CONSTRUCTION:

DESIGN LOAD: 20 psf live load
RAFTER: Flat solid rafter
RAFTER SIZE: 2X8 #2 SYP equal or better
SPACING: 24" O.C.
(12" O.C. the first 6'-0" of each unit on each end)
MATE BEAM: Multi-layer laminated plywood
HEIGHT: 16 1/2" to 24" to 16 1/2"
LENGTH: 60 FT
NO. OF LAYERS: (4)
NO. OF BEAMS: (1)
CEILINGS: 2 ft. x 4 ft. Standard T-Grid #769
(Mineral Fiber Tile) installed at factory. (8'-8" A.F.F.)
Held back at mate lines.
Completion of ceiling installation on site by Nortex.
INSULATION: R-30c (Compressed) unfaced fiberglass batt with support netting
SHEATHING: 7/16" FR-Deck
ROOFING: 45 mil black single plymembrane adhered to FR-Deck with Mule Hide Acrylic Water Base Bonding Adhesive (100 sq. ft. per gallon)

ADDITIONAL ROOF ITEMS INCLUDED IN QUOTED PRICE:
ITEM 1) Three (3) 3" holes in each mate beam for phone/data crossover.

EXTERIOR DOORS: Door color to be: (SW-6149 Relaxed Khaki) on both sides.

DOOR "1"

QUANTITY: (2) 36" X 80" Commercial steel, 18 Gauge door, 16 Gauge jamb with pencil window (6" X 22")
CLOSER: Hydraulic closer (Tell 12641)
HARDWARE: Keyed lever (Tell LC2481CTL) "KEYED ALIKE"

INTERIOR DOORS:

DOOR "2"

QUANTITY: (10) 36" X 80" Comm'l prefinished hollow core
HARDWARE: Passage lever (LC2475CTL), Floor mounted door stops

DOOR "3"

QUANTITY: (2) 36" X 80" Comm'l prefinished hollow core
HARDWARE: Privacy lever (LC2476CTL), Floor mounted door stops

WINDOWS:

WINDOW "A"

QUANTITY: (16) Clear glass bronze finish vertical slider
Dual glazed, "LOW-E"
24" X 52"

ELECTRICAL

SERVICE: 120/230v. 60 Hz. Single phase
PANEL BOXES: (3) 100A (NEMA 3R) Single Phase with main breaker.
SERVICE ENTRANCE: EMT conduit thru floor.
RACEWAY: EMT thin wall conduit with green ground
LIGHT TYPE No.1: 48" 4-tube diffused flourescent recessed lay-in (T-8 Lamps and Electronic Ballast)
LIGHT TYPE No.2: 48" 3-tube diffused flourescent recessed lay-in (T-8 Lamps and Electronic Ballast)
PORCH LIGHTS: (2) Fluorescent exterior with photo cell
EXIT LIGHT: (2) Combo dual emergency light/exit light sign with battery backup
EMERGENCY LIGHTS: (2) Exterior remote heads
RECEPT. TYPE No.1: 20a/125v Duplex
RECEPT. TYPE No.2: 20a/125v GFCI protected
RECEPT. TYPE No.3: 20a/125v Waterproof exterior with in-use cover
RECEPT. TYPE No.4: 20a/125v Heat tape receptacle under unit
PHONE/COMM JACKS: Stubbed out above T-Grid with 3/4" EMT conduit

PLUMBING:

SUPPLY: Type L Hard Copper
DWV SYSTEM: Poly vinyl chloride Schedule 40
WATER CLOSETS: (2) Handicapped tank type
LAVATORIES: (2) White vitreous wall hung with ADA handles
WATER HEATERS: (1) 6 gallon electric with vacuum relief and drain pan
PAPER HOLDER: (2) Chrome single roll wall mount
GRAB BARS: (2) Sets
MIRRORS: (2) 18" X 36" with clips
SINK: (1) 25" X 22" stainless steel single bowl with ADA handles
MDP SINK: (1) 24" X 24" fiberglass mop sink with legs

HVAC: Color to be: (BEIGE)

HVAC UNITS: END MOUNTS - 36vp 3 ton cooling with 10KW electric heat strip. (SB-2)
(2) 100 cfm ceiling mounted light/fan combo
EXHAUST FANS: 18" X 9" and 11" X 9"
DUCT: 1 1/2" Foil faced fiberglass
24" X 24" 4-way lay-in

DIFFUSERS: 24" X 24" 4-way lay-in
R/A GRILLS: 24" X 24" Perforated lay-in

ADDITIONAL HVAC ITEMS INCLUDED IN QUOTED PRICE:
ITEM 1) Plenum wall with ducted supply and return.
ITEM 2) Programmable T-stats.

CABINETS:

BASE CABINETS: (2 LF) Stained wood with laminated top.
Laminated color to be: (FASHION GRAY)
WALL CABINETS: (5 LF) Stained wood

ADDITIONAL CABINET ITEMS INCLUDED IN QUOTED PRICE:
ITEM 1) ADA/TAS sink base with wood apron

SKIRTING: NONE

STATE LABELS: Third party plan review and state.
IBC certification to be included.

ADDITIONAL LABEL ITEMS INCLUDED IN QUOTED PRICE:
ITEM 1) TX State label only.
ITEM 2) 130-mph and Exp. B
ITEM 3) 2006 IBC coded.

- ☐ APPROVED
☐ APPROVED EXCEPT AS NOTED
☐ REVISE AND RESUBMIT

BY: _____ DATE: _____

APPROVED DRAWINGS MUST BE RETURNED TO
INDICOM BUILDINGS, INC. NO LATER THAN _____
IN ORDER TO RETAIN CURRENT ESTIMATED
PRODUCTION SCHEDULE.

<div><input type="checkbox"/> APPROVED <input type="checkbox"/> APPROVED EXCEPT AS NOTED <input type="checkbox"/> REVISE AND RESUBMIT</div> <div>BY: _____ DATE: _____</div> <div>APPROVED DRAWINGS MUST BE RETURNED TO INDICOM BUILDINGS, INC. NO LATER THAN _____ IN ORDER TO RETAIN CURRENT ESTIMATED PRODUCTION SCHEDULE.</div>	
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DATA PLATE

MANUFACTURE & ADDRESS: INDICOM BUILDINGS, INC.
(FOR WARRANTY INFORMATION) 721 N. Burleson Blvd.
BURLESON, TX. 76028
1HM - 47
DRAT AGENCY: ADDRESS: PFS Corporation Cottage Grove, WI
SERIAL No.
DECAL No.
DATE OF MFG.
FLOOR LIVE LOAD: 50 psf. (2000 lb concentrated)
(100 psf. @ corridor)
WIND LOAD (V3s): 130mph (EXPOSURE-B)
ROOF LIVE LOAD: 20 psf.
TYPE OF CONSTRUCTION: VB
OCCUPANCY USE GROUP: B
PERMISSABLE GAS (for equip.) N/A
NAME AND DATE OF CODES: 2006 IBC, 2006 IPC.
2006 IMC, 2008 NEC.
2006 IECC, 1994 TAS

SYSTEMS COMPLETED AT FACTORY:
STRUCTURAL(X) ELECTRICAL(X) PLUMBING(X)
H.V.A.C. (X)
SPECIAL CONDITIONS/LIMITATIONS

HEATING EQUIP. MFG.
HEATING MODEL
SEISMIC DESIGN CAT.: C

NOTE: DATA PLATE TO BE LOCATED ON PANEL BOX DOOR OR SHALL BE
PLACE ON THE INTERIOR SIDE OF THE EXTERIOR WALL @ THE HITCH
END ABOVE THE T-GRID LOCATION.

NOTES:

1. SITE PLAN NOT AVAILABLE AT THIS TIME. BUILDING DESIGNED TO HAVE FIRE SEPARATION DISTANCE GREATER THAN 10 FT. IN ACCORDANCE WITH TABLE 602 OF THE 2006 IBC.
2. PORCHES, STEPS, AND RAMPS TO BE SUPPLIED AND INSTALLED BY OTHERS IN ACCORDANCE WITH THE 1994 TAS AND THE IBC.
3. PORTABLE FIRE EXTINGUISHERS TO BE SUPPLIED AND INSTALLED ON SITE BY OWNER IN ACCORDANCE WITH SECTION 906 OF THE 2006 IBC.
4. DRINKING FOUNTAIN TO BE PROVIDED ON SITE BY OWNER.
5. ADDITIONAL HANDICAP TOILET FACILITIES PROVIDED IN ADJACENT BUILDING ON THE SAME PROPERTY.
6. ALL REST ROOM WALLS TO HAVE FRP WAINSCOT 48" HIGH.
7. SERVICE SINK PROVIDED IN ADJACENT BUILDING ON THE SAME PROPERTY.
8. ANY REQUIRED FIRE/SMOKE DETECTION AND/OR SUPPRESSION TO BE INSTALLED BY OTHERS ON SITE IN ACCORDANCE WITH THE IBC AND THE IFC.
9. NORTEX MODULAR TO SITE CONSTRUCT DRAFT STOP IN ACCORDANCE WITH THE IBC WHERE REQUIRED.
10. TDLR DECAL TO BE LOCATED ON HITCH END INTERIOR WALL ABOVE T-GRID.
11. DOOR CLOSERS SHALL COMPLY WITH THE REQUIREMENTS IN TAS 4.13.10 AND 4.13.11 FOR CLOSING SPEED AND OPENING FORCE.

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INDICOM BUILDINGS, INC.
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721 N. BURLESON BLVD - BURLESON, TX 76028
817-447-1213 FAX 817-447-2751

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DEALER: NORTEX MODULAR

DFW

PROJECT: 14 X 64 (60)

NORPLEX "VO" SERIES

PROJECT NUMBER:

PROJECT -NTX - VO

SCALE: AS NOTED

PLOT DATE:
11/11/2008

SALESMAN: RP

DRAWN BY: MJM

STATES:
TX

SERIAL NUMBERS:
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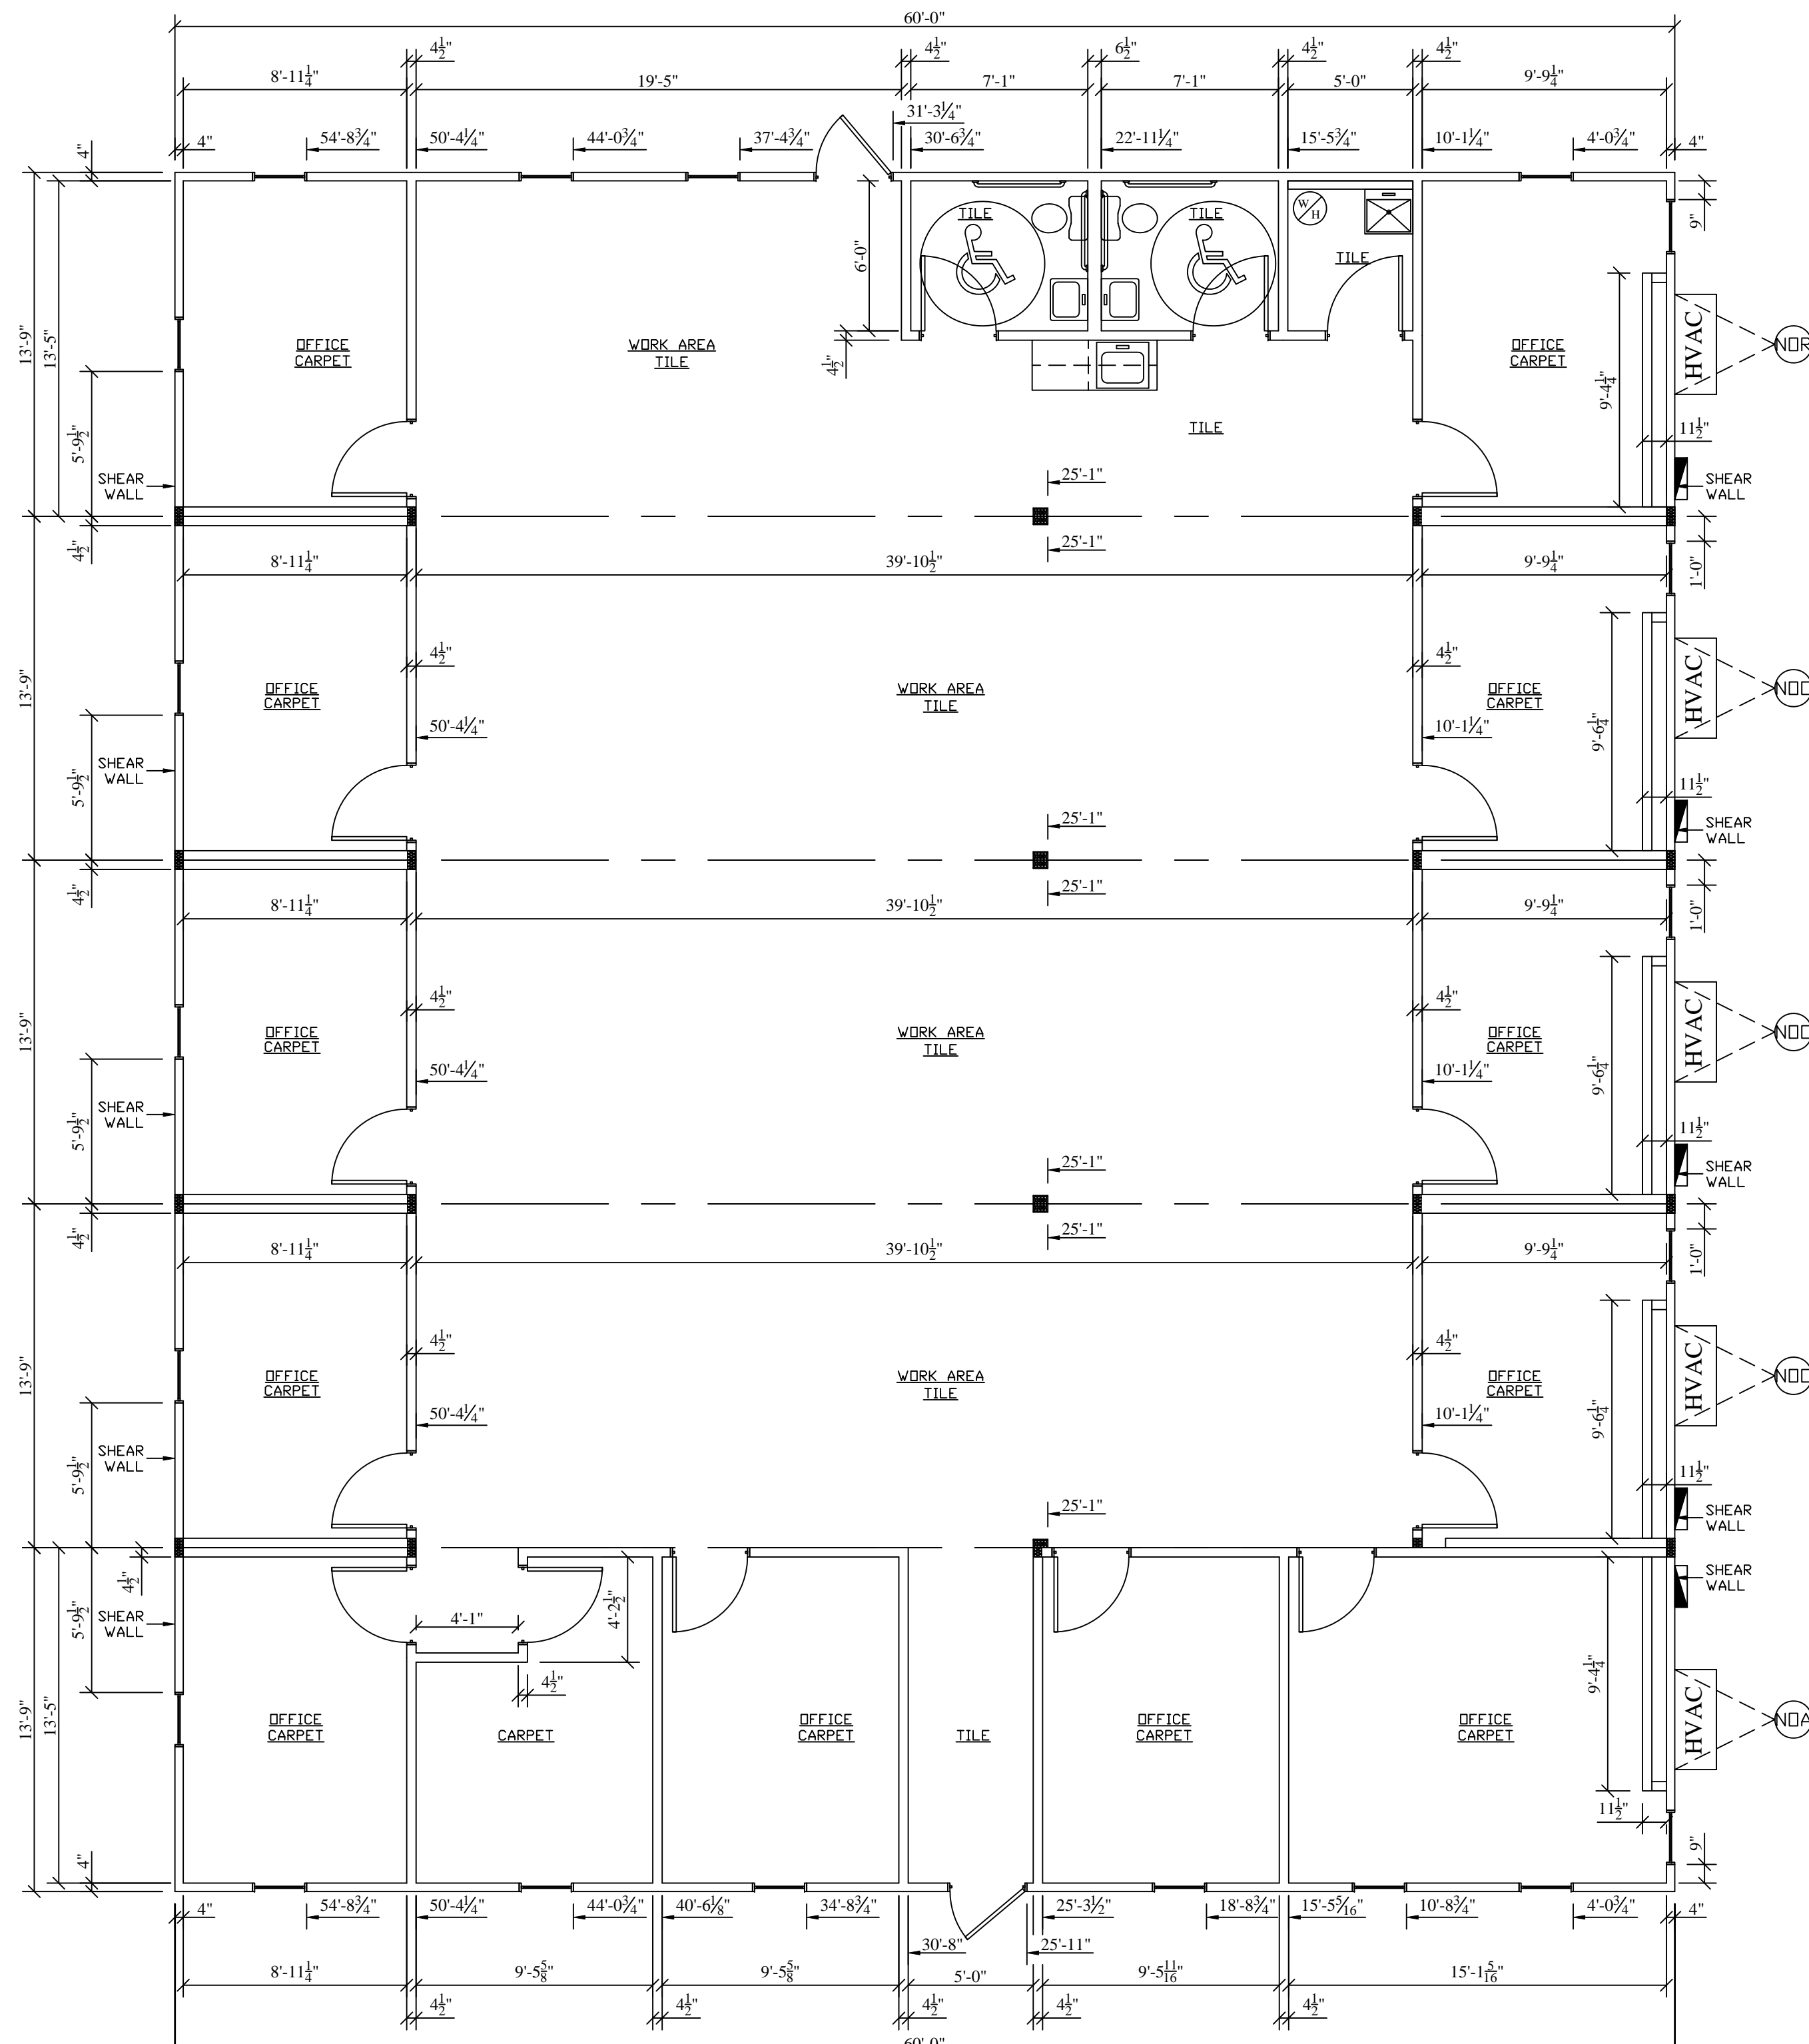
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5-UNIT COMPLEX FLOOR PLAN
3/16" = 1'-0"

SQUARE FOOTAGE: 4125
USE GROUP: B
CONSTRUCTION TYPE: VB
OCCUPANT LOAD: 41

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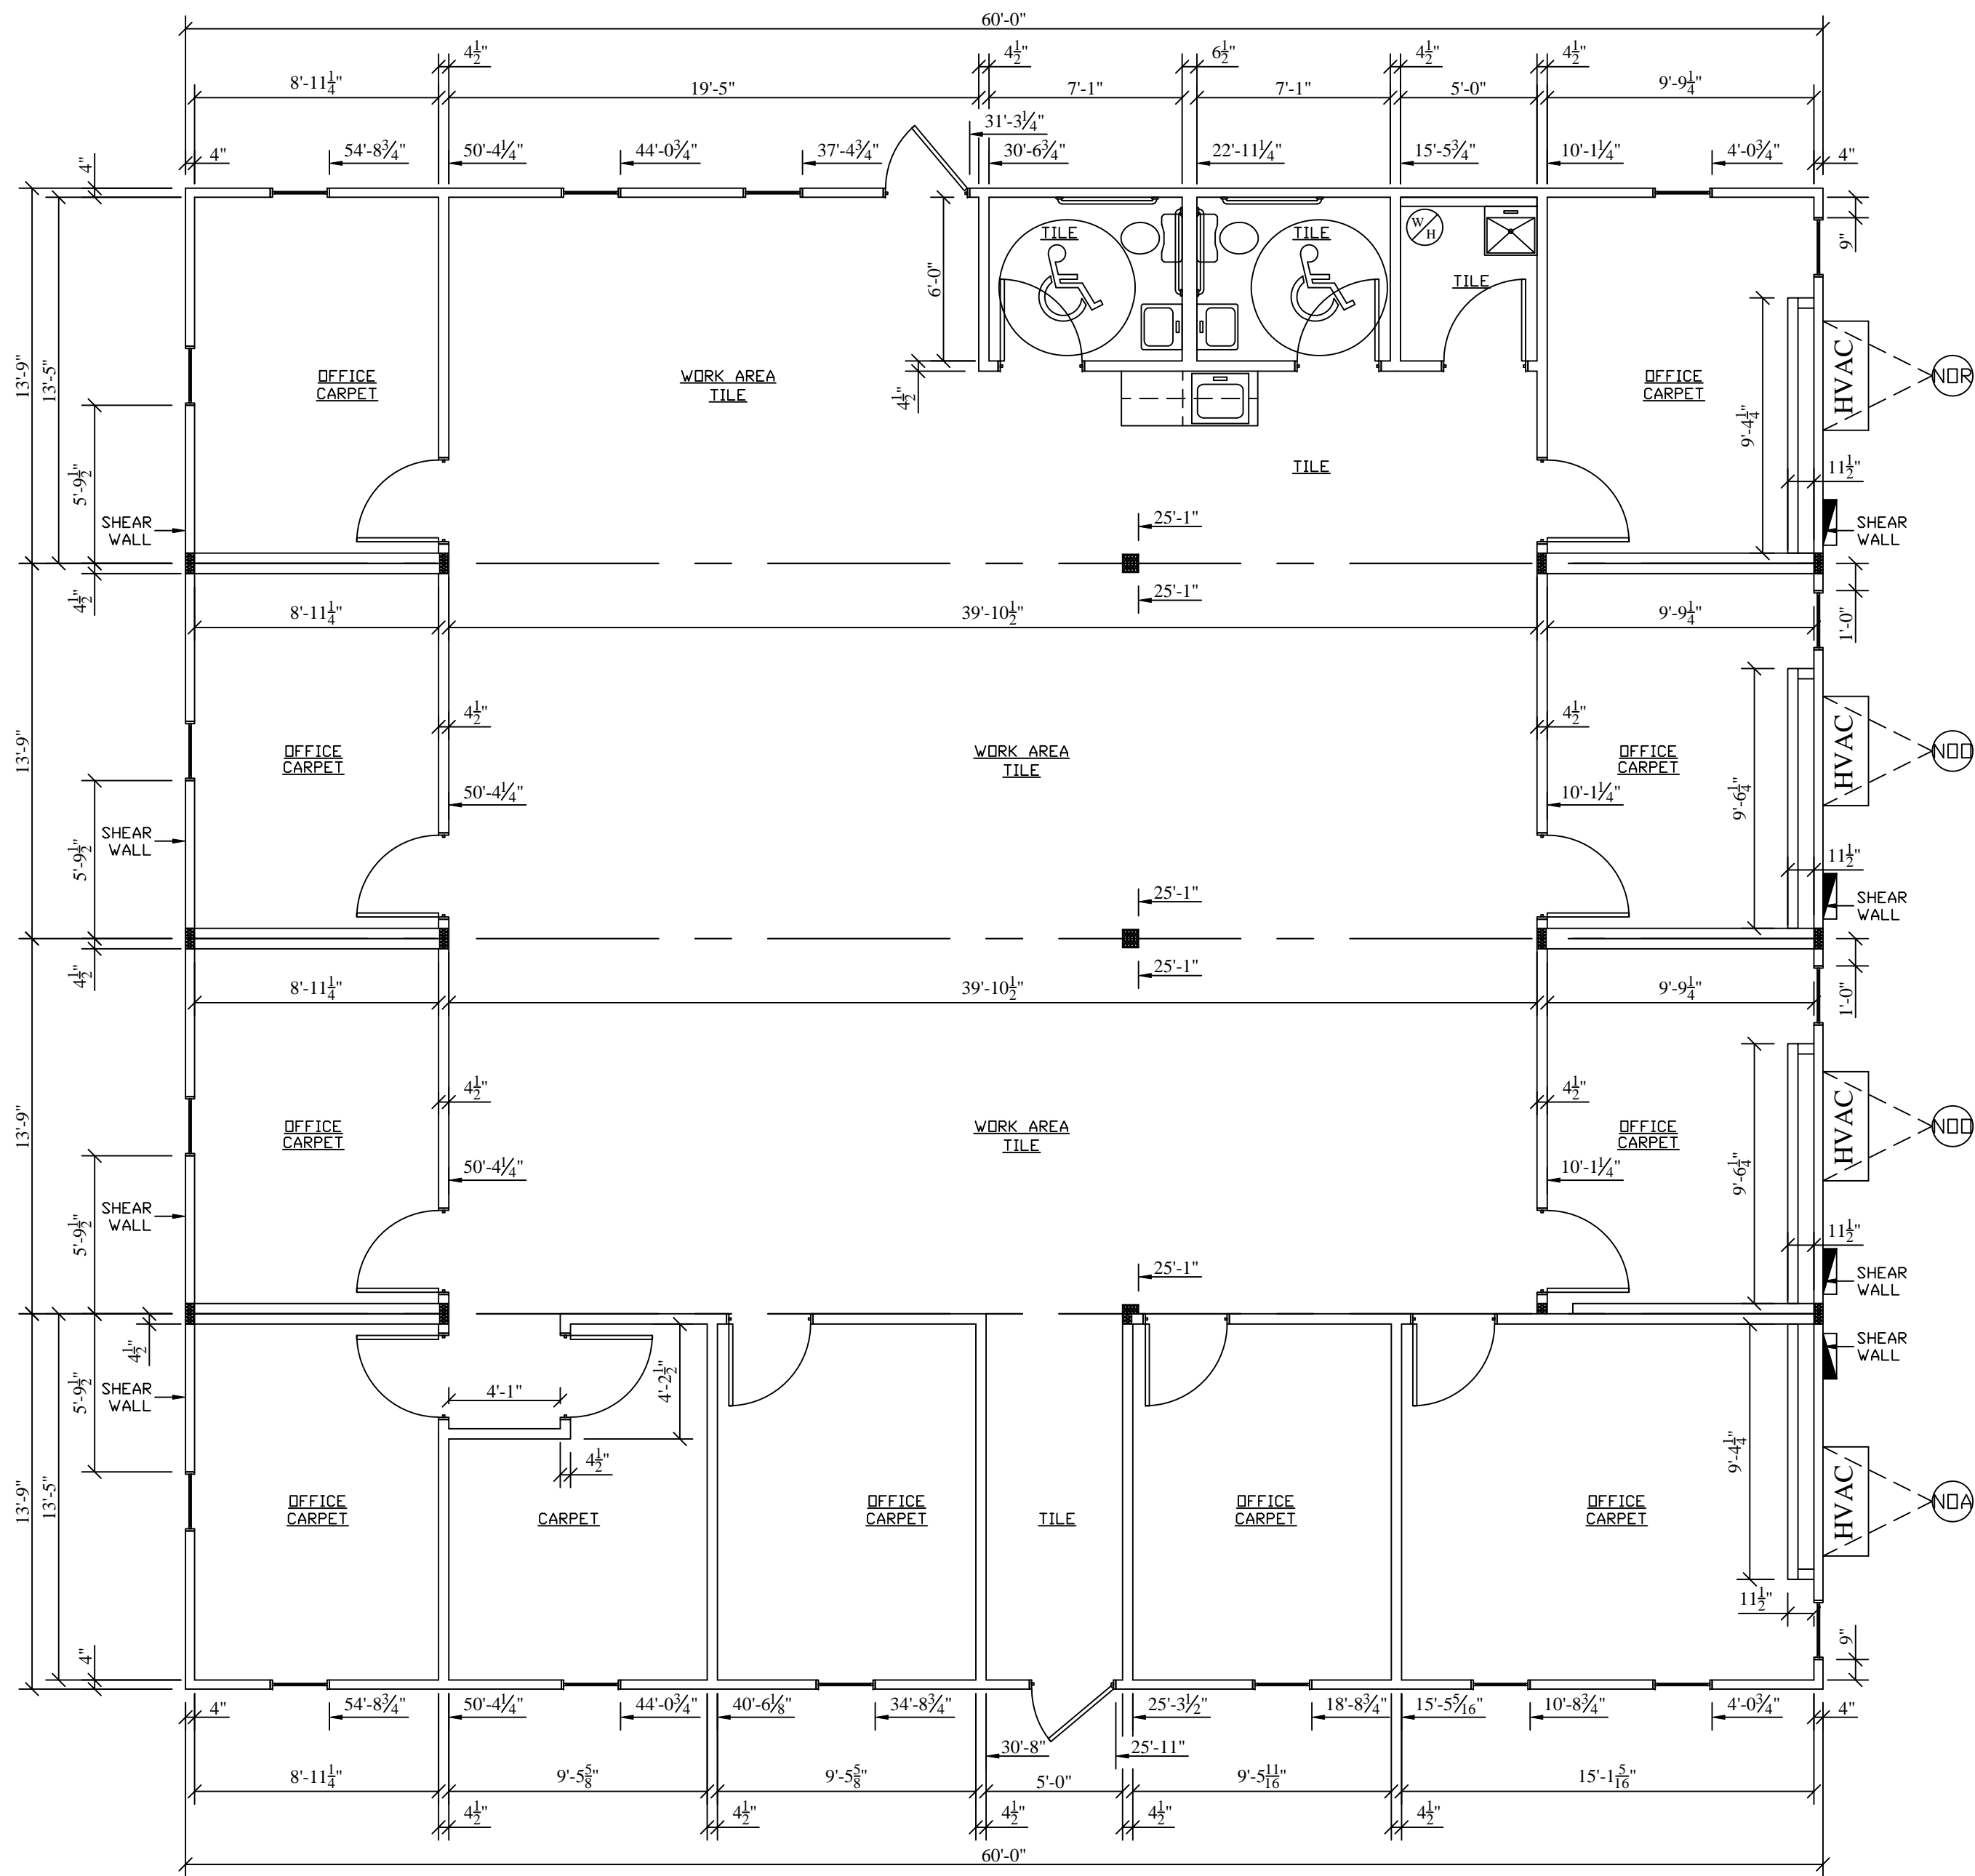
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4-UNIT COMPLEX FLOOR PLAN

3/16" = 1'-0"

SQUARE FOOTAGE: 3300
USE GROUP: B
CONSTRUCTION TYPE: VB
OCCUPANT LOAD: 33

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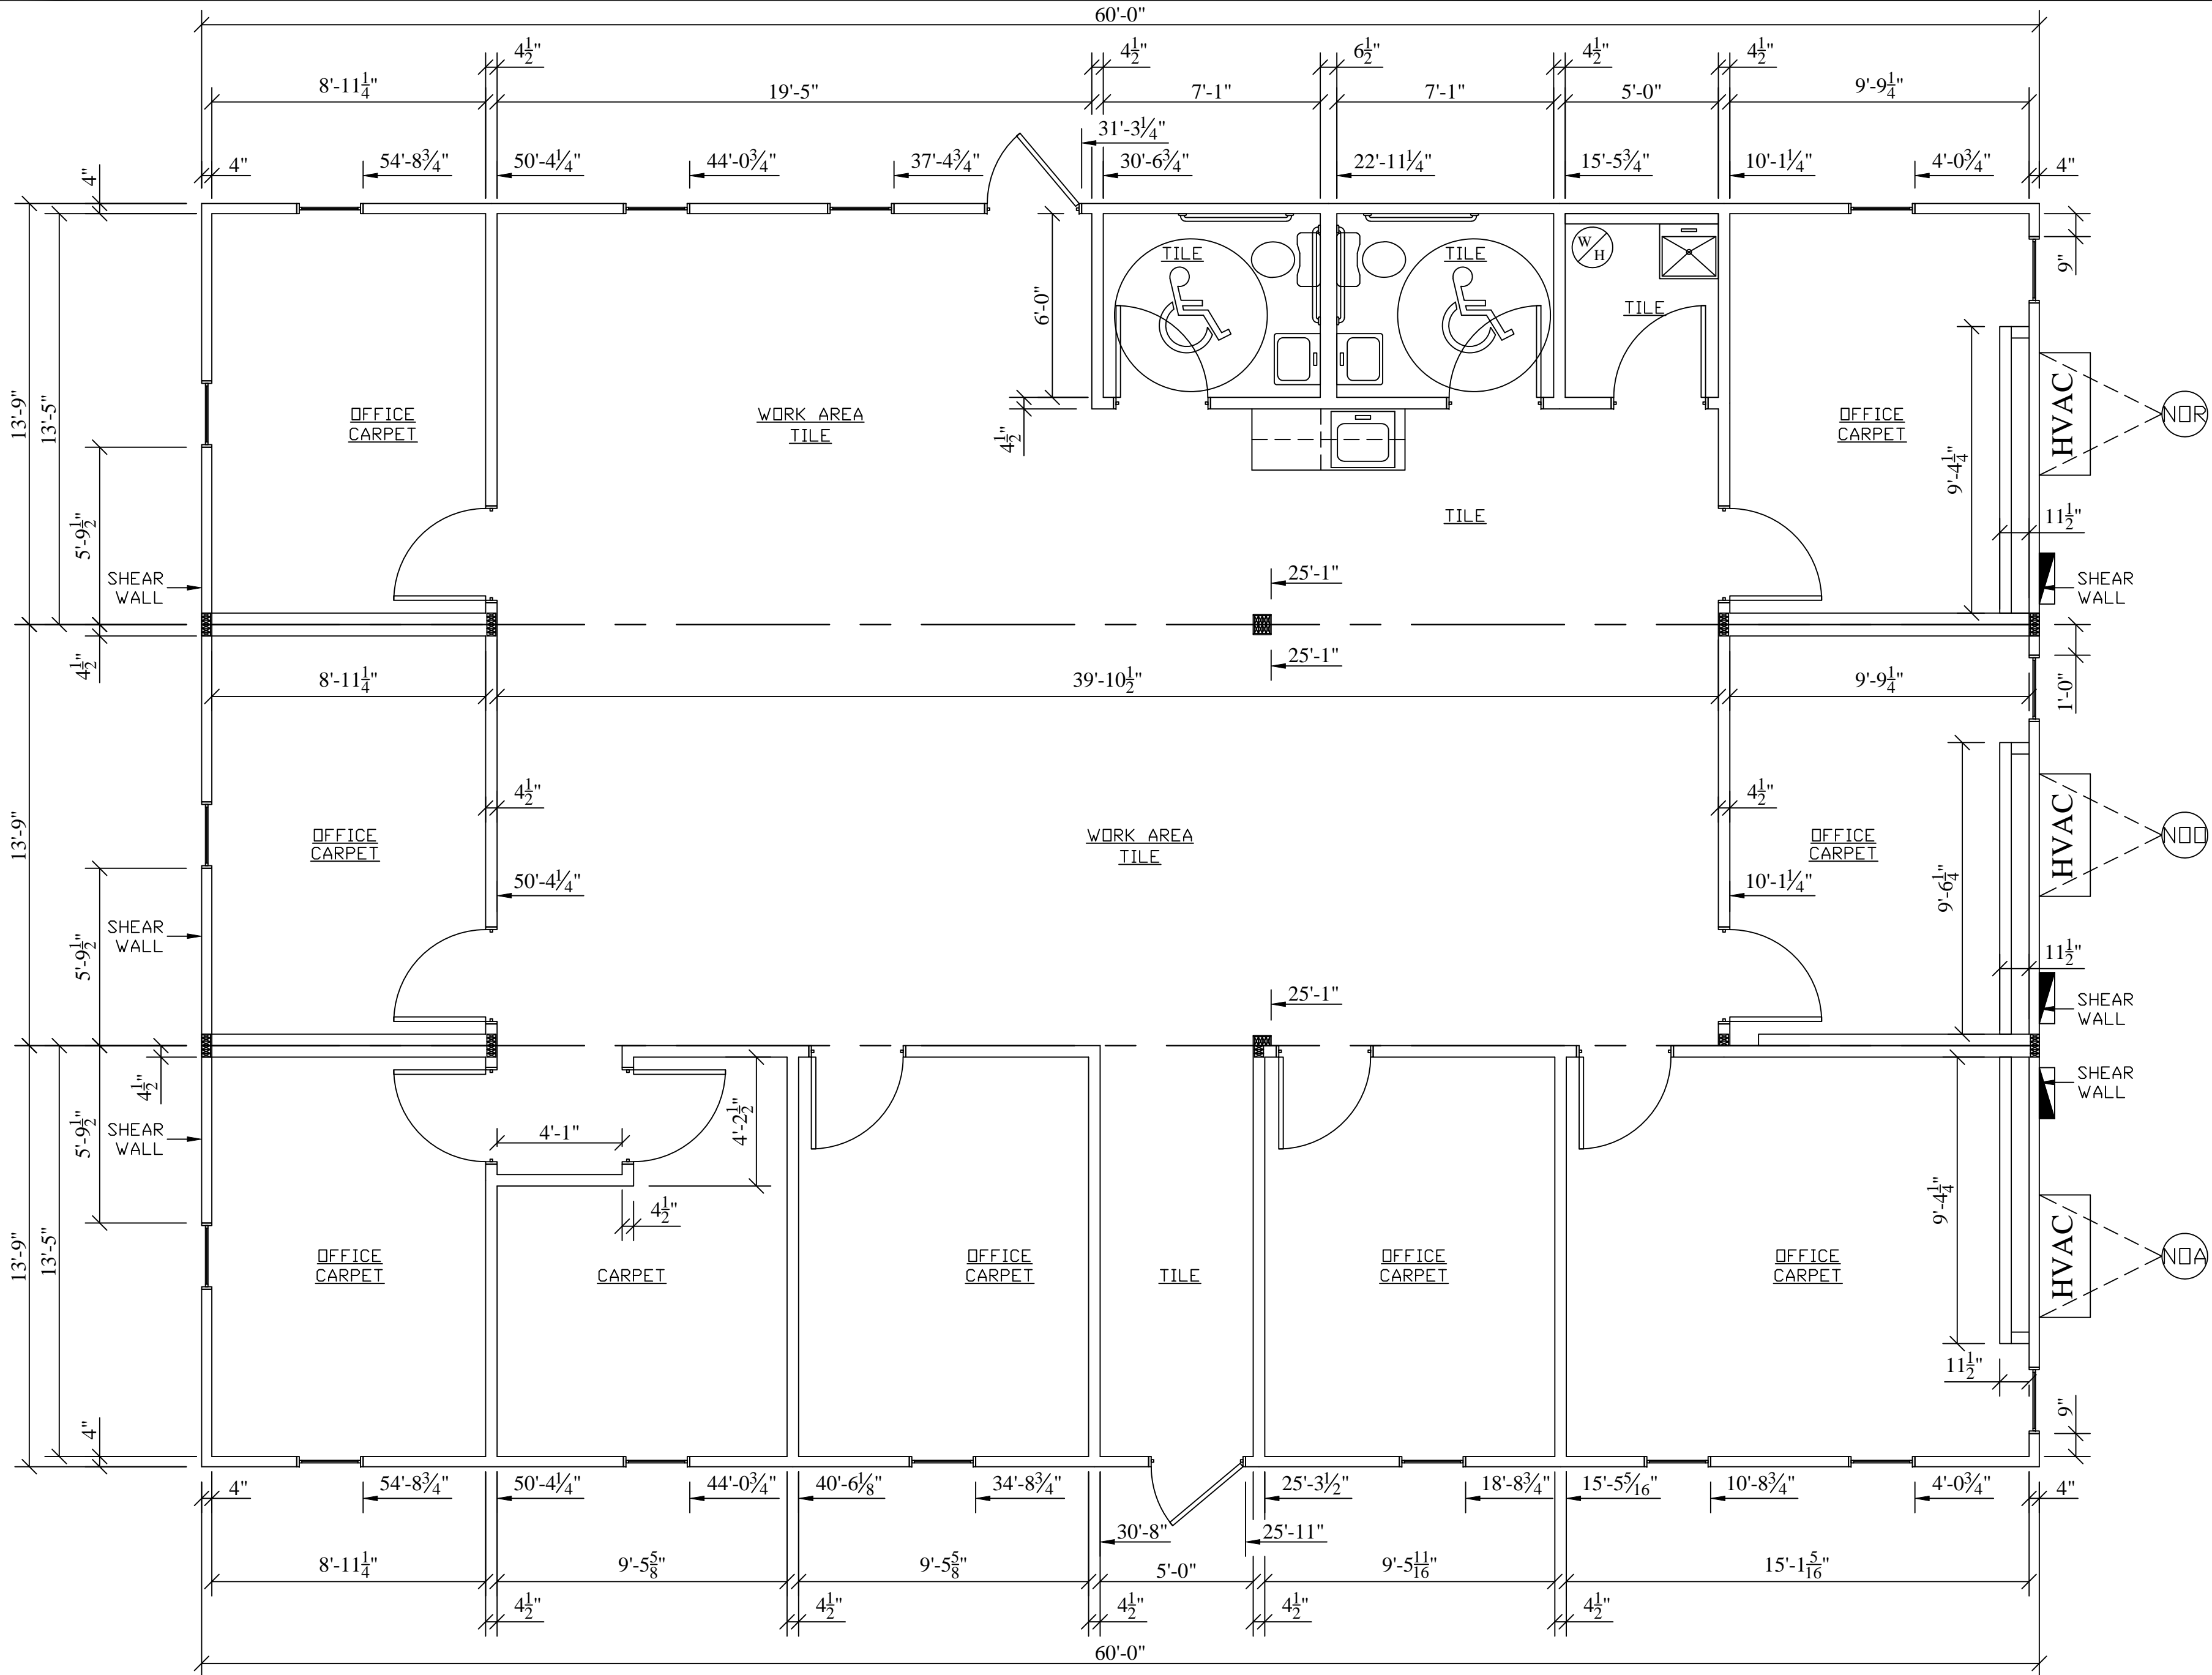
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TRIPLE FLOOR PLAN

1/4" = 1'-0"

SQUARE FOOTAGE: 2475
USE GROUP: B
CONSTRUCTION TYPE: VB
OCCUPANT LOAD: 25

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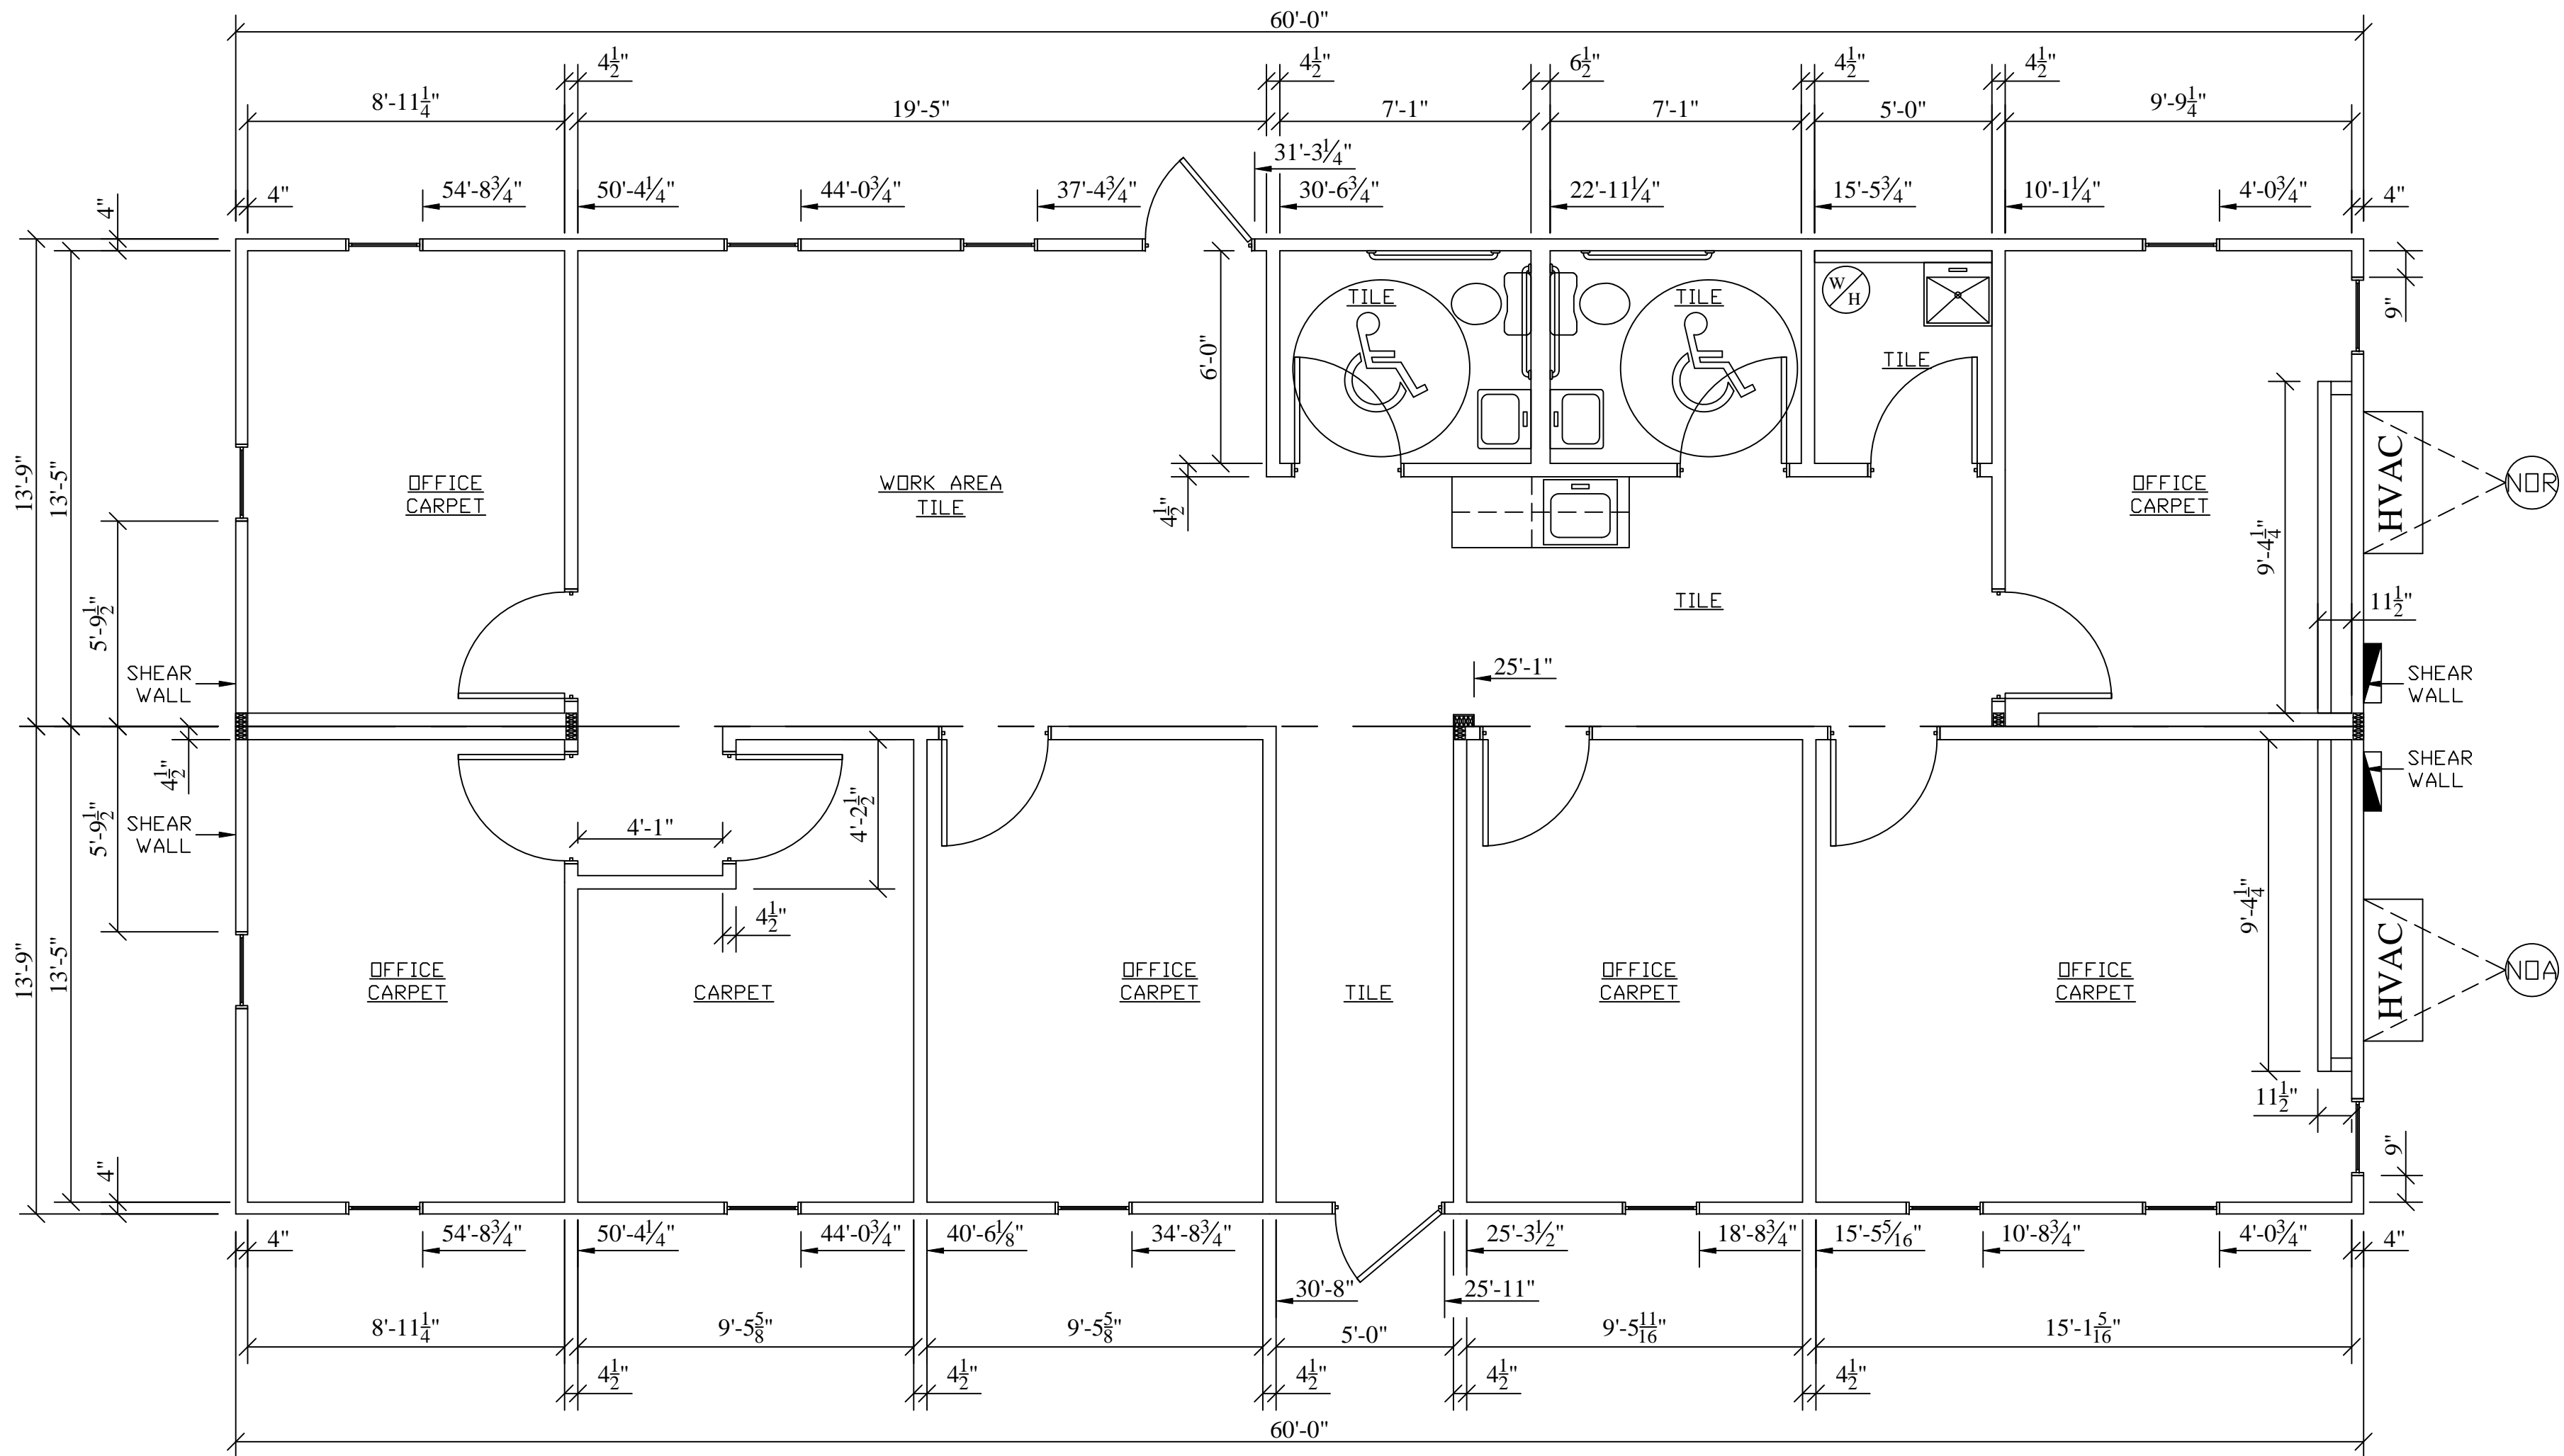
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DOUBLE FLOOR PLAN

1/4" = 1'-0"

SQUARE FOOTAGE: 1650
USE GROUP: B
CONSTRUCTION TYPE: VB
OCCUPANT LOAD: 17

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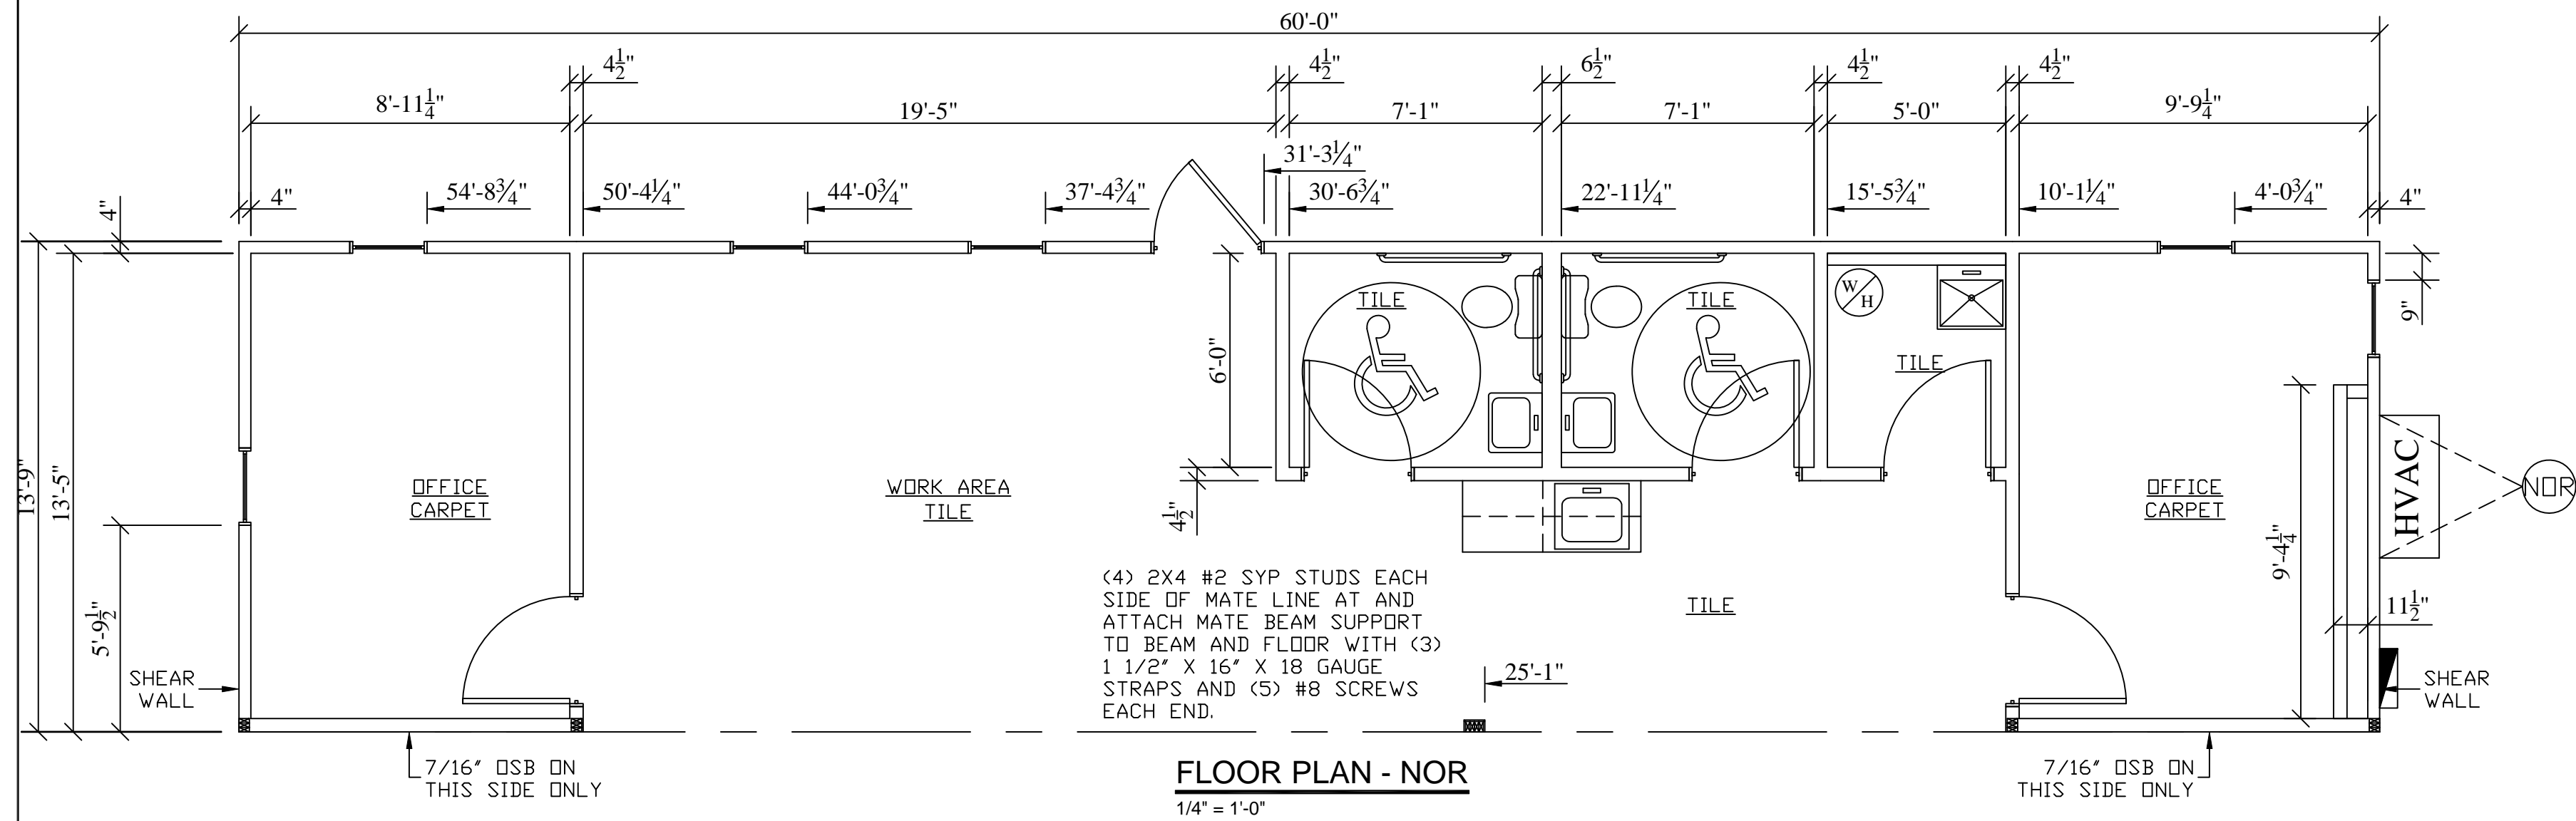
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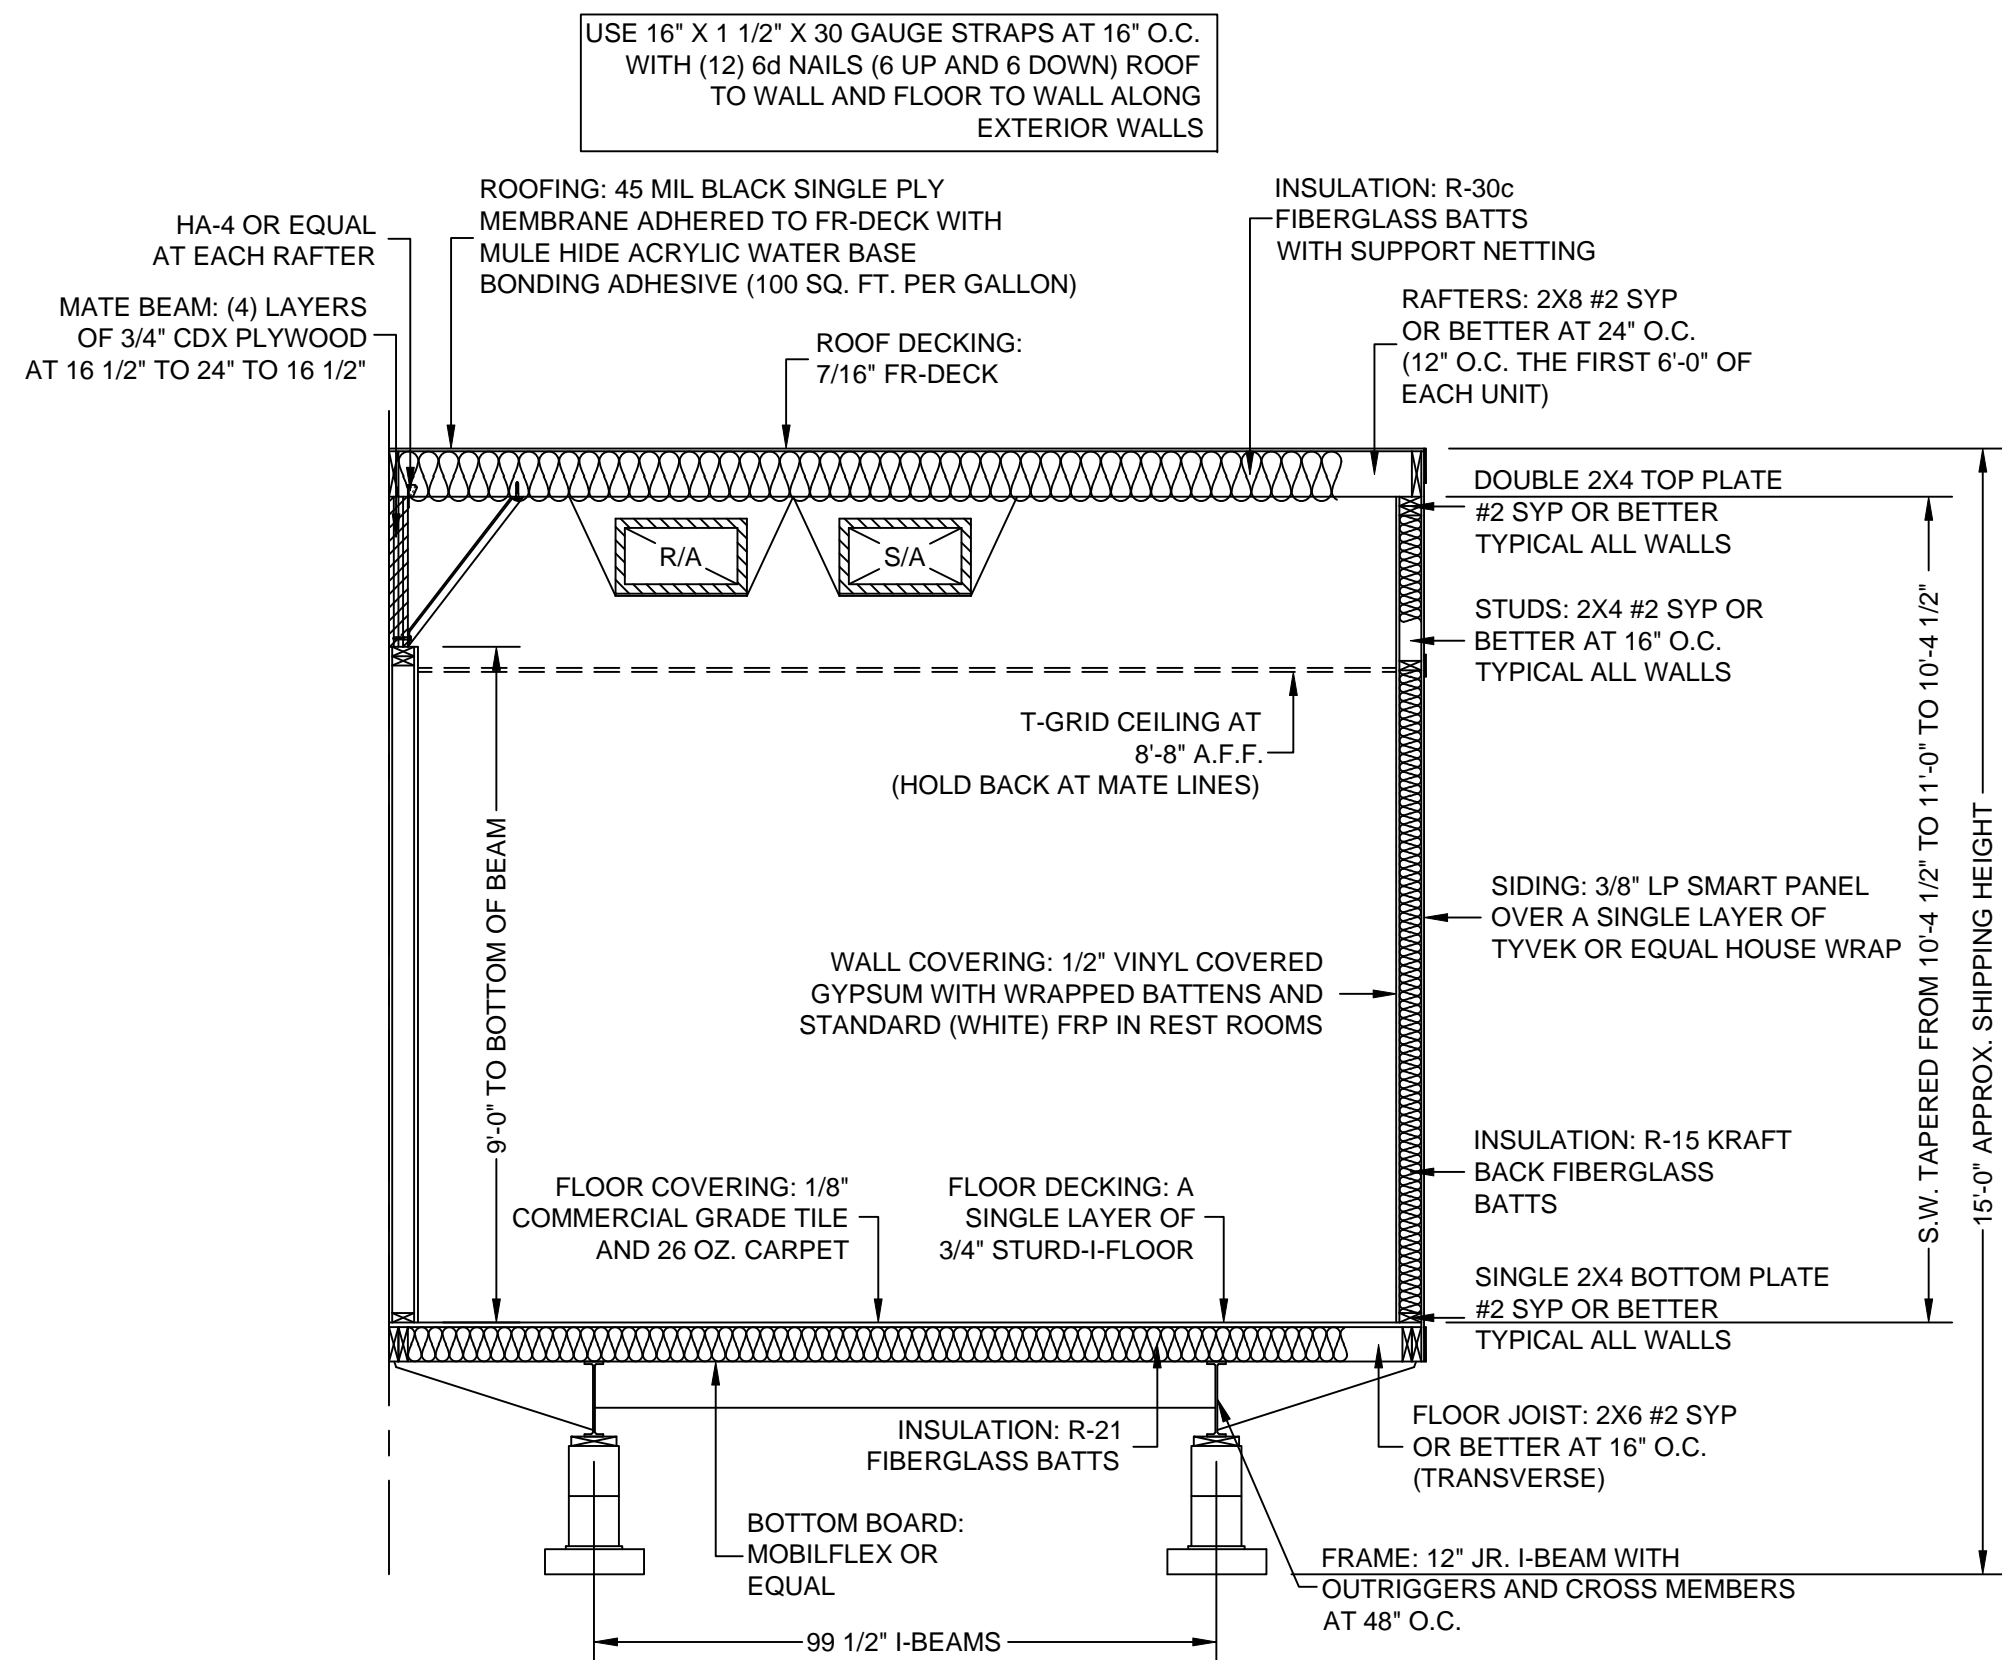
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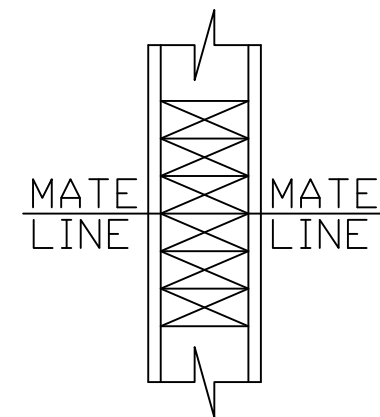


FLOOR PLAN - NOR
1/4" = 1'-0"



BUILDING CROSS-SECTION AT HITCH END
3/8" = 1'-0"

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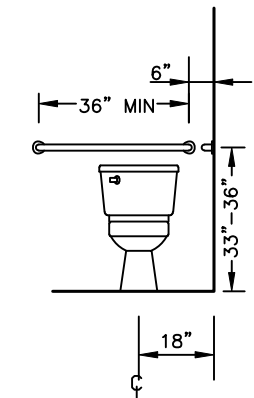


THREE (3) STUD COLUMN: (3) 2X4 #2 SYP STUDS ATTACHED TO BEAM AND FLOOR WITH (2) 1 1/4" X 12" X 18 GAUGE STRAPS WITH (7) #8 SCREWS AT EACH END


COLUMN DETAIL IN WALLS
1 1/2" = 1'-0"

FLOOR PLAN LEGEND	
	HANDICAPPED TANK TYPE WATER CLOSET
	WHITE VITREOUS WALL HUNG LAVATORY WITH ADA HANDLES
	6 GALLON ELECTRIC WATER HEATER WITH VACUUM RELIEF AND DRAIN PAN
	25" X 22" STAINLESS STEEL SINGLE BOWL SINK WITH ADA HANDLES AND GOOSENECK FAUCET
	24" X 24" FIBERGLASS MOP SINK WITH LEGS
	36" GRAB BAR
	42" GRAB BAR


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USE GROUP: B
CONSTRUCTION TYPE: VB
OCCUPANT LOAD: 8




HANDICAPPED WATER CLOSET FRONT VIEW

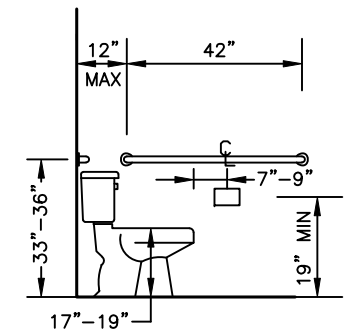

HANDICAPPED WATER CLOSET SIDE VIEW

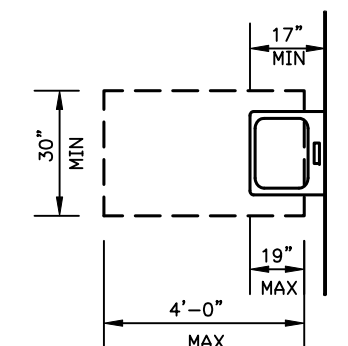

CLEAR FLOOR SPACE AT LAVATORIES

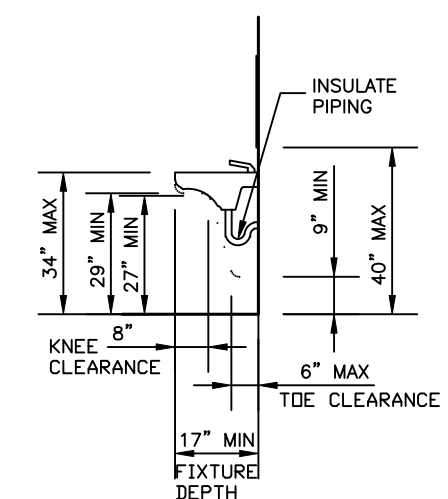

LAV CLEARANCES

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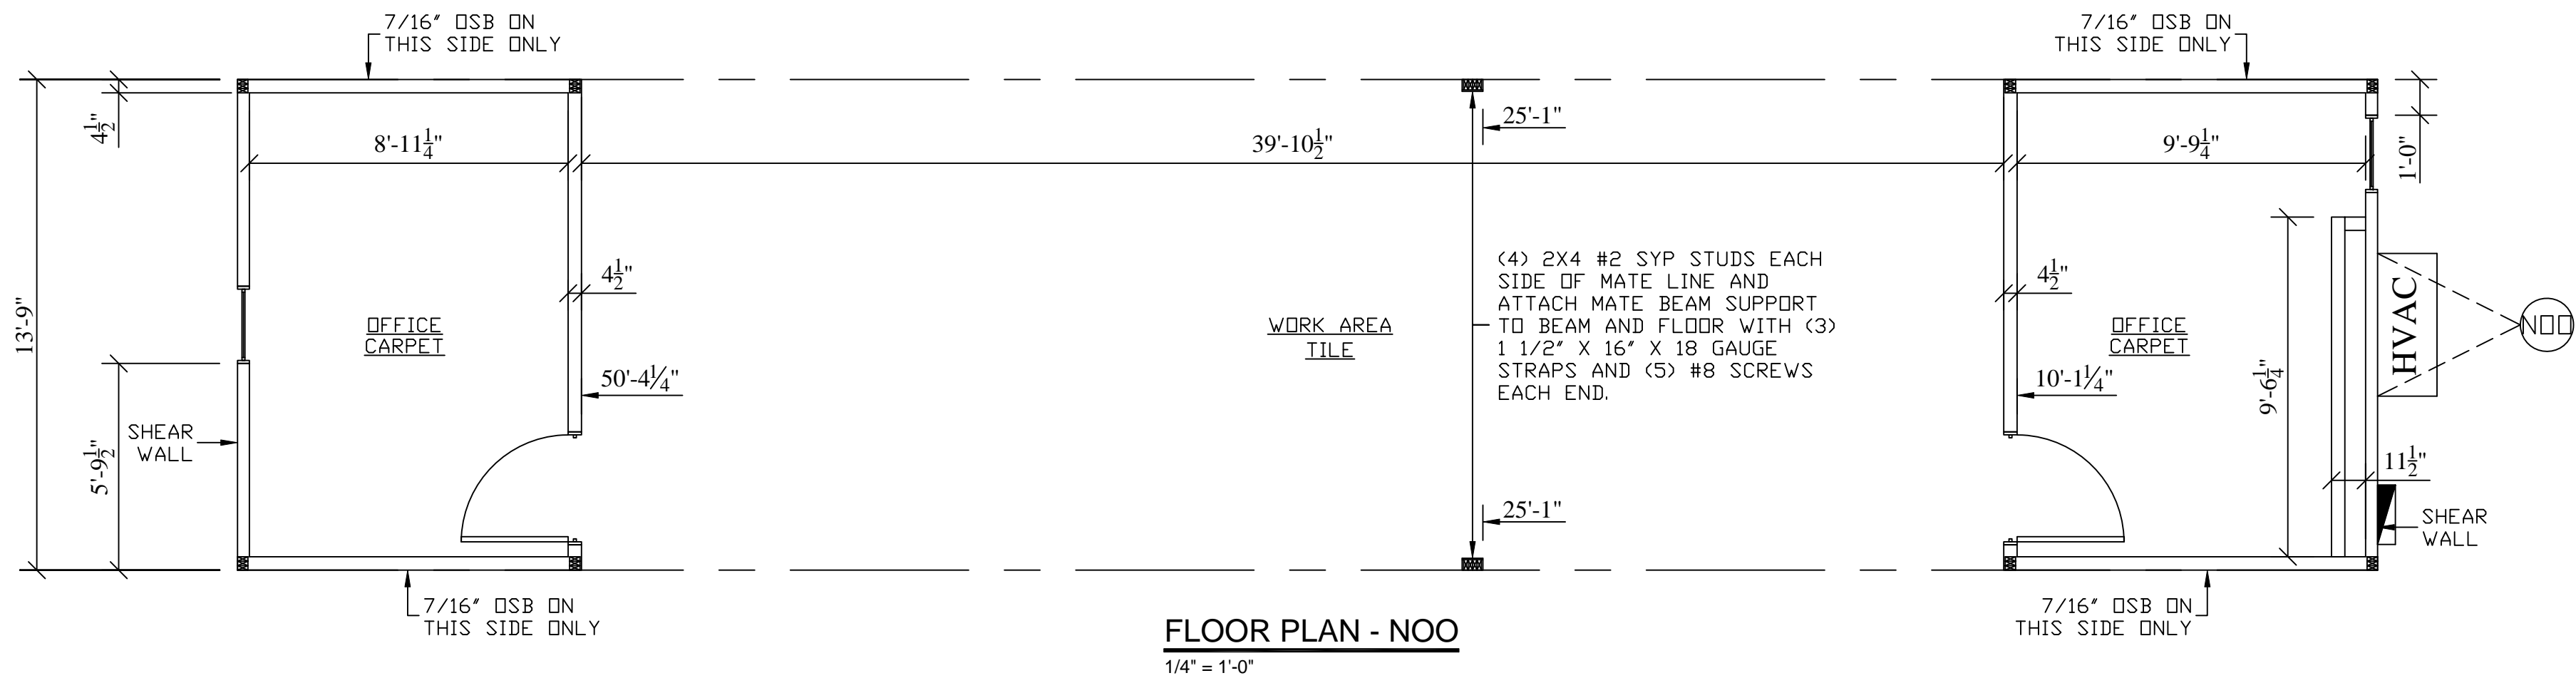
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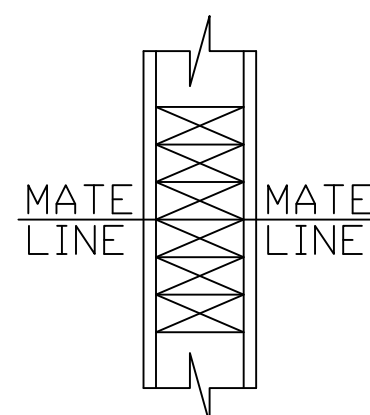
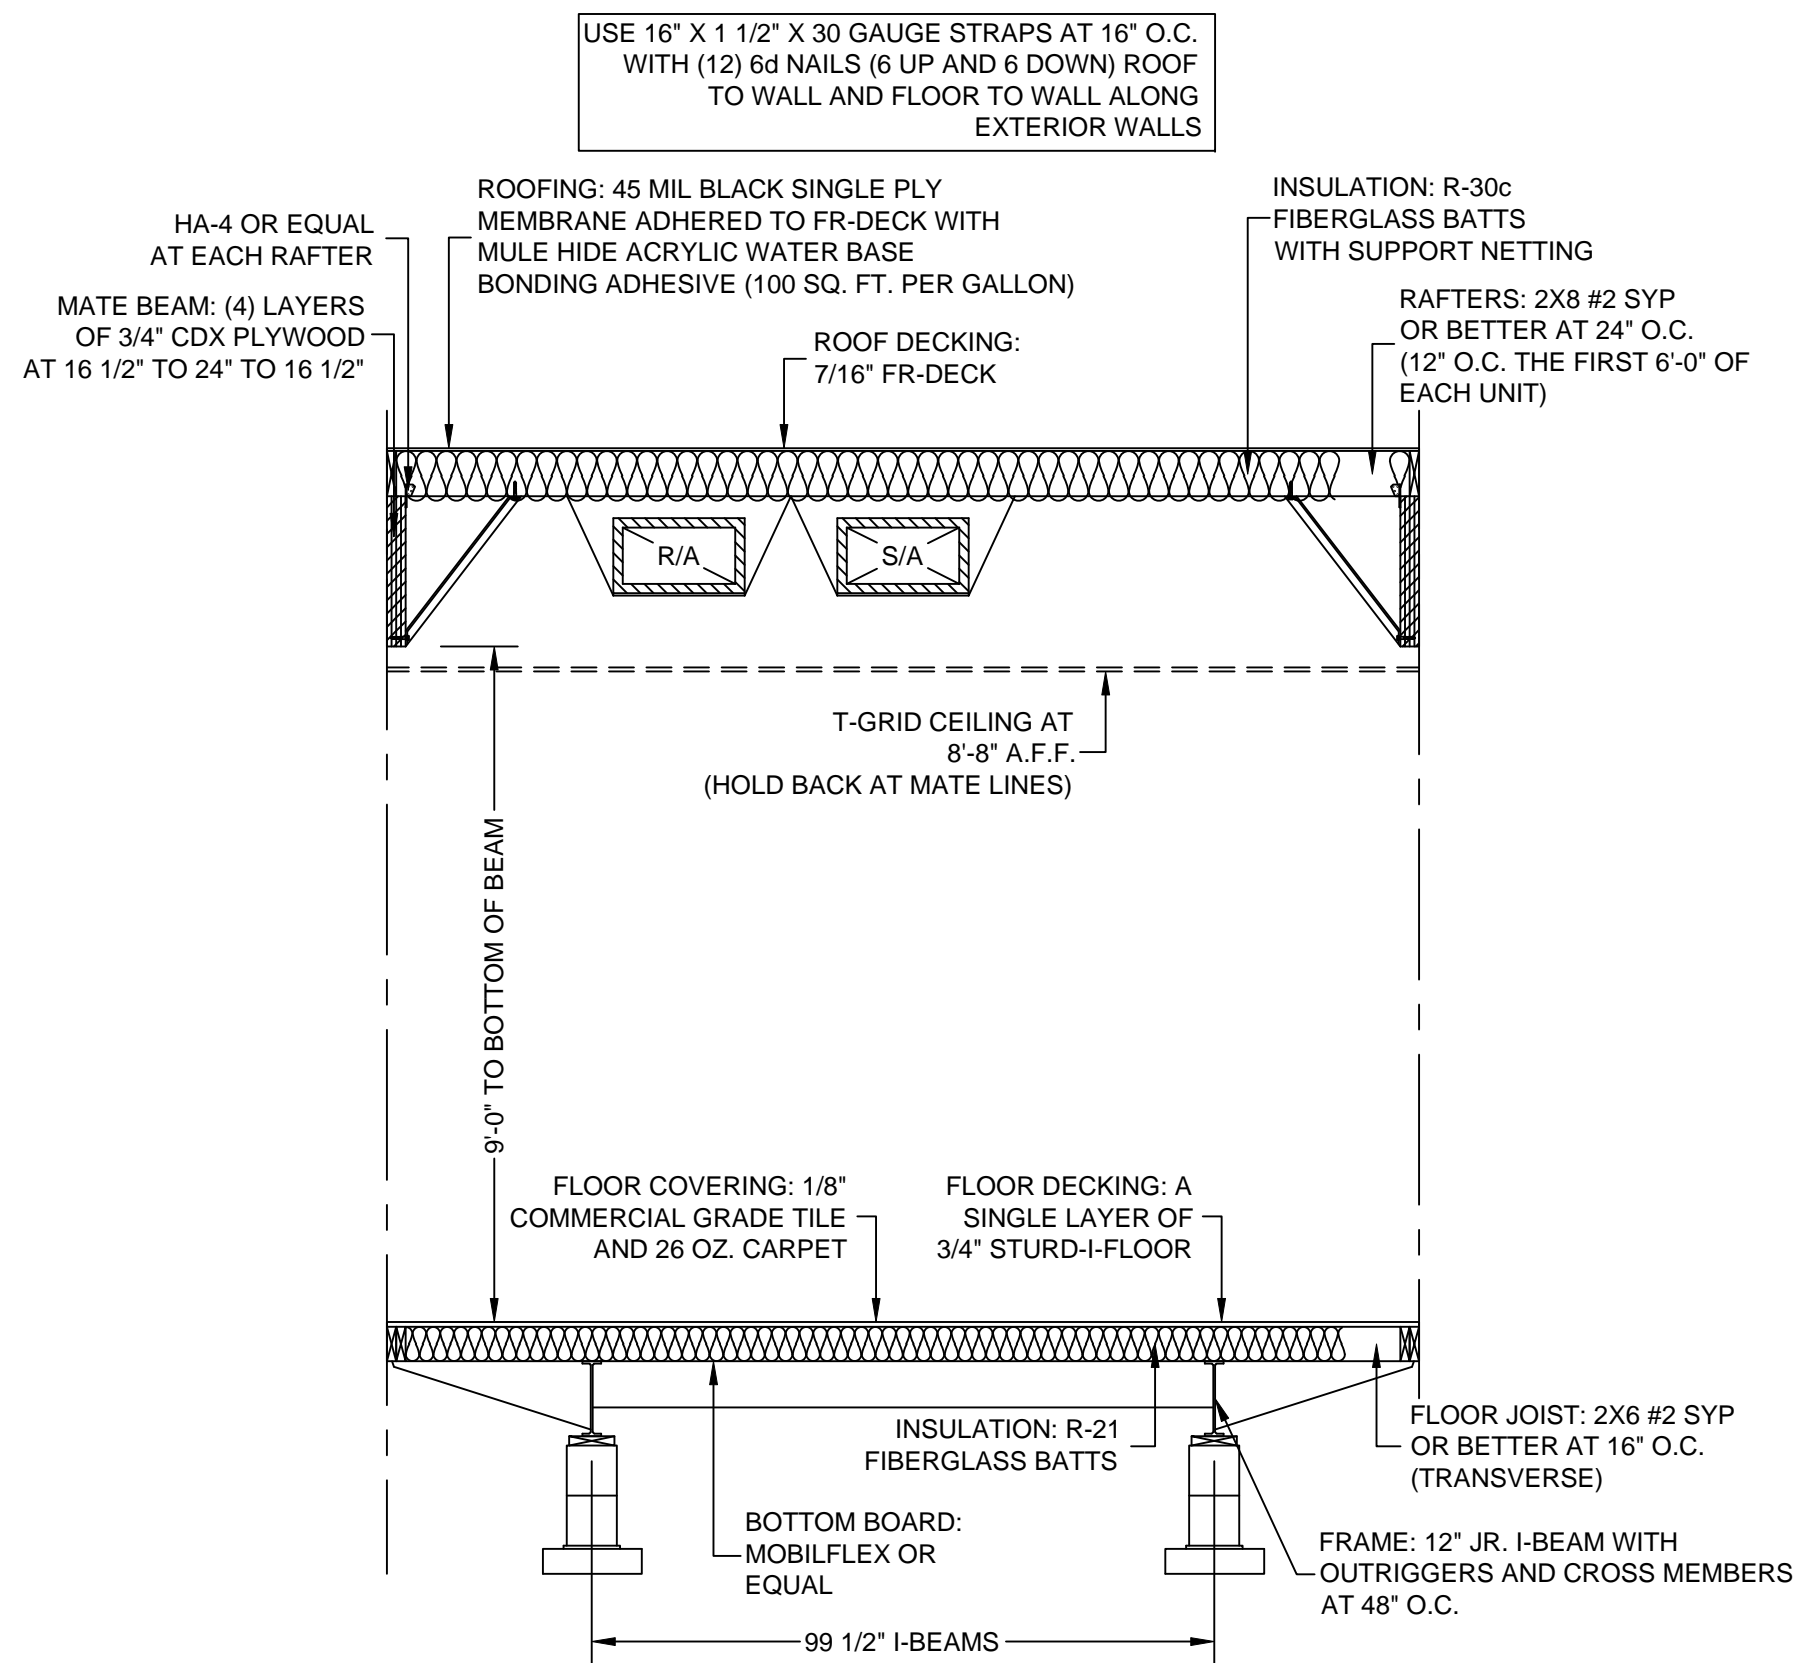
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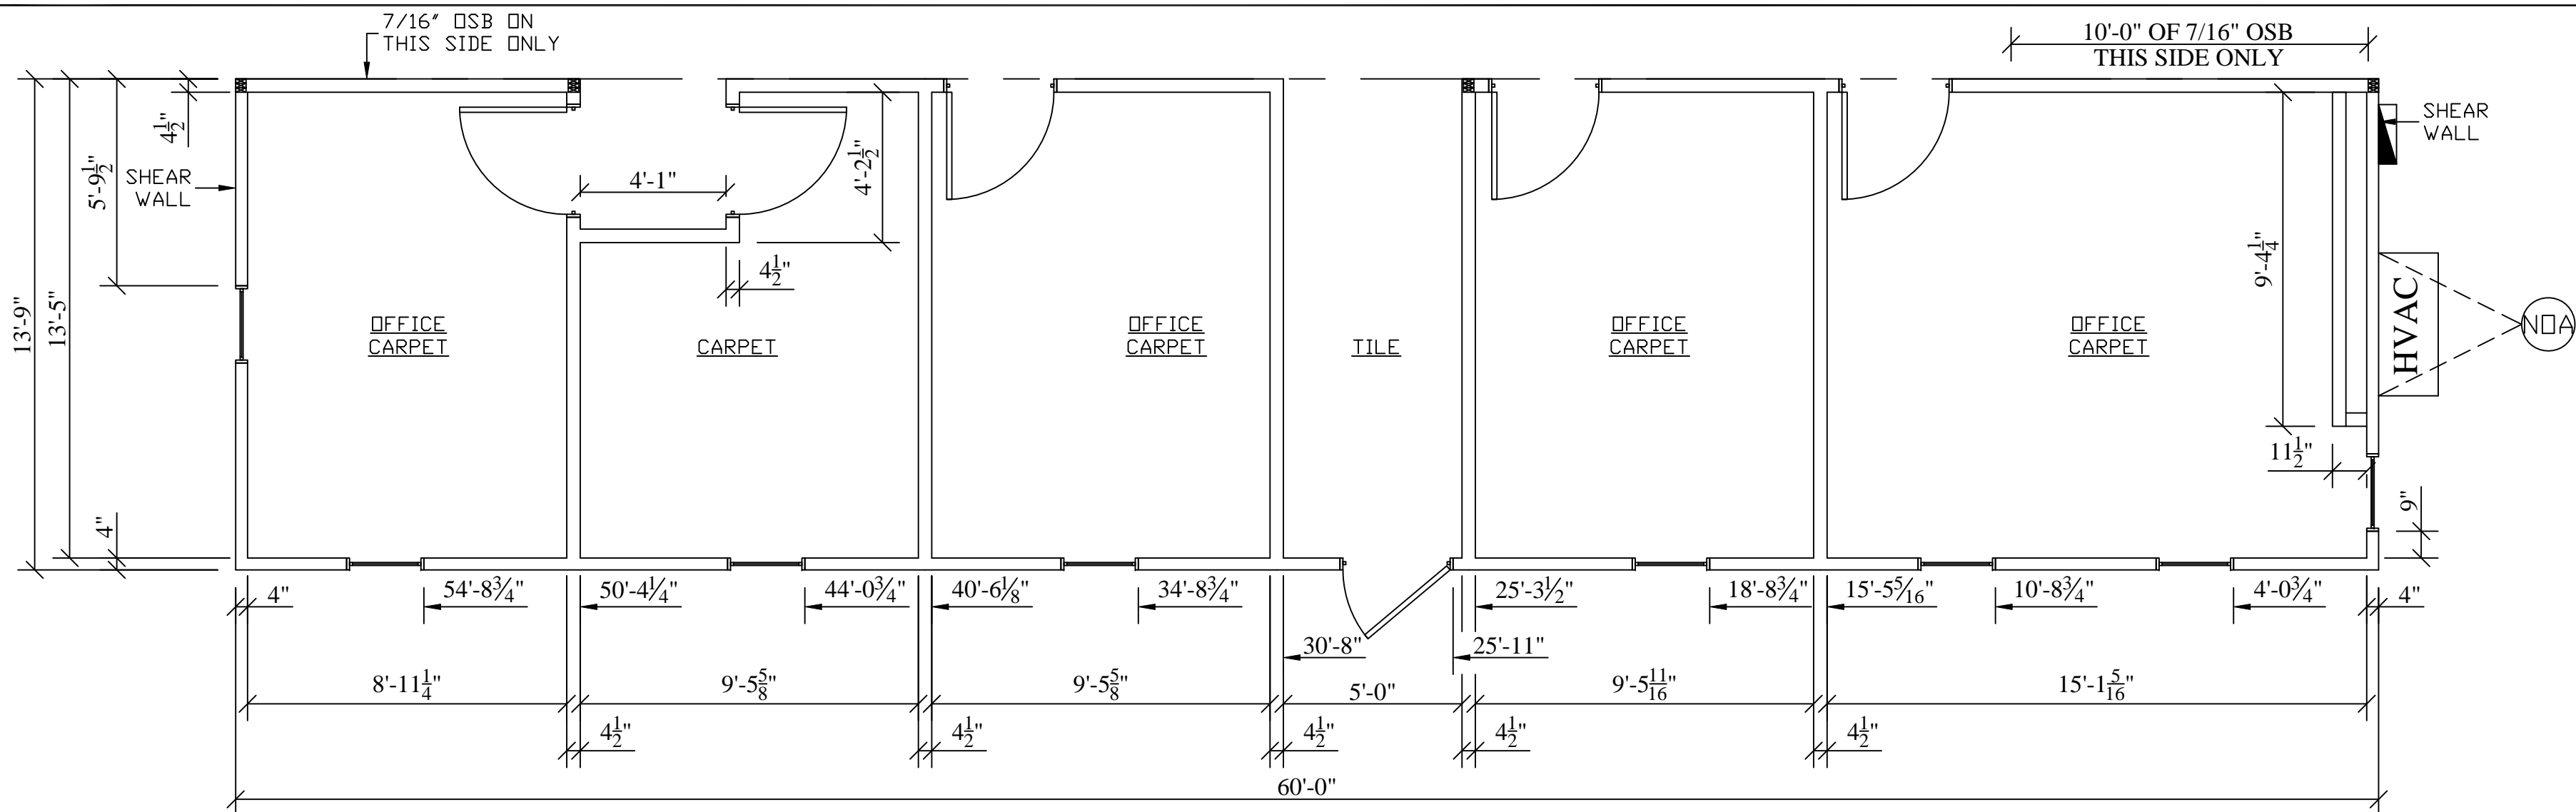
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SHEET:



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FLOOR PLAN - NOA
1/4" = 1'-0"

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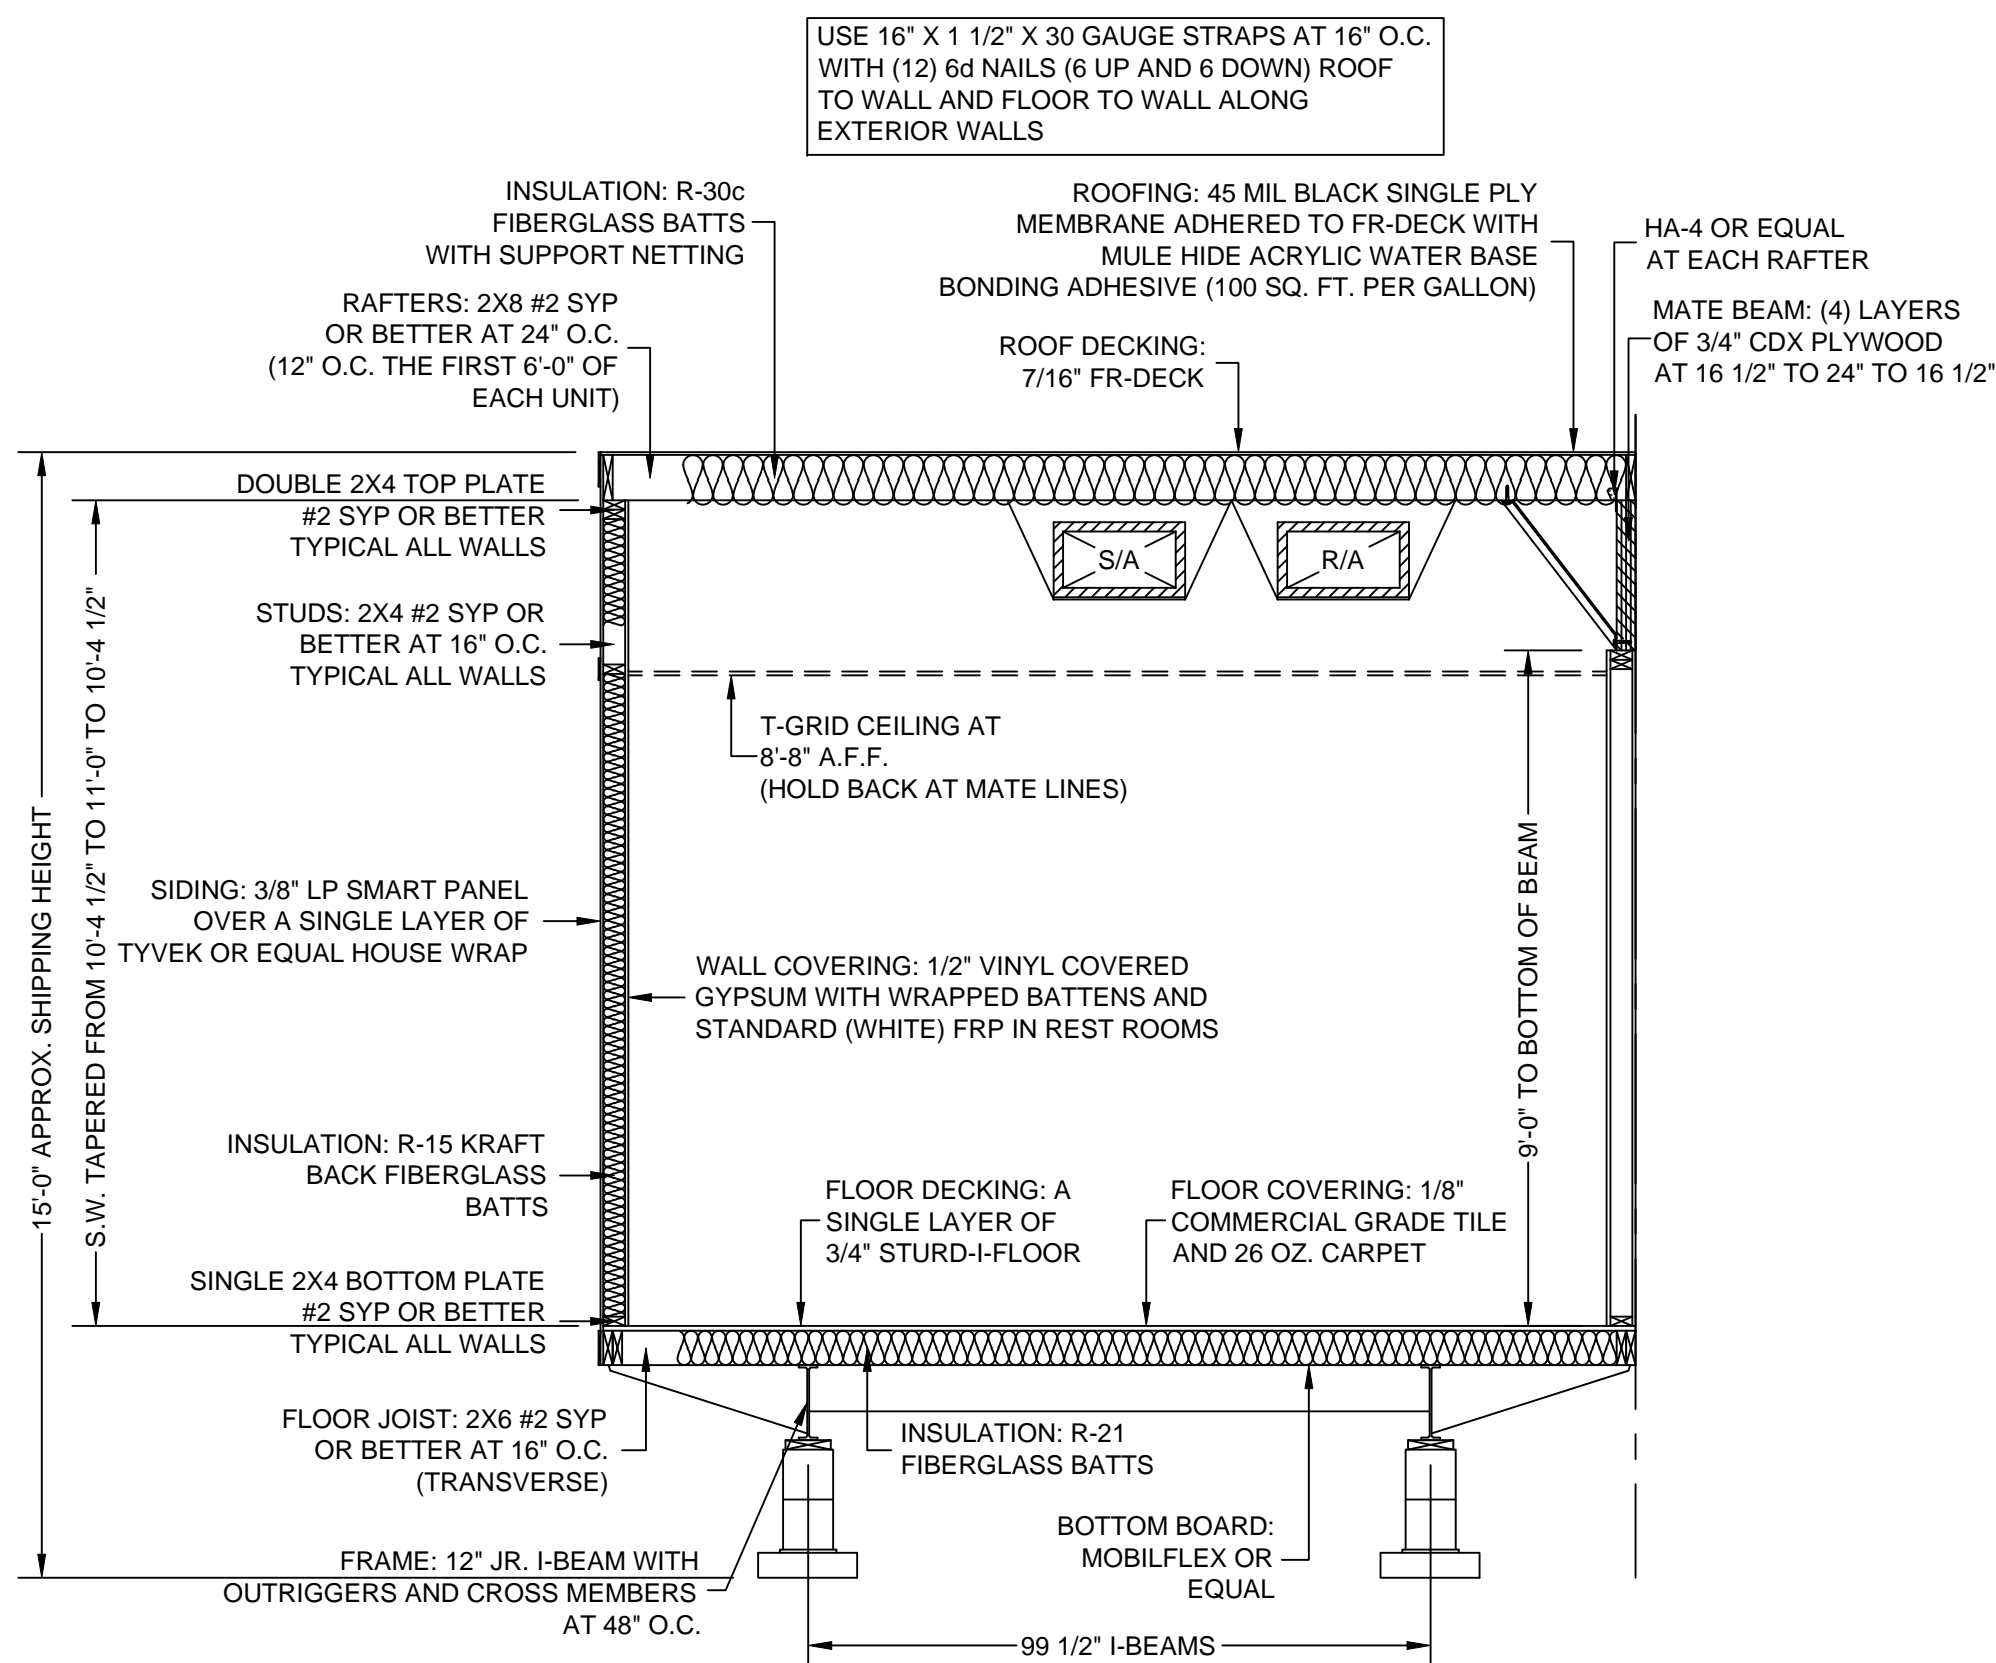
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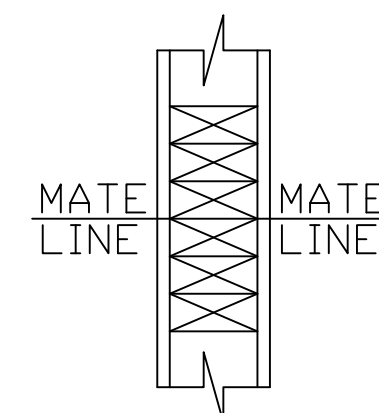
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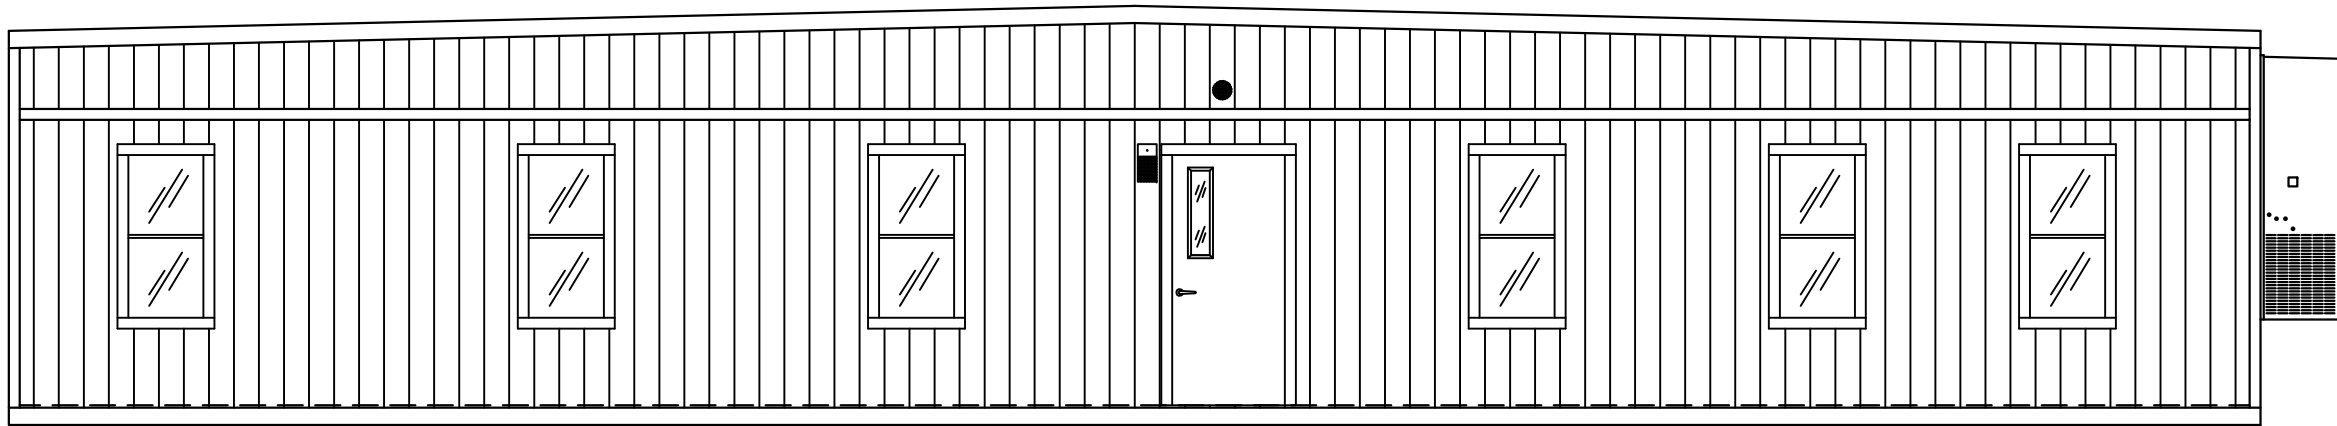
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3/8" = 1'-0"

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VENTING TO BE PROVIDED AND SITE INSTALLED BY OTHERS IN ACCORDANCE WITH THE
2006 IBC SECTIONS 1209.1 AND 1203.3.1 RESPECTIVELY.




THREE (3) STUD COLUMN: (3) 2X4 #2 SYP
STUDS ATTACHED TO BEAM AND FLOOR WITH
(2) 1 1/4" X 12" X 18 GAUGE STRAPS WITH
(7) #8 SCREWS AT EACH END


COLUMN DETAIL IN WALLS
1 1/2" = 1'-0"




FRONT ELEVATION
1/8" = 1'-0"

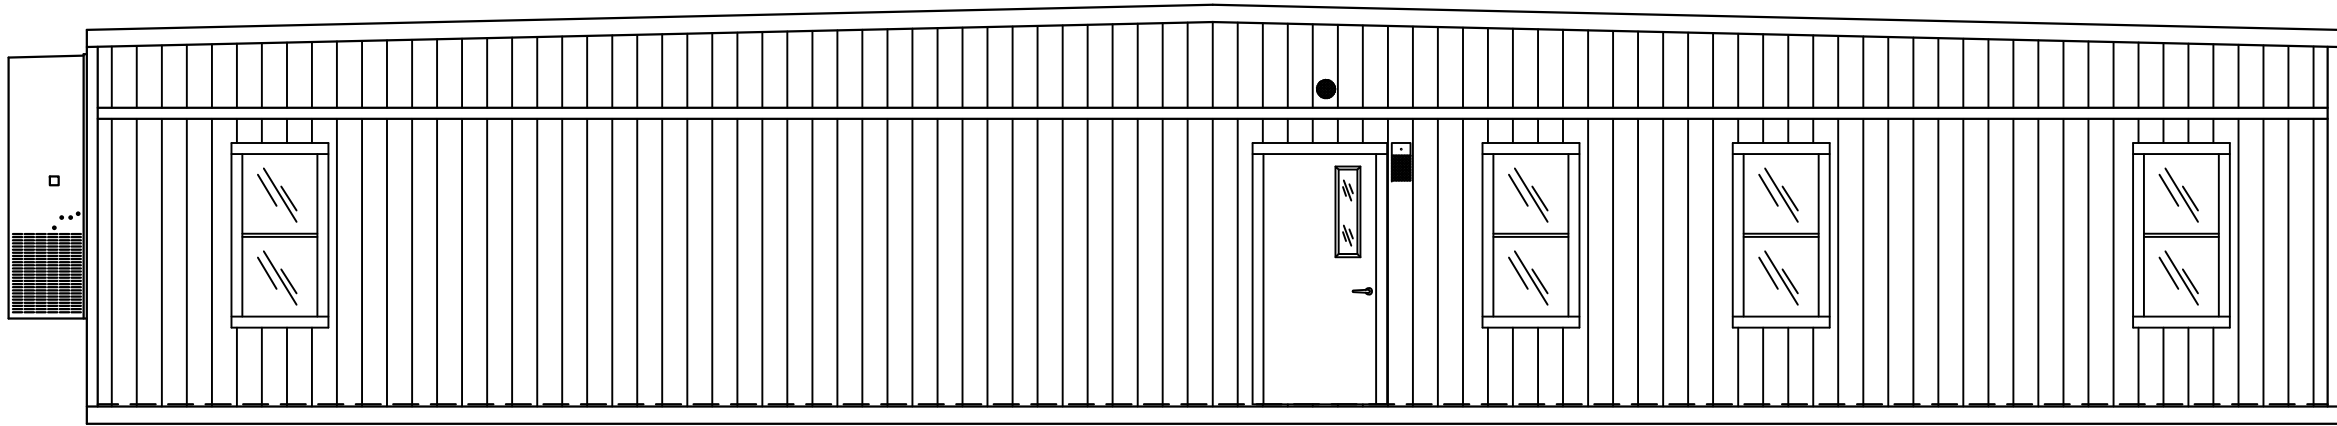


BACK SIDE ELEVATION
1/8" = 1'-0"

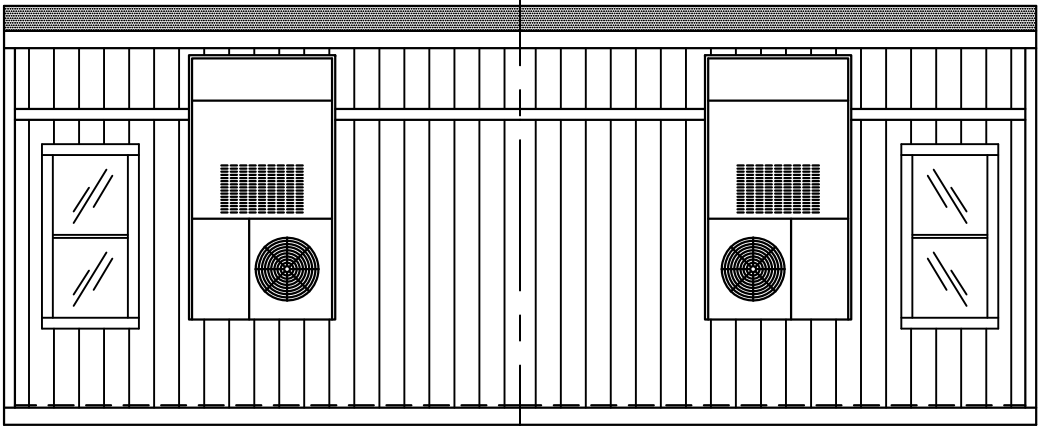


DOUBLE WIDE HITCH END ELEVATION
1/8" = 1'-0"

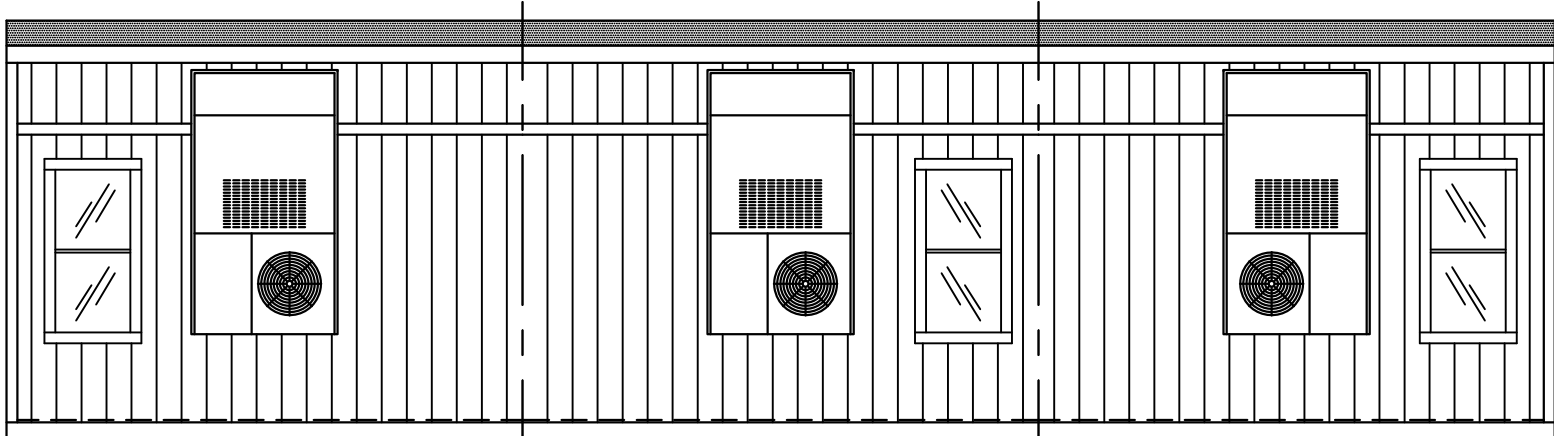

TRIPLE WIDE HITCH END ELEVATION
1/8" = 1'-0"

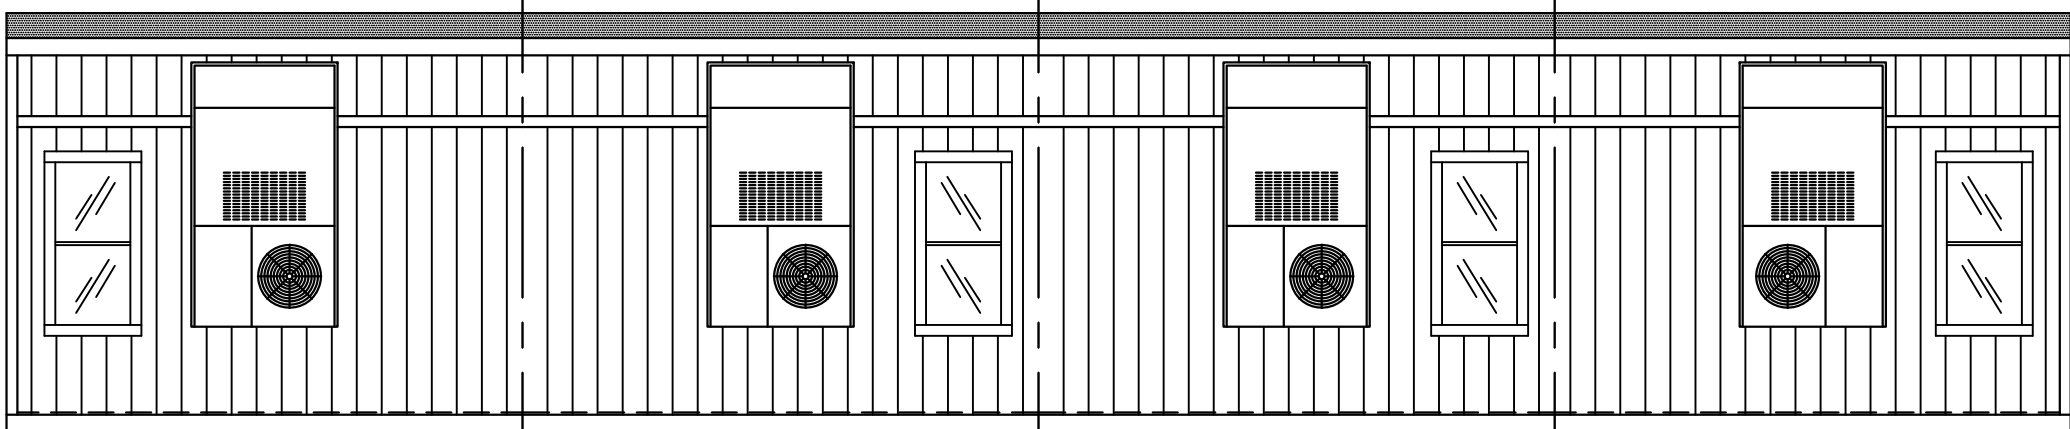

4-UNIT HITCH END ELEVATION
1/8" = 1'-0"

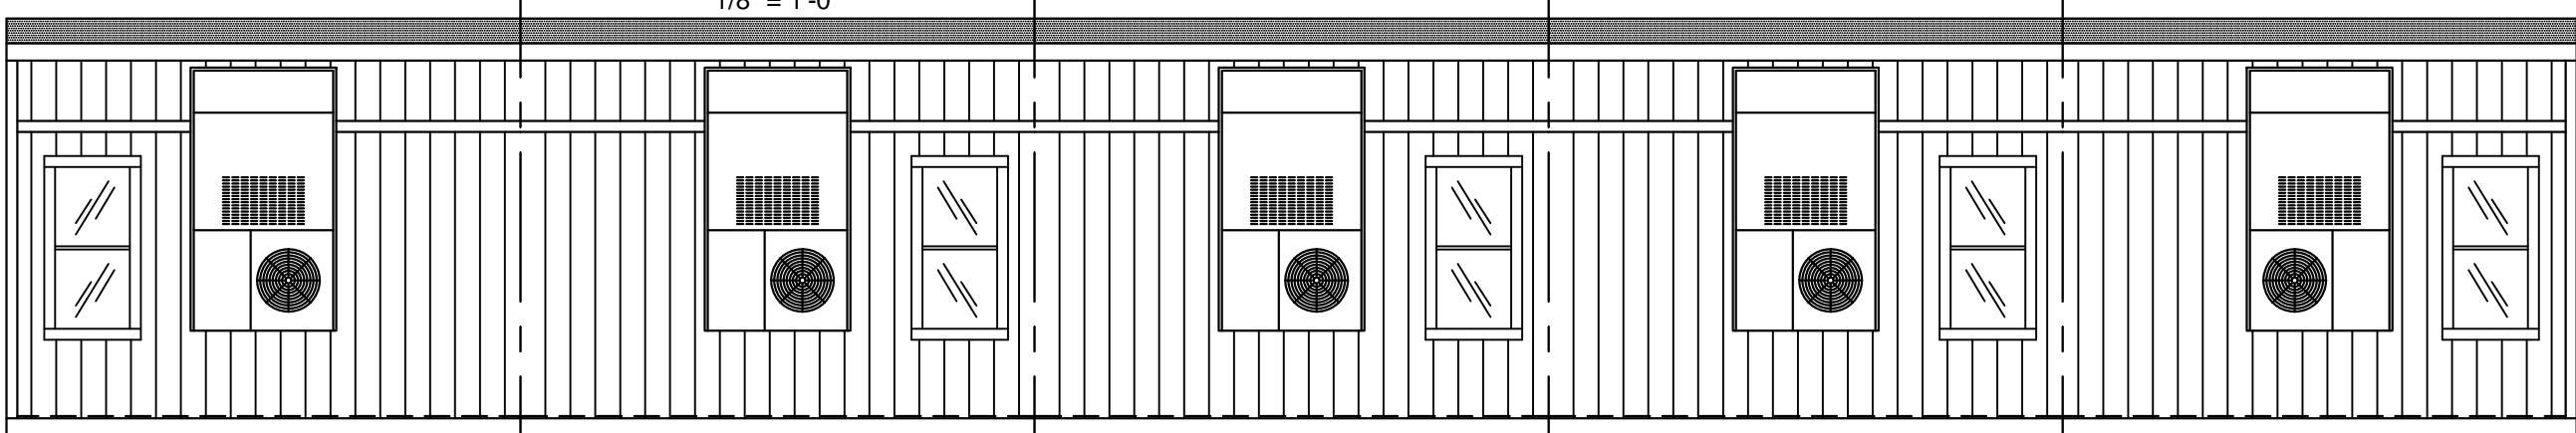

5-UNIT HITCH END ELEVATION
1/8" = 1'-0"

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721 N. BURLESON BLVD - BURLESON, TX 76028
817-447-1213 FAX 817-447-2751

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DEALER: NORTEX MODULAR
DFW
PROJECT: 14 X 64 (60)
NORPLEX "VO" SERIES
PROJECT NUMBER:
PROJECT - NTX - VO

SCALE: AS NOTED

PLOT DATE:
11/11/2008

SALESMAN: RP


DRAWN BY: MJM

STATES:
TX

SERIAL NUMBERS:
XXX


REVISIONS:

SHEET:

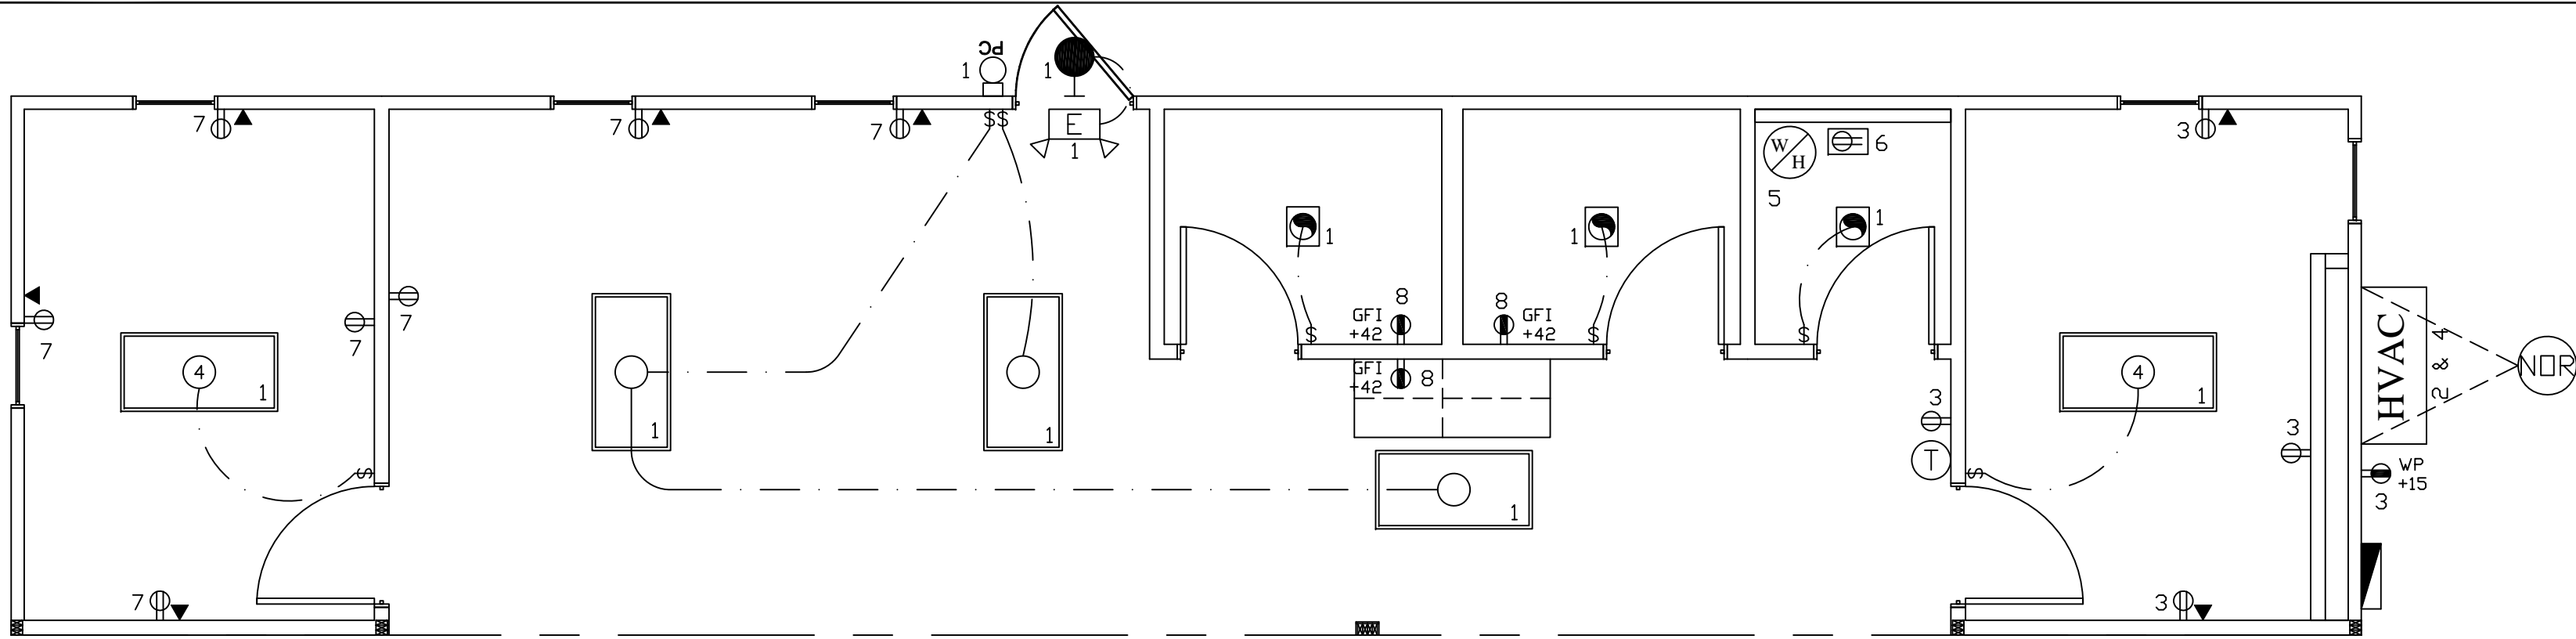


ELECTRICAL PLAN

1/4" = 1'-0"

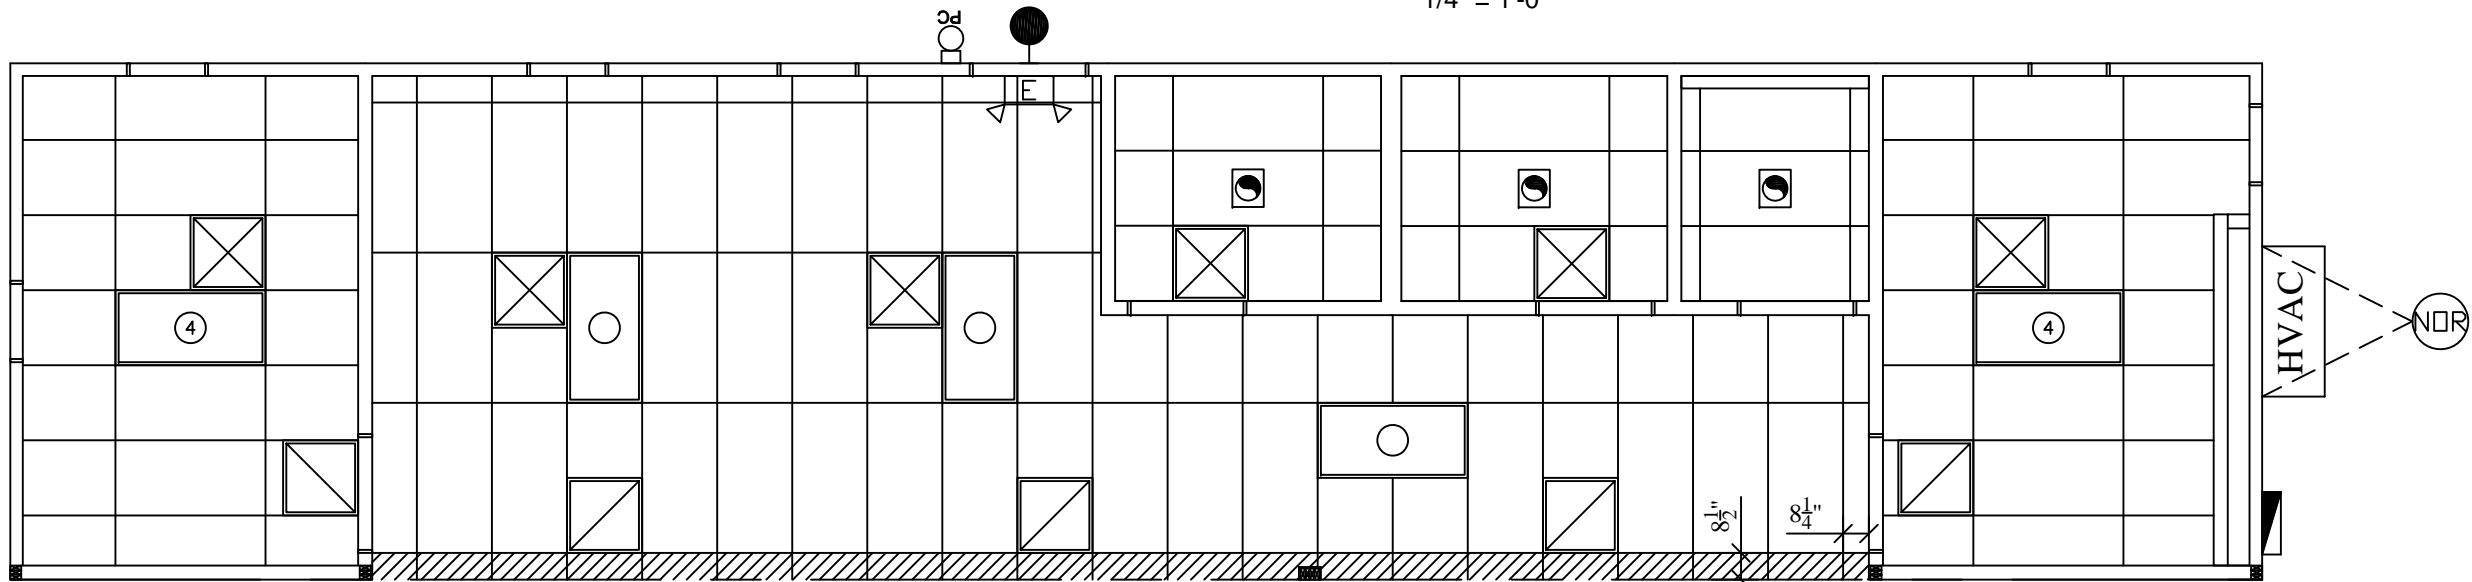


REFLECTED CEILING PLAN

3/16" = 1'-0"

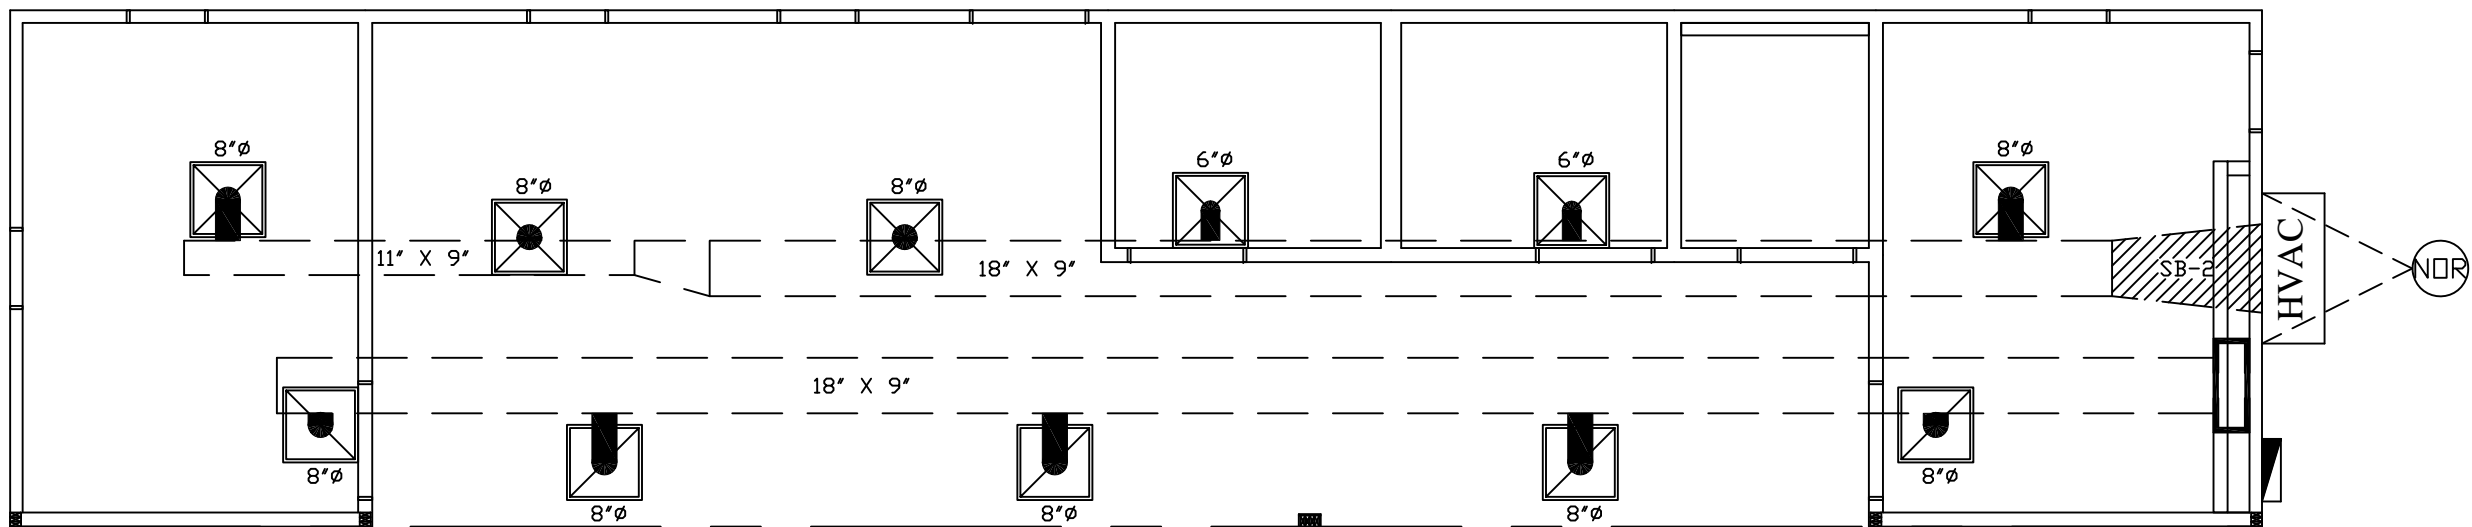


HVAC PLAN


3/16" = 1'-0"

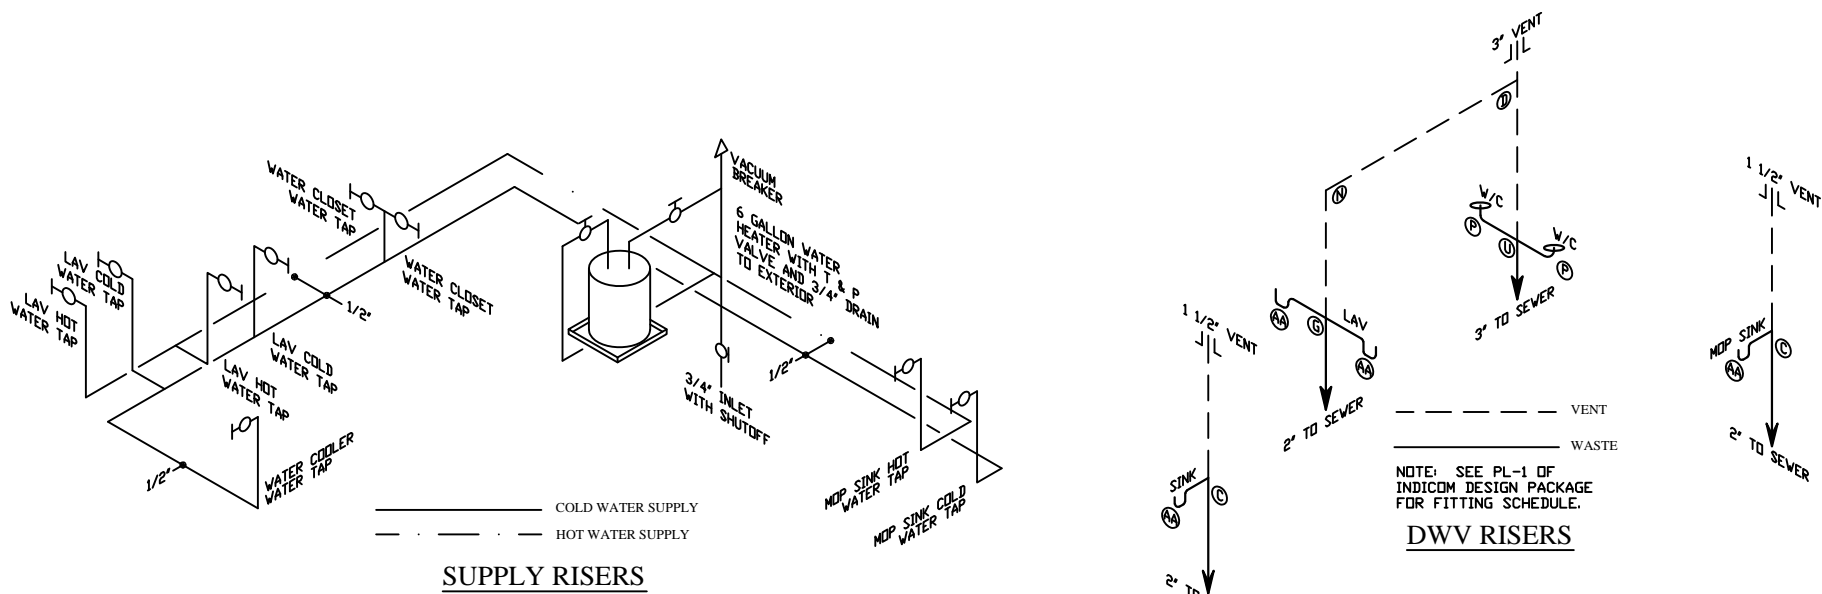

SUPPLY RISERS

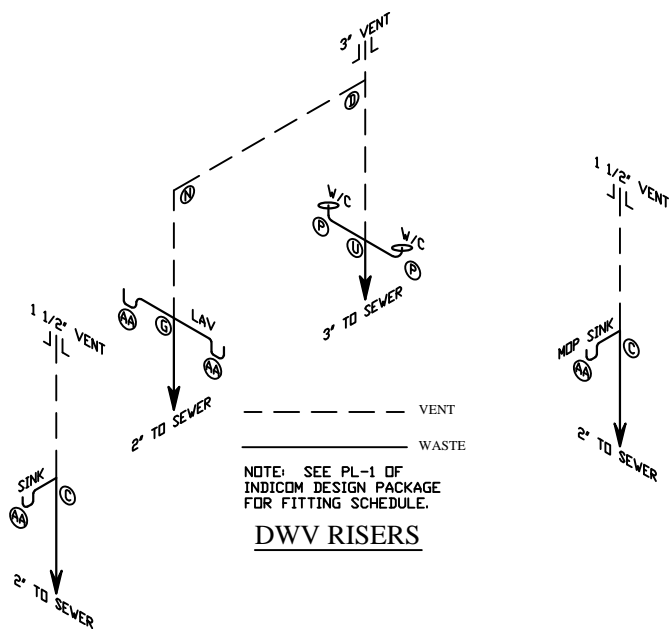

DWV RISERS

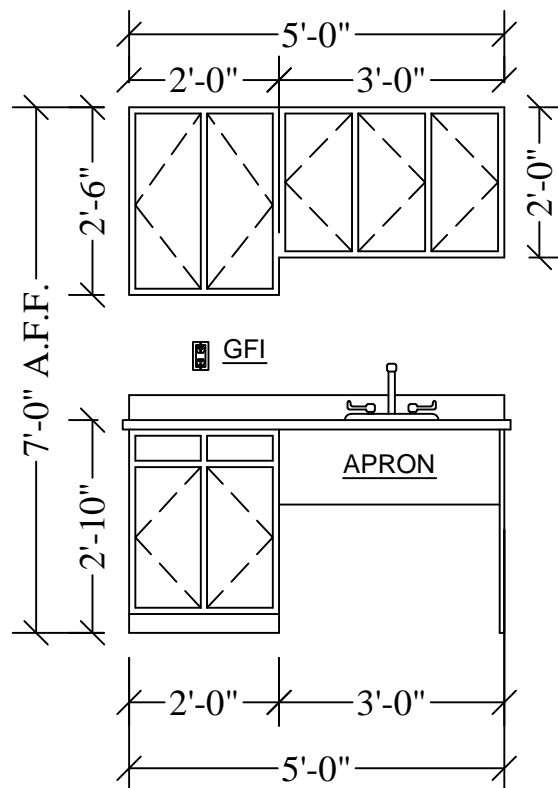

NOTE: FINAL DESIGN BY CABINETMAKER AND SUBJECT TO CHANGE



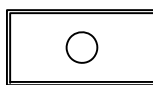








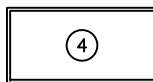


CABINET DETAILS

3/8" = 1'-0"

NOTE:
MAIN ELECTRICAL PANEL TO BE PROVIDED BY OTHERS AND SITE INSTALLED. PANEL TO SIZED AS SPEC'D BY CODE BASED ON LOADS SHOWN ON THIS SHEET, "FEEDERS" TO SUB-PANELS ALSO TO BE PROVIDED BY OTHERS AND SIZED IN ACCORD. WITH THE NEC BASED ON LOADS SHOWN.

*FINAL GROUNDING TO BE COMPLETED BY OTHERS ON SITE IN ACCORDANCES WITH THE NEC.

*MINIMUM WIRE SIZE - #12 THHN.
*MINIMUM BREAKER SIZE - 20A

ELECTRICAL LEGEND			
	4-TUBE DIFFUSED FLUORESCENT RECESSED LAY-IN (T-8 LAMPS AND ELECTRONIC BALLAST)		20A/125V DUPLEX RECEPTACLE MOUNTED AT 15' A.F.F.
	3-TUBE DIFFUSED FLUORESCENT RECESSED LAY-IN (T-8 LAMPS AND ELECTRONIC BALLAST)		20A/125V WEATHERPROOF RECEPTACLE WITH IN-USE COVER MOUNTED AT 15' A.F.F.
			20A/125V GFI RECEPTACLE MOUNTED AT 42" A.F.F.
	FLUORESCENT EXTERIOR PORCH LIGHT WITH PHOTOCELL		20A/125V HEAT TAPE RECEPTACLE MOUNTED UNDER THE FLOOR
	COMBO DUAL EMERGENCY LIGHT/EXIT SIGN WITH BATTERY BACKUP		2X4 J-BOX WITH 3/4" EMT CONDUIT STUBBED OUT ABOVE CEILING. J-BOX MOUNTED AT 15" A.F.F.
	EXTERIOR REMOTE HEAD EMERGENCY LIGHT (CENTER LIGHT ABOVE DOOR)		PROGRAMMABLE THERMOSTAT THERMOSTAT MOUNTED AT 48" A.F.F.
	100 CFM CEILING MOUNTED LIGHT/EXHAUST FAN COMBO	<div>HVAC</div>	3-TON HVAC WITH 10KW ELECTRIC HEAT STRIP
	20A/120V SINGLE POLE SWITCH MOUNTED AT 48" A.F.F.		100A (NEMA 3R) SINGLE PHASE PANEL BOX WITH MAIN BREAKER

100 AMP 120/240 1 PHASE EXTERIOR SURFACE MOUNT PANEL W/ 100 AMP MAIN BRKR									
DESCRIPTION	CIR	BRK	WS	A	B	WS	BRK	CIR	DESCRIPTION
LIGHTS	1	20	#12	854		#6	60		HVAC UNIT
				5444					
RECEPTACLES	3	20	#12		900	#6	2		
				5444				4	
WATER HEATER	5	25	#10	2000		#12	20		RECEPTACLE
				180					
RECEPTACLES	7	20	#12		1260	#XX	XX		RECEPTACLES
				540				8	
SPACE	9	XX	#XX	XXXX		#XX	XX		SPACE
				XXXX					
SPACE	11	XX	#XX			#XX	XX		SPACE
ELECTRICAL CALCULATIONS: PANEL "NOR"									
GENERAL LIGHTING:									
825 sq/ft x 3.5 x 1.25				=		3609.38			
(10,888) HVAC UNIT				=		10,888			
(2880) RECEPTACLES				=		2880			
(2000) WATER HEATER				=		2000			
19,377.38 ÷ 240v = 80.74 AMPS TOTAL									

MECHANICAL VENTILATION	
BUILDING SQUARE FOOTAGE	825 S.F.
OCCUPANCY LOAD	8
OUTSIDE AIR REQUIRED (20 cfm x 8)	160 CFM
TOTAL CFM AVAILABLE	1200 CFM
FRESH AIR MAKE-UP (160 / 1200)	13.3%
*MECHANICAL VENTILATION SHALL BE PROVIDED AS REQ'D. IN ACCORDANCE WITH TABLE 403.3 OF THE 2003 IMC OR NATURAL MEANS OF VENTILATION SHALL BE PROVIDED IN ACCORDANCE WITH SECTION 402 OF THE 2003 IMC.	


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INDUSTRIALIZED COMMERCIAL BUILDINGS
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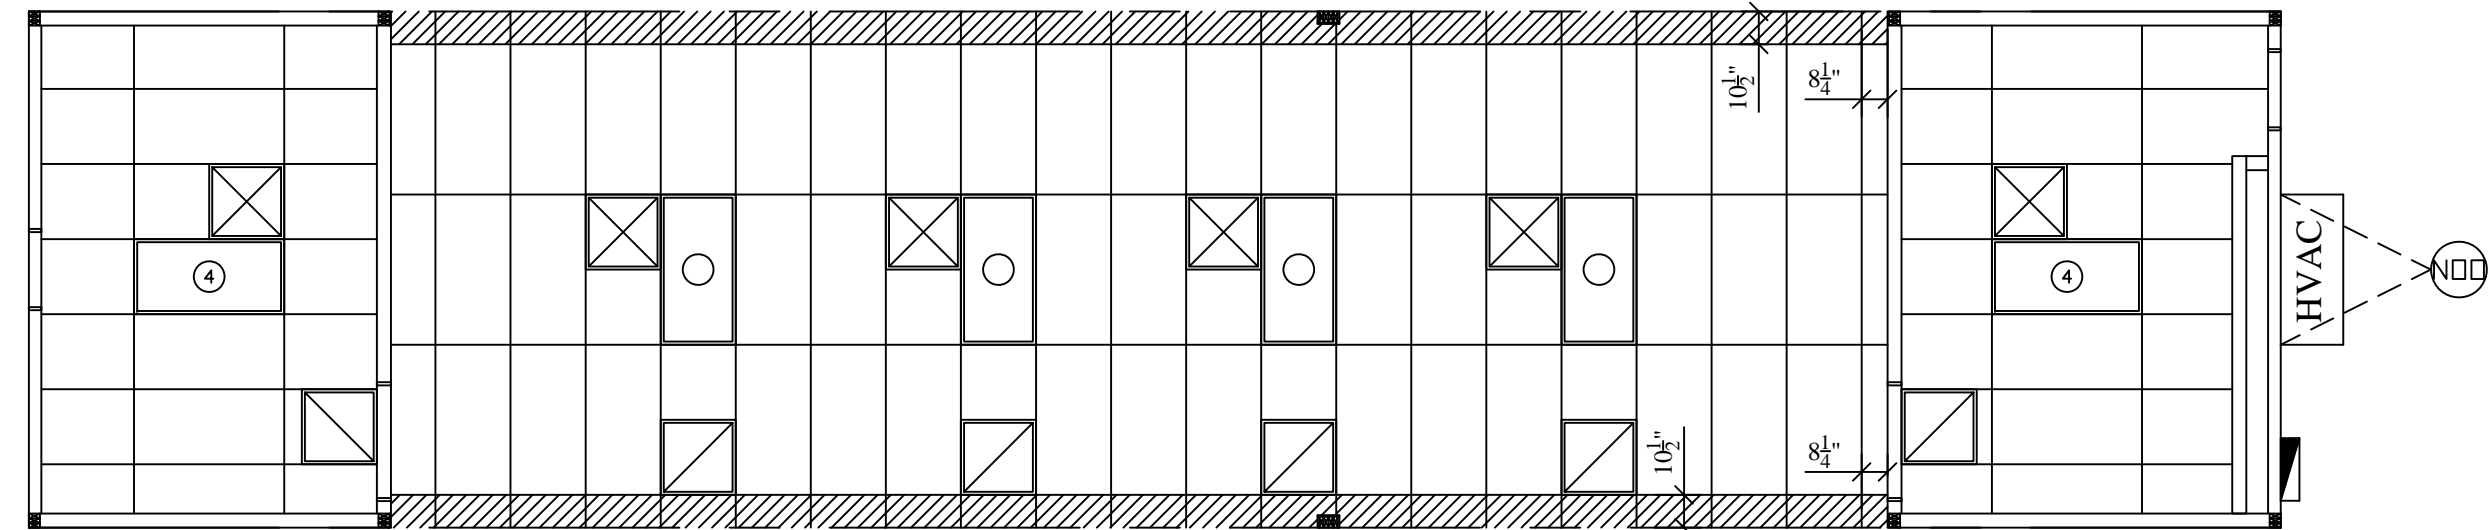
DEALER: NORTEX MODULAR DFW
PROJECT: 14 X 64 (60) NORPLEX "VO" SERIES
PROJECT NUMBER: PROJECT - NTX - VO

SCALE: AS NOTED
PLOT DATE: 11/11/2008
SALESMAN: RP
DRAWN BY: MJM
STATES: TX
SERIAL NUMBERS: XXX
REVISIONS:


SHEET: 7 OF 15



ELECTRICAL PLAN
1/4" = 1'-0"

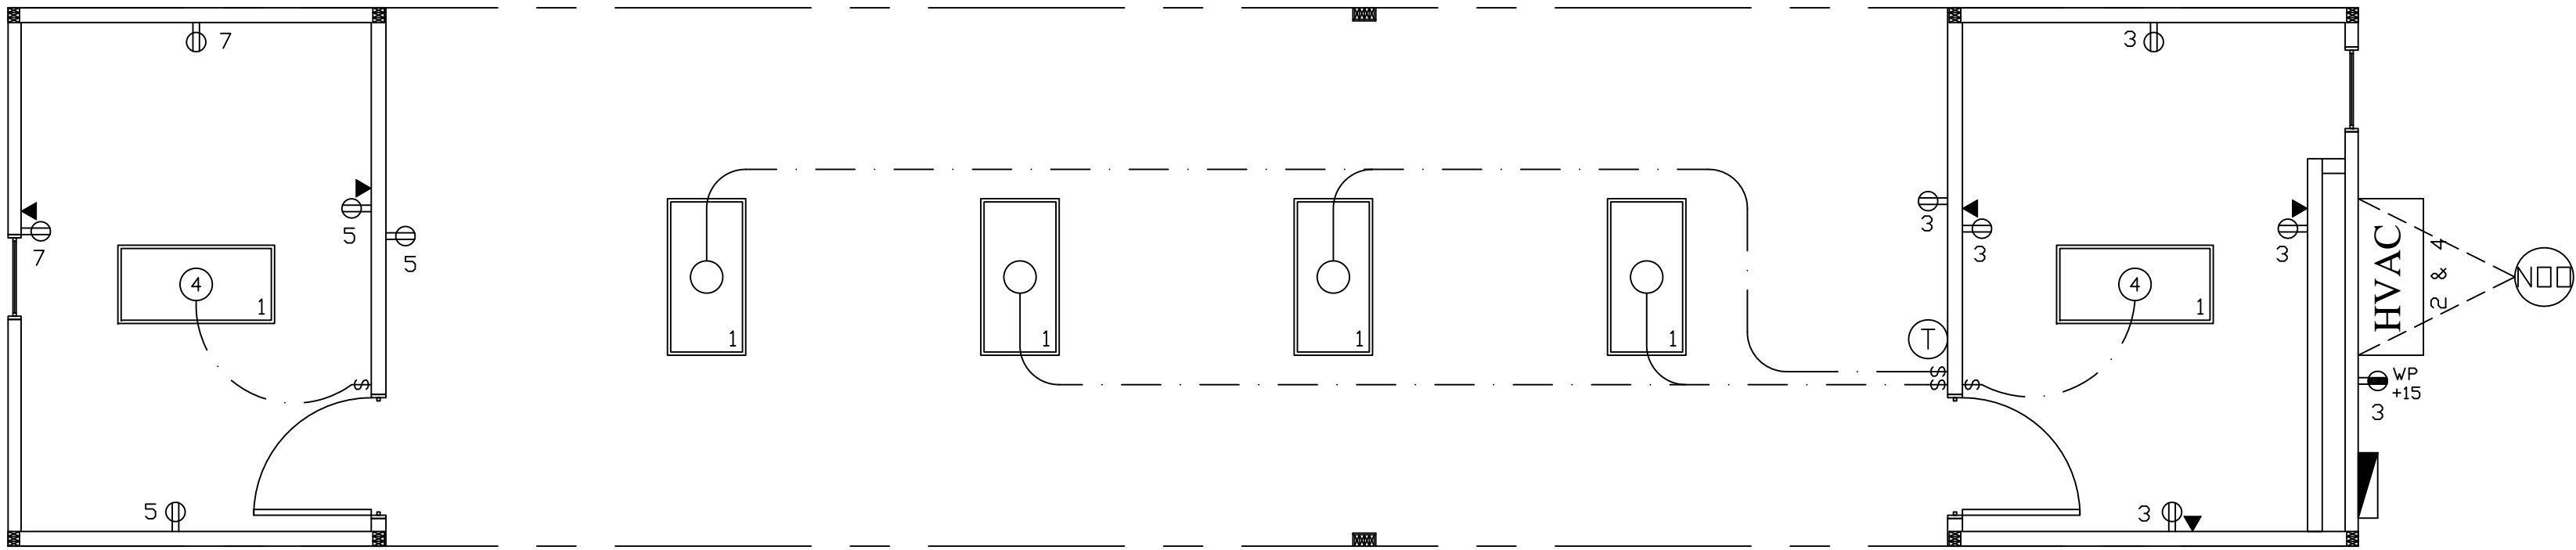

REFLECTED CEILING PLAN
3/16" = 1'-0"

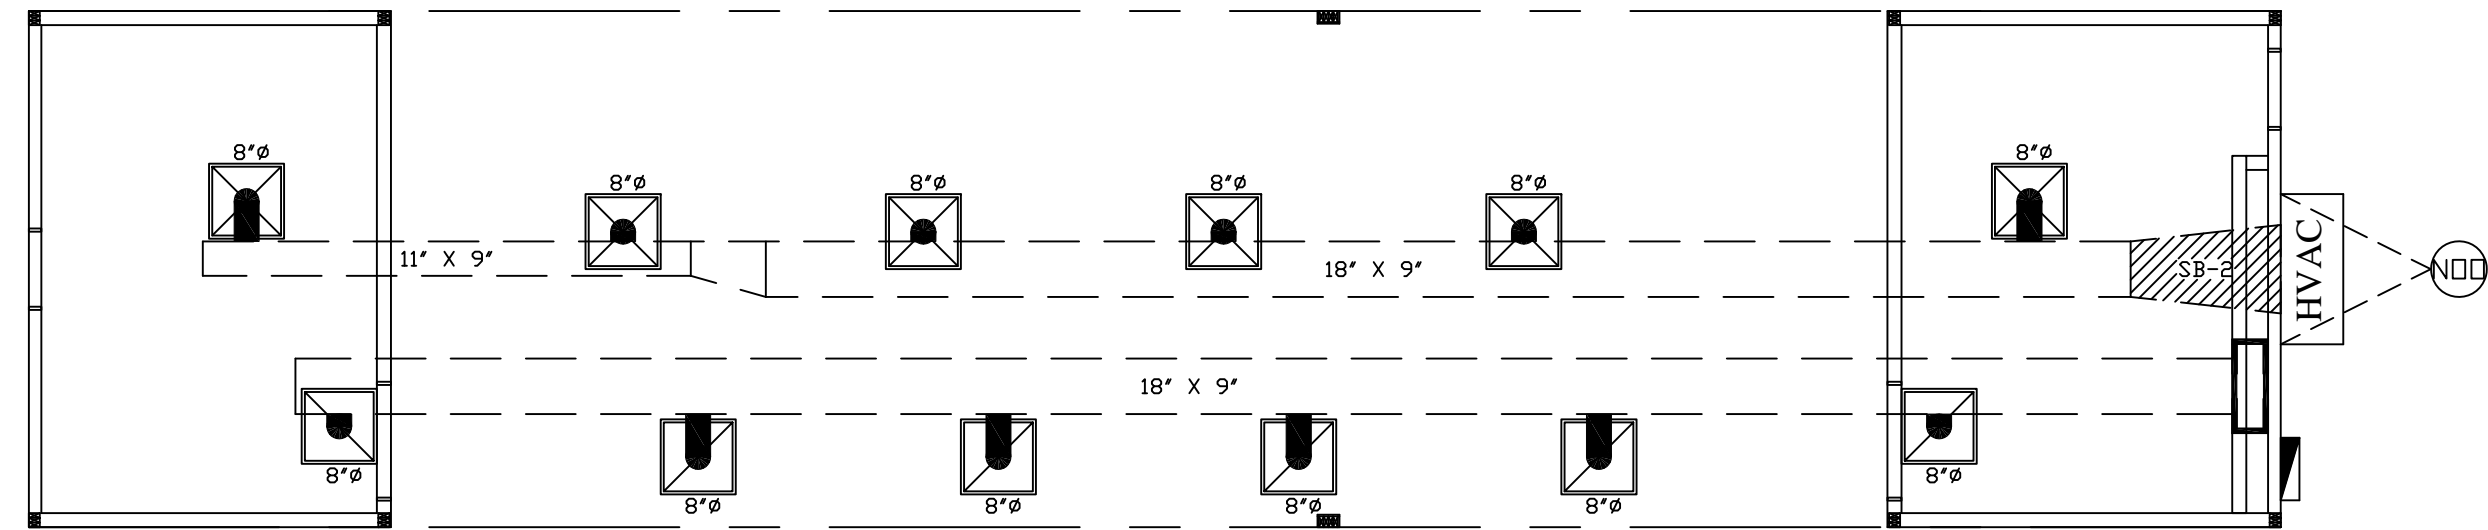








HVAC PLAN
3/16" = 1'-0"

NOTE:
MAIN ELECTRICAL PANEL TO BE PROVIDED
BY OTHERS AND SITE INSTALLED. PANEL TO
SIZED AS SPEC'D BY CODE BASED ON LOADS
SHOWN ON THIS SHEET, "FEEDERS" TO
SUB-PANELS ALSO TO BE PROVIDED BY
OTHERS AND SIZED IN ACCORD. WITH THE NEC
BASED ON LOADS SHOWN.

*FINAL GROUNDING TO BE COMPLETED BY
OTHERS ON SITE IN ACCORDANCES WITH
THE NEC.

*MINIMUM WIRE SIZE - #12 THHN.
*MINIMUM BREAKER SIZE - 20A

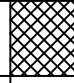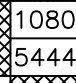ELECTRICAL LEGEND			
	4-TUBE DIFFUSED FLUORESCENT RECESSED LAY-IN (T-8 LAMPS AND ELECTRONIC BALLAST)		20A/125V DUPLEX RECEPTACLE MOUNTED AT 15' A.F.F.
	3-TUBE DIFFUSED FLUORESCENT RECESSED LAY-IN (T-8 LAMPS AND ELECTRONIC BALLAST)		20A/125V WEATHERPROOF RECEPTACLE WITH IN-USE COVER MOUNTED AT 15' A.F.F.
			20A/125V GFI RECEPTACLE MOUNTED AT 42' A.F.F.
	FLUORESCENT EXTERIOR PORCH LIGHT WITH PHOTOCCELL		20A/125V HEAT TAPE RECEPTACLE MOUNTED UNDER THE FLOOR
	COMBO DUAL EMERGENCY LIGHT/EXIT SIGN WITH BATTERY BACKUP		2X4 J-BOX WITH 3/4" EMT CONDUIT STUBBED OUT ABOVE CEILING. J-BOX MOUNTED AT 15' A.F.F.
	EXTERIOR REMOTE HEAD EMERGENCY LIGHT (CENTER LIGHT ABOVE DOOR)		PROGRAMMABLE THERMOSTAT . THERMOSTAT MOUNTED AT 48" A.F.F.
	100 CFM CEILING MOUNTED LIGHT/EXHAUST FAN COMBO		3-TON HVAC WITH 10KW ELECTRIC HEAT STRIP
	20A/120V SINGLE POLE SWITCH MOUNTED AT 48' A.F.F.		100A (NEMA 3R) SINGLE PHASE PANEL BOX WITH MAIN BREAKER

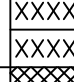100 AMP 120/240 1 PHASE EXTERIOR SURFACE MOUNT PANEL W/ 100 AMP MAIN BRKR									
DESCRIPTION	CIR	BRK	WS	A	B	WS	BRK	CIR	DESCRIPTION
LIGHTS	1	20	#12	724 5444		#6	60	2	 HVAC UNIT
RECEPTACLES	3	20	#12		1080 5444	#6	2	4	
RECEPTACLES	5	20	#12	540 XXXX		#XX	XX	6	SPACE
RECEPTACLES	7	20	#12		360 XXXX	#XX	XX	8	SPACE
SPACE	9	XX	#XX	XXXX XXXX		#XX	XX	10	SPACE
SPACE	11	XX	#XX			#XX	XX	12	SPACE
ELECTRICAL CALCULATIONS: PANEL "N00"									
GENERAL LIGHTING:									
825 sq/ft x 3.5 x 1.25				=	3609.38				
(10,888) HVAC UNIT				=	10,888				
(1980) RECEPTACLES				=	1980				
<hr/>									
16,477.38 ÷ 240v = 68.66 AMPS TOTAL									

MECHANICAL VENTILATION

BUILDING SQUARE FOOTAGE	825 S.F.
OCCUPANCY LOAD	8
OUTSIDE AIR REQUIRED (20 cfm x 8)	160 CFM
TOTAL CFM AVAILABLE	1200 CFM
FRESH AIR MAKE-UP (160 / 1200)	13.3%

*MECHANICAL VENTILATION SHALL BE PROVIDED AS REQ'D. IN ACCORDANCE WITH TABLE 403.3 OF THE 2003 IMC OR NATURAL MEANS OF VENTILATION SHALL BE PROVIDED IN ACCORDANCE WITH SECTION 402 OF THE 2003 IMC.

INDICOM BUILDINGS, INC.
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DEALER: NORTEX MODULAR

DFW

PROJECT: 14 X 64 (60)

NORPLEX "VO" SERIES

PROJECT NUMBER:

PROJECT - NTX - VO

SCALE: AS NOTED

PLOT DATE:
11/11/2008

SALESMAN: RP


DRAWN BY: MJM

STATES:
TX

SERIAL NUMBERS:
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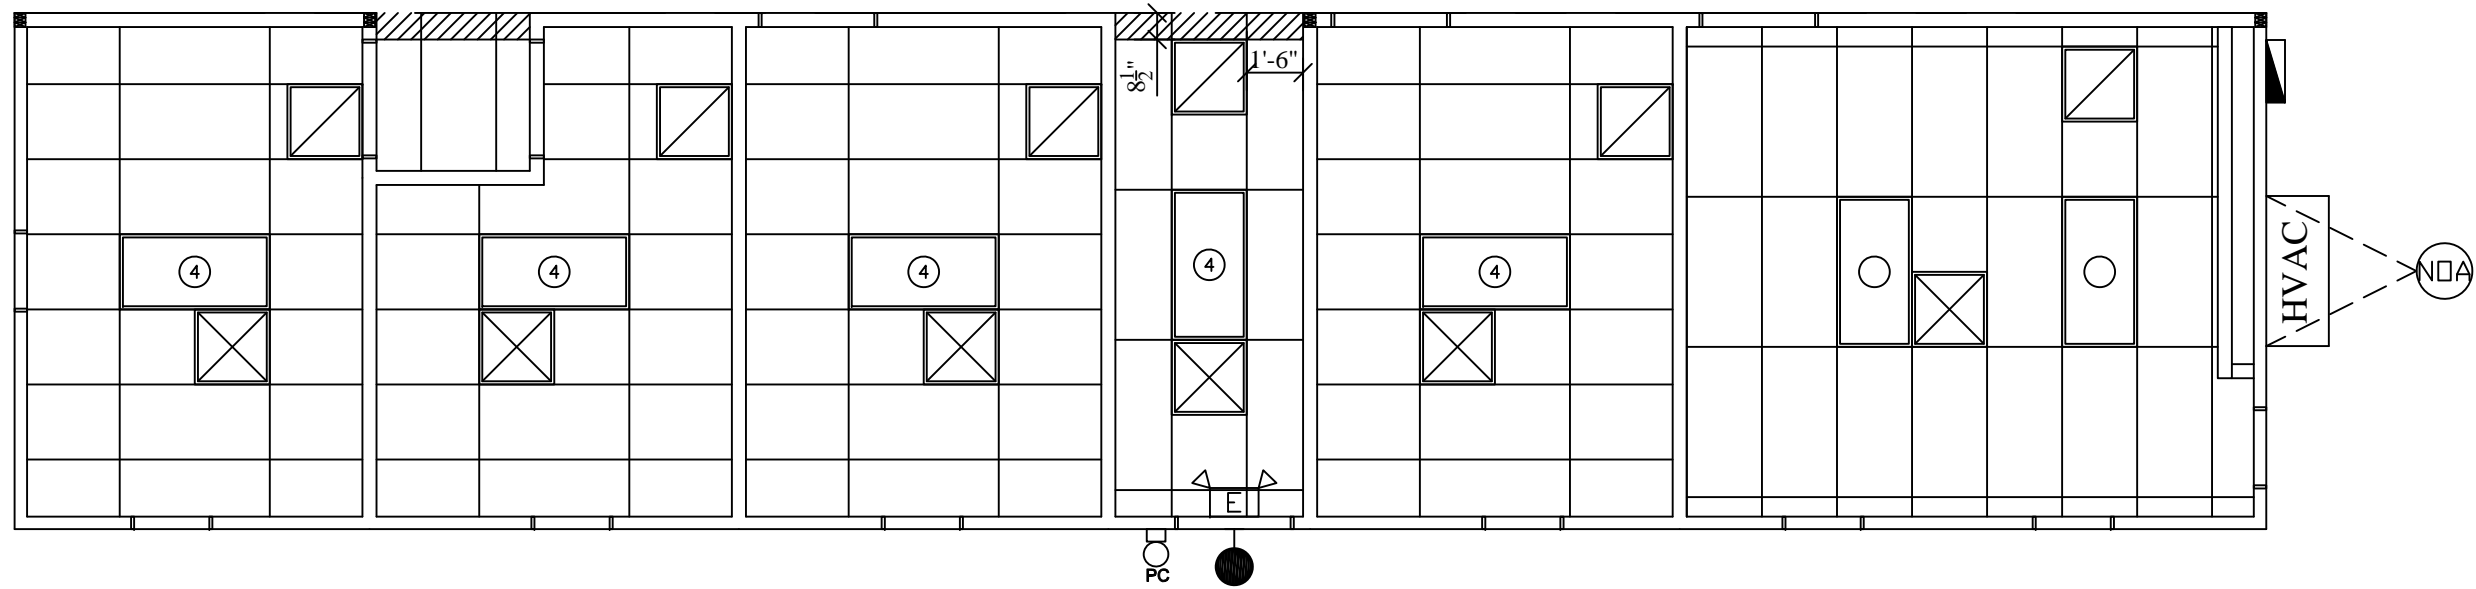
REVISIONS:

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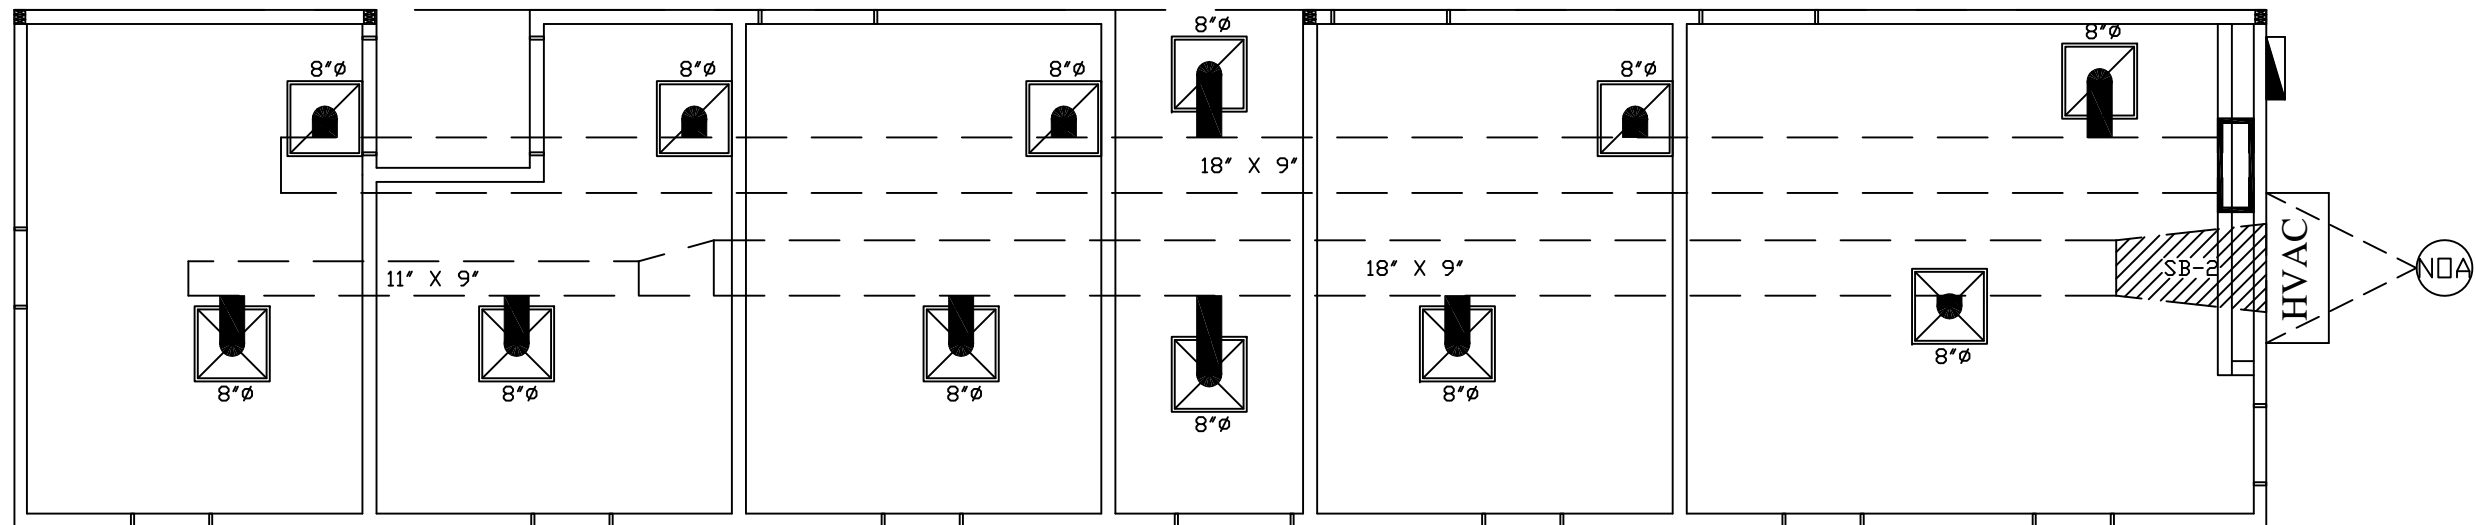
ELECTRICAL PLAN

1/4" = 1'-0"

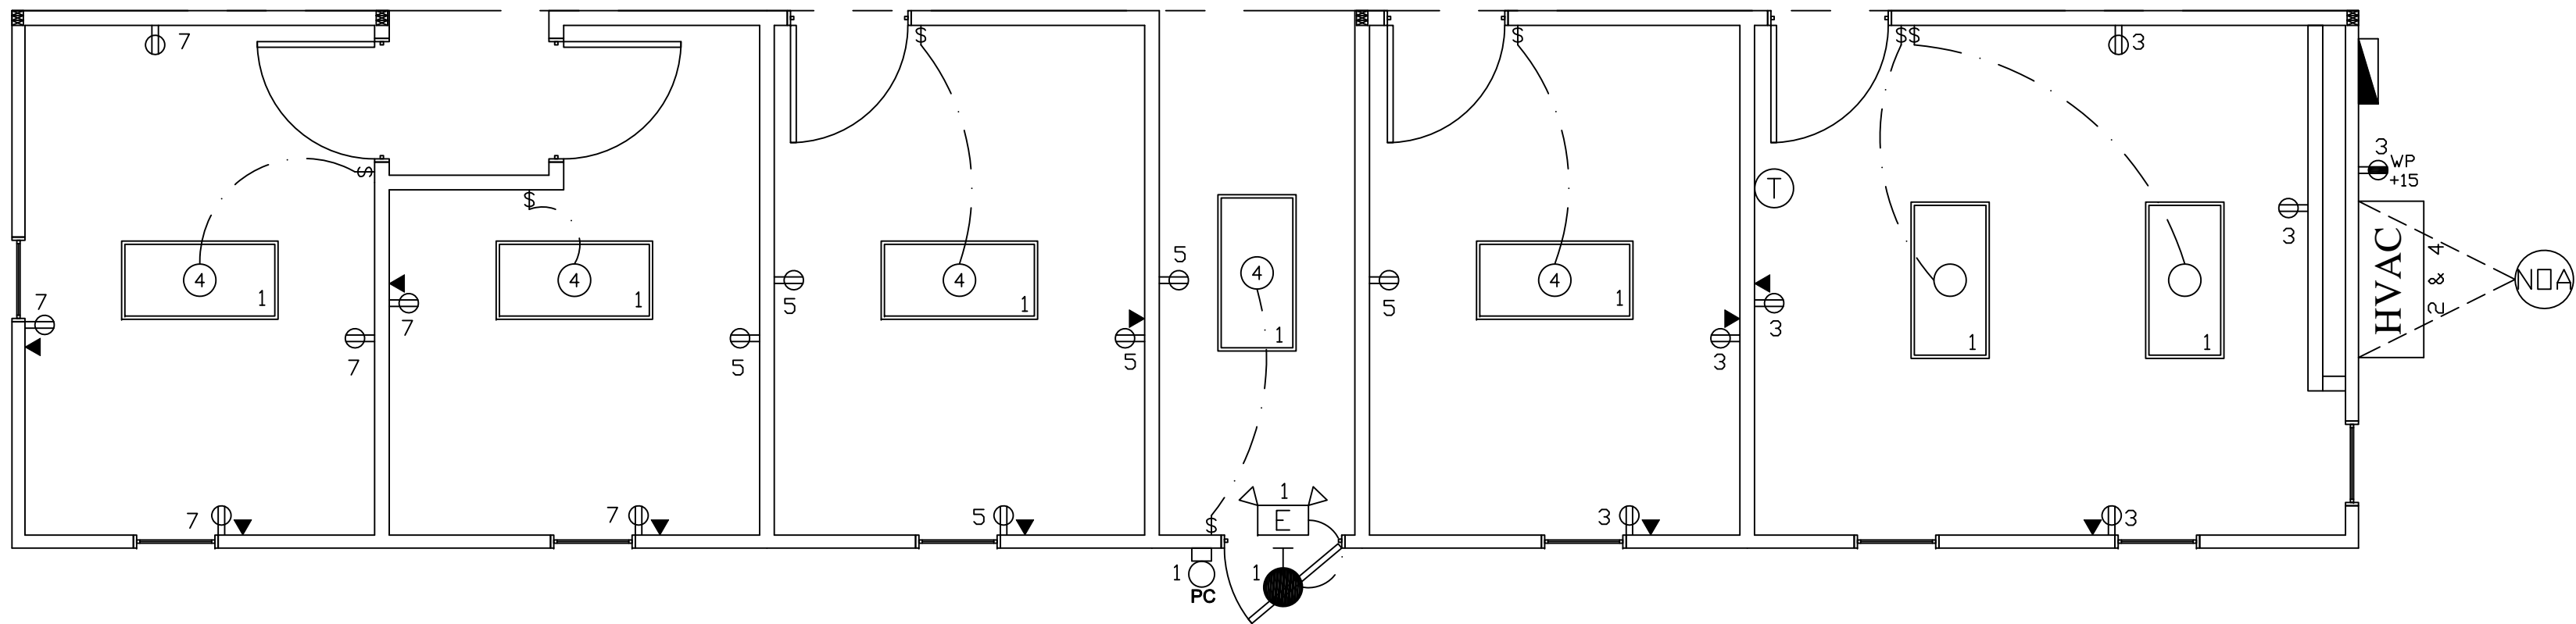

REFLECTED CEILING PLAN

3/16" = 1'-0"



HVAC PLAN

3/16" = 1'-0"

NOTE:
MAIN ELECTRICAL PANEL TO BE PROVIDED BY OTHERS AND SITE INSTALLED. PANEL TO SIZED AS SPEC'D BY CODE BASED ON LOADS SHOWN ON THIS SHEET, "FEEDERS" TO SUB-PANELS ALSO TO BE PROVIDED BY OTHERS AND SIZED IN ACCORD. WITH THE NEC BASED ON LOADS SHOWN.

*FINAL GROUNDING TO BE COMPLETED BY OTHERS ON SITE IN ACCORDANCES WITH THE NEC.

*MINIMUM WIRE SIZE - #12 THHN.
*MINIMUM BREAKER SIZE - 20A

ELECTRICAL LEGEND			
	4-TUBE DIFFUSED FLUORESCENT RECESSED LAY-IN (T-8 LAMPS AND ELECTRONIC BALLAST)		20A/125V DUPLEX RECEPTACLE MOUNTED AT 15' A.F.F.
	3-TUBE DIFFUSED FLUORESCENT RECESSED LAY-IN (T-8 LAMPS AND ELECTRONIC BALLAST)		20A/125V WEATHERPROOF RECEPTACLE WITH IN-USE COVER MOUNTED AT 15' A.F.F.
			20A/125V GFI RECEPTACLE MOUNTED AT 42' A.F.F.
	FLUORESCENT EXTERIOR PORCH LIGHT WITH PHOTOCCELL		20A/125V HEAT TAPE RECEPTACLE MOUNTED UNDER THE FLOOR
	COMBO DUAL EMERGENCY LIGHT/EXIT SIGN WITH BATTERY BACKUP		2X4 J-BOX WITH 3/4" EMT CONDUIT STUBBED OUT ABOVE CEILING, J-BOX MOUNTED AT 15' A.F.F.
	EXTERIOR REMOTE HEAD EMERGENCY LIGHT (CENTER LIGHT ABOVE DOOR)		PROGRAMMABLE THERMOSTAT THERMOSTAT MOUNTED AT 48" A.F.F.
	100 CFM CEILING MOUNTED LIGHT/EXHAUST FAN COMBO		3-TON HVAC WITH 10KW ELECTRIC HEAT STRIP
	20A/120V SINGLE POLE SWITCH MOUNTED AT 48' A.F.F.		100A (NEMA 3R) SINGLE PHASE PANEL BOX WITH MAIN BREAKER

100 AMP 120/240 1 PHASE EXTERIOR SURFACE MOUNT PANEL W/ 100 AMP MAIN BRKR									
DESCRIPTION	CIR	BRK	WS	A	B	WS	BRK	CIR	DESCRIPTION
LIGHTS	1	20	#12	1100 5444	#6	60	2		HVAC UNIT
RECEPTACLES	3	20	#12	1260 5444	#6	2	4		
RECEPTACLES	5	20	#12	1080 XXXX	#XX	XX	6		SPACE
RECEPTACLES	7	20	#12	1080 XXXX	#XX	XX	8		SPACE
SPACE	9	XX	#XX	XXXX XXXX	#XX	XX	10		SPACE
SPACE	11	XX	#XX	XXXX XXXX	#XX	XX	12		SPACE
ELECTRICAL CALCULATIONS: PANEL "NOA"									
GENERAL LIGHTING:									
825 sq/ft x 3.5 x 1.25 = 3609.38									
(10,888) HVAC UNIT = 10,888									
(3440) RECEPTACLES = 3440									
17,937.38 ÷ 240v = 74.74 AMPS TOTAL									

MECHANICAL VENTILATION

BUILDING SQUARE FOOTAGE	825 S.F.
OCCUPANCY LOAD	8
OUTSIDE AIR REQUIRED (20 cfm x 8)	160 CFM
TOTAL CFM AVAILABLE	1200 CFM
FRESH AIR MAKE-UP (160 / 1200)	13.3%

*MECHANICAL VENTILATION SHALL BE PROVIDED AS REQ'D. IN ACCORDANCE WITH TABLE 403.3 OF THE 2003 IMC OR NATURAL MEANS OF VENTILATION SHALL BE PROVIDED IN ACCORDANCE WITH SECTION 402 OF THE 2003 IMC.

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DEALER: NORTEX MODULAR DFW

PROJECT: 14 X 64 (60) NORPLEX "VO" SERIES PROJECT NUMBER: PROJECT - NTX - VO

SCALE: AS NOTED

PLOT DATE: 11/11/2008

SALESMAN: RP


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STATES: TX


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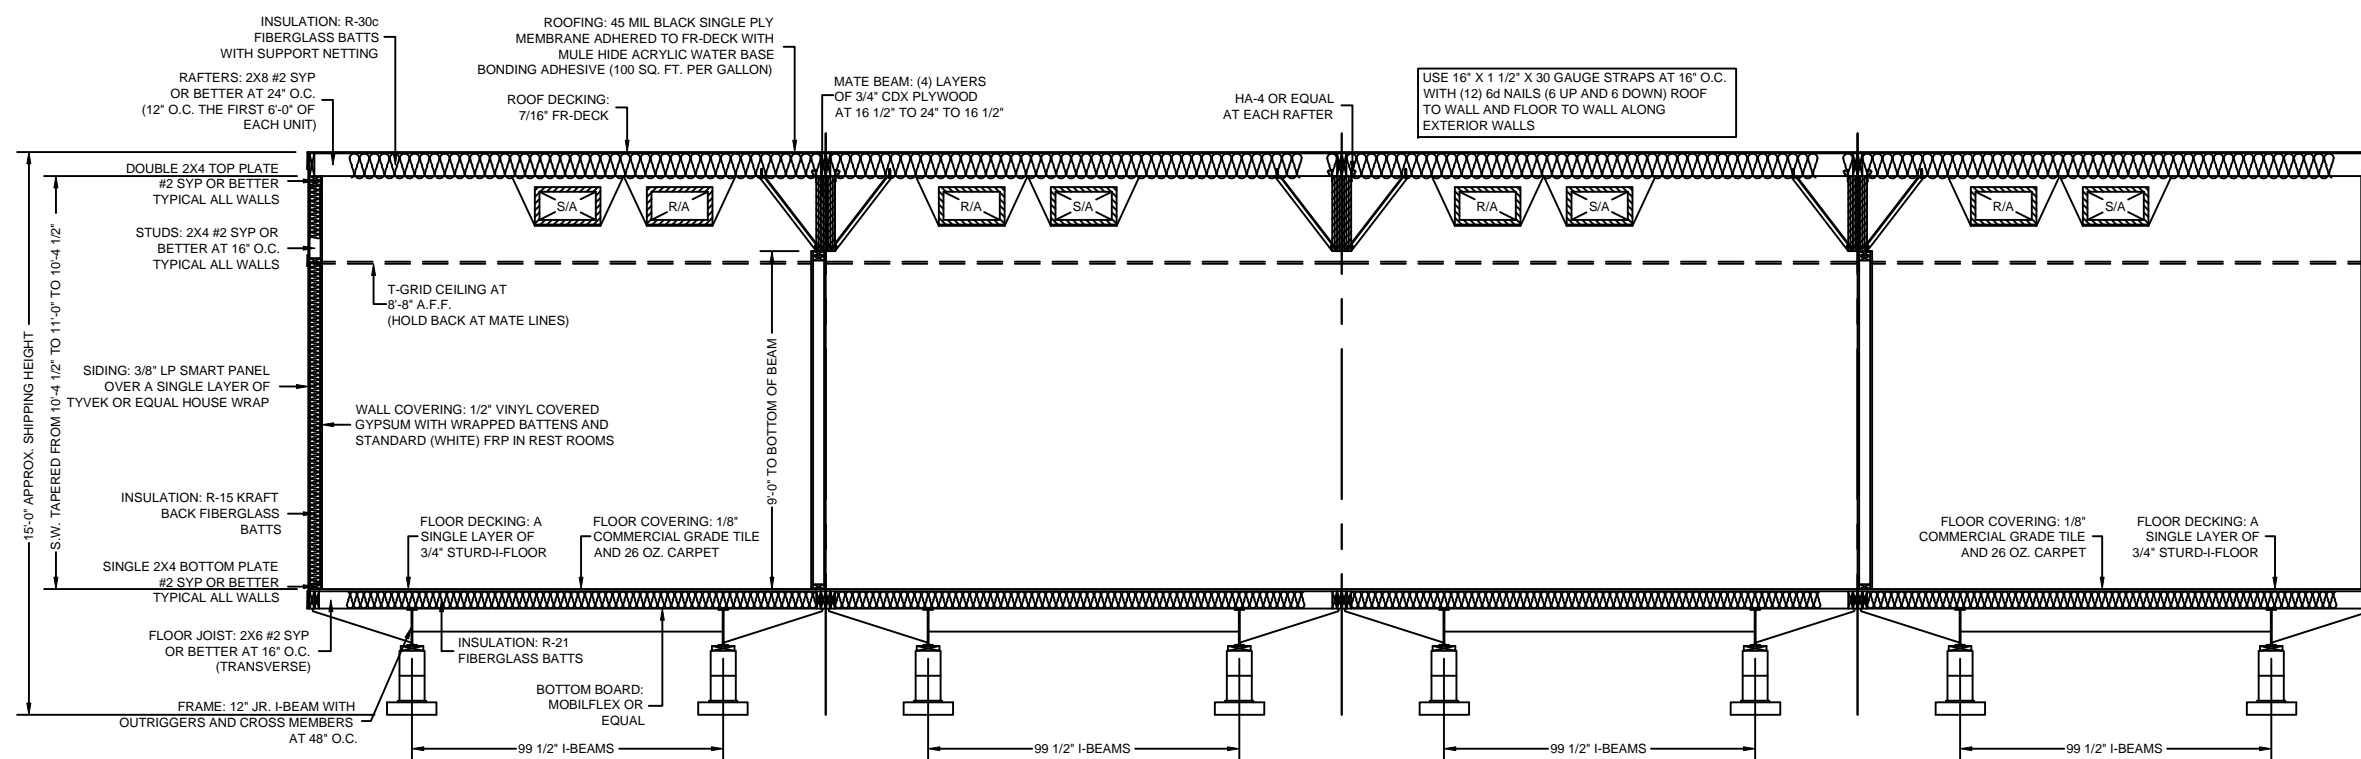
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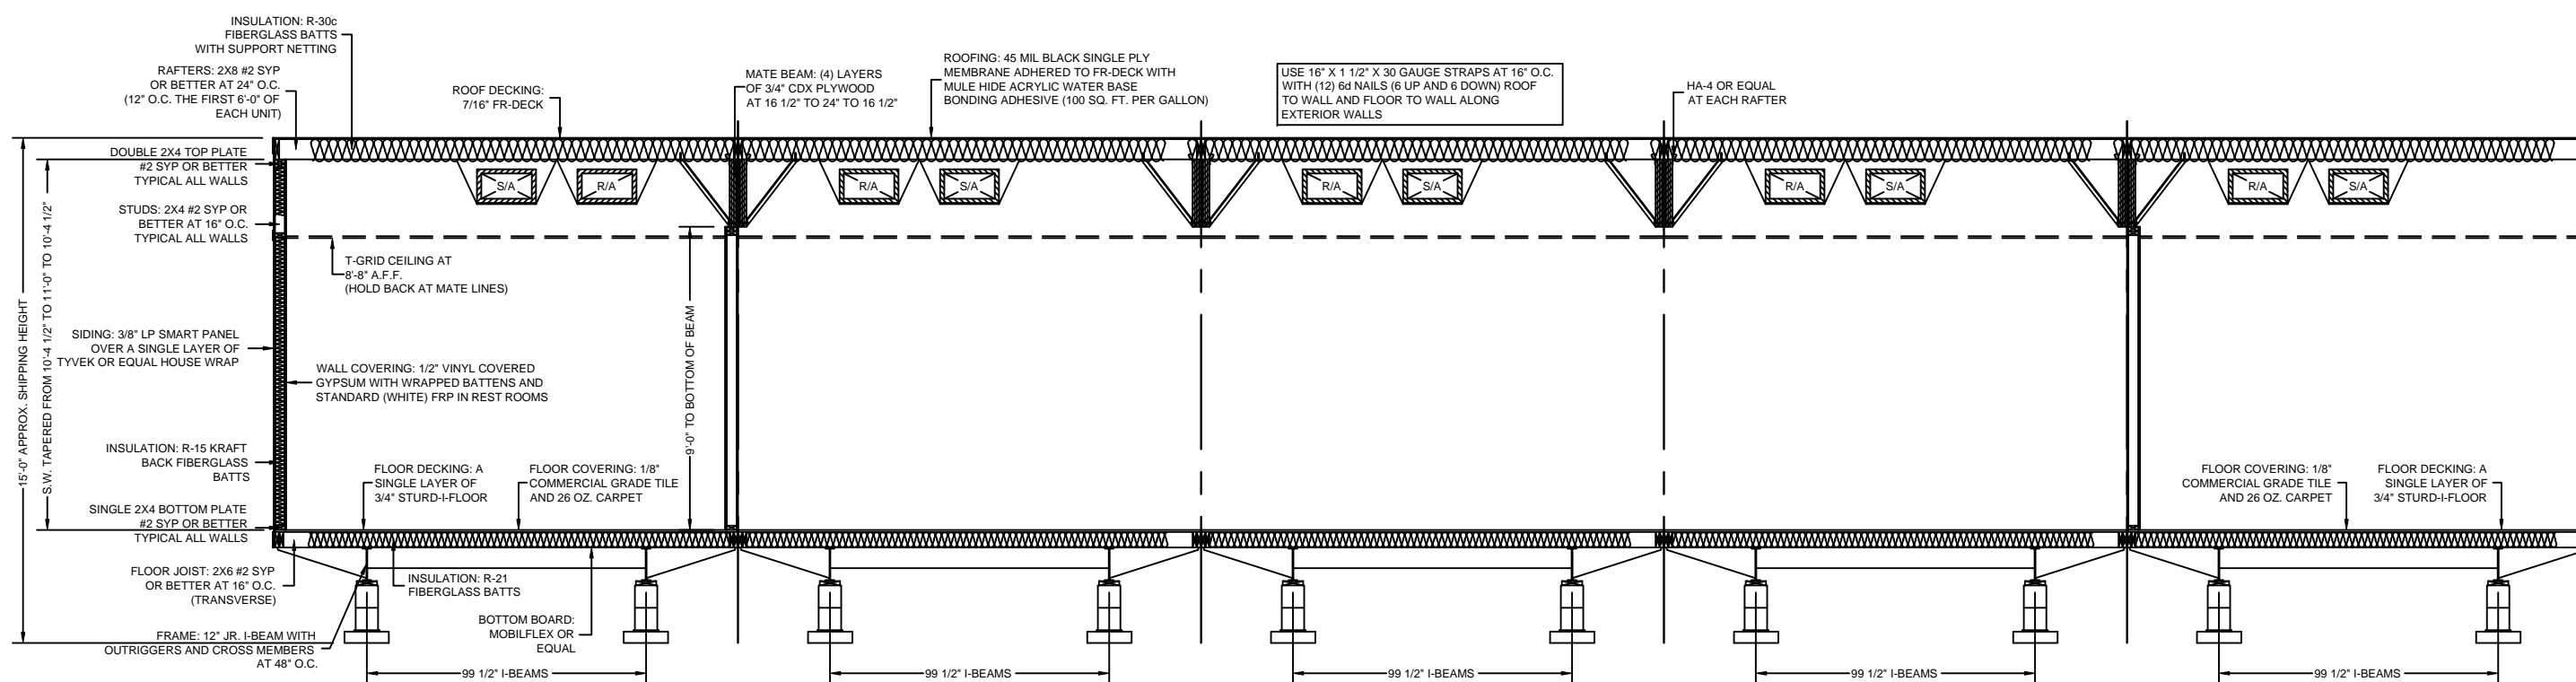
DOUBLE WIDE CROSS-SECTION AT HITCH END
3/16" = 1'-0"



TRIPLE WIDE CROSS-SECTION AT HITCH END
3/16" = 1'-0"

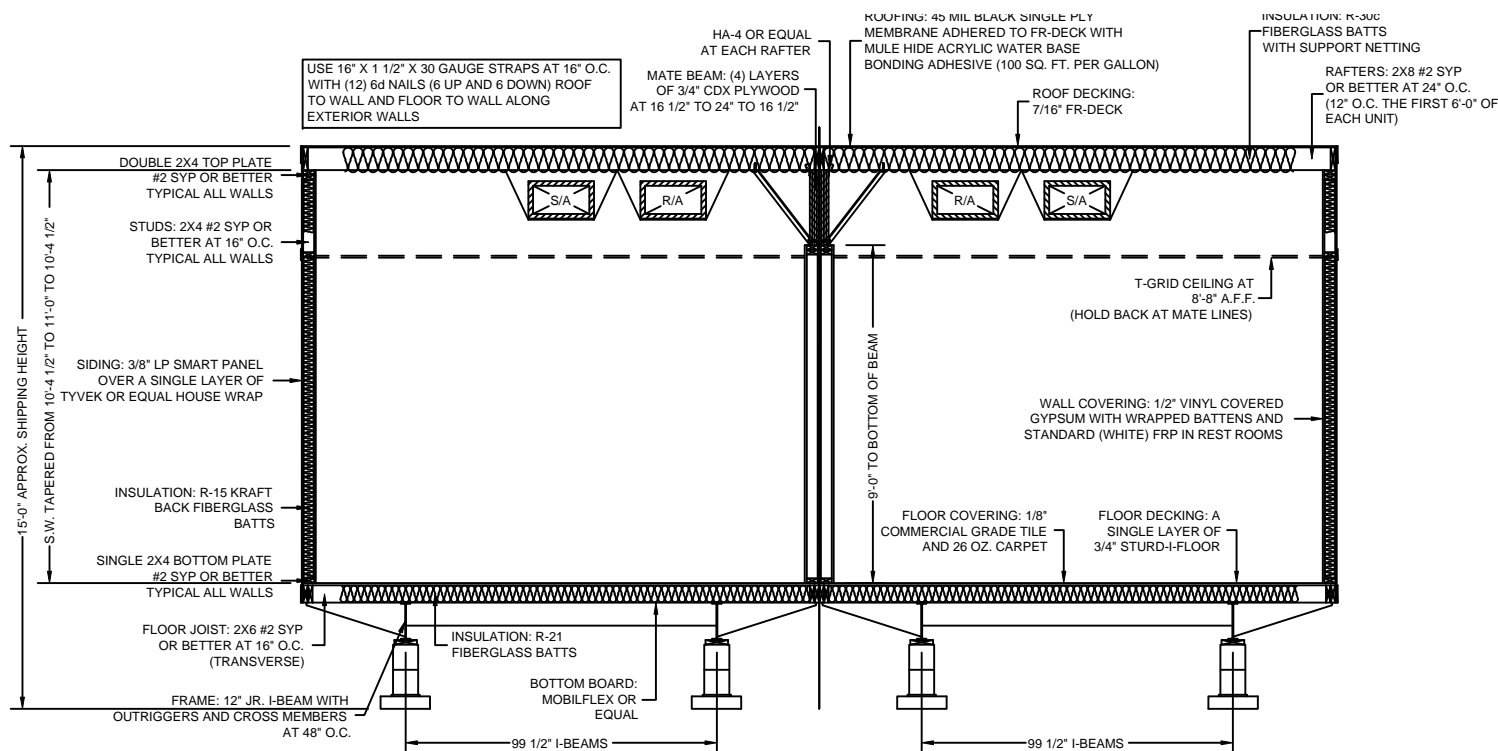

4-UNIT CROSS-SECTION AT HITCH END
3/16" = 1'-0"

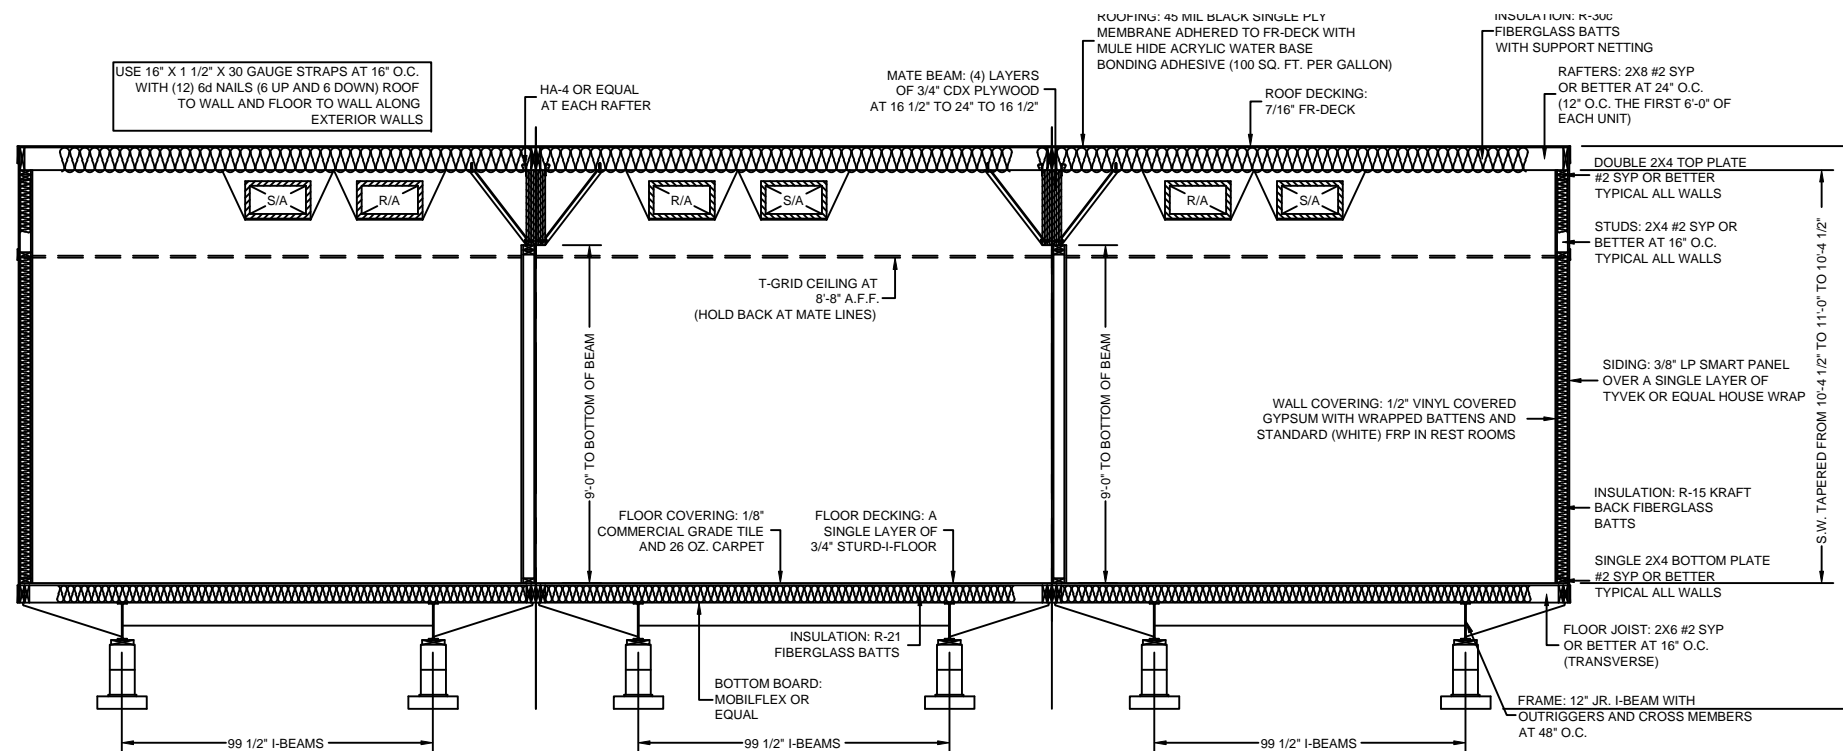

5-UNIT CROSS-SECTION AT HITCH END
3/16" = 1'-0"

FOUNDATION TO BE CONSTRUCTED IN ACCORDANCE WITH THE INDICOM STATE PACKAGE OR DESIGNED BY A REGISTERED PROFESSIONAL ENGINEER. CRAWL SPACE ACCESS AND VENTING TO BE PROVIDED AND SITE INSTALLED BY OTHERS IN ACCORDANCE WITH THE 2006 IBC SECTIONS 1209.1 AND 1203.3.1 RESPECTIVELY.

INDICOM BUILDINGS, INC.
INDUSTRIALIZED COMMERCIAL BUILDINGS
721 N. BURLESON BLVD - BURLESON, TX 76028
817-447-1213 FAX 817-447-2751

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DEALER: NORTEX MODULAR DFW

PROJECT: 14 X 64 (60) NORPLEX "VO" SERIES

PROJECT NUMBER: PROJECT - NTX - VO

SCALE: AS NOTED

PLOT DATE: 11/11/2008

SALESMAN: RP

DRAWN BY: MJM


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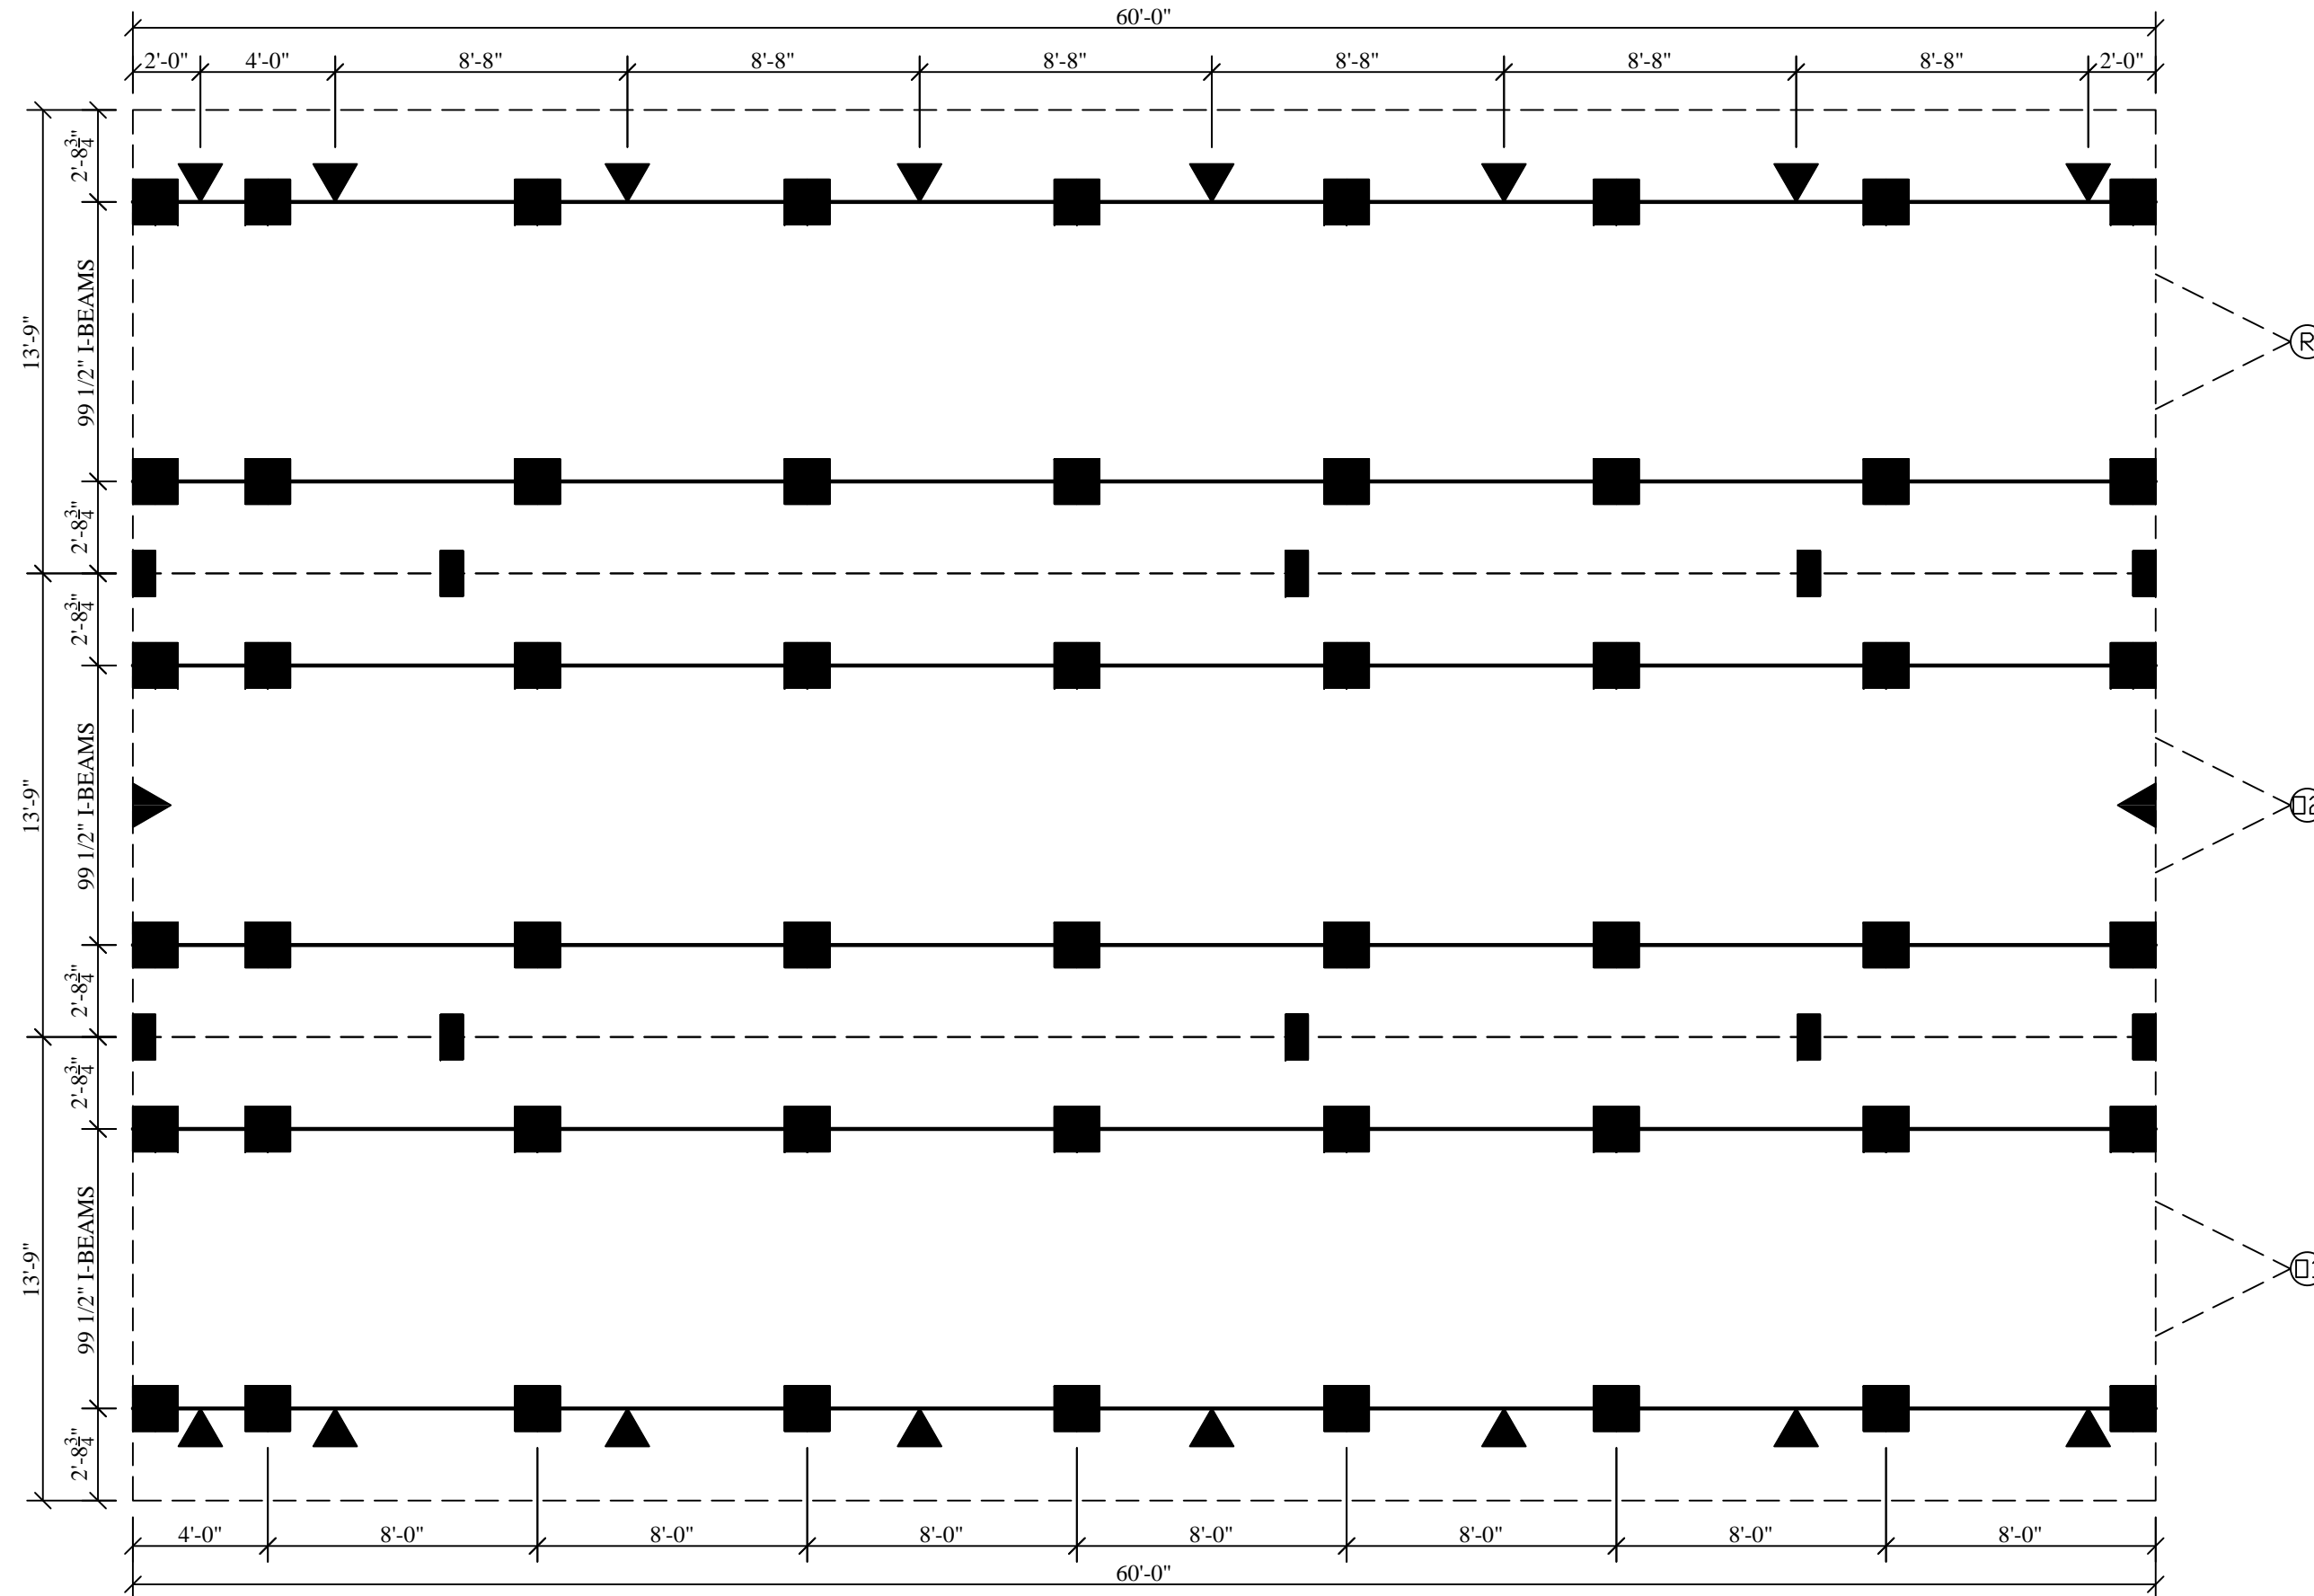
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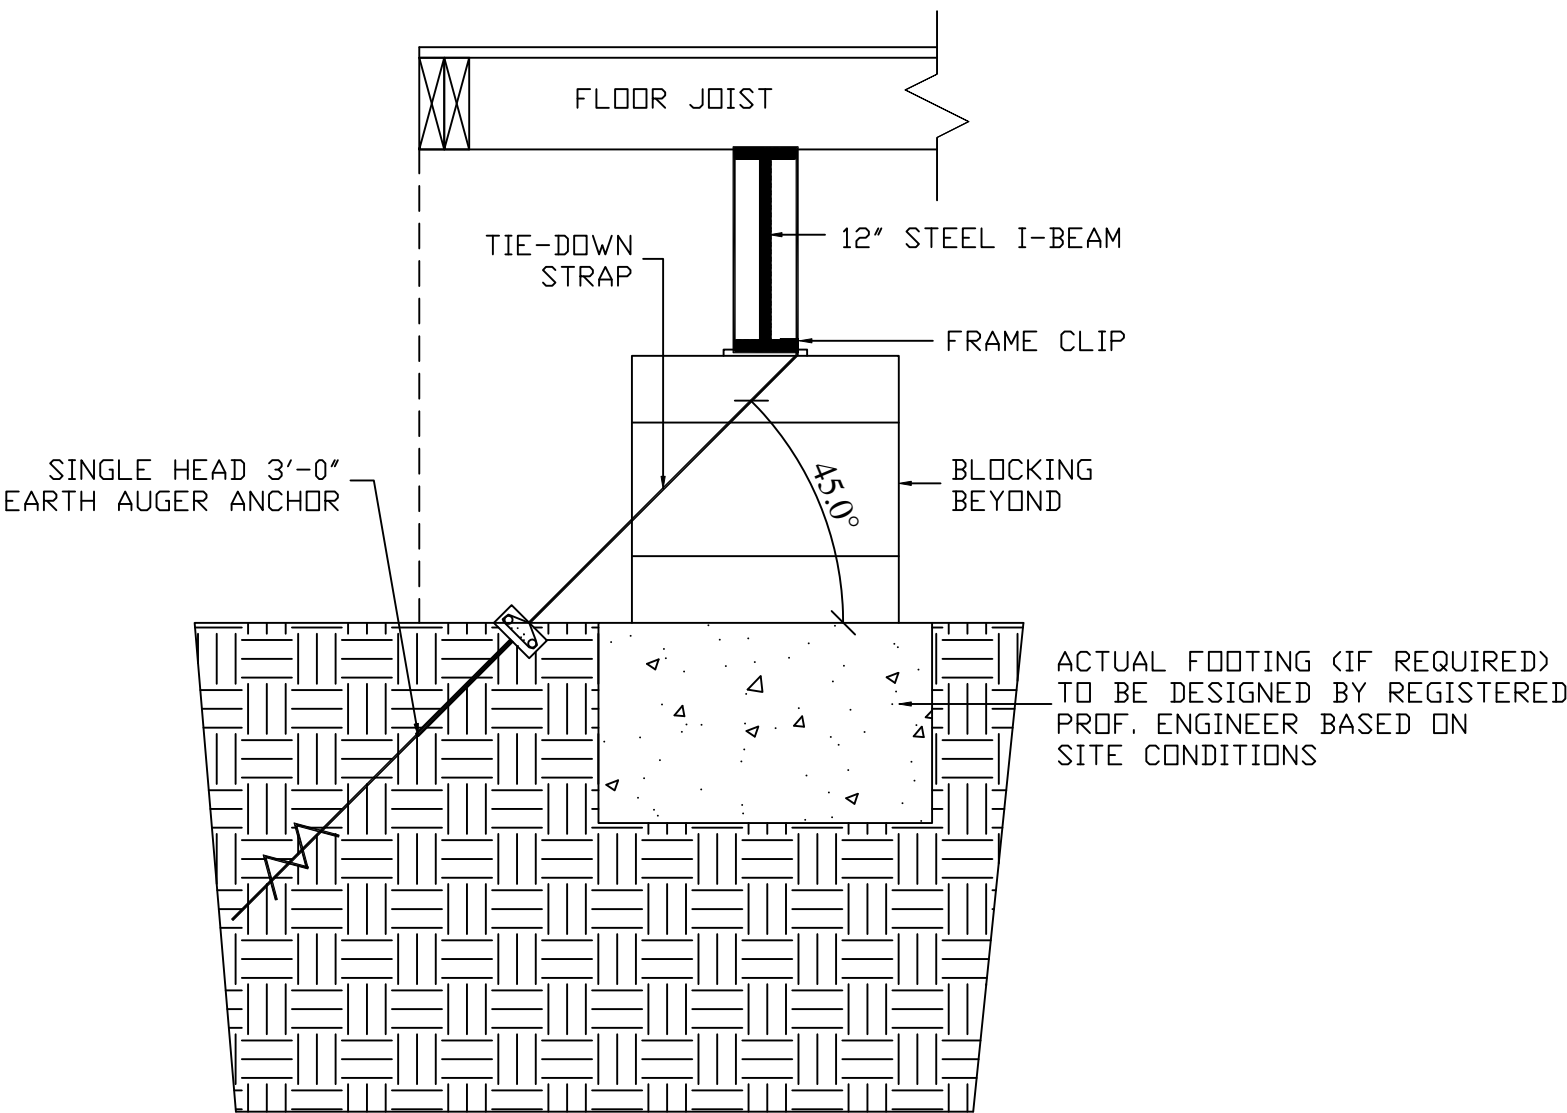
13^{OF} 15



DOUBLE WIDE SUGGESTED BLOCKING PLAN
3/16" = 1'-0"



TRIPLE WIDE SUGGESTED BLOCKING PLAN
3/16" = 1'-0"

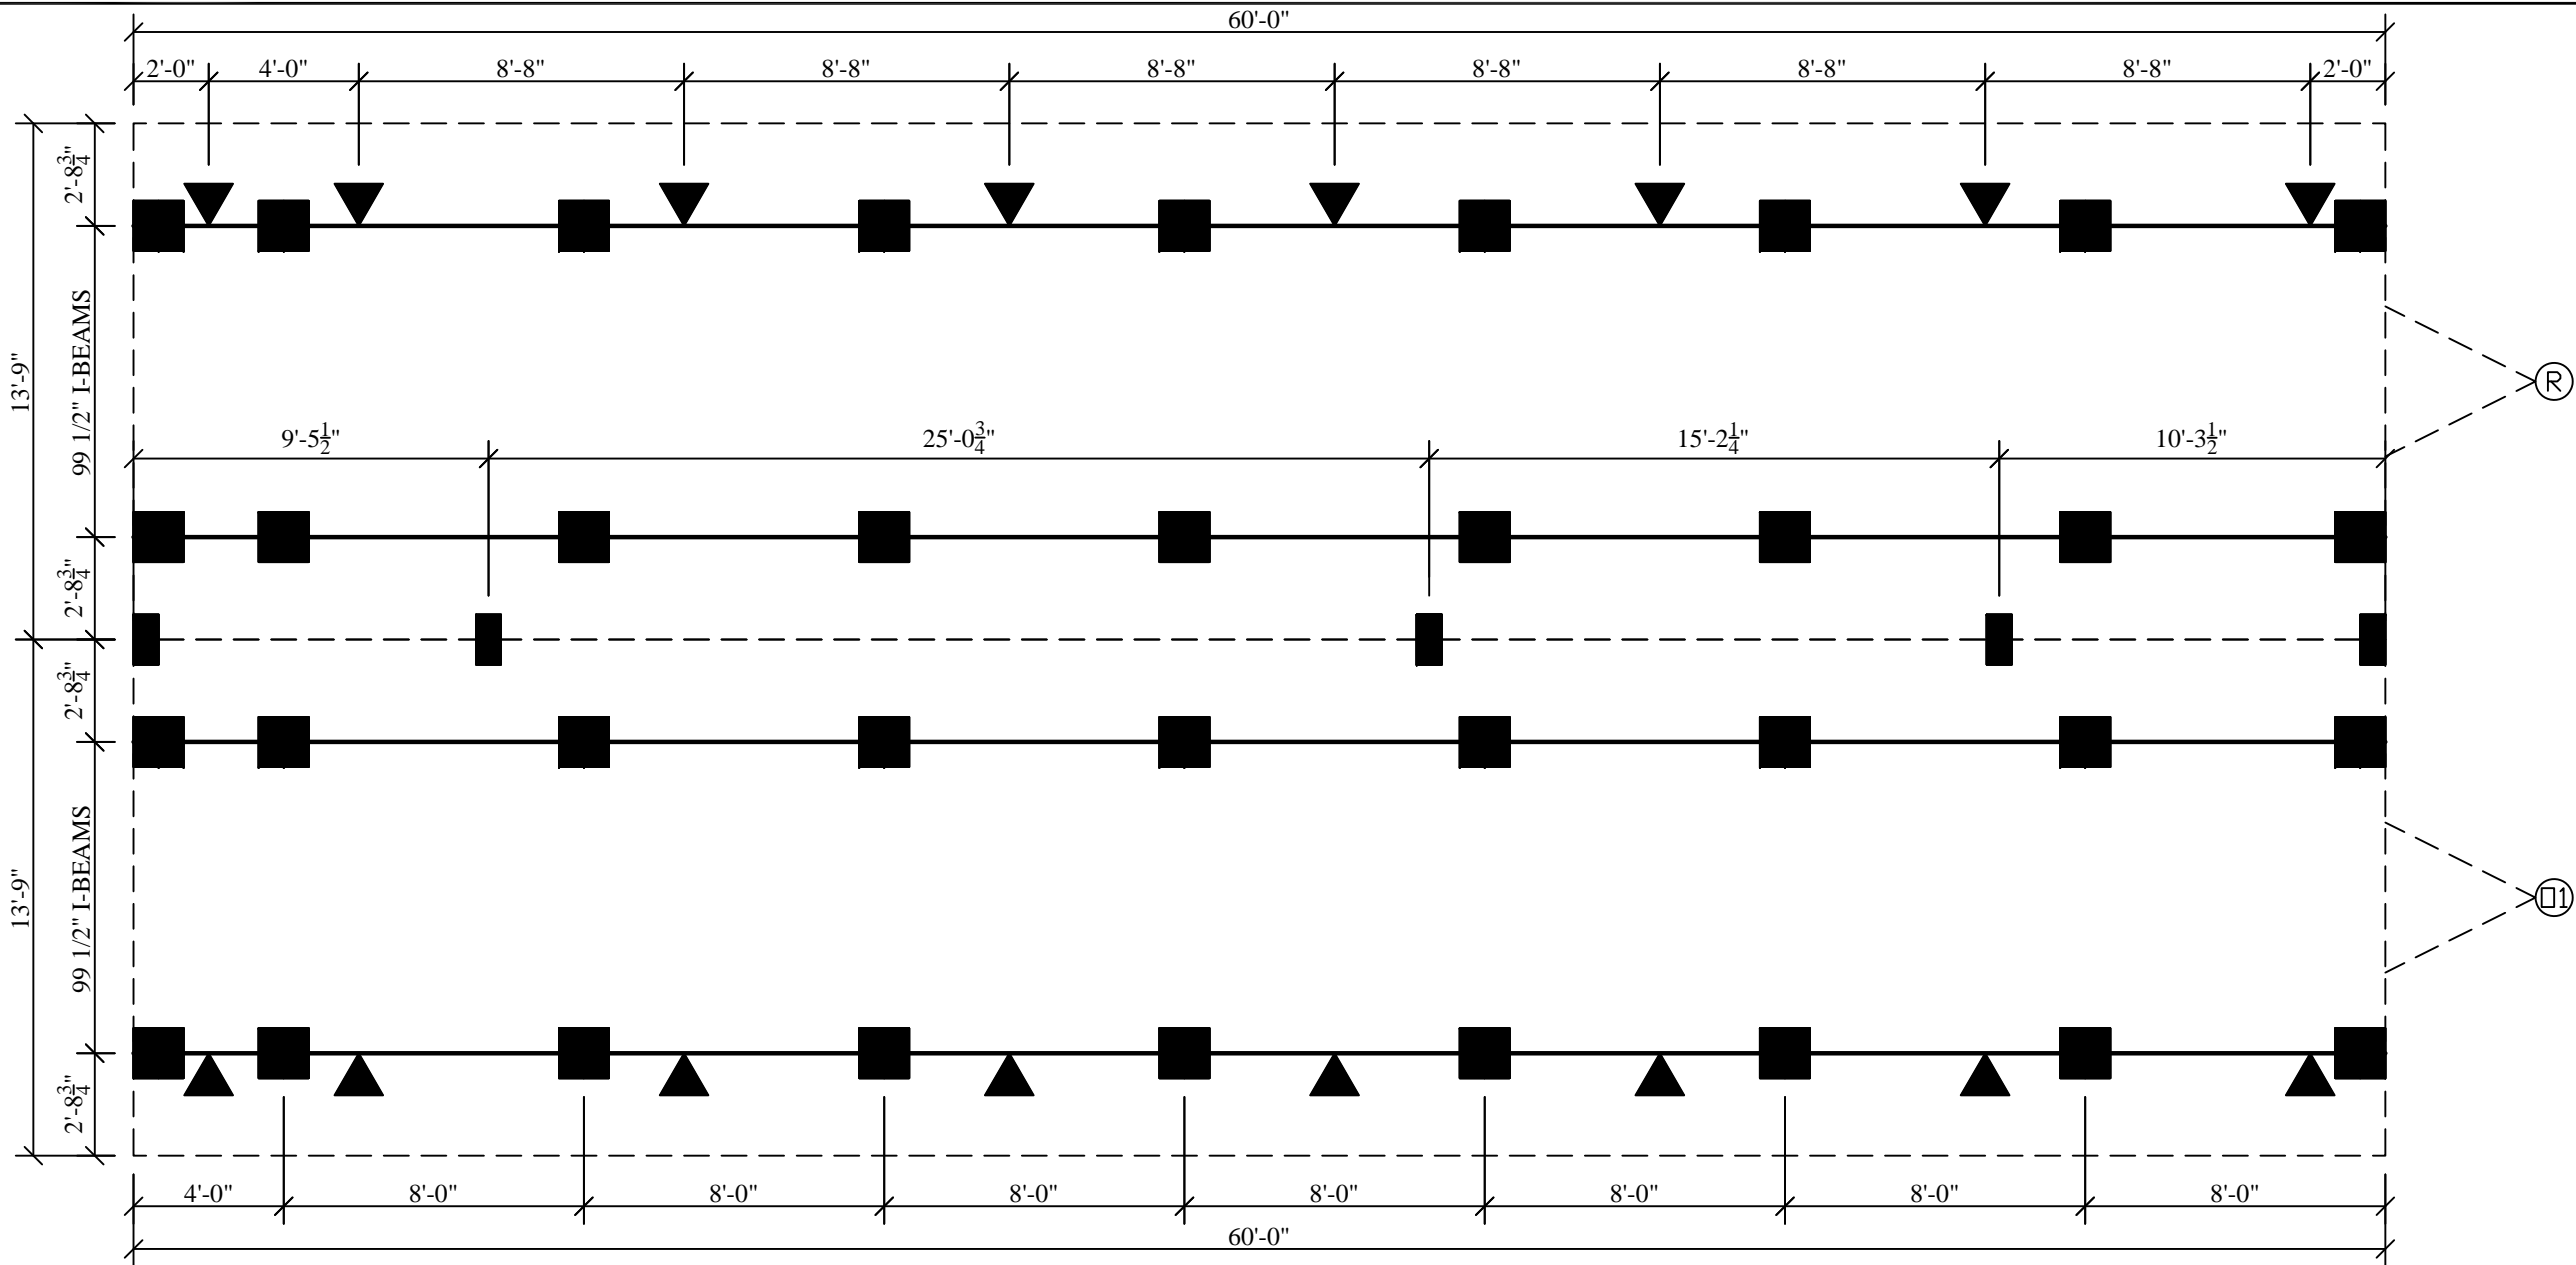

SUGGESTED ANCHORING METHOD

1" = 1'-0"

NOTE: ALTERNATE ANCHORING METHOD MAY BE DESIGNED BY LOCAL PROFESSIONAL BASED ON SITE CONDITIONS AND LOCAL/STATE REQUIREMENTS.

- INDICATES SUGGESTED MAXIMUM I-BEAM BLOCKING SPACING - PIERS AND FOOTINGS DESIGNED BY LOCAL PROFESSIONAL IN ACCORD. WITH ALL LOCAL AND STATE REQUIREMENTS BASED ON SITE CONDITIONS
- INDICATES REQUIRED MATE LINE BLOCKING LOCATION - PIERS AND FOOTINGS DESIGNED BY LOCAL PROFESSIONAL IN ACCORD. WITH ALL LOCAL AND STATE REQUIREMENTS BASED ON SITE CONDITIONS
- INDICATES ADDITIONAL REQUIRED FRAME-TIE GROUND ANCHOR (MIN. 4725 LBS. HOLDING STRENGTH) LOCATION FOR WIND LOADS GREATER THAN 90 MPH AND UP TO 130 MPH V3s (EXP B). - NOTE: ALTERNATE ANCHORING DESIGN MAY BE MADE BY REGISTERED PROFESSIONAL ENGINEER.

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DFW	NORPLEX "VO" SERIES	

SCALE: AS NOTED

PLOT DATE: 11/11/2008

SALESMAN: RP


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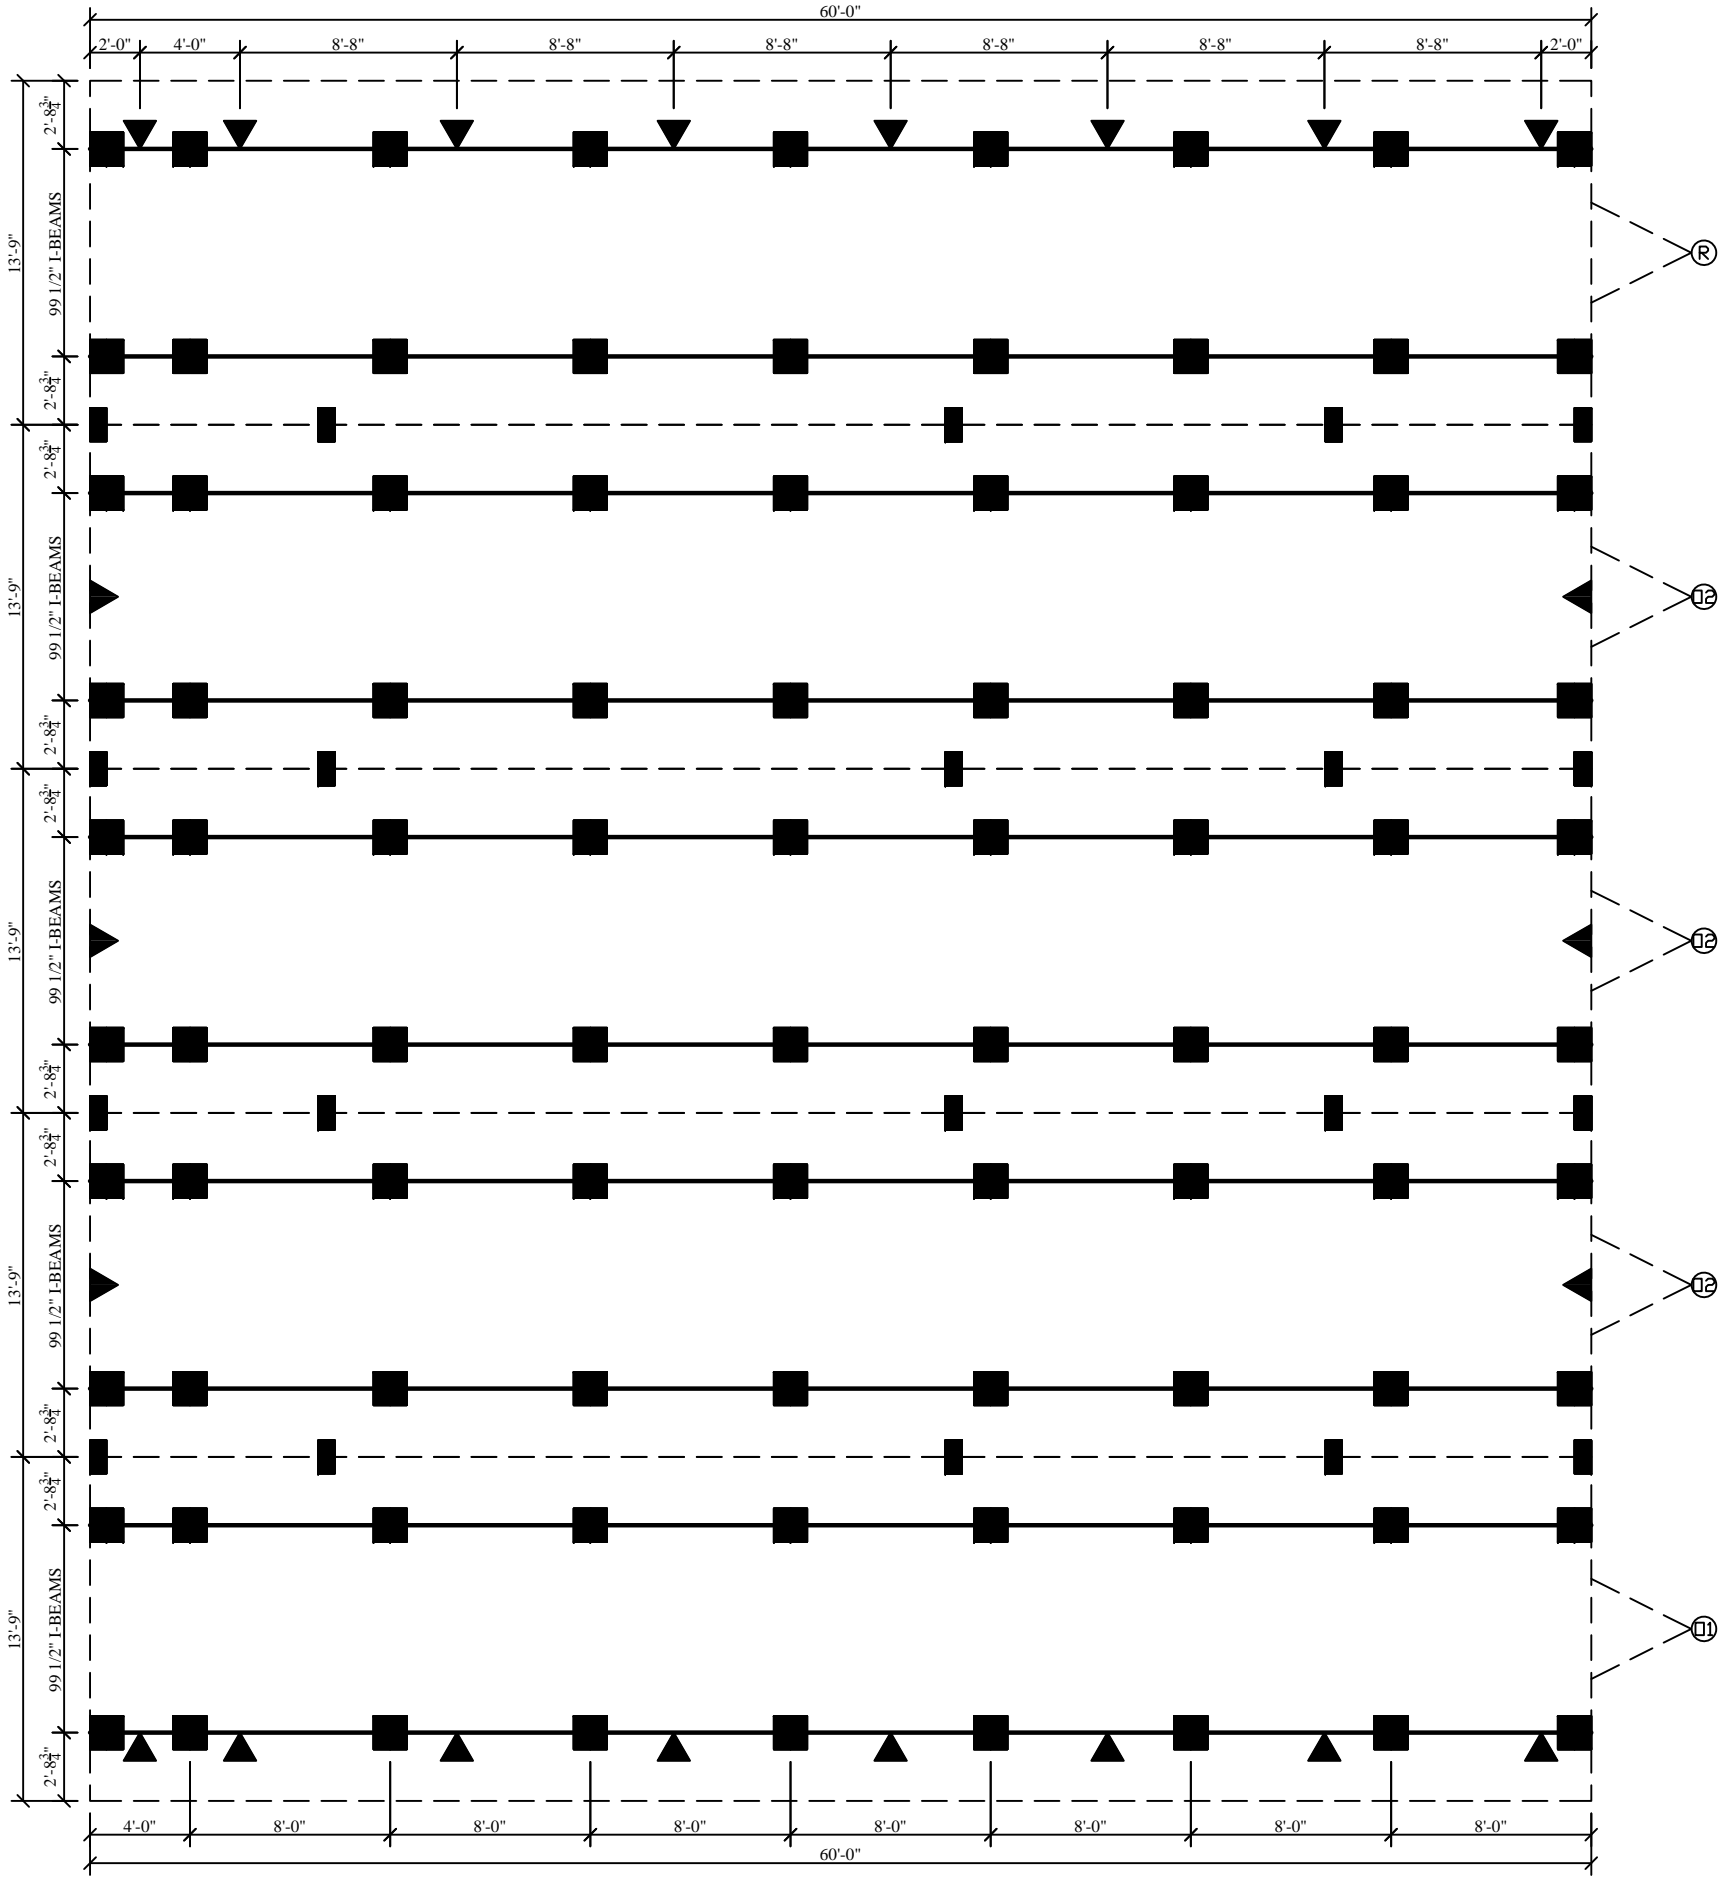
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REVISIONS:

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4-UNIT SUGGESTED BLOCKING PLAN
1/8" = 1'-0"



5-UNIT SUGGESTED BLOCKING PLAN
1/8" = 1'-0"

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DEALER: NORTEX MODULAR
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PROJECT: 14 X 64 (60)
NORPLEX "VO" SERIES
PROJECT NUMBER:
PROJECT - NTX - VO

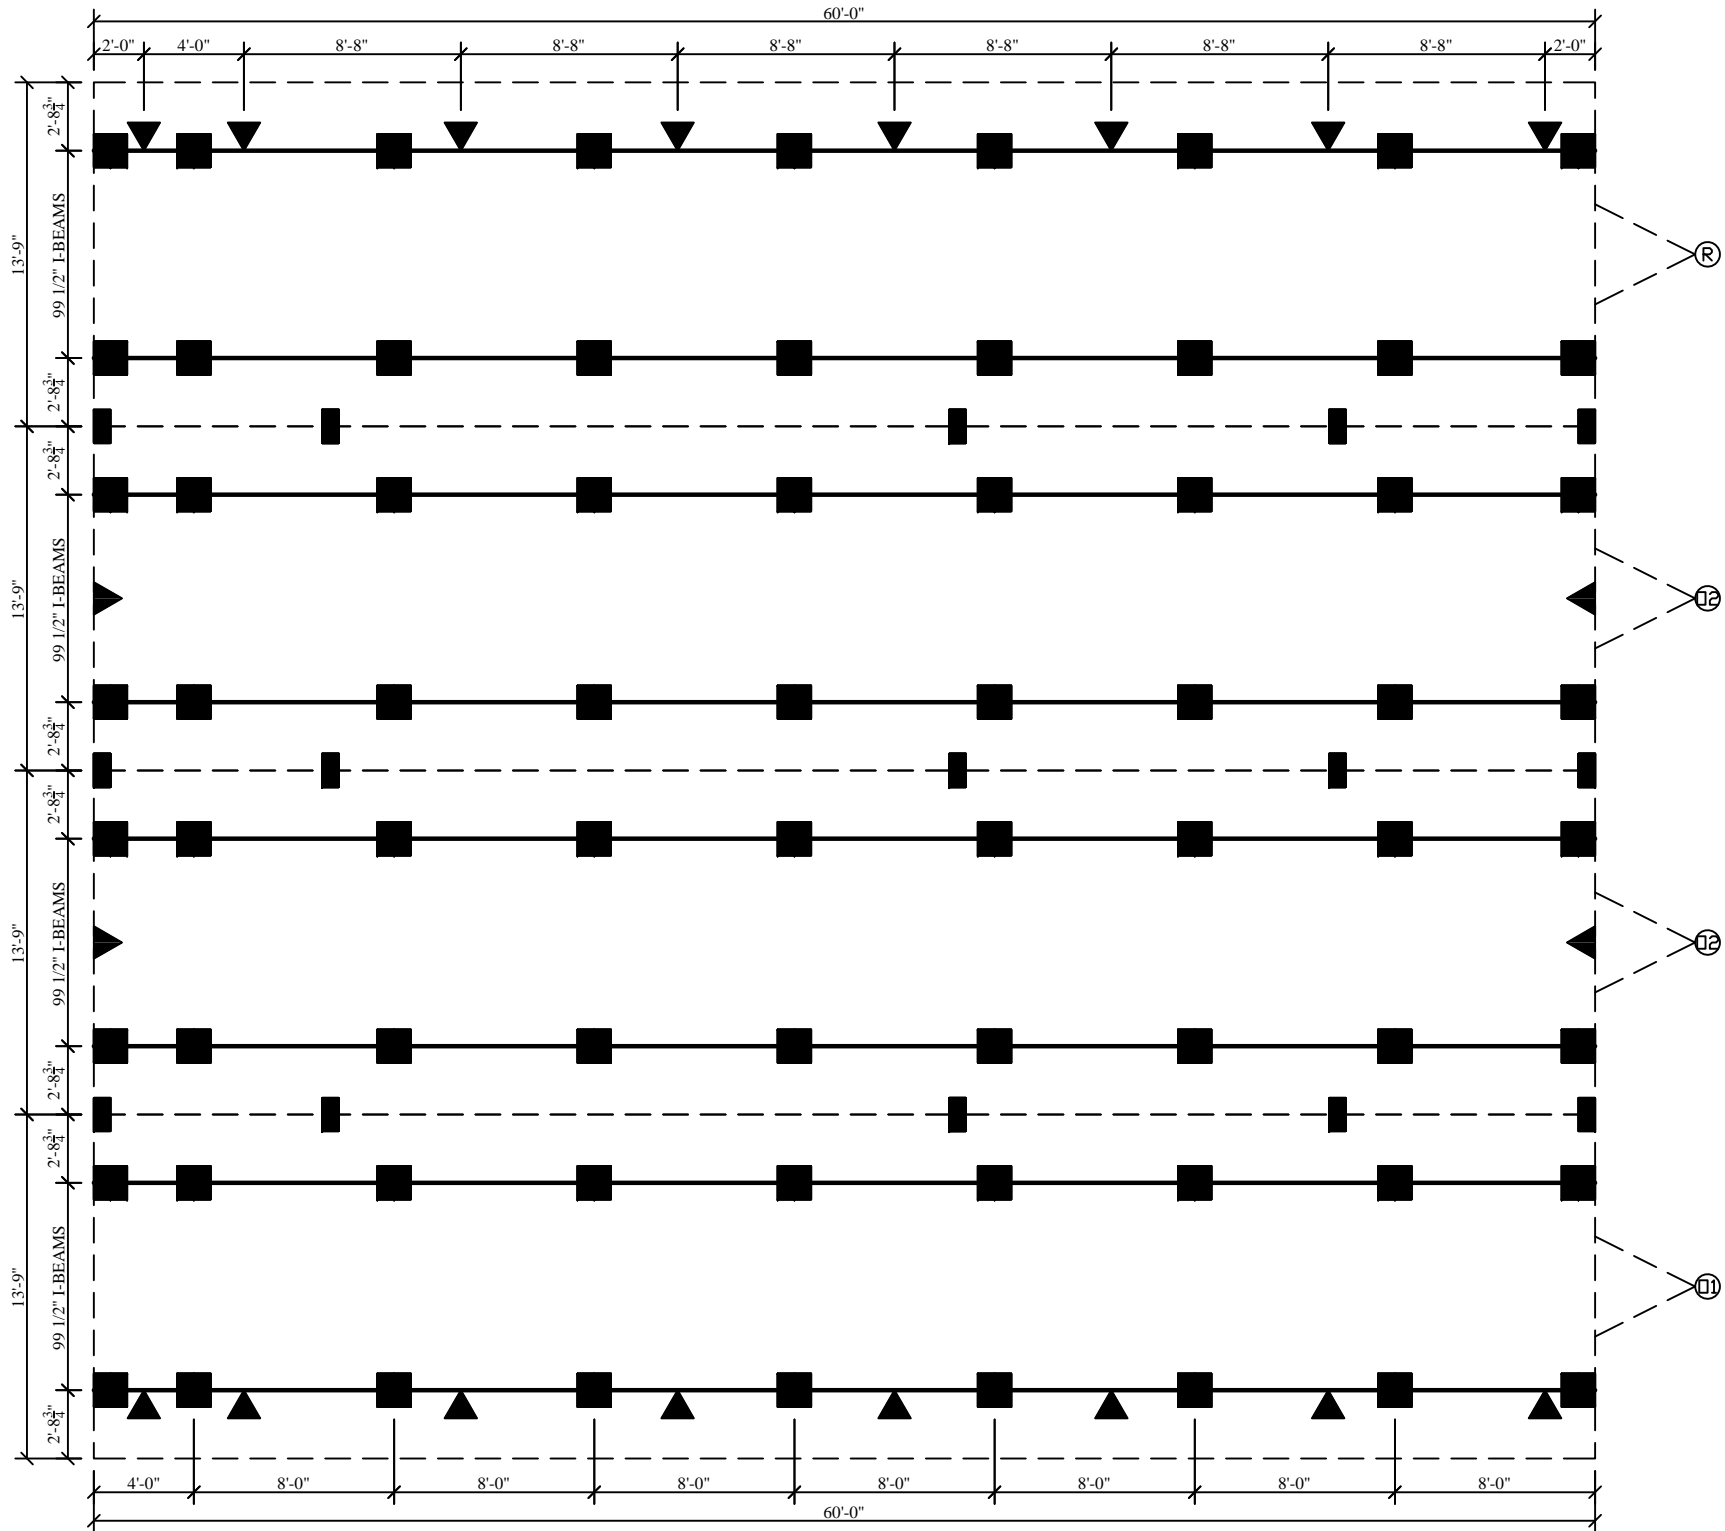SCALE: AS NOTED

PLOT DATE:
11/11/2008

SALESMAN: RP


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REVISIONS:

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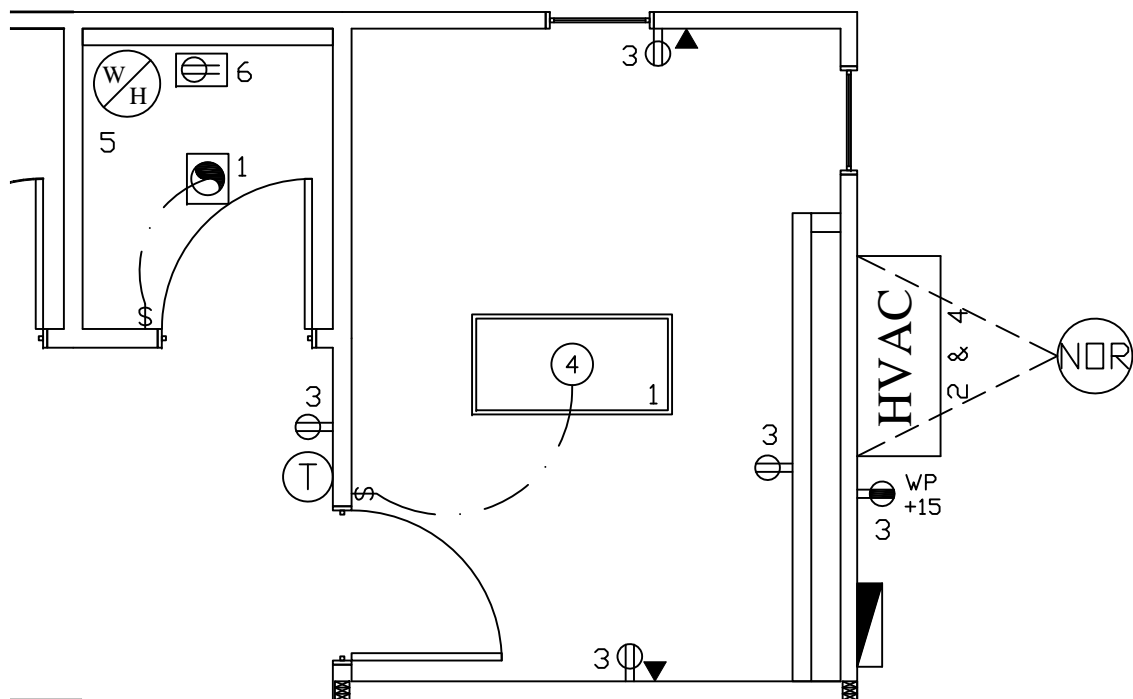
FRAME LAY OUT
1/4" = 1'-0"

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DEALER: NORTEX MODULAR DFW	PROJECT: 14 X 64 (60) NORPLEX "VO" SERIES
PROJECT NUMBER: PROJECT -NTX - VO	
SCALE: AS NOTED	
PLOT DATE: 11/11/2008	
SALESMAN: RP	
DRAWN BY: MJM	
STATES: TX	
SERIAL NUMBERS: XXX	
REVISIONS:	
SHEET: 1 OF 1	

PROJECT: 08-NORPLEX-VO-SERIES

1. CHANGE THE HEAT TAPE RECEPTACLE FROM CIRCUIT #3 TO CIRCUIT #6.

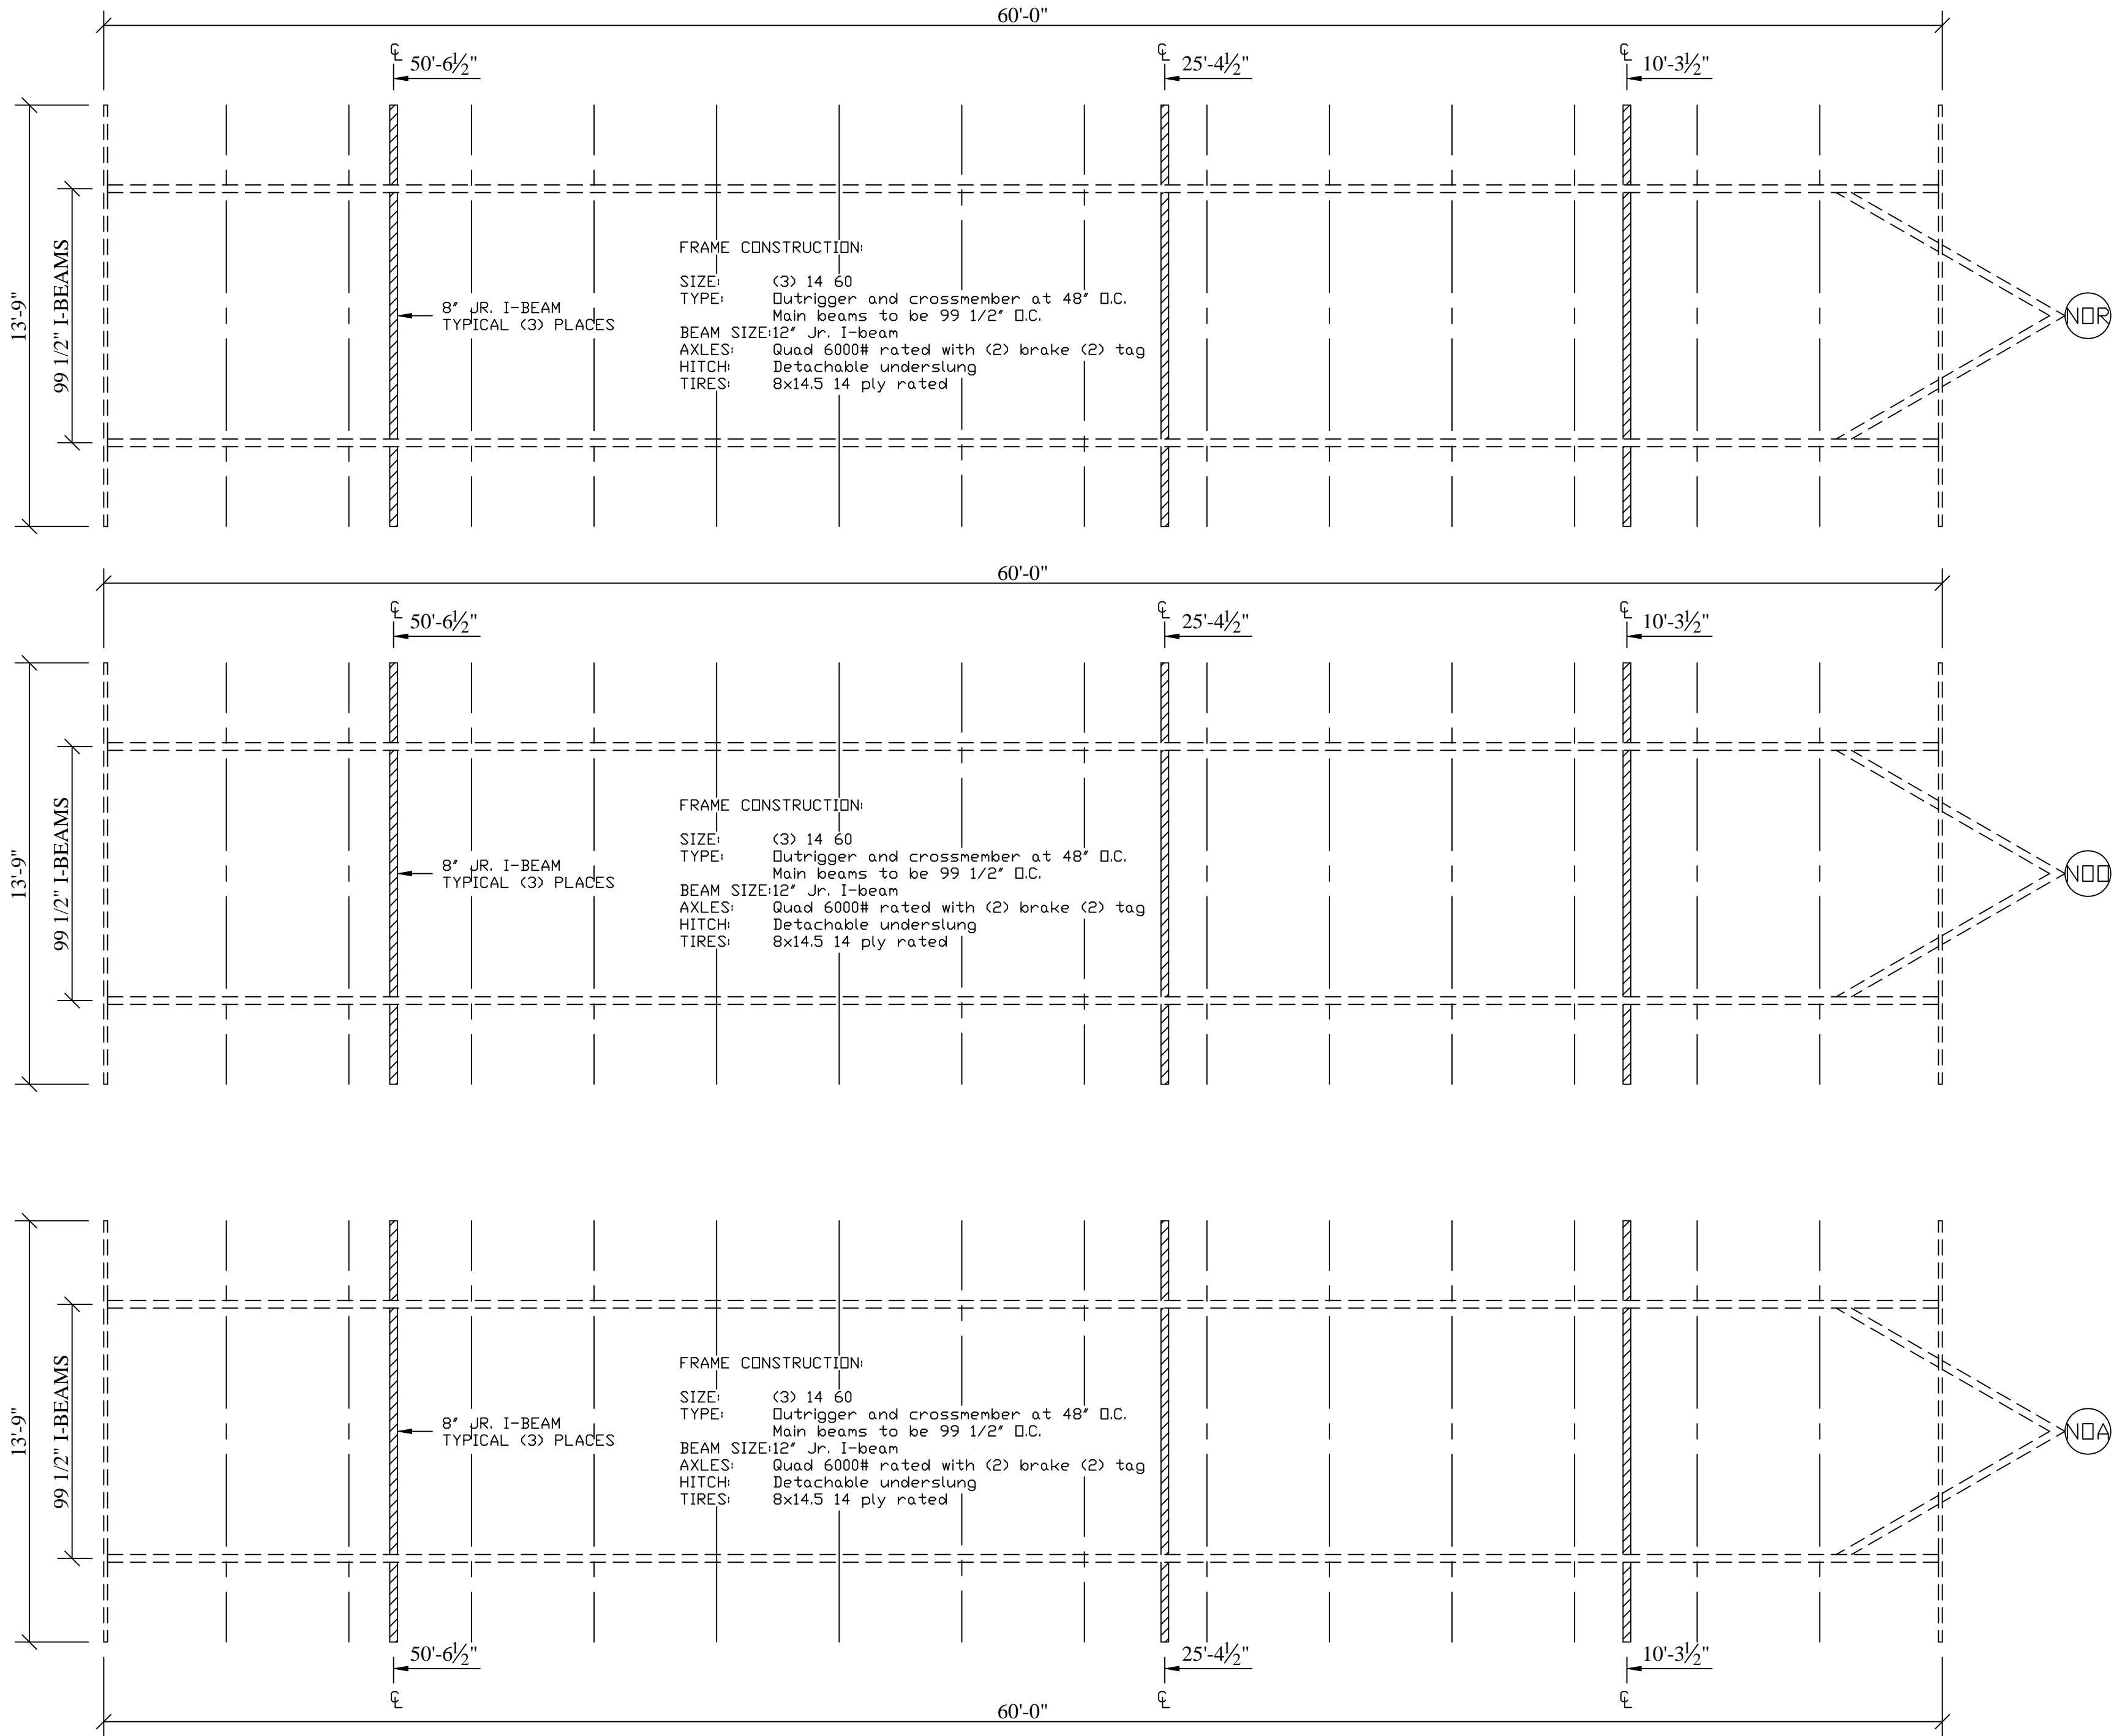PER 210.8(B) EXCEPTION No.1 TO (3) AND (4):
RECEPTACLES THAT ARE NOT READILY ACCESSIBLE AND
ARE SUPPLIED FROM DEDICATED BRAND CIRCUIT FOR
ELECTRIC SNOW-MELTING OR DEICING EQUIPMENT SHALL
BE PERMITTED TO BE INSTALLED WITHOUT GFCI
PROTECTION.



ELECTRICAL PLAN

$$1/4'' = 1'-0''$$

DEALER: NORTEX MODULAR	DATE: 11/11/08	PROPERTY OF: INDICOM BUILDINGS, INC. 721 N. BURLESON BLVD - BURLESON, TX 76028 (817)447-1213 FAX (817)447-2751 DO NOT COPY
PROJECT: NORPLEX "VO" SERIES	SALESMAN: RP	
PROJECT #: 08-NORPLEX-VO-SERIES	DRAWN BY: MJM	