

DESIGN CRITERIA: PROJECT NAME: NORTEX STOCK 2460 CLASSROOM BUILDING SQUARE FOOTAGE: 1410 SF 2002 NEC 2003 IBC 2003 IMC 2003 IPC 2003 IECC 1994 TAS USE GROUP: E CONSTRUCTION TYPE: BC: V-B OCCUPANT LOAD: 65 PERMISSIBLE GAS TYPE: LP NATURAL NA

DESIGN LOADS: ROOF LIVE LOAD: 30 PFS FLOOR LIVE LOAD: 100 PFS (SEE BLOCKING S-101) CONC. FLOOR LIVE LOAD: 2000 LBS WIND LOAD: (130 MPH 3-SEC GUST) EXPOSURE: B SEISMIC DESIGN CATEGORY: C

SPECIAL CONDITIONS AND/OR LIMITATIONS: 1. HANDICAP ACCESS TO BE PROVIDED PER 1994 TAS AS REQUIRED BY OTHERS. 2. BUILDING TO BE LOCATED PER TABLE 602 OF THE 2003 IBC. 3. ANY REQUIRED ALARM SYSTEM WILL BE INSTALLED ON SITE BY OTHERS. 4. RESTROOMS TO BE PROVIDED BY OTHERS PER TAS AND IPC. 5. WATER FOUNTAIN SHALL BE FURNISHED BY OTHERS PER IPC-2003 TABLE 403.1.

FOUNDATION NOTES: 1. TIE DOWN ANCHORING SEE SHEET S-101 2. CRAWL SPACE VENTILATION PROVIDED BY SITE INSTALLER PER 1203.3.1 OF 2003 IBC.

SCOPE OF WORK: NOT INCLUDED IN SCOPE OF WORK: 1. UTILITIES AND UTILITY CONNECTIONS 2. POURED CONCRETE (DRIVEWAY, SIDEWALK, SLABS, FOOTINGS, ECT.) 3. SITE PREPARATION 4. TAX OF ANY KIND 5. BUILDING PERMITS SITE WORK: 1. NO PROVISION FOR SITE WORK HAS BEEN INCLUDED. IT IS PRESUMED THE SITE WILL PROVIDE CLEAR ACCESS FOR TRUCKS AND MODULARS. ADEQUATE DRAINAGE TO BE PROVIDED. 2. ALL ELECTRICAL, PLUMBING, SEWER, & GAS SERVICE CONNECTIONS AND ALL CONCRETE WORK ON SITE, TO INCLUDE POURED FOOTINGS, SLABS, FOUNDATIONS, SIDEWALKS, DRIVEWAYS OF WHATEVER KIND ARE THE RESPONSIBILITY OF OTHERS.

IDENTIFICATION STATE DECAL: TDLR DECAL AND MANUFACTURERS DATA PLATE ON ELECTRICAL PANEL. DECAL: NORTEX PLACED ON FRONT LEFT OF BUILDING

FRAME / CHASSIS: OUTRIGGERS: 48" O.C. CROSSMEMBERS: 48" O.C. BEAM: 12" JR. I-BEAM HITCH: DETACHABLE HITCH AXLES: (4) EA. W/BRAKES ON ONE AXLE, DRAG ON THREE TIRES: L (12-PLY) FRAME: HEAVY

FLOOR: BOTTOM BOARD: ROLL, POLYETHYLENE FIBER MESH INSULATION: R-22 FACED JOIST: 2X8 #2SYP OR BETTER AT 16" O.C. SIDEBAND JOIST (RIM): 2X8 #2SYP OR BETTER DECKING: 3/4" T&G OSB (DRY GUARD), GLUED & ATTACHED W/ MIN. 2-1/2" SCREW SHANK NAILS UNDERLAYMENT: N/A COVERING: 24" INCYCLED CARPET SQUARES-STD COLOR BASE COVE: 4" RUBBER COLOR= GREY

EXTERIOR WALLS: SIDEWALL HEIGHT: 10'-1 1/8" STUDS: 2X4 #2SYP 12" O.C. BOTTOM PLATE: SINGLE 2X4 #3SFP OR BETTER TOP PLATES: DOUBLE 2X4 #3 SFP OR BETTER HEADERS: DOUBLE 2X8 #2SYP W/ 7/16" FILLER JACK STUDS: SINGLE EACH SIDE OF OPENINGS 2X4 #2SYP KING STUDS (2) ON EACH SIDE OF OPENINGS. FIRE BLOCKING: 2X4 #3SFP OR BETTER ON EDGE AT THE CEILING LINE INSULATION: R-15 FACED SHEATHING: 7/16" OSB AT END WALLS. SIDING: 3/8" SMART PANEL COLOR: SEE SHEET A-201 TRIM: 1X4 SMART PANEL COLOR: SEE SHEET A-201 SKIRTING: SHIP LOOSE 12 4X12 SHTS SMART PNL. PAINTED TO MATCH BODY IF ORDERED IF SKIRTING IS ORDERED, 12"X12" VENTS TO BE SHIPPED WITH MAT 10

INTERIOR WALLS: WALL HEIGHT: 10'-1 1/8" STUDS 2X4 STUD GRADE SFP OR BETTER 16" O.C. BOTTOM PLATE: SINGLE 2X4 #3 SFP OR BETTER TOP PLATES: DOUBLE 2X4 #3 SFP OR BETTER FIRE BLOCKS: 2X4 #3SFP OR BETTER ON EDGE AT CEILING LINE COVERING: 5/8" FIRE-X VCG COLOR: HAMTOM GRAY TRIM: STANDARD VCG BATTENS INSULATION: R-15 UNFACED THROUGHOUT.

WINDOWS: SIZE/TYPE: (4) 24"X52" V.S. BRONZE FRAME/CLEAR LOW E GLASS BRAND: HR MIN. ENERGY VALUES: U-FACTOR=.51 SHGC=.34 COVERING: (4) ALUMINUM MIN-BLINDS COLOR: GRAY MSC: N/A

DOORS: EXTERIOR: (2) 36"X80" 18GA STEEL W/ 5"X20" PENCIL WINDOW (TEMP) EXTERIOR HARDWARE: (2) DEADBOLT (SCHLAGE) B660 BD x 26D W/IC CONSTR. CORE (2) 9305BC x AL NORTON CLOSURE (2) HOLLOW METAL FRAME (4) FULL PLATES ROCKWOOD #107 x 70C X US28 (2) PEMCO THRESHOLD 170A-36 (2) PEMCO SWEEP 315QN-36 (2) SET PEMCO WEATHERSTRIP 303AV-3070 INTERIOR: (2) 36"X80" SC MOHAWK W/STEEL REDIFRAME 1/L 1/R INTERIOR HARDWARE: LEVER HANDLES IF OPTIONAL DOOR INSTALLED. (2) HEAVY DUTY PRIVACY ND40S X RHODES x 26D (SCHLAGE) RESTROOM

ROOF: RAFTER: 2X10 #2SYP 16" O.C. RIM: 1 3/4" LVL 14 3/4" TAPER CUT TO 7 1/4" OVER ENDWALL - 2X8 @ MAT ELING SHEATHING: 7/16" MULE-HIDE FR DECK PANEL C COVERING: COLOR: WHITE STANDARD .045 MULE-HIDE EPDM ADHERED WITH MULE-HIDE ACRYLIC WATER BASED BONDING ADHESIVE BOTTOM RAFTER SHEATHING: NET TO HOLD INSULATION ROOF HITCH: .25/12 TRANSVERSE CEILING: 8'-8" HEIGHT. 2X4 LAY IN PANELS INSULATION: (2) LAYERS R-15 FLENUM: WALL RETURN VENTS: 1" ABOVE INSULATION

ELECTRICAL: SERVICE: 120/240V SINGLE PHASE LOAD CENTER: (1) 225 AMP, INT MOUNT LOAD CNT. W/ #6 BARE GROUND ENTRANCE: 2" NIPPLE DOWN METAL WIRING: MC CABLE W/ #12 (#6 AT HVAC) LIGHTS: (20) 48" T-8 (3) TUBE 32 WATT FLOUR. FIXTURES (92 FIXTURE WATTS) (2) PHOTO CELL EXTERIOR 13 WATT @ 860 LUMENS = 66 LUMEN PER WATT (2) 24" T-8 U-TUBE 32 WATT FLOUR. FIXTURES (38 FIXTURE WATTS) FANS: (2) 90 CFM EXHAUST IN BATHROOM VENT THRU ROOF NUTONE 671R SURGE PROTECT: OPTIONAL EXIT/EMERG. LIGHT: (2) EXIT/EMERGENCY LIGHT BATTERY BACK UP. RECEIPTS: (12) STD. 120V DUPLEX RECEP (2) GFCI 120V STD. DUPLEX RECEPTACLES (1) W.P. EXT. GFCI 120V RECEPTACLE SWITCHES: 4 SINGLE POLE 120V J-BOXES: (2) J-BOXES FOR FULL STATIONS BY CUSTOMER - ALL PLATES TO BE IVORY ALARM: N/A MSC: GROUNDING ON SITE TO BE PER NEC 2002, 250-96

PLUMBING: WATER SUPPLY: TYPE "L" COPPER WASTE: PVC SCHEDULE 40 WATER HEATER: (1) EMAX SP65 SUPPLY TO BOTH SINKS WITH SET OF 105-110F DEGREE WATER CLOSET: (2) HANDICAP FLUSH VALVE ELONGATED L/HANDLE LAVATORY: HANDICAP WALL HUNG, COVER UNDERNEATH HANDLES BAR SINK: N/A ACCESSORIES: 36" AND 42" GRAB BARS, TOILET PAPER HOLDER NOTE: ALL FIXTURE MOUNTING PER TAS 1994

HVAC: HVAC: (2) 3 TON WITH 10KW HEAT STRIP W/ 60AMP OUTSIDE DISCONNECT. BRAND: BARD COLOR: TAN EFFICIENCY: SEER 10.6, EER 9.2 > MINIMUM SEER 9.7 PER 2003 IECC TABLE 803.2.2 (1) THERMOSTAT: (2) PROGRAMABLE DUCTS: DUCT BOARD MAIN, FLEX TO GRILLS IN UNCOND. SPACE R-4.3 MIN. VALUE SUPPLY REGISTERS: 24X24 W/ ADJUSTABLE DIFFUSERS RETURN REGISTERS: AT FLENUM WALL WITH GRILL MSC: FRESH AIR MAKEUP IS PROVIDED BY DAMPER IN HVAC AND OPENABLE WINDOWS DISCONNECT: EXTERIOR 60AMP WITH IN 6' OF REACH BALANCE: SYSTEM TO BE BALANCED IN THE FIELD BY OTHERS.

FURNITURE OR MISC: 5LB ABC FIRE EXTINGUISHER IN CABINET NEAR ENTRANCE

TELECOM: PROVIDED J-BOXES W/ FULL WIRE FOR INTERCOM TELECOM BY OTHERS

TRANSPORTATION:		
7/16	ROOF DECK	0.0416667
18-12 LVL	ROOF RAFTER	1.5
0	UNDERSIDE RAFTER	0
10'-1 1/8"	TALLEST WALL	10.1
0		0
3/4"	FLOOR DECK	0.0625
2X8	FLOOR JOIST	0.6041667
2'-6"	TO ROAD APPROX	2.5
TOTAL		14.808333 FT
WEIGHT APPROX.		39480 LBS

ENERGY CODE COMPLIANCE COMCHECK CERTIFICATES TO BE USED AS CHECKLIST. 3 TUBE LIGHT FIXTURE IS 92 FIXTURE WATTS EXTERIOR LIGHT IS 13 WATT @ 860 LUMENS = 66 LUMEN PER WATT. WINDOWS ARE U=.51 AND SHGC=.34 OR BETTER DOOR U VALUE IS DEFAULT .7

DRAWING INDEX: G-001 = COVER A-101 = FLOOR PLAN A-201 = EXTERIOR ELEVATIONS A-301 = SECTION E-101 = ELECTRICAL PLAN A-601 = ADA (TAS) M-101 = MECHANICAL (HVAC) PLAN P-101 = PLUMBING PLAN SF-101 = FLOOR FRAMING PLAN SF-102 = FLOOR DECKING/WALL LAYOUT PLAN SF-103 = ROOF FRAMING PLAN SF-201 = ROOF FRAMING LONG. SECTION S-101 = BLOCKING PLAN

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NORTEX MODULAR SPACE

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TEXAS INDUSTRIALIZED BUILDING CODE COUNCIL

This document is approved pursuant to the Texas Industrialized Housing and Building Act

DRA No. 7 IBC IRC

Date MAR 27 2008

DRA Signature



NOTE: ALL NAILING PATTERNS SHOWN ON SF PAGES SHALL OVERRIDE DESIGN MANUAL.

LTR	REVISION	BY	DATE	DRAWN BY: JPW	PROJECT: 2460 CLASSROOM STOCK	TITLE: COVER SHEET AND SPECIFICATIONS
				DATE: 03/19/2008	SCALE: N.T.S.	DWG# 2460CLASS-STK
					SALES PERSON: DARRY MICHIE	SHEET: G-001

AREA SCHEDULE						
DESIGNATION	DESCRIPTION	FLOOR AREA	FLOOR	WALL	CEILING	BASE
100	CLASSROOM	610 EA	CARPET	3/8" VINYL COVERED GYPSUM TYPE X	2"X4" LAY IN	4" RUBBER BASE
101	BATHROOM	56 EA	TILE	FRP OVR 3/8" GRN GYP (2 WALLS) TYPE X-VCG RMDR	2"X4" LAY IN	4" RUBBER BASE


WINDOW SCHEDULE			
DESIGNATION	DESCRIPTION	RD	QTY
W1	2044 ALUMINUM BRONZE FRAME, DOUBLE INSULATED LOW E GLASS W/ ALUMINUM MINI BLINDS	24 1/2" X 52 1/2"	4


DOOR SCHEDULE					
DESIGNATION	SIZE	DOOR MATERIAL	FRAME	RD	QTY
D1	3068L	STEEL W/ PENCIL VISION	STEEL	40 1/2" X 82 1/2"	1
D2	3068R	STEEL W/ PENCIL VISION	STEEL	40 1/2" X 82 1/2"	1
D3	3068L	1-3/4" SC MOHAWK	STEEL	37 1/4" X 81 1/4"	1
D4	3068R	1-3/4" SC MOHAWK	STEEL	37 1/4" X 81 1/4"	1

Texas Industrialized
Building Code Council
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MAR 27 2008

Approved
PFS Corp.
IHDRA 7



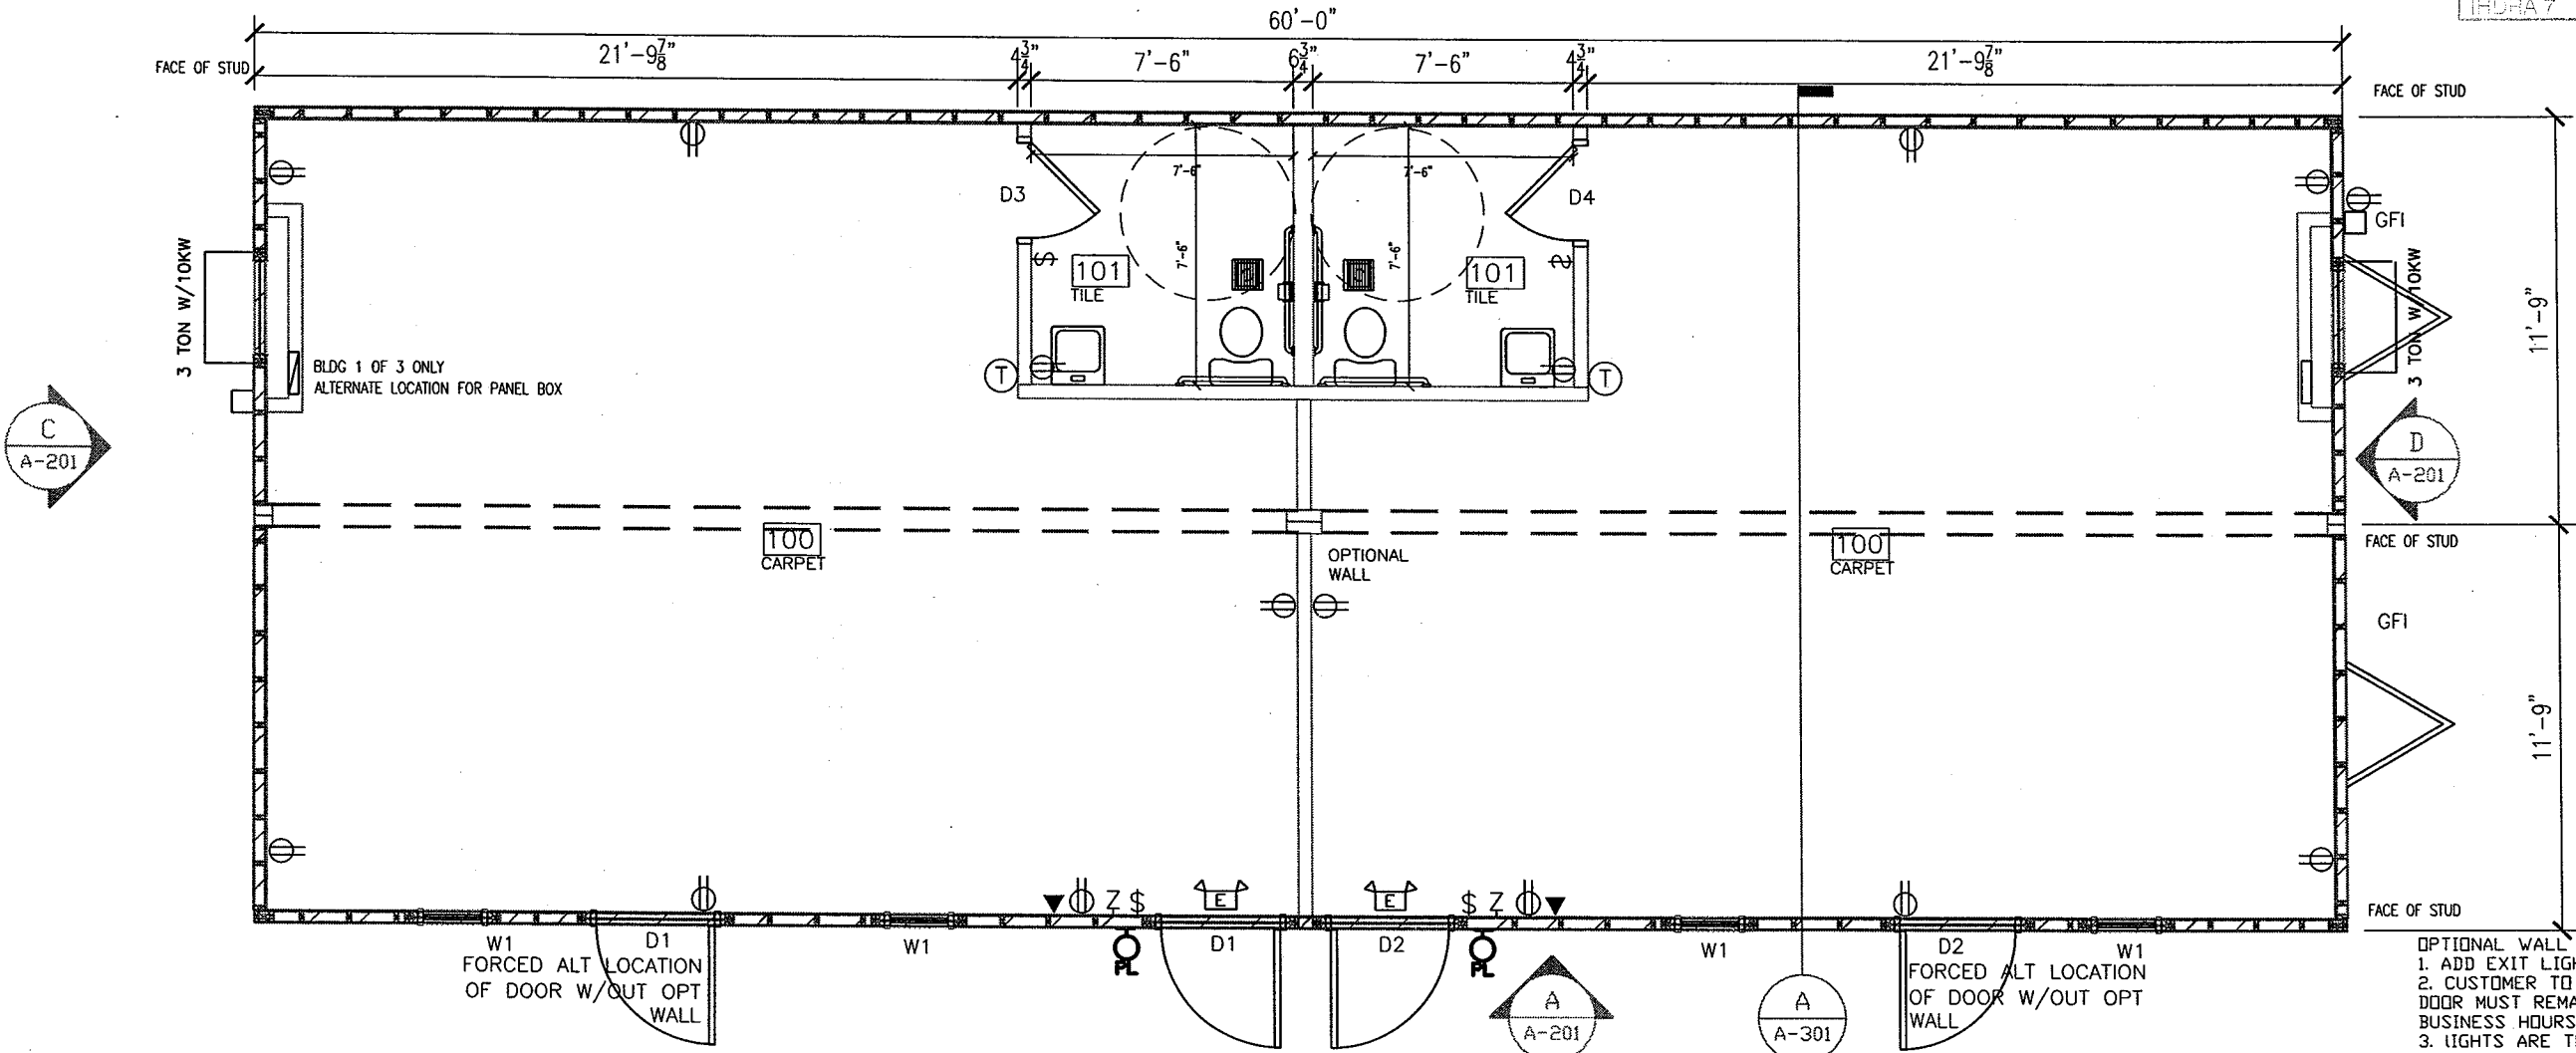

FLOOR PLAN
3/16" = 1'-0"


- OPTIONAL WALL NOTES:
1. ADD EXIT LIGHTS ON BOTH SIDES OF DOOR.
 2. CUSTOMER TO SUPPLY A SIGN THAT THE DOOR MUST REMAIN UNLOCKED DURING BUSINESS HOURS.
 3. LIGHTS ARE TO BE CHANGED TO SINGLE POLE SWITCH, EACH CONTROLLING (4) LIGHTS IN IT'S RESPECTIVE HALF.

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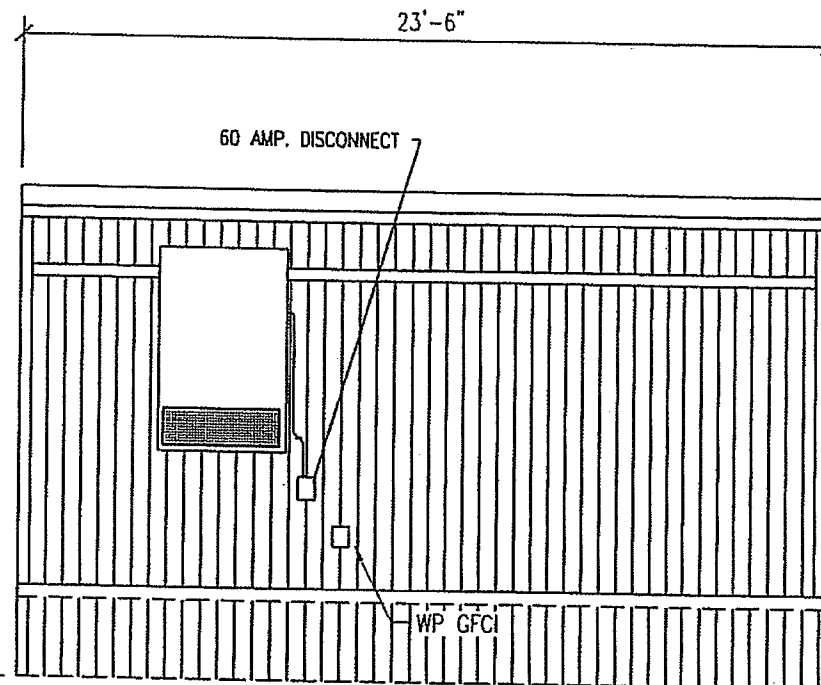
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				JPW	2460 CLASSROOM STOCK	FLOOR PLAN
				DATE:	SCALE:	DWG#
				03/19/2008	3/16=1'-0"	2460CLASS-STK
					SALES PERSON:	SHEET:
					DARRY MICHIE	A-101





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C RIGHT END ELEVATION
3/16" = 1'-0"

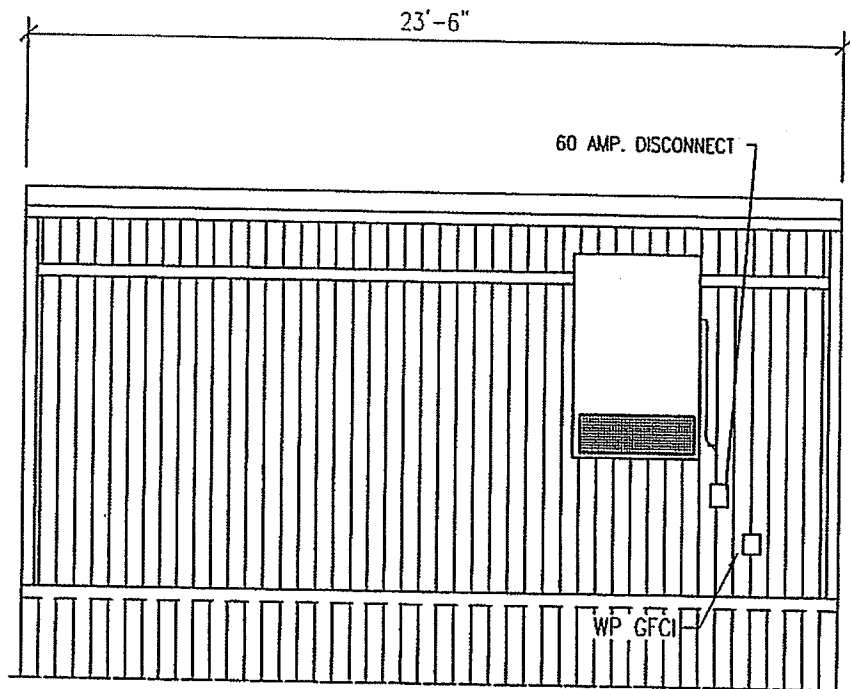

D LEFT END ELEVATION
3/16" = 1'-0"




A FRONT ELEVATION
3/16" = 1'-0"

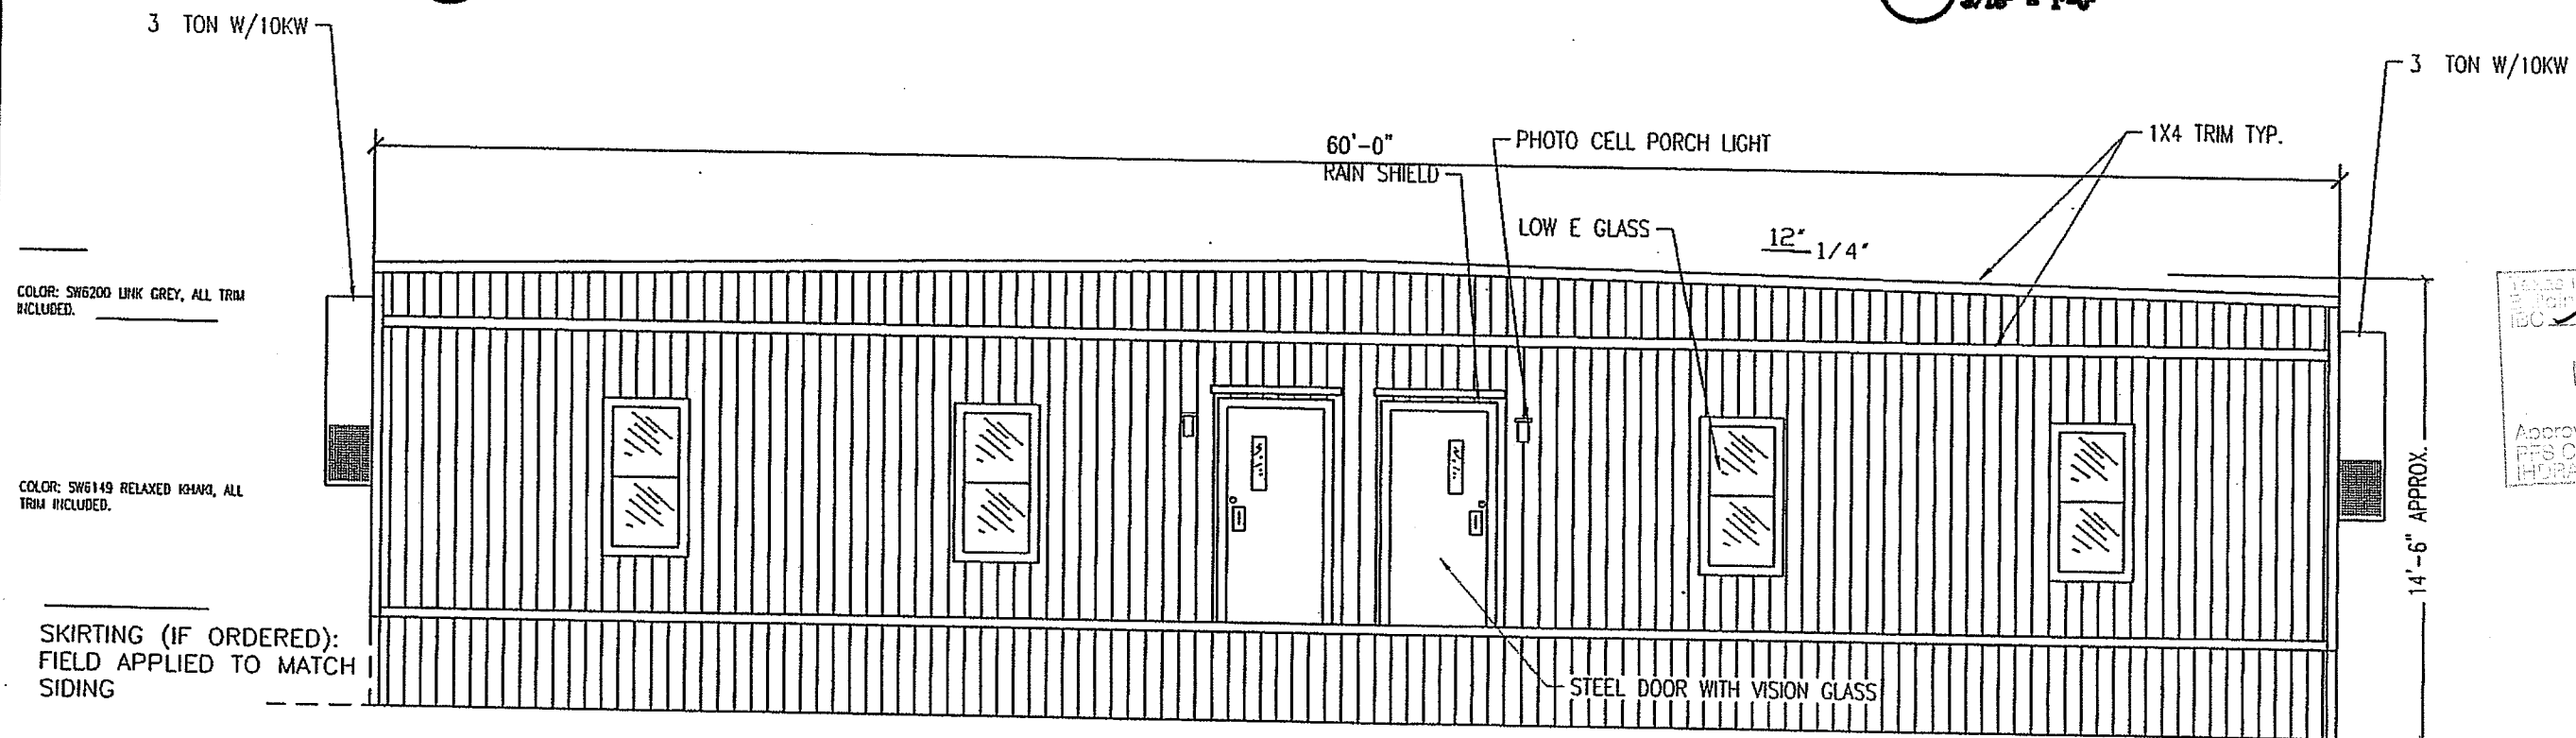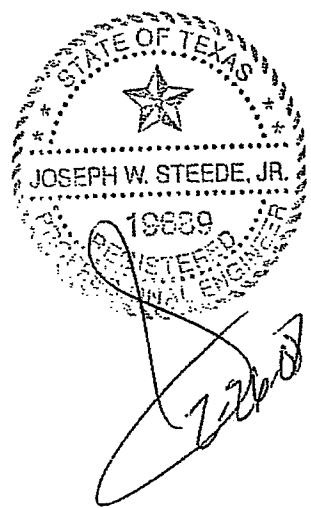COLOR: SW6200 LINK GREY, ALL TRIM INCLUDED.

COLOR: SW6149 RELAXED KHAKI, ALL TRIM INCLUDED.

SKIRTING (IF ORDERED):
FIELD APPLIED TO MATCH SIDING

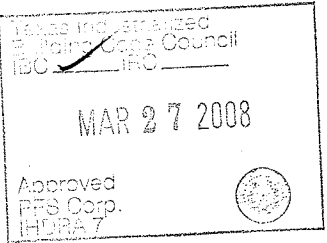

LTR	REVISION	BY	DATE	DRAWN BY:	PROJECT:	TITLE:	DWG#	SHEET:	
				JPW	2460 CLASSROOM STOCK	ELEVATIONS	2460CLASS-STK	A-201	
			02/13/2008	DATE:	SCALE: 3/16"=1'-0"	SALES PERSON:			
				DARRY MICHIE					

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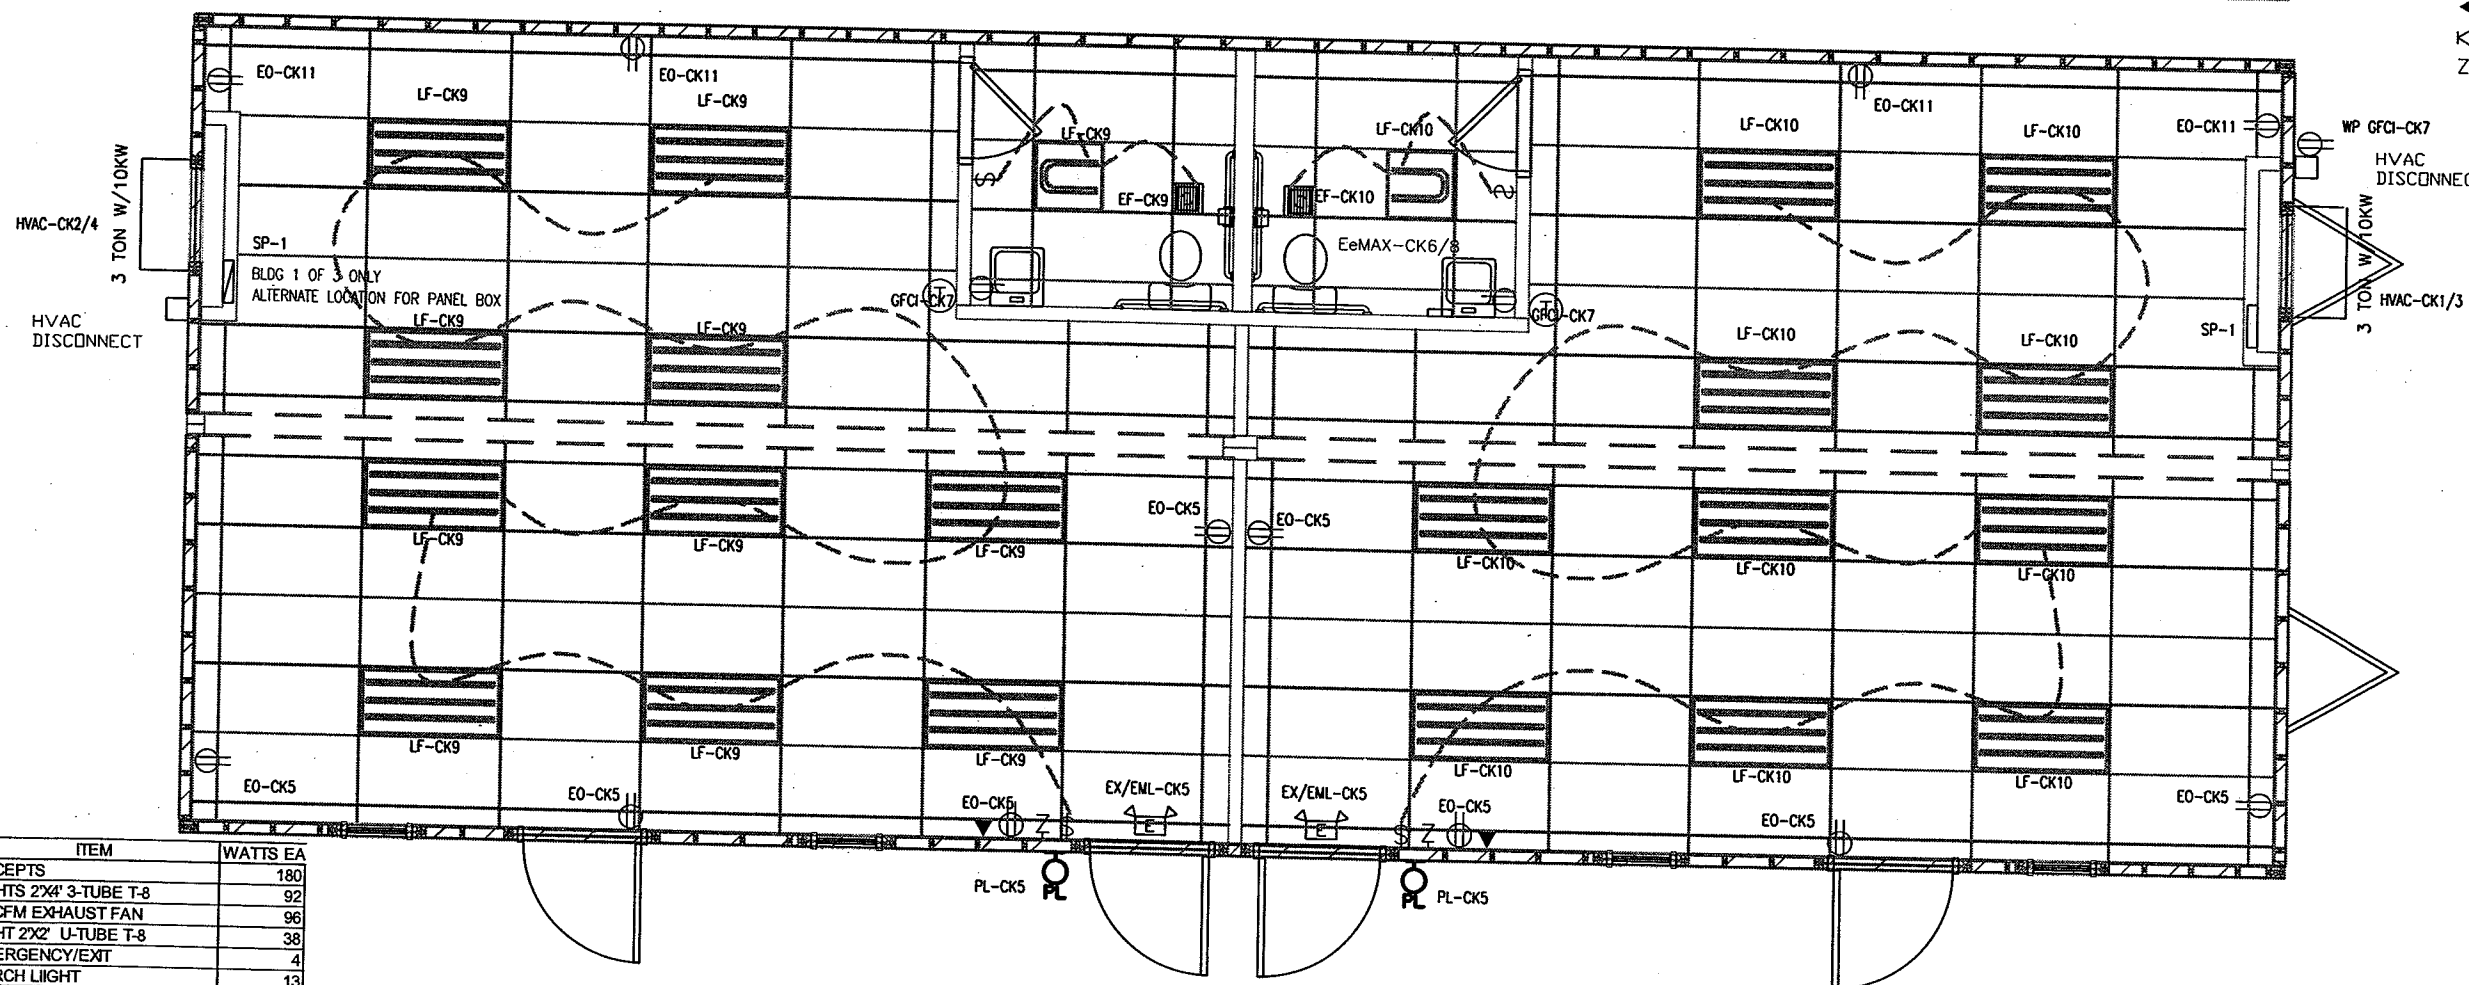
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PANEL MARKUP, WIRE AND BREAKER SIZING.

MIN WIRE SIZE		225 AMP 2-POLE 120V/240V MAIN BREAKER SINGLE PHASE							MIN WIRE SIZE
		"A"			"B"				
		BREAKER	LEG	CKT	CKT	LEG	BREAKER		
6	HVAC	60	A	1	2	A	60	HVAC	6
		2P	B	3	4	B	2P		
12	RECEPTS	20	A	5	6	A	30	Ee-MAX	10
12	GFCI RECEPTS	20	B	7	8	B	2P		
12	LIGHTS	20	A	9	10	A	20	LIGHTS	12
12	RECEPTS	20	B	11	12	B			
								NOT USED	

PANEL SP-1 225 AMP 2-POLE 120V/240V SINGLE PHASE MAIN BREAKER CALCULATIONS					
LEG	CKT	DESCRIPTION	LEG A-AMPS	LEG B-AMPS	LEG A-WATTS
A	1	HVAC	59.00		7,080.00
A	2	HVAC	59.00		7,080.00
B	3	HVAC		59.00	7,080.00
B	4	HVAC		59.00	7,080.00
A	5	RECEPTS, PORCH, EMG	12.00		1,440.00
A	6	Ee-MAX	22.90		2,748.00
B	7	GFCI RECEPTS		4.50	540.00
B	8	Ee-MAX		22.90	2,748.00
A	9	LIGHTS	8.81		1,057.20
A	10	LIGHTS	8.81		1,057.20
B	11	RECEPTS	6.00		720.00
B	12				
			176.52	145.40	21,182.40
					17,448.00
		AMPS	176.52		
		W /20%	211.82		
		225AMP	OK		
		TOTALS			38,630.40 WATTS
					46,356.48 W/ 20%
					3,734.40 WATTS
					8.06% OK
					193.15 AMPS

- SS SURGE PROTECTOR
- CL CAN LIGHT LIGHT
- 2'X4' TROUFFER LIGHT T-8 ELEC. BALLAST, 3-BULB
- EMERGENCY EXIT LIGHT
- PORCH LIGHT
- \$ SINGLE POLE LIGHT SWITCH
- \$s OCCUPANCY SENSOR SWITCH
- \$d DIMMER SWITCH
- \$ 3WAY SWITCH
- ⊕ DUPLEX OUTLET
- ⊕ SBD SURGE BLOCK OUTLET
- ⊕ WP WEATHER PROOF DUPLEX GROUND
- ⊕ WP FAULT INTERRUPT OUTLET
- ⊕ GFCI
- ⊕ CO CEILING OUTLET
- ◀ DATA DROP
- ◀ VOICE DROP
- Z J-BOX FOR FIRE PULL STATION



- NOTES:
1. MOUNT ALL OUTLET BOXES TO 16" AFF TO TOP OF BOX.
 2. IF OPTIONAL WALL IS INSTALLED, PUT (5) LIGHTS FOR EACH ROOM ON A SINGLE POLE SWITCH.
 3. INSTALL JUNCTION BOXES IN THE CEILING FOR POSSIBLE EXIT LIGHTS ON BOTH SIDES OF DOOR ON CIRCUIT #4 IF DIVIDER WALL IS INSTALLED.
 4. 3-TUBE LIGHT FIXTURE IS FIGURED AS 92 FIXTURE WATTS AND THE (1)U TUBE FIXTURE AS 38 WATTS.

ELECTRICAL PLAN 3/16" = 1'-0"


AMPS EA	ITEM	WATTS EA
1.5	RECEPTS	180
0.77	LIGHTS 2'X4' 3-TUBE T-8	92
0.8	90 CFM EXHAUST FAN	96
0.31	LIGHT 2'X2' U-TUBE T-8	38
0.0333333	EMERGENCY/EXT	4
0.1083333	PORCH LIGHT	13
22.9	EeMAX	2633.5
59	HVAC	7080
		0
		0
		0

LTR	REVISION	BY	DATE	DRAWN BY:	PROJECT:	TITLE:
				JPW	2460 CLASSROOM STOCK	ELECTRICAL
				DATE:	SCALE:	DWG#
			02/11/2008		3/16"=1'-0"	2460CLASS-STK
				SALES PERSON:		SHEET:
				DARRY MICHE		E-101


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NORTEX MODULAR SPACE


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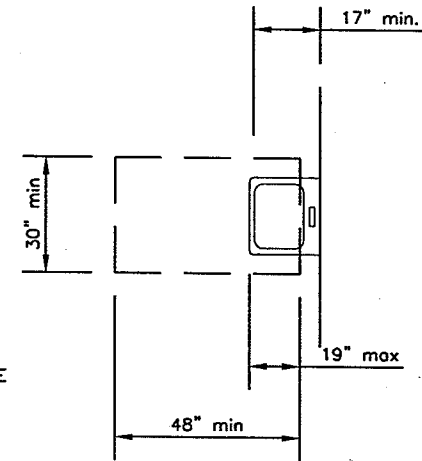
WATER CLOSET
SIDE VIEW

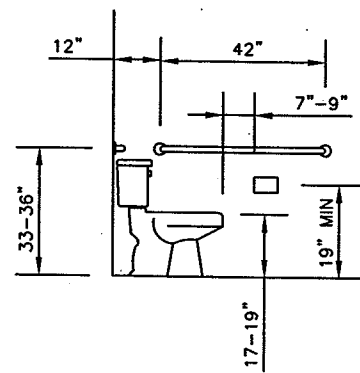


WATER CLOSET
FRONT VIEW

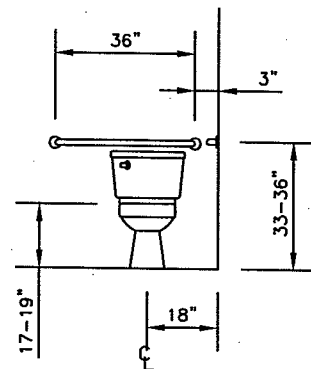

LAV CLEARANCES

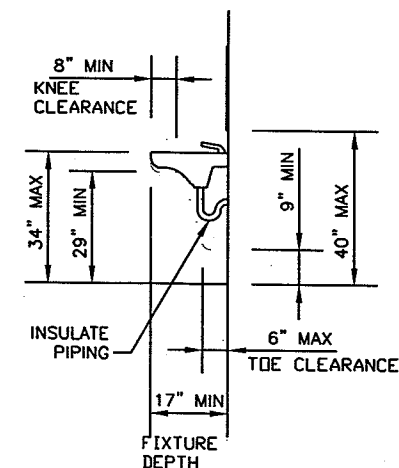



CLEAR FLOOR SPACE
AT LAVATORIES

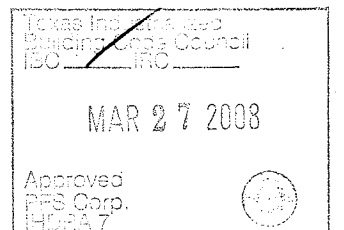

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
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				JPW	2460 CLASSROOM STOCK	ADA (TAS) DETAILS
				DATE:	SCALE:	DWG#
			03/19/2008		1/4"=1'-0"	2460CLASS-STK
					SALES PERSON:	SHEET:
					DARRY MICHIE	A-601




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Council
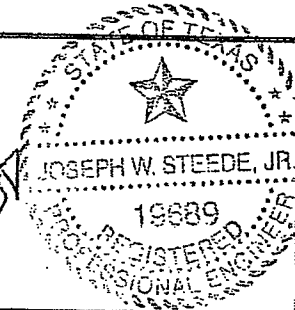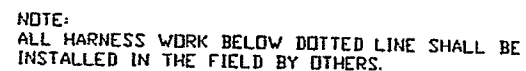
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2008





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				DATE: 02/15/2008	SCALE: 3/16"=1'-0"	SALES PERSON: DARRY MICHIE	DWG# 2460CLASS-STK	SHEET: P-101		

MECHANICAL SCHEDULE		
DESIGNATION	DESCRIPTION	COMMENTS
SA1	2X2 SUPPLY AIR REGISTER	ADJUSTABLE
RA1	RETURN GRILL AT PLENUM WALL	NONE
T	THERMOSTAT	PROGRAMMABLE
3 TON W/10KW	BARD MODEL	

OCCUPANTS	65
CFM REQ'D EACH	15 CFM
TOTAL OUTSIDE REQD	975 CFM

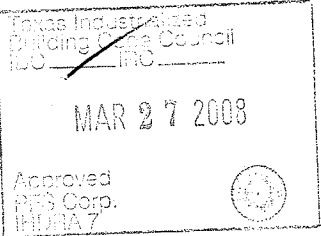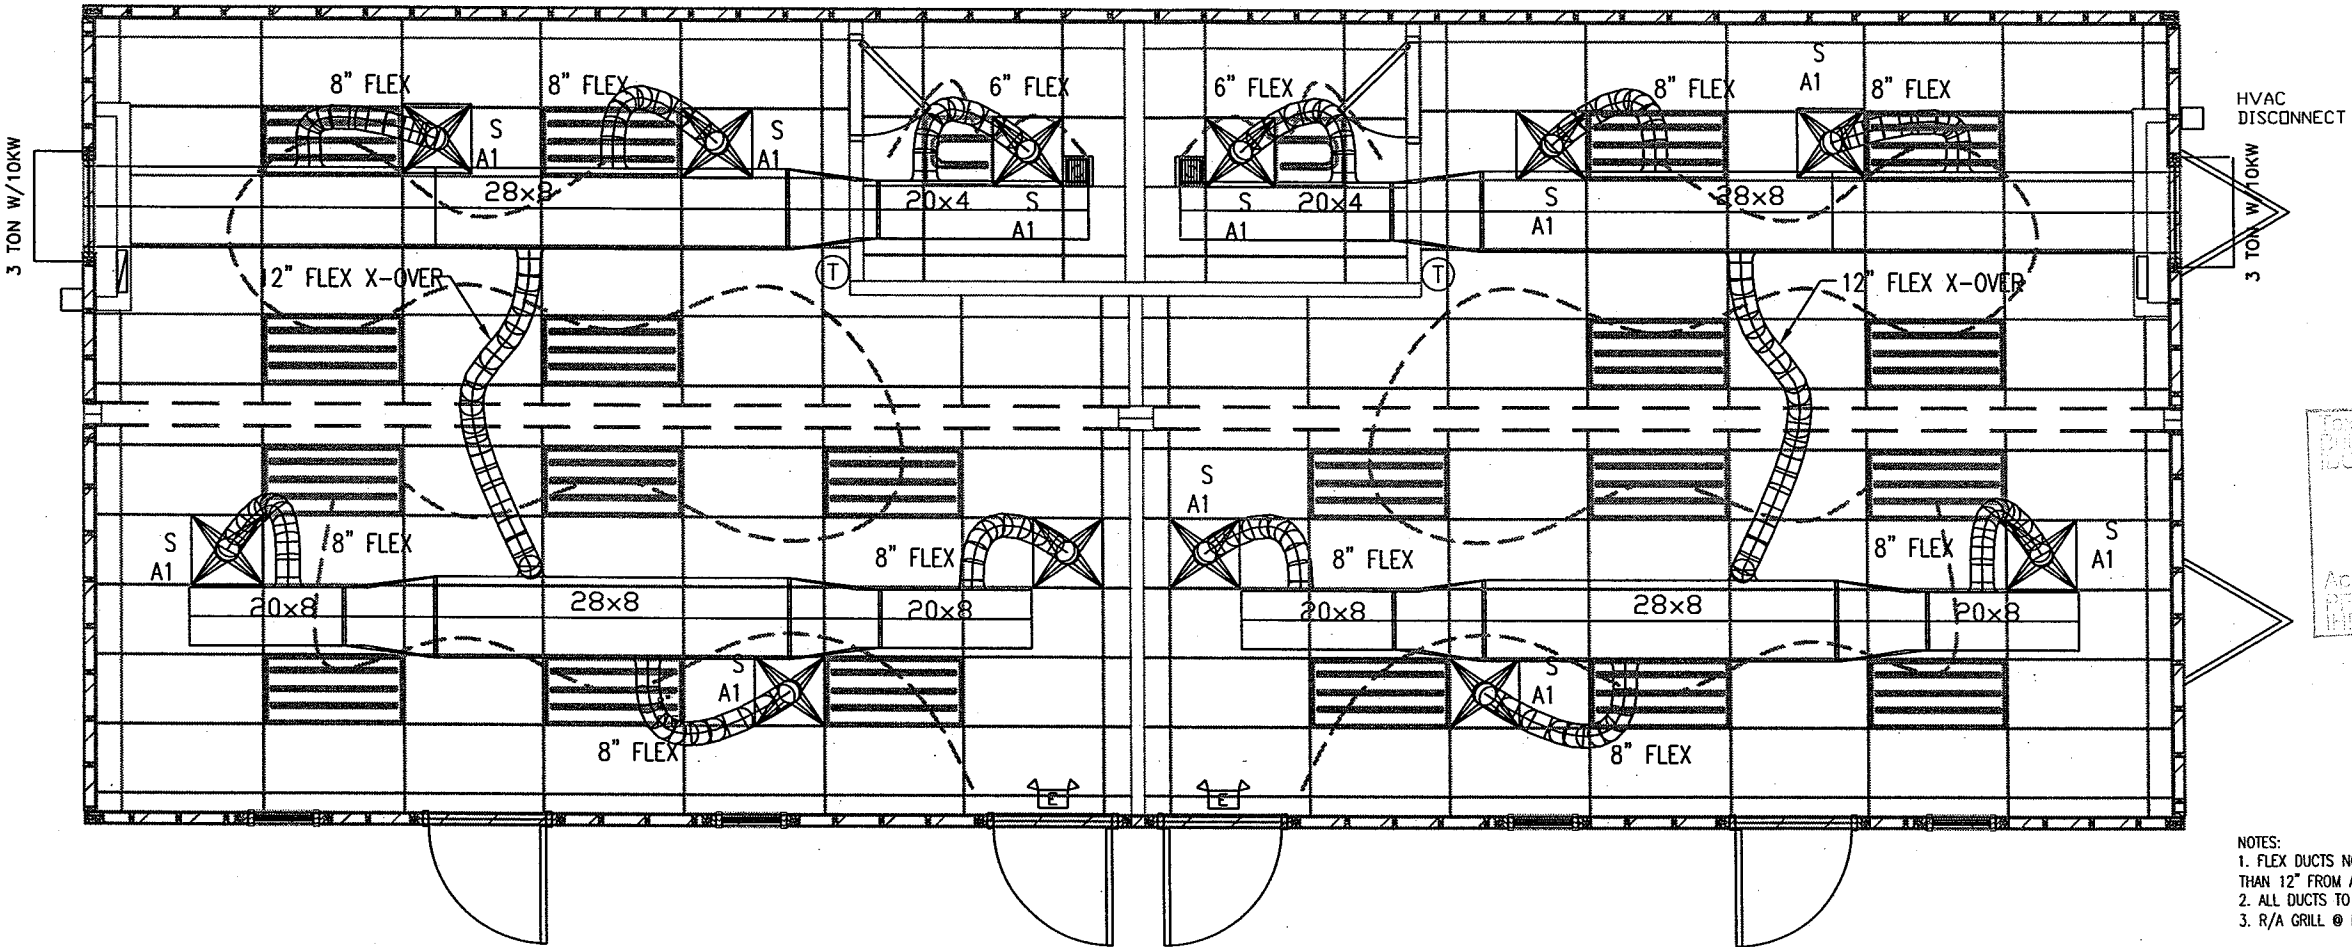

- NOTES:
1. FLEX DUCTS NOT TO BE CUT INTO MAIN DUCT LESS THAN 12" FROM A TRANSITION.
 2. ALL DUCTS TO HAVE A R-4.3 MINIMUM VALUE.
 3. R/A GRILL @ PLENUM IS 30"x 16" MINIMUM

MECHANICAL PLAN
3/16" = 1'-0"



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DALLAS, TX 75250 PHONE 972-238-1611

LTR	REVISION	BY	DATE	DRAWN BY:	PROJECT:	TITLE:	DWG#	SHEET:
				JPW	2460 CLASSROOM STOCK	MECHANICAL	2460CLASS-STK	M-101
				DATE:	SCALE:	SALES PERSON:		
				03/19/2008	3/16"=1'-0"	DARRY MICHIE		




NORTEX MODULAR SPACE


555 JUBILEE LANE
LEWISVILLE, TX 75056
PHONE: 972-492-4040
FAX: 972-492-2704

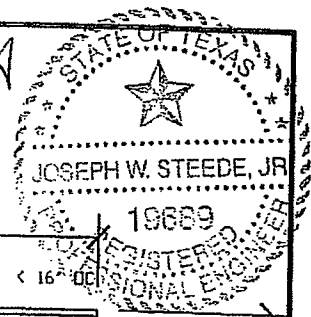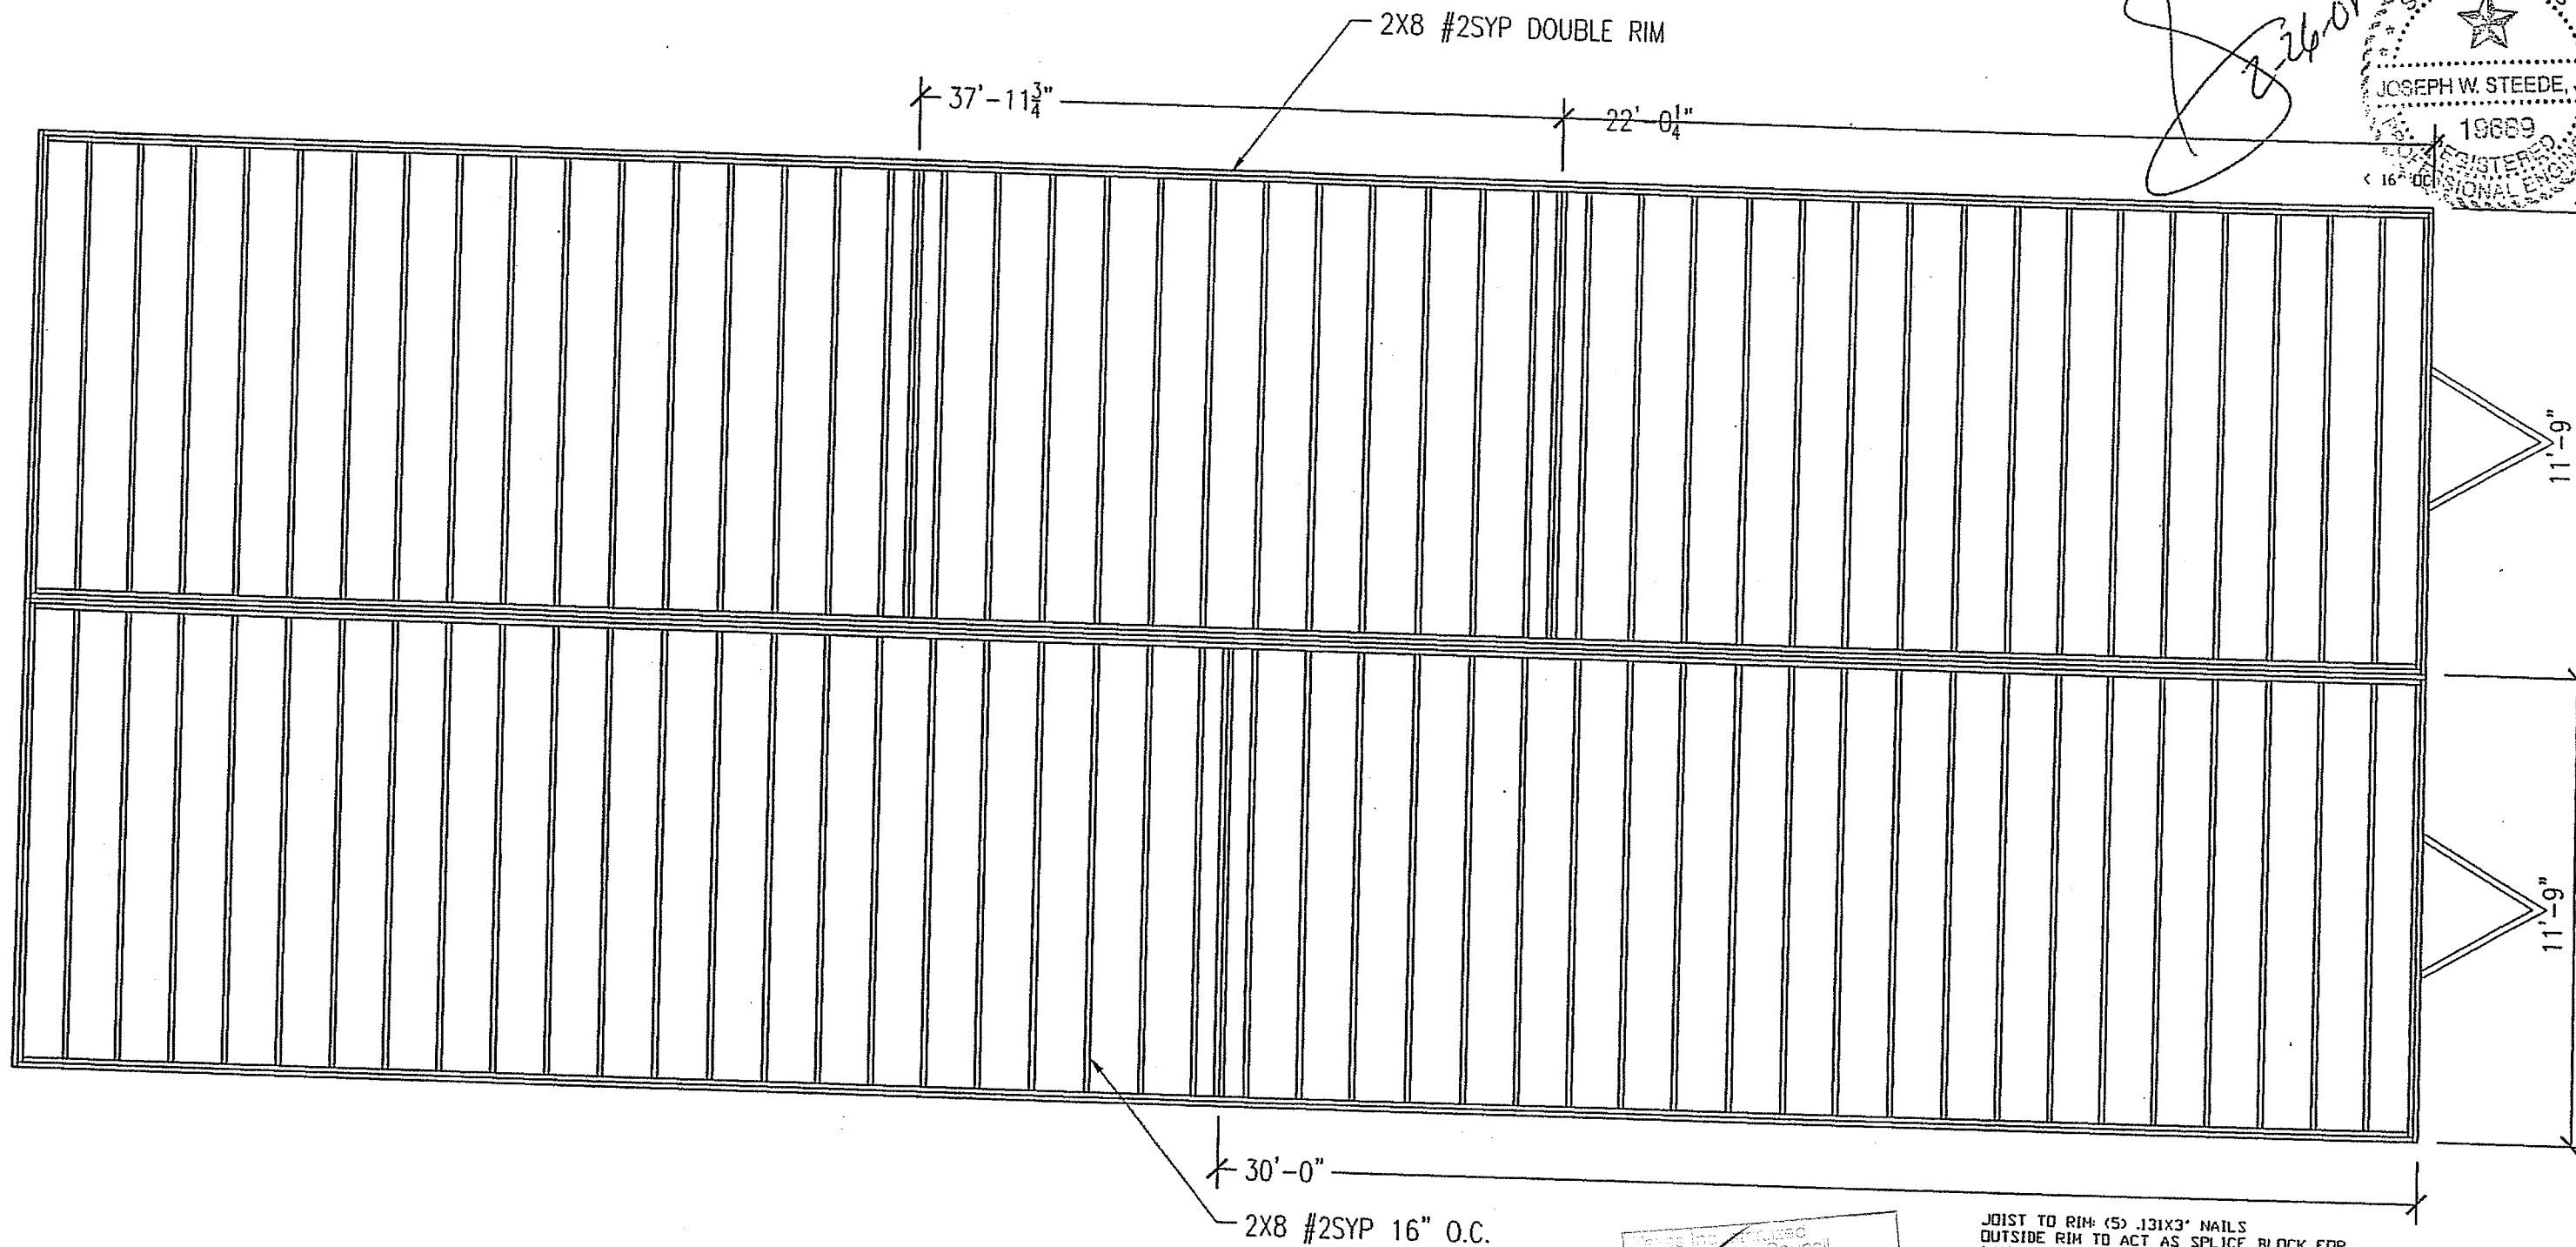


FLOOR JOIST PLAN
1/4" = 1'-0"

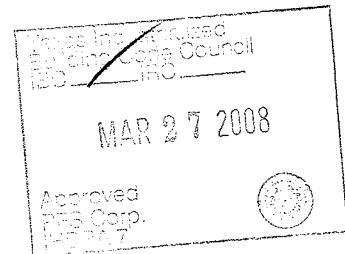


LTR	REVISION	BY	DATE	DRAWN BY:	PROJECT:	TITLE:	DWG#	SHEET:	NOTES
				JPW	2460 CLASSROOM STOCK	FLOOR JOIST PLAN	2460CLASS-STK	SF-101	
			02/11/2008		SCALE: N.T.S.				
					SALES PERSON: DARRY MICHIE				
									JOE STEEDE, P.E. 13999 GOLDMARK, SUITE 374 DALLAS, TX 75250 PHONE 972-238-1611 NORTEX MODULAR SPACE 555 JUBILEE LANE LEWISVILLE, TX 75056 PHONE: 972-492-4040 FAX: 972-492-2704

LTR	REVISION	BY	DATE	DRAWN BY: JPW	PROJECT: 2460 CLASSROOM STOCK	TITLE: ROOF JOIST PLAN		NORTEX MODULAR SPACE 555 JUBILEE LANE LEWISVILLE, TX 75056 PHONE: 972-492-4040 FAX: 972-492-2704
				DATE: 02/11/2008	SCALE: 3/16"=1'-0"	SALES PERSON: SF-103		

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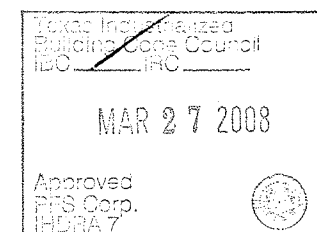


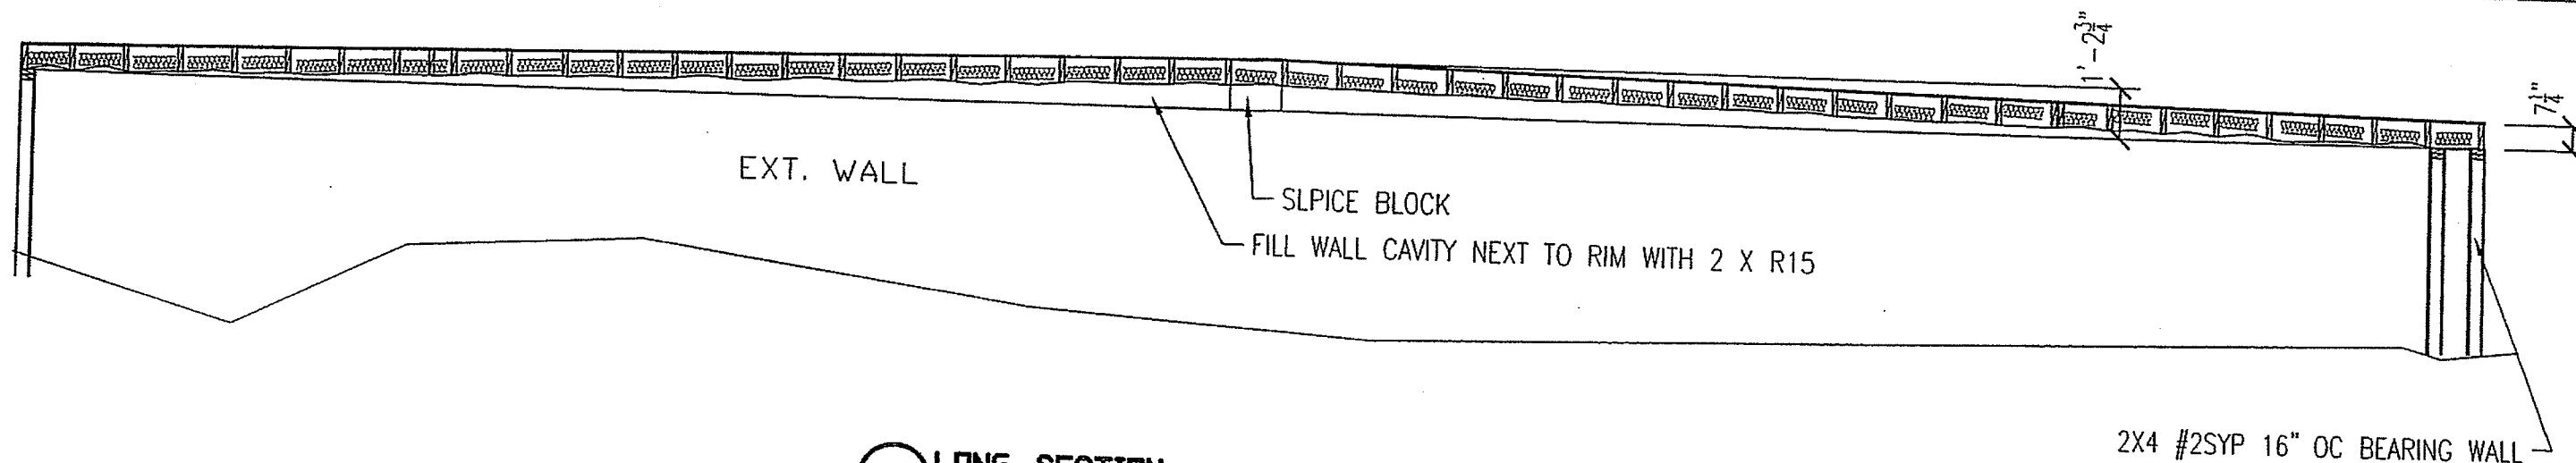1 LONG. SECTION
1/4" = 1'-0"

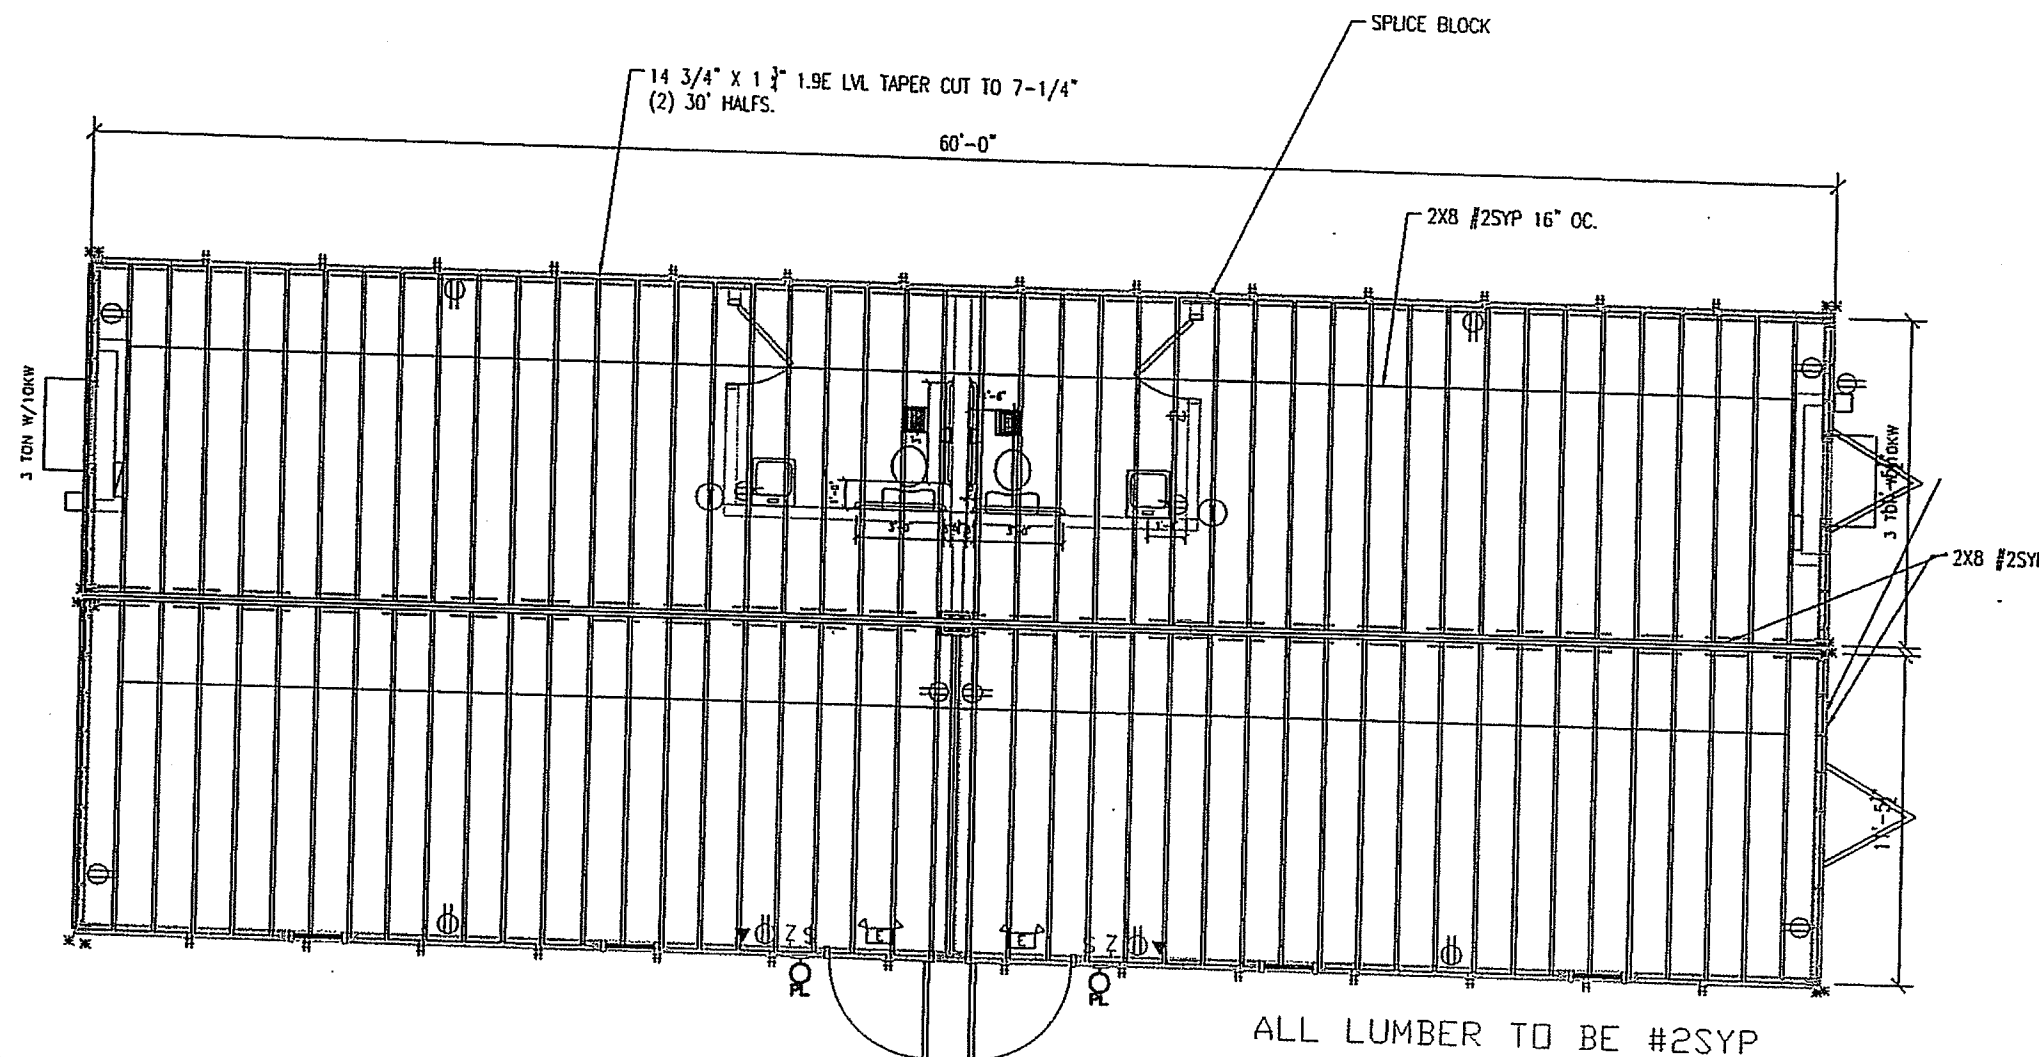

2-26-08

* ST-2122
STRAP
20GA.
STRAP



LTR	REVISION	BY	DATE	DRAWN BY:	PROJECT:	TITLE:	DWG#	SHEET:
				JPW	2460 CLASSROOM STOCK	LONG SECT.	2460CLASS-STK	SF-201
			02/11/2008	DATE:	SCALE: 1/4"=1'-0"	SALES PERSON:		
					DARRY MICHIE			



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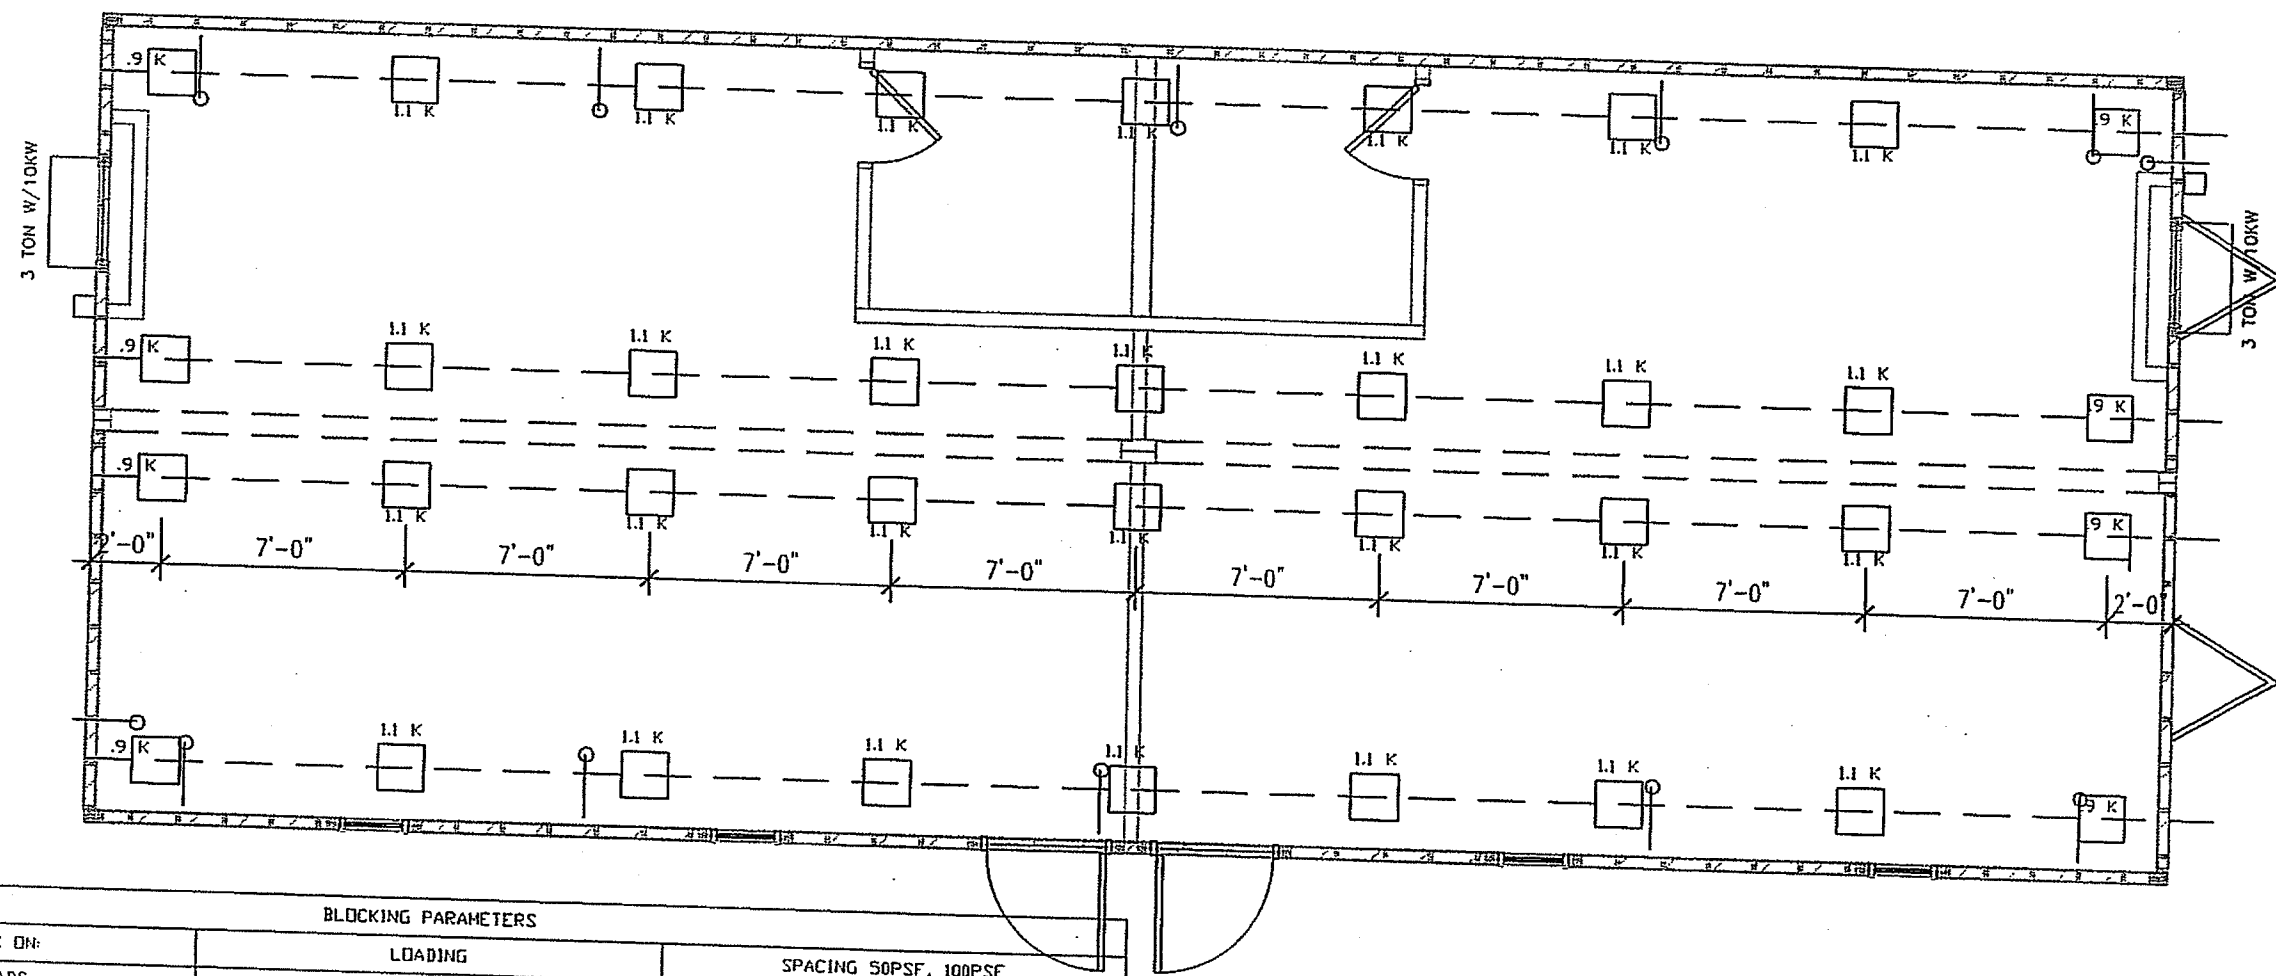
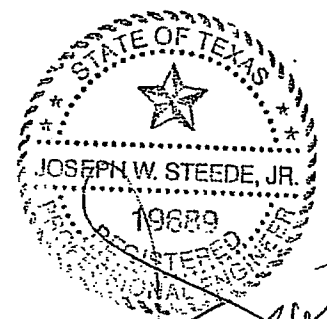
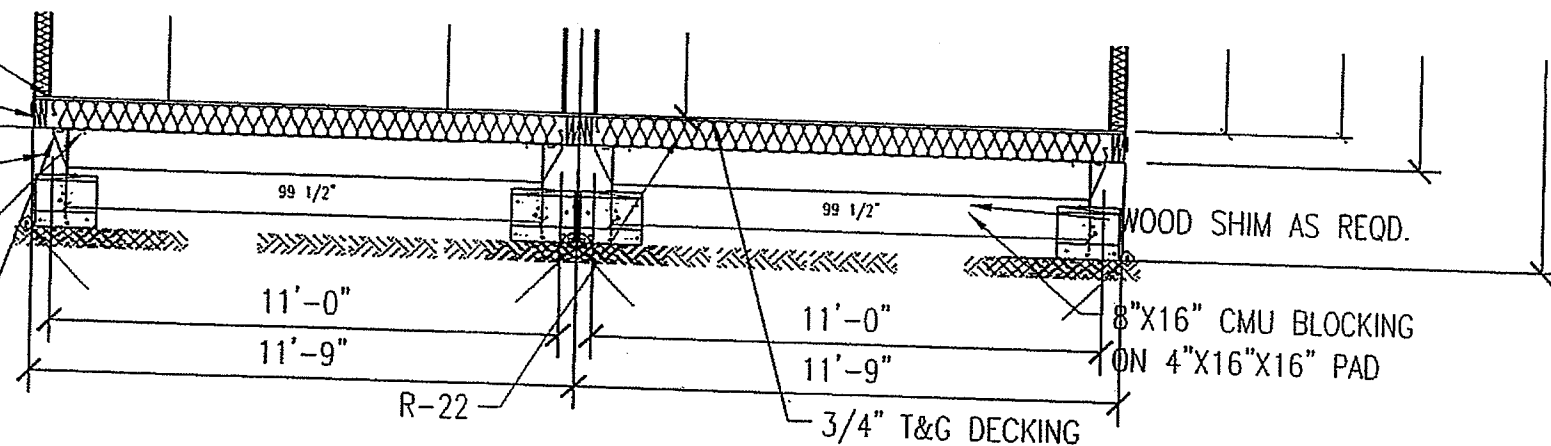
NORTEX MODULAR SPACE
555 JUBILEE LANE
LEWISVILLE, TX 75056
PHONE: 972-492-4040
FAX: 972-492-2704

(1) 2X4 #3SPF OR BETTER BOTTOM PLATE
(2) #2SYP RIM JOIST

OVER ROOF STRAP

3/8" LAG EACH OUTRIGGER

LAG FRAME CLIP 4'O.C. AND AT AXLES



Approved
MAR 27 2008
P.E. Corp.
19689

NOTES:
1. SOIL ASSUMED AT 2500PSI
2. PAD SPACING SHOWN IS FOR 50PSF FLOOR LOADS. 100PSF=3' O.C.
3. ANY ADDITIONAL TIE STRAPS REQUIRED BY LOCAL AUTHORITIES WILL BE FRAME TIE STRAPS.
4. STRAPS ARE (5) PER 60' SIDE STARTING APPROX 2' FROM EACH END, THEN EQUALLY SPACED AND MAY BE +/- 1'-0" AND (1) PER 23.5' SIDE.

BLOCKING PARAMETERS		
SET BLOCKS ON:	LOADING	SPACING 50PSF, 100PSF
16X16X4 PADS	50 PSF, 100 PSF	7'-0" O.C., 4'-8" O.C.
20X20 ABS PADS	50 PSF, 100 PFS	11'-0" O.C., 7'-6" O.C.
24" DRILLED AND POURED FOOTINGS	50 PSF, 100 PSF	12'-5" O.C., 8'-6" O.C.

BLOCKING PLAN 3/16" = 1'-0"

LTR	REVISION	BY	DATE	DRAWN BY:	PROJECT:	TITLE:	DWG#	SHEET:
				JPW	2460 CLASSROOM STOCK	BLOCKING PLAN	2460CLASS-STK	S-101
			02/26/2008		N.T.S.	SALES PERSON:		
					DARRY MICHIE			



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