

DESIGN CRITERIA:

PROJECT NAME: NORTEX STANDARD 1460
BUILDING SQUARE FOOTAGE: 825 SF
2002 NEC
2003 IBC
2003 IMC
2003 IPC
2003 IECC
1994 TAS
USE GROUP: B
CONSTRUCTION TYPE: IBC: V-B
OCCUPANT LOAD: 8
PERMISSIBLE GAS TYPE: LP NATURAL N/A

DESIGN LOADS:

ROOF LIVE LOAD: 20 PFS
FLOOR LIVE LOAD: 50 PFS
CONC. FLOOR LIVE LOAD: 2000 LBS
WIND LOAD: (90 MPH 3-SEC GUST)
EXPOSURE: B
SEISMIC DESIGN CATEGORY: B

SPECIAL CONDITIONS AND/OR LIMITATIONS:

1. HANDICAP ACCESS TO BE PROVIDED PER 1994 TAS AS REQUIRED BY OTHERS.
2. BUILDING TO BE LOCATED PER TABLE 602 OF THE 2003 IBC.
3. ANY REQUIRED ALARM SYSTEM WILL BE INSTALLED ONSITE BY OTHERS.
4. WATER FOUNTAIN SHALL BE FURNISHED BY OTHERS PER IPC-2003 TABLE 403.1.
5. RAFTER SPACE VENTILATION TO BE IN ACCORDANCE WITH REQUIREMENTS OF THE LOCAL BUILDING OFFICIAL.

FOUNDATION NOTES:

1. TIE DOWN ANCHORING SEE SHEET S-101
2. CRAWL SPACE VENTILATION PROVIDED BY SITE INSTALLER PER 1203.3.1 OF 2003 IBC.

SCOPE OF WORK:

NOT INCLUDED IN SCOPE OF WORK
1. UTILITIES AND UTILITY CONNECTIONS
2. POURED CONCRETE (DRIVEWAY, SIDEWALK, SLABS, FOOTINGS, ECT.)
3. SITE PREPARATION
4. TAX OF ANY KIND
5. BUILDING PERMITS
SITE WORK
1. NO PROVISION FOR SITE WORK HAS BEEN INCLUDED. IT IS PRESUMED THE SITE WILL PROVIDE CLEAR ACCESS FOR TRUCKS AND MODULARS.
ADEQUATE DRAINAGE TO BE PROVIDED.
2. ALL ELECTRICAL, PLUMBING, SEWER, & GAS SERVICE CONNECTIONS AND ALL CONCRETE WORK ONSITE, TO INCLUDE POURED FOOTINGS, SLABS, FOUNDATIONS, SIDEWALKS, DRIVEWAYS OF WHATEVER KIND ARE THE RESONSIBILITY OF OTHERS.

IDENTIFICATION

STATE DECAL: TDLR DECAL AND MANUFACTURERS DATA PLATE ON ELECTRICAL PANEL.
DECAL: NORTEX PLACED ON FRONT LEFT OF BUILDING

FRAME / CHASSIS:

OUTRIGGERS: 48" O.C.
CROSSMEMBERS: 48" O.C.
BEAM: 12" JR. I-BEAM
HITCH: DETACHABLE HITCH
AXLES: (4) W/BRAKES ON TWO AXLES, DRAG ON TWO.
TIRES: L (12-PLY)
FRAME: HEAVY

FLOOR:

BOTTOM BOARD: ROLL, POLYETHYLENE FIBER MESH
INSULATION: R-19 FACED
JOIST: 2X8 #2SYP OR BETTER AT 16" O.C.
SIDEBAND JOIST (RIM): 2X8 #2SYP OR BETTER
DECKING: 3/4" T&G OSB(DRY GUARD), GLUED & ATTACHED W/ MIN. 2-1/4" SCREWS
UNDERLAYMENT: N/A
COVERING: 1/8" TILE: WHITE #51899; OFFICES 26OZ CARPET=SAND PEBBLES
BASE COVE: 4" RUBBER: COLOR= GREY

EXTERIOR WALLS:

SIDEWALL HIEGHT: FULL HIEGHT REFERENCE SHEET A-301
STUDS: 2X4 #2SYP 16"O.C. DOUBLE WHERE HEIGHT EXCEEDS 119.65"
BOTTOM PLATE: SINGLE 2X4 #2SYP
TOP PLATES: DOUBLE 2X4 #2SYP
HEADERS: DOUBLE 2X6 W/ 7/16" FILLER
JACK STUDS: SINGLE EACH SIDE 2X4 #2SYP
FIRE BLOCKING: 2X4 ON EDGE AT THE CEILING LINE
INSULATION: R-13 FACED
SHEATHING: NONE
SIDING: 3/8" SMART PANEL COLOR: SEE SHEET A-201
TRIM: 1X4 SMART PANEL COLOR: SEE SHEET A-201
SKIRTING: SHIP LOOSE (9) 4X12 SHTS SMART PNL PAINTED TO MATCH BODY IF ORDERED
IF SKIRTING IS ORDERED, 12"X12"VENTS TO BE SHIPPED WITH MATERIAL.

INTERIOR WALLS:

WALL HIEGHT: FULL HIEGHT
STUDS 2X4 #2SYP 16" O.C.
BOTTOM PLATE: SINGLE 2X4 #2SYP
TOP PLATES: DOUBLE 2X4 #2SYP
FIRE BLOCKS: 2X4 ON EDGE AT CEILING LINE
COVERING: 5/8" FIRE-X VCG COLOR: HAMTOM GRAY
5/8" GREEN BOARD AT RESTROOM COVERED WITH FRP
TRIM: STANDARD VCG BATTENS
FRP: 4' WAINSCOT AT RESTROOM
INSULATION: R-13 UNFACED THROUGHOUT.

WINDOWS:

SIZE/TYPE: (9) 24"X52" V.S. BRONZE FRAME/CLEAR LOW E GLASS
BRAND: HR MIN. ENERGY VALUES: U-FACTOR =.87 SHGC=.66
COVERING: (9)ALUMINUM MINI-BLINDS COLOR: GRAY
MISC: N/A

DOORS:

EXTERIOR: (2) 36"X80" 18GA STEEL W/ 5"X20" PENCIL WINDOW (TEMP)
EXTERIOR HARDWARE:
(2) DEADBOLT (SCHLAGE) B660 BD x 26D W/IC CONSTR. CORE
(2) 9305BC x AL NORTON CLOSURER
(2) HOLLOW METAL: FRAME
(4) PULL PLATES ROCKWOOD #107 x 70C X US28
(2) PEMCO THRESHOLD 170A-36
(2) PEMKO SWEEP 315CN-36
(2) SET PEMKO WEATHERSTRIP 303AV-3070
INTERIOR: (3) 36"X80" MOHAWK SOLID CORE DOORS 1R/1L W/ 5X20 PENCIL WINDOW

(3) 3680 REDIFRAMES 478 BROWN 20GA
(1) 2468 REDIFRAME 478 BROWN 20GA
INTERIOR HARDWARE: LEVER HANDLES.
(1) HEAVY DUTY PRIVACY ND40S X RHODES x 26D (SCHLAGE) RESTROOM
(2) HEAVY DUTY ENTRY ND53BD X RHODES x 26D (SCHLAGE) OFFICES
W/ IC CONSTRUCTION CORE

ROOF:

RAFTER: 2X6 #2SYP 16" O.C.
RIM: SINGLE 2X6 #2SYP
SHEATHING: 7/16" MULE-HIDE FR DECK PANEL C
COVERING: COLOR: BLACK STANDARD .045 MULE-HIDE EPDM ADHERED WITH MULE-HIDE ACRYLIC WATER BASED BONDING ADHESIVE
BOTTOM RAFTER SHEATHING: 5/8" FIRE-X SHEETROCK -PERPENDICULAR TO RAFTERS
ROOF PITCH: .25/12 TRANSVERSE
CEILING: 8'-0" HEIGHT. 2X4 LAYIN PANELS
INSULATION: R-19 FACED
PLENUM: AREA ABOVE CEILING GRID TO BE A PLENUM RETURN.
VENTS: RAFTER SPACE TO BE IN ACCORDANCE WITH REQUIREMENTS OF LOCAL BUILDING OFFICIAL.

ELECTRICAL:

SERVICE: 120/240V SINGLE PHASE
LOAD CENTER: (1) 125 AMP, INT MOUNT LOAD CNT. W/ #6 BARE GROUND

ENTRANCE: 2 " NIPPLE DOWN METAL
WIRING: ROMEX W/#12 (#6 AT HVAC)
LIGHTS: (11) 48" T-8 (3) TUBE 32 WATT FLOUR. FIXTURES (92 FIXTUREWATTS)
(1) PHOTO CELL EXTERIOR 13 WATT @ 860 LUMENS = 66 LUMEN PER WATT
(1) 24" T-8 U SHAPE (1)32 WATT FLOURESENT- (38 FIXTURE WATTS)
FANS: (1) 90 CFM EXHAUST IN BATHROOM VENT THRU ROOF NUTONE 671R
SURGE PROTECT: N/A
EXIT/EMERG. LIGHT: (1) EXIT/EMERGENY LIGHT BATTERY BACK UP.
RECIEPTS (16) STD. 120V DUPLEX RECEP.
(1) GFCI 120V STD. DUPLEX RECEPTACLES
(1) W.P. EXT. GFCI 120V RECEPTACLE

SWITCHES 4 SINGLE POLE 102V
J-BOXES: ALL PLATES TO BE IVORY
ALARM: N/A
MISC: GROUNDING ON SITE TO BE PER NEC 2002, 250-96

PLUMBING:

WATER SUPPLY: TYPE "L" COPPER
WASTE: PVC SCHEDULE 40
WATER HEATER: (1) EeMAX SP55 SUPPLY TO BOTH SINKS WITH SET OF 105-110F DEGREE.
WATER CLOSET: (1) HANDICAP FLUSH VALVE ELONGATED L/HANDLE
LAVATORY: HANDICAP WALL HUNG, COVER UNDERNEATH HANDLES
BAR SINK: (1) STAINLESS STEEL COUNTER LAV, DUAL LEVER FAUCET.
ACCESSORIES: 36" AND 42" GRAB BARS, TOLIET PAPER HOLDER.
NOTE: ALL FIXTURE MOUNTING PER TAS 1994

HVAC:

HVAC: (1) 3 TON WITH 10KW HEAT STRIP W/ 60AMP OUTSIDE DISCONNECT.
BRAND: BARD COLOR: TAN
EFFICIENCY: SEER 10.6, EER 9.2 > MINIMUM SEER 9.7 PER 2003 IECC TABLE 803.2.2(1)
THERMOSTAT: (1) PROGRAMABLE
DUCTS: DUCT BOARD MAIN, FLEX TO GRILLS IN UNCOND. SPACE. R-4.3 MIN. VALUE.
SUPPLY REGISTERS: 24X24 W/ ADJUSTABLE DIFFUSERS
RETURN REGISTERS: 24X24 , ABOVE CEILING PLENUM WITH PLENUM WALL CUT OUTS
MISC: FRESH AIR MAKEUP IS PROVIDED BY DAMPER IN HVAC.

DISCONNECT: EXTERIOR 60AMP WITHIN 6' OF GROUND.
BALANCE: SYSTEM TO BE BALANCED IN THE FIELD BY OTHERS.

FURNITURE OR MISC:

NORTEX MODULAR SPACE
CUSTOMER APPROVAL
AS IS: YES / NO.
AS NOTED: YES / NO
DATE _____ INT: _____

TELECOM:

J BOXES IN WALL STUBBED ABOVE CEILING

TRANSPORTATION:

7/16	ROOF DECK	0.0416667
2X6	ROOF RAFTER	0.4583333
5/8 GYP	UNDERSIDE RAFTER	0.0520833
10'	TALLEST WALL	10
1/4"	FLOOR COVER	0.020833
3/4"	FLOOR DECK	0.0625
2X8	FLOOR JOIST	0.6041667
2'-8"	TO ROAD APPROX	2.625

13.864583 FT
TOTAL 13'-10 1/4" APPROX.
WEIGHT APPROX. 20625 LBS

ENERGY CODE COMPLIANCE

COMCHECK CERTIFICATES TO BE USED AS CHECKLIST.
3 TUBE LIGHT FIXTURE IS 92 FIXTURE WATTS
2'X2'- U TUBE FIXTURE IS 38 FIXTURE WATTS
EXTERIOR LIGHT IS 13 WATT@860 LUMENS = 66 LUMEN PER WATT.
WINDOWS ARE U=.87 AND SHGC=.66 OR BETTER
OCCUPANCY SENSORS USED AT ALL LOCATIONS
DOOR U VALUE IS DEFAULT .7

DRAWING INDEX:
G-001 = COVER
A-101 = FLOOR PLAN
A-201 = EXTERIOR ELEVATIONS
A-202 = NOT USED
A-301 = SECTIONS
A-601 = ADA(TAS)
E-101 = ELECTRICAL PLAN
M-101 = MECHANICAL(HVAC) PLAN
P-101 = PLUMBING PLAN

PLANT FABRICATION DRAWINGS:
SF-101 = FLOOR FRAMING PLAN
SF-102 = FLOOR DECKING/WALL LAYOUT PLAN
SF-103 = ROOF FRAMING PLAN
SF-201 = WALL FRAMING PLAN
SF-202 = WALL FRAMING PLAN
S-101 = FOUNDATION PLAN
S-102 = NOT USED
S-501 = NOT USED
T-101 = TELECOM PLAN

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LTR

REVISION

BY

DATE

DRAWN BY: REW

PROJECT: VALERO ENERGY

TITLE: 1460STD COVER

DATE: 10/20/07

SCALE: N/A

DWG# 1460STD

SHEET: G-001

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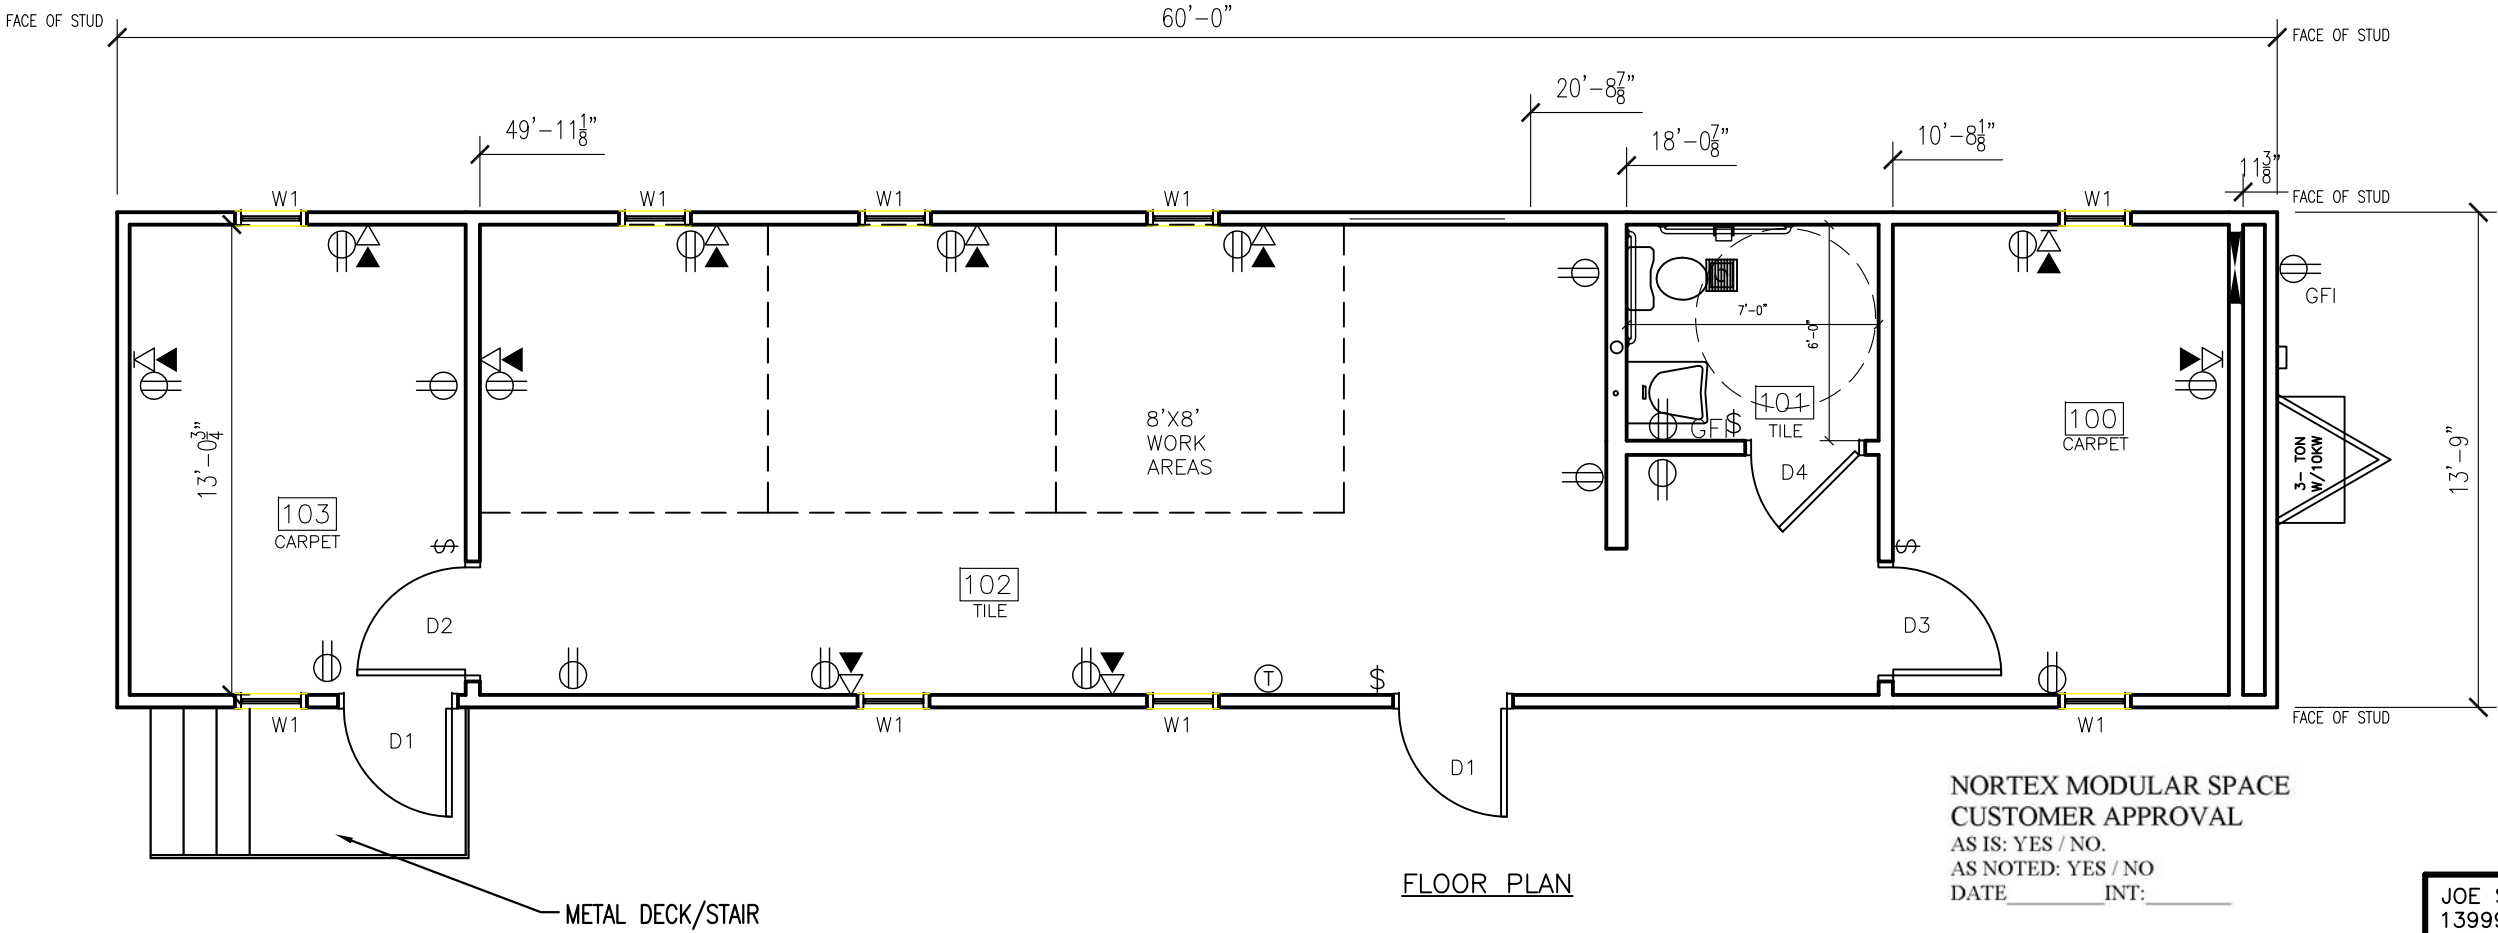
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AREA SCHEDULE						
DESIGNATION	DESCRIPTION	FLOOR AREA	FLOOR	WALL	CEILING	BASE
100	OFFICE	121	CARPET	5/8" VINYL COVERED GYPSUM TYPE X	2'X4' LAY IN	4" RUBBER BASE
101	BATHROOM	42	TILE	FRP OVER 5/8" GYPSUM TYPE X	2'X4' LAY IN	4" RUBBER BASE
102	WORK AREAS AND SINK AREA	454	TILE	5/8" VINYL COVERED GYPSUM TYPE X	2'X4' LAY IN	4" RUBBER BASE
103	OFFICE	121	CARPET	5/8" VINYL COVERED GYPSUM TYPE X	2'X4' LAY IN	4" RUBBER BASE

DOOR SCHEDULE					
DESIGNATION	SIZE	DOOR MATERIAL	FRAME	RD	QTY
D1	3068L	STEEL W/ PENCIL VISION	STEEL	40 1/2" X 82 1/2"	2
D2	3068L	MOHAWK SOLID CORE W/ VISION GLASS	REDIFRAME	37" X 81"	1
D3	3068R	MOHAWK SOLID CORE W/ VISION GLASS	REDIFRAME	37" X 81"	1
D4	3068L	MOHAWK SOLID CORE	REDIFRAME	37" X 81"	1
D5	2068R	MOHAWK SOLID CORE	REDIFRAME	25" X 81"	1

WINDOW SCHEDULE			
DESIGNATION	DESCRIPTION	RD	QTY
W1	2044 ALUMINUM BRONZE FRAME, DOUBLE INSULATED LOW E GALSS W/ ALUMINUM MINI BLINDS	24 1/2" X 52 1/2"	9

COMCHECK AREA
(1)SIDEWALL = 60' X 10'-0 3/4" = 618SF + PEAK AREA OF 18SF = 636SF
(1)ENDWALL = 13'-9" X 10'-0 3/4" = 137.9SF
SIDEWALL X 2= 1272SF + ENDWALL X 2 = 275.8 FOR A TOTAL OF 1547.8




NORTEX MODULAR SPACE
CUSTOMER APPROVAL
AS IS: YES / NO.
AS NOTED: YES / NO
DATE _____ INT: _____

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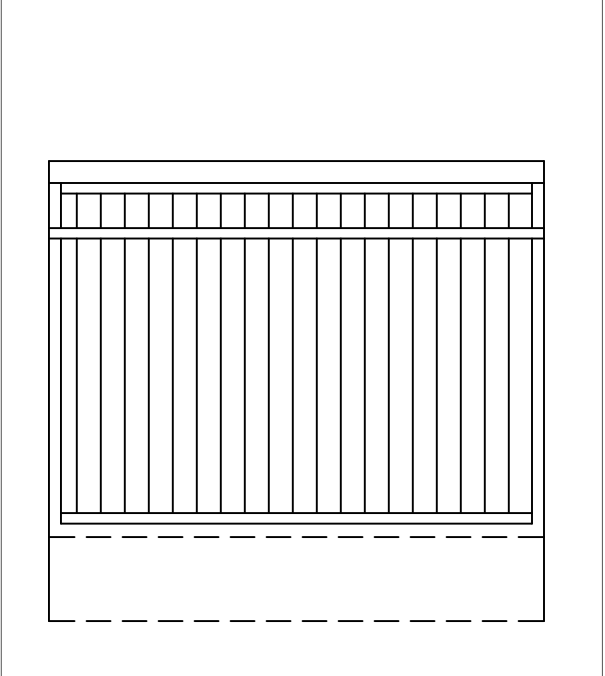
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				REW	VALERO ENERGY	1460STD FLOOR PLAN	1460STD	A-101
				DATE:	SCALE:			
				10/20/07	3/16" = 1'-0"			




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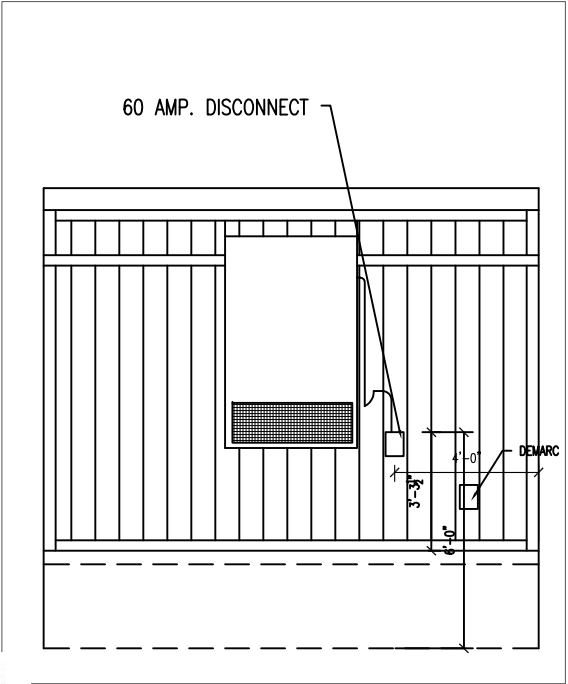
BACK ELEVATION

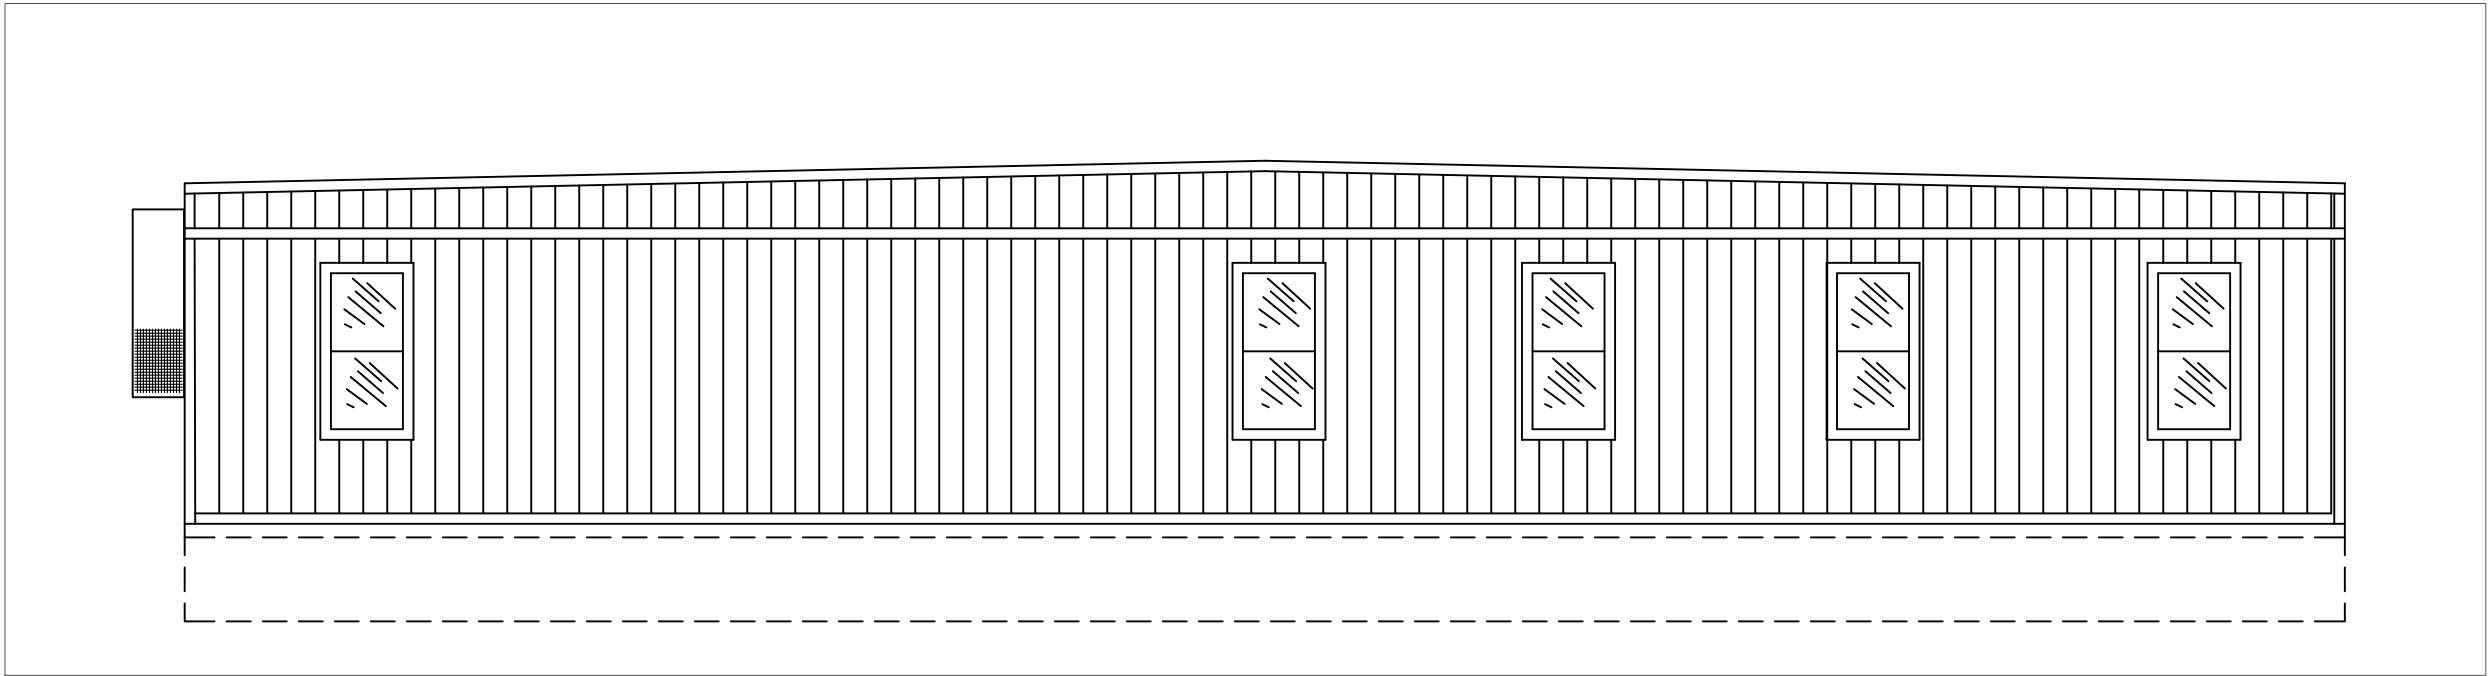

BACK END ELEVATION



FRONT ELEVATION

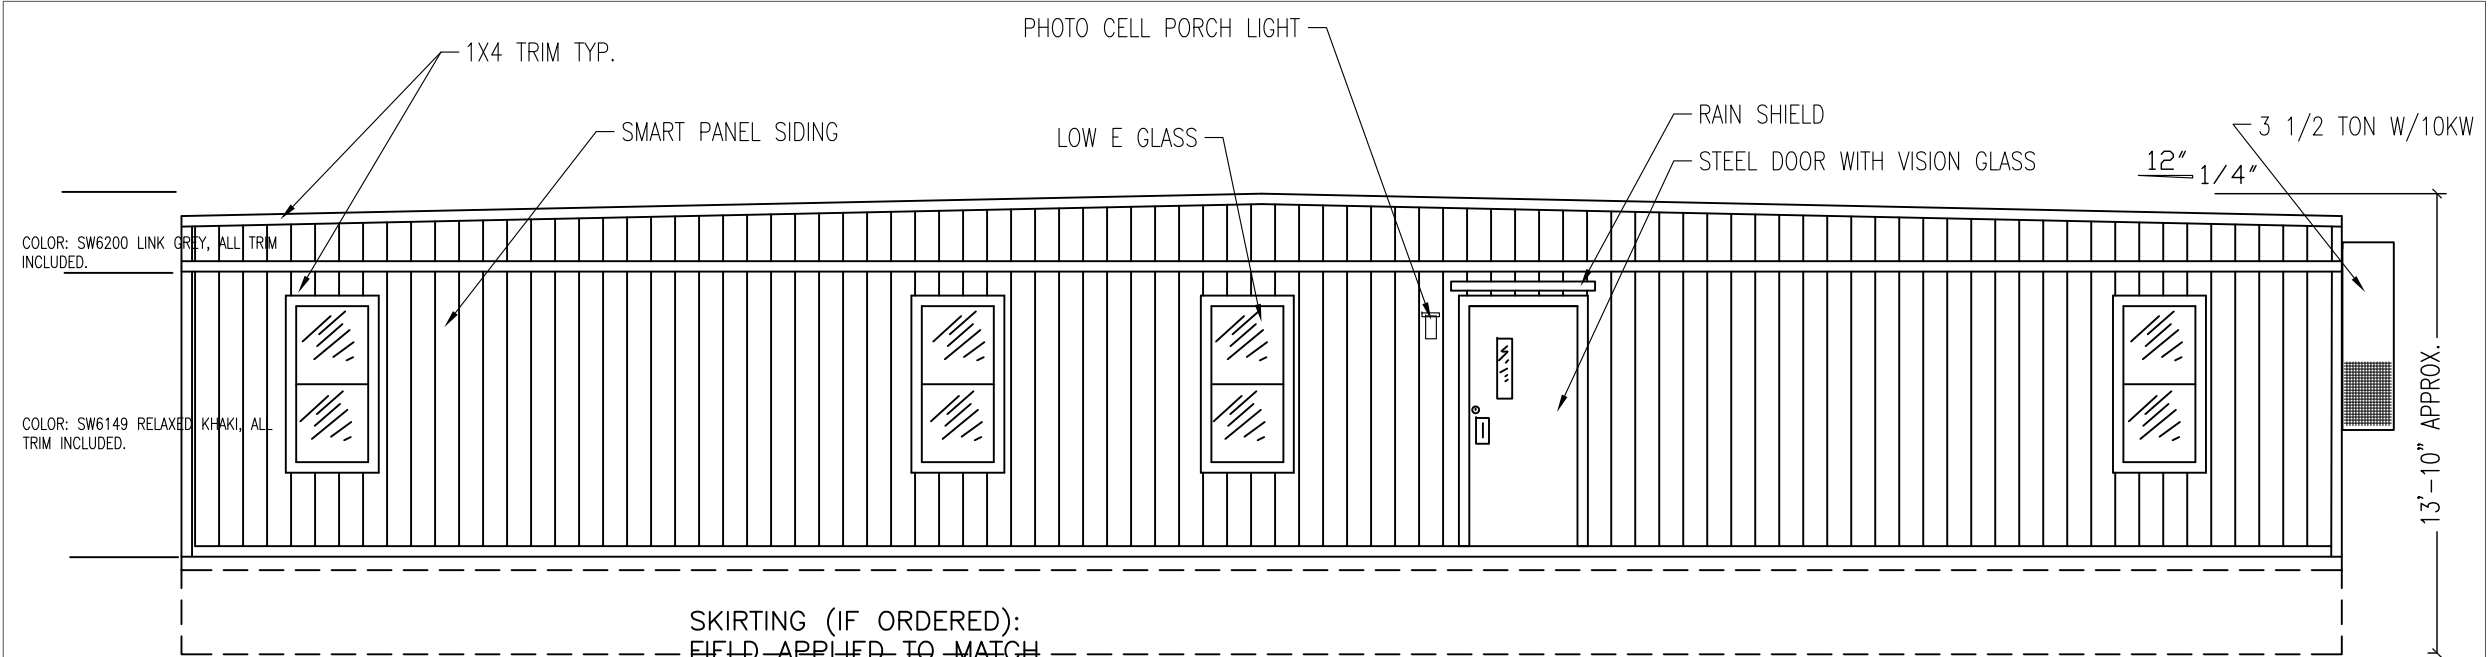

HITCH END ELEVATION


NORTEX MODULAR SPACE
CUSTOMER APPROVAL
AS IS: YES / NO.
AS NOTED: YES / NO
DATE _____ INT: _____

LTR	REVISION	BY	DATE	DRAWN BY:	PROJECT:	TITLE:	DWG#	SHEET:
				REW	VALERO ENERGY	1460STD ELEVATIONS	1460STD	A-201
				DATE:	SCALE:			
				10/20/07	3/16" = 1'-0"			



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SECTION VIEW

NORTEX MODULAR SPACE
CUSTOMER APPROVAL
AS IS: YES / NO.
AS NOTED: YES / NO
DATE _____ INT: _____

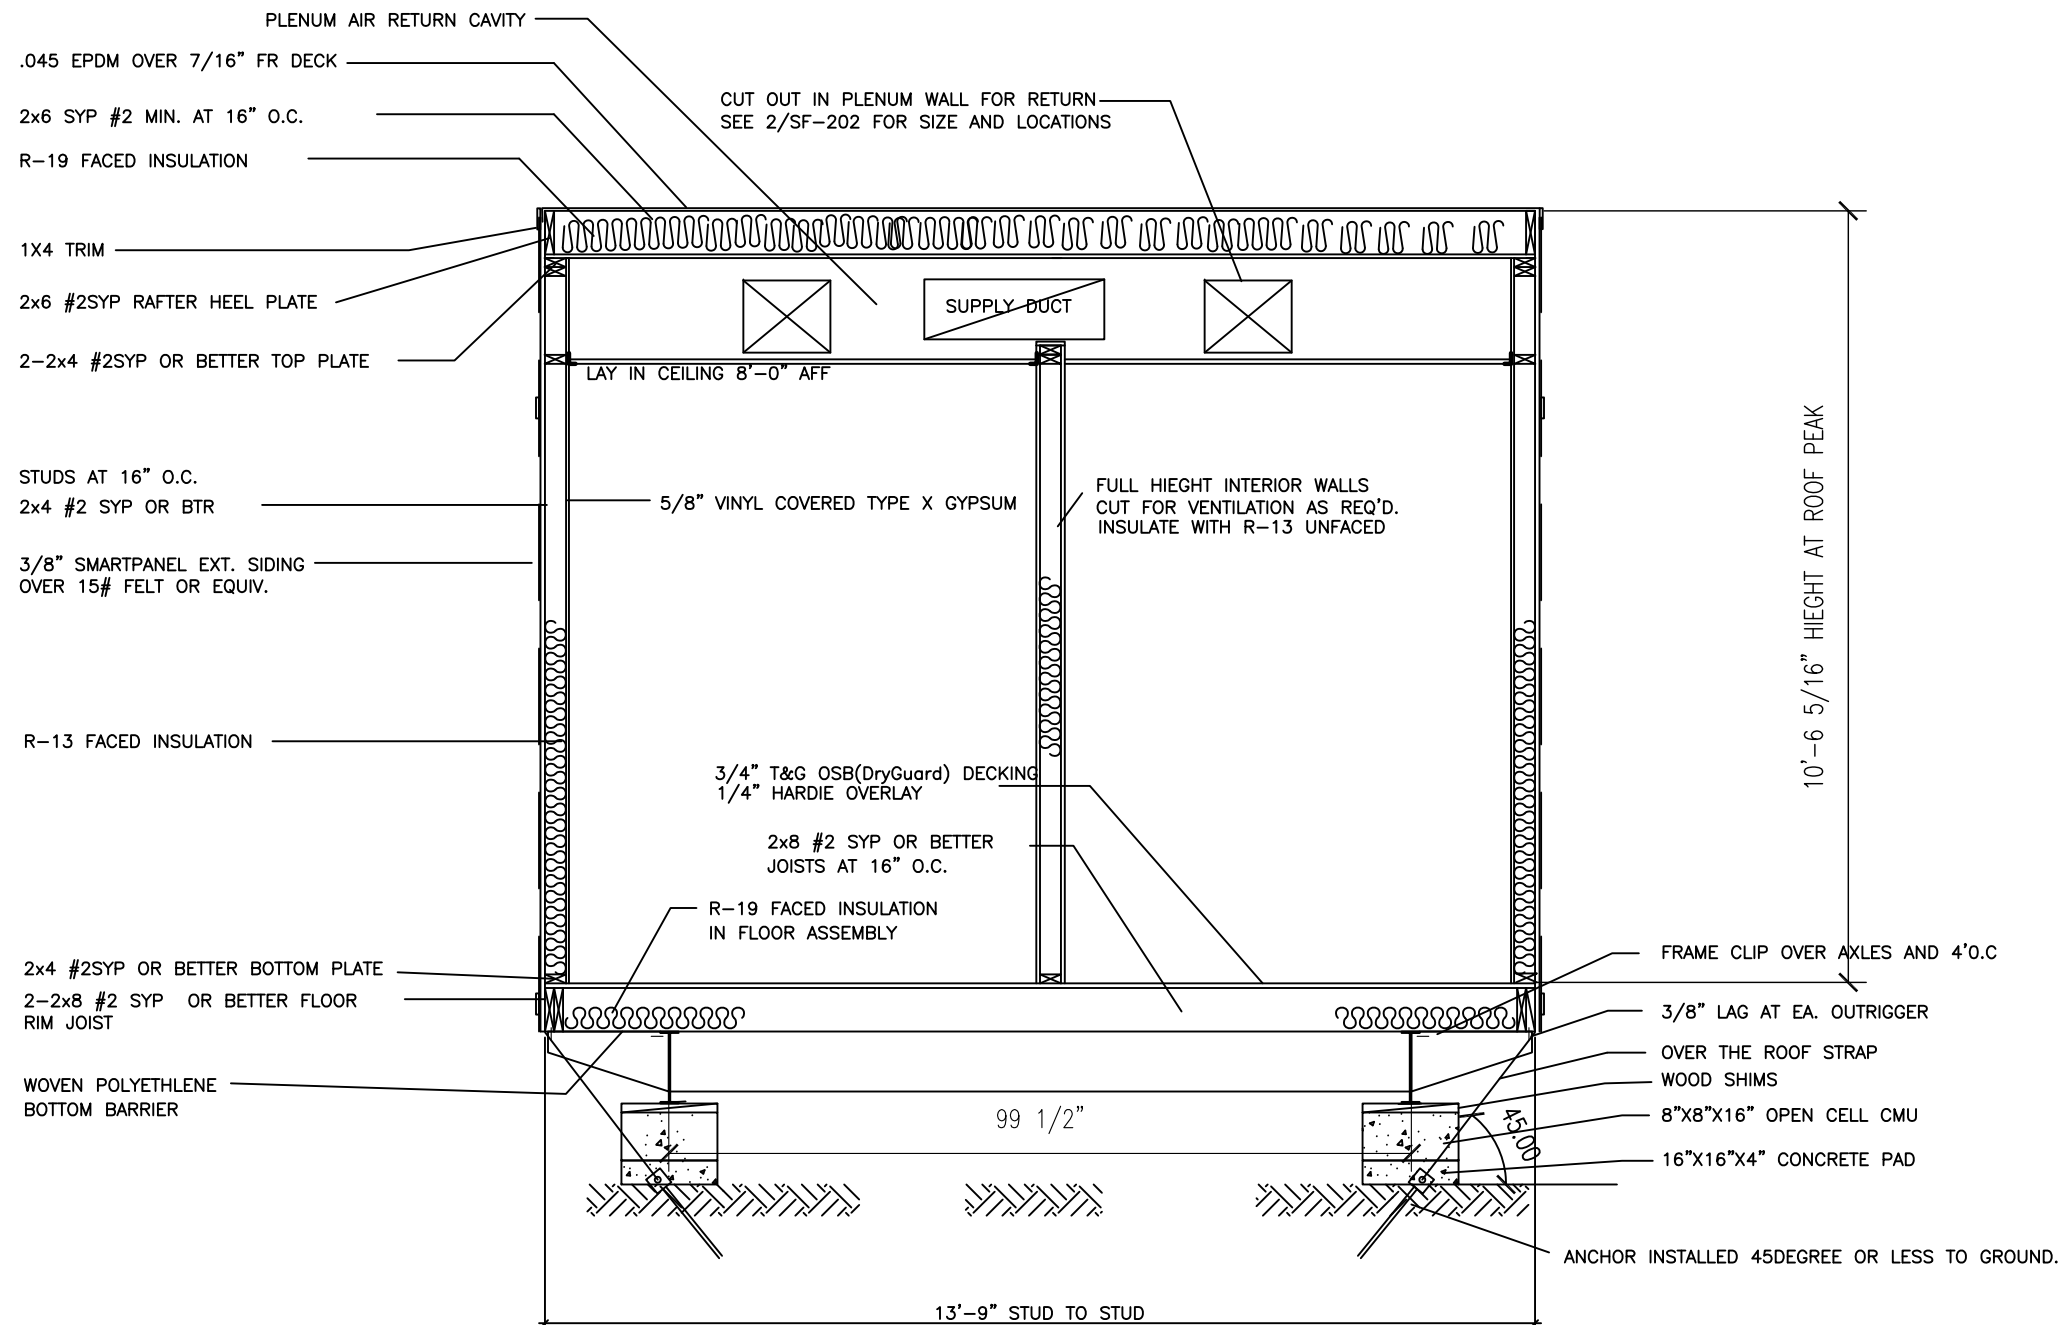
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LTR	REVISION	BY	DATE	DRAWN BY:	PROJECT:	TITLE:	DWG#	SHEET:
				REW	VALERO ENERGY	1460STD SECTION		
				DATE:	SCALE:			
				10/20/07	3/8" = 1'-0"		1460STD	A-301



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ADA DETAILS



NORTEX MODULAR SPACE
CUSTOMER APPROVAL
AS IS: YES / NO.
AS NOTED: YES / NO
DATE _____ INT: _____
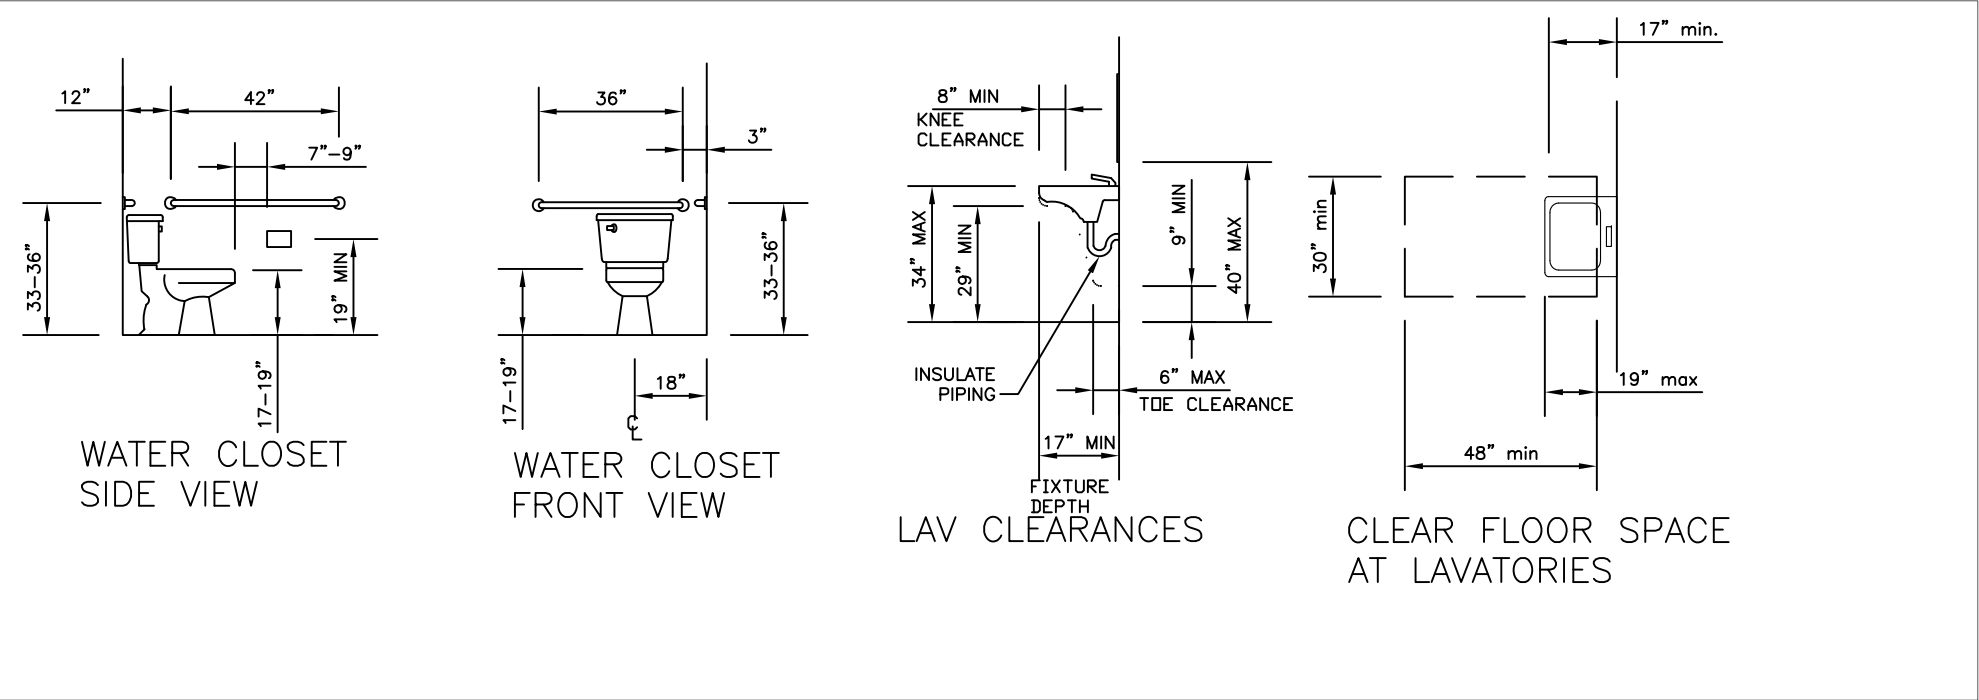
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LTR	REVISION	BY	DATE	DRAWN BY:	PROJECT:	TITLE:	DWG#	SHEET:
				REW	VALERO ENERGY	1460STD ADA	1460STD	A-601
				DATE:	SCALE:			
				10/20/07	N/A			



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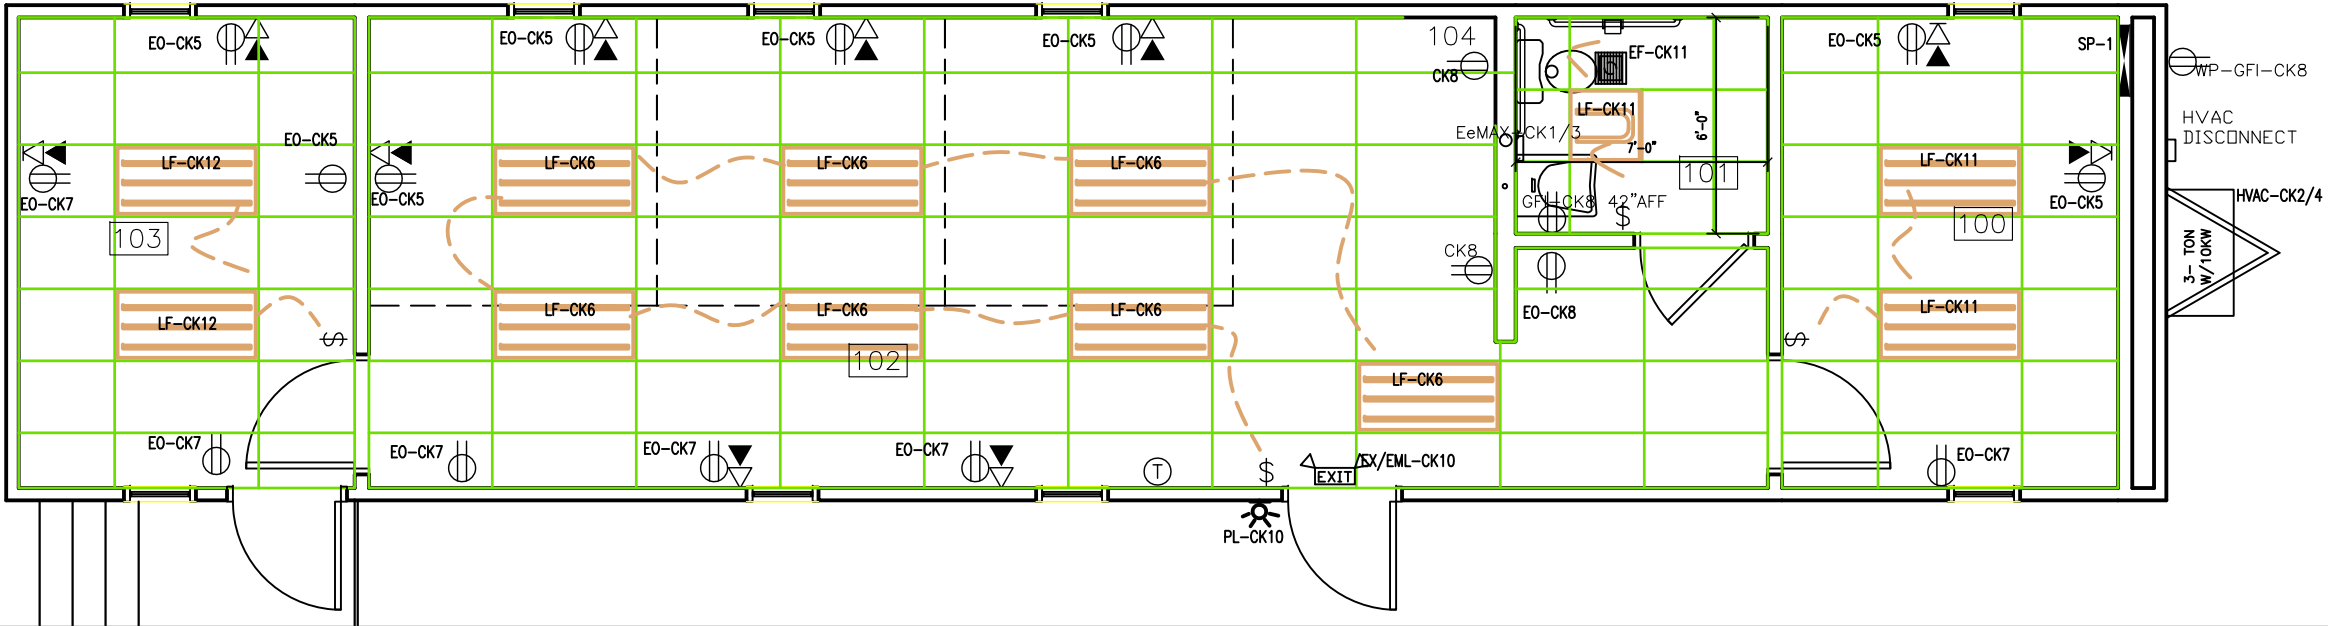
PANEL MARKUP, WIRE AND BREAKER SIZING.

MIN WIRE SIZE		125 AMP 2-POLE 120V/240V SINGLE PHASE MAIN BREAKER						MIN WIRE SIZE
		BREAKER	LEG	CKT	CKT	LEG	BREAKER	
10	EeMAX	30	A	1	2	A	60	3-1/2 TON 10KW HVAC UNIT
		2P	B	3	4	B	2P	
12	RECEPTS	20	A	5	6	A	20	LIGHTS
12	RECEPTS	20	B	7	8	B	20	GFIS
12	NOT USED		A	9	10	A	20	EMERG,EXT,PORCH
12	EXHAUST FAN AND LIGHTS	20	B	11	12	B	20	LIGHTS
	NOT USED		A	13	14	A		NOT USED
	NOT USED		B	15	16	B		NOT USED
	NOT USED		A	17	18	A		NOT USED
	NOT USED		B	19	20	B		NOT USED
	NOT USED		A	21	22	A		NOT USED
	NOT USED		B	23	24	B		NOT USED

- SS SURGE PROTECTOR
- CAN LIGHT LIGHT
- 2'X4' TROUFFER LIGHT T-8 ELEC. BALLAST, 3-BULB
- EMERGENCY EXIT LIGHT
- PORCH LIGHT
- SINGLE POLE LIGHT SWITCH
- OCCUPANCY SENSOR SWITCH
- DIMMER SWITCH
- 3WAY SWITCH
- DUPLEX OUTLET
- SURGE DUPLEX OUTLET
- WEATHER PROOF DUPLEX GROUND FAULT INTERRUPT OUTLET
- GFCI
- CEILING OUTLET
- DATA DROP
- VOICE DROP

PANEL SP-1		125 AMP 2-POLE		120V/240V	
		SINGLE PHASE MAIN BREAKER		LOAD CALCULATIONS	
LEG	CKT	DESCRIPTION	LEG A-AMPS	LEG B-AMPS	LEG A-WATTS
A	1	EeMAX	22.90		2,381.60
A	2	HVAC	59.00	-	6,136.00
B	3	EeMAX		22.90	2,381.60
B	4	HVAC	-	59.00	6,136.00
A	5	RECPTS	9.00		936.00
A	6	LIGHTS	5.39	-	560.56
B	7	RECPTS	-	9.00	936.00
B	8	GFIS		6.00	624.00
A	9		-		-
A	10	EMERG/EXIT	0.14	-	14.73
B	11	EXHAUST/LIC	-	1.93	200.72
B	12	LIGHTS		1.54	160.16
			96.43	100.37	10,028.89
			TOTALS		20,467.37
			W /20%		25,584.22
			125AMP OK		(409.59) WATTS
			DIFF B-A +/- 20%		-1.60% OK
					106.60 AMPS

		AMPS EA.	ITEM	WATTS EA
		1.5	RECEPTS	156
BULBS	32 WATT	0.77	LIGHTS 2'X4' 3-TUBE T-8	92
		0.8	90 CFM EXHAUST FAN	83.2
BULBS	32 WATT	0.31	LIGHT 2'X2' U-TUBE T-8	38
		0.0333333	EMERGENCY/EXIT	4
		0.1083333	PORCH LIIGHT	13
		22.9	EeMAX	2633.5
		59	HVAC	6136
				0
				0
				0



- NOTES:
1. MOUNT ALL OUTLET BOXES TO 16" AFF TO TOP OF BOX.
 2. COUNTER TOP OUTLET TO BE 42" AFF TO BOTTOM OF BOX.
 3. BATHROOM OUTLET TO BE 42" AFF TO BOTTOM OF BOX.
 4. 3-TUBE LIGHT FIXTURE IS FIGURED AS 92 FIXTURE WATTS AND THE (1) U TUBE FIXTURE AS 38 WATTS.
 5. ALL WIRING TO BE ROMEX


NORTEX MODULAR SPACE
CUSTOMER APPROVAL
AS IS: YES / NO.
AS NOTED: YES / NO
DATE _____ INT: _____

ELECTRICAL PLAN


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LTR	REVISION	BY	DATE	DRAWN BY:	PROJECT:	TITLE:
				REW	VALERO ENERGY	1460STD ELECTRICAL PLAN
				DATE:	SCALE:	DWG#
				10/20/07	3/16" = 1'-0"	1460STD
						SHEET: E-101

MECHANICAL SCHEDULE		
DESIGNATION	DESCRIPTION	COMMENTS
SA1	2X2 SUPPLY AIR REGISTER	ADJUSTABLE
SA2	12X12 SUPPLY GRILL	NONE
RA1	2X2 RETURN AIR REGISTER	NONE
T	THERMOSTAT	PROGRAMMABLE
3 TON W/10KW	BARD 	W/ECONOMIZER
EX1	90 CFM EXHAUST FAN	THRU ROOF

AC	CFM	FPM	RECT W	RECT W	ROUND DUCT
3-1/2 ton	1400	960	30	10	16
OCCUPANTS	6				
CFM REQ'D EACH	20 CFM				
TOTAL OUTSIDE REQD	120 CFM				

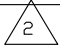


- NOTES:
1. PLENUM CAVITY ABOVE LAY IN CEILING.
 2. PLENUM WALL TO HAVE OPENINGS CUT AND GYPED TO ACHIVE 30X16 AREA.
 3. OFFICE WALLS AND 2X6 WALL TO HAVE OPENING FOR DUCT TO PASS THRU FABRICATED INTO FRAMING.
 4. FLEX DUCTS NOT TO BE CUT INTO MAIN DUCT LESS THAN 12" FROM A TRANSITION.
 5. ALL DUCTS TO HAVE A R-4.3 MINIMUM VALUE.
 6. AREA OPEN AROUND 16X10 DUCT THROUGH WALL WILL SERVE AS THE RETURN OF AIR FROM ROOM 103.

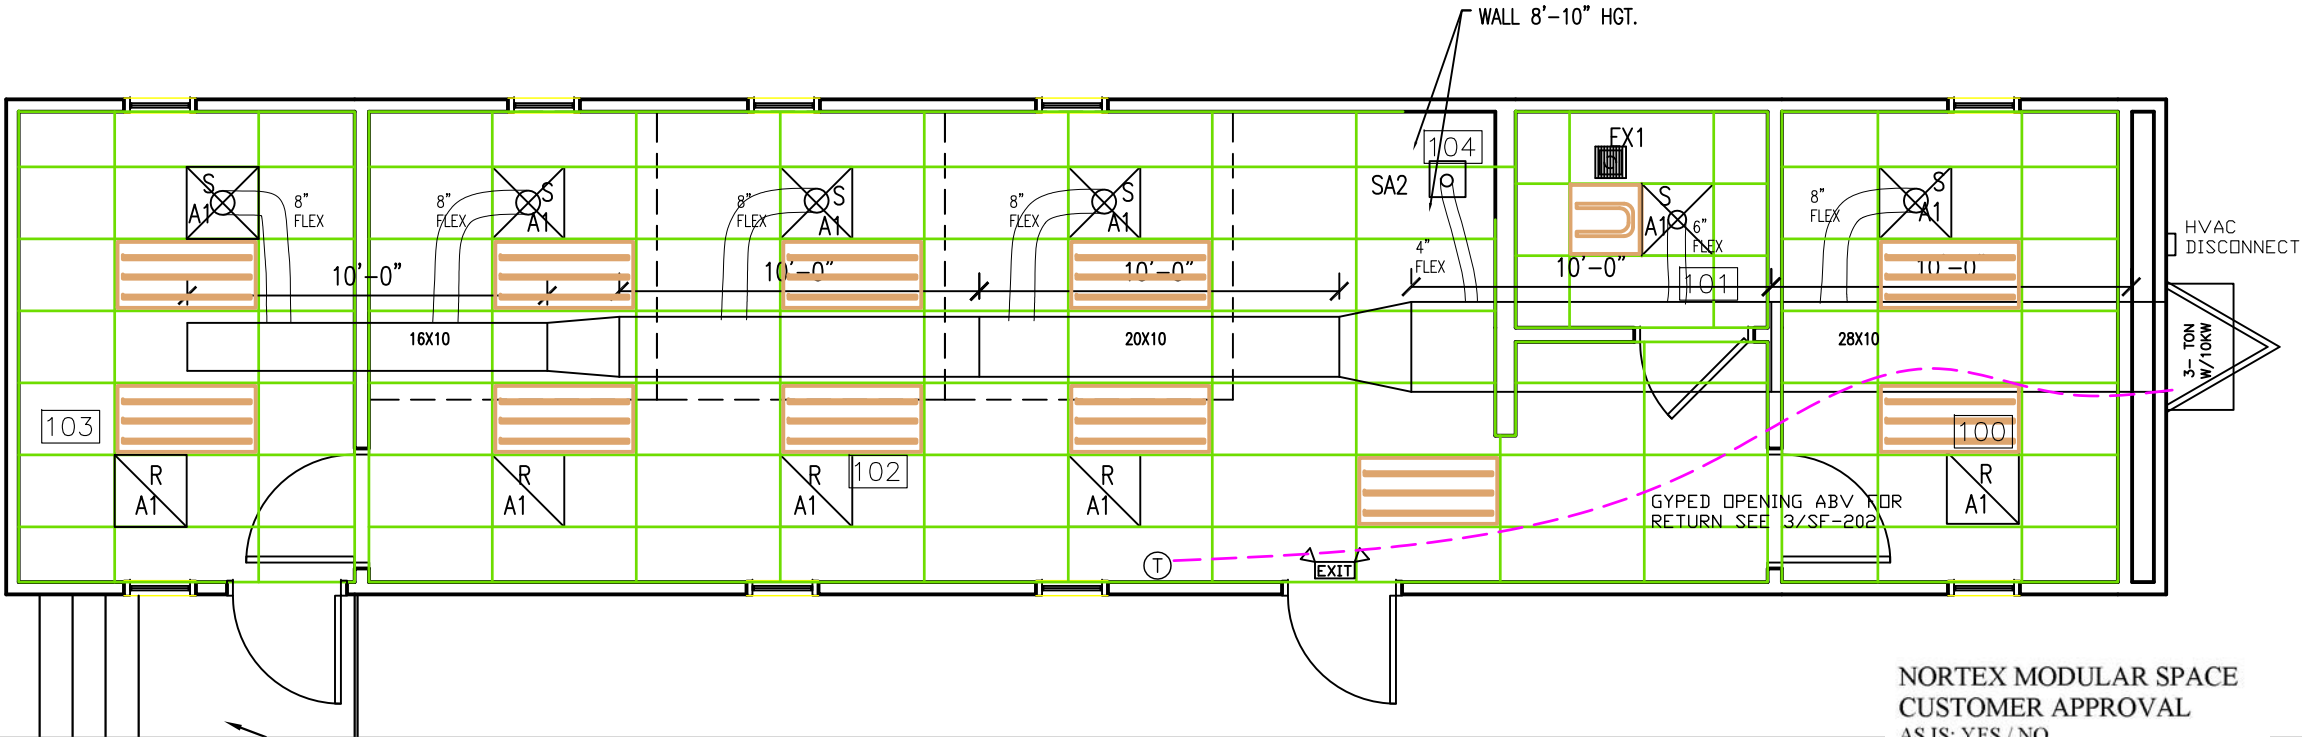NORTEX MODULAR SPACE
CUSTOMER APPROVAL
AS IS: YES / NO.
AS NOTED: YES / NO
DATE _____ INT: _____

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FAX: 972-492-2704


LTR	REVISION	BY	DATE	DRAWN BY:	PROJECT:	TITLE:	DWG#	SHEET:
				REW	VALERO ENERGY	1460STD MECHANICAL PLAN	1460STD	M-101
				DATE:	SCALE:			
				10/20/07	3/16" = 1'-0"			

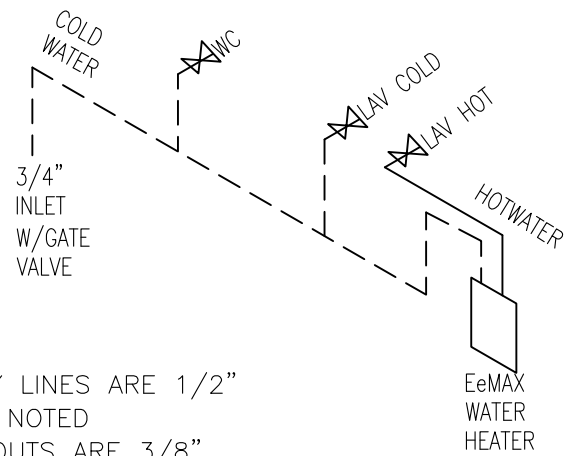


ALL SUPPLY LINES ARE 1/2"
EXCEPT AS NOTED
ALL STUB-OUTS ARE 3/8"
EXCEPT AS NOTED

NOTE: ALL SUPPLY LINES OVER
3/4" IN SIZE SHALL BE COPPER

SUPPLY RISER

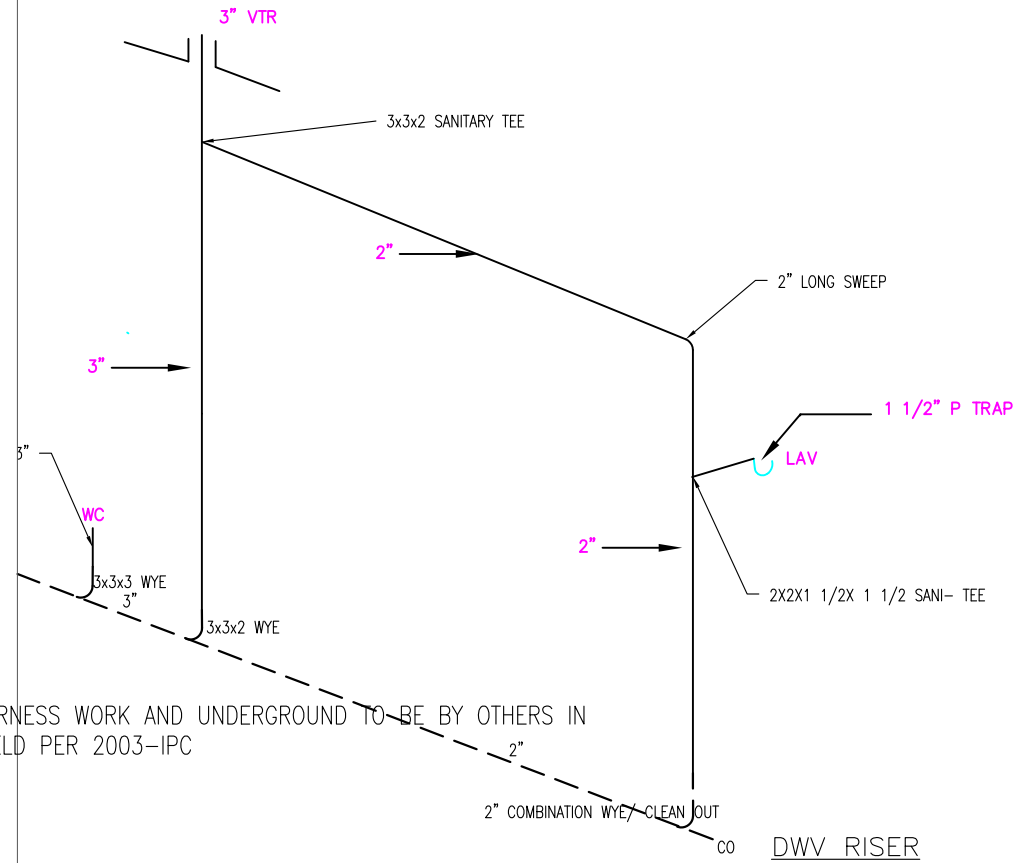

ALL HARNESS WORK AND UNDERGROUND TO BE BY OTHERS IN
THE FIELD PER 2003-IPC

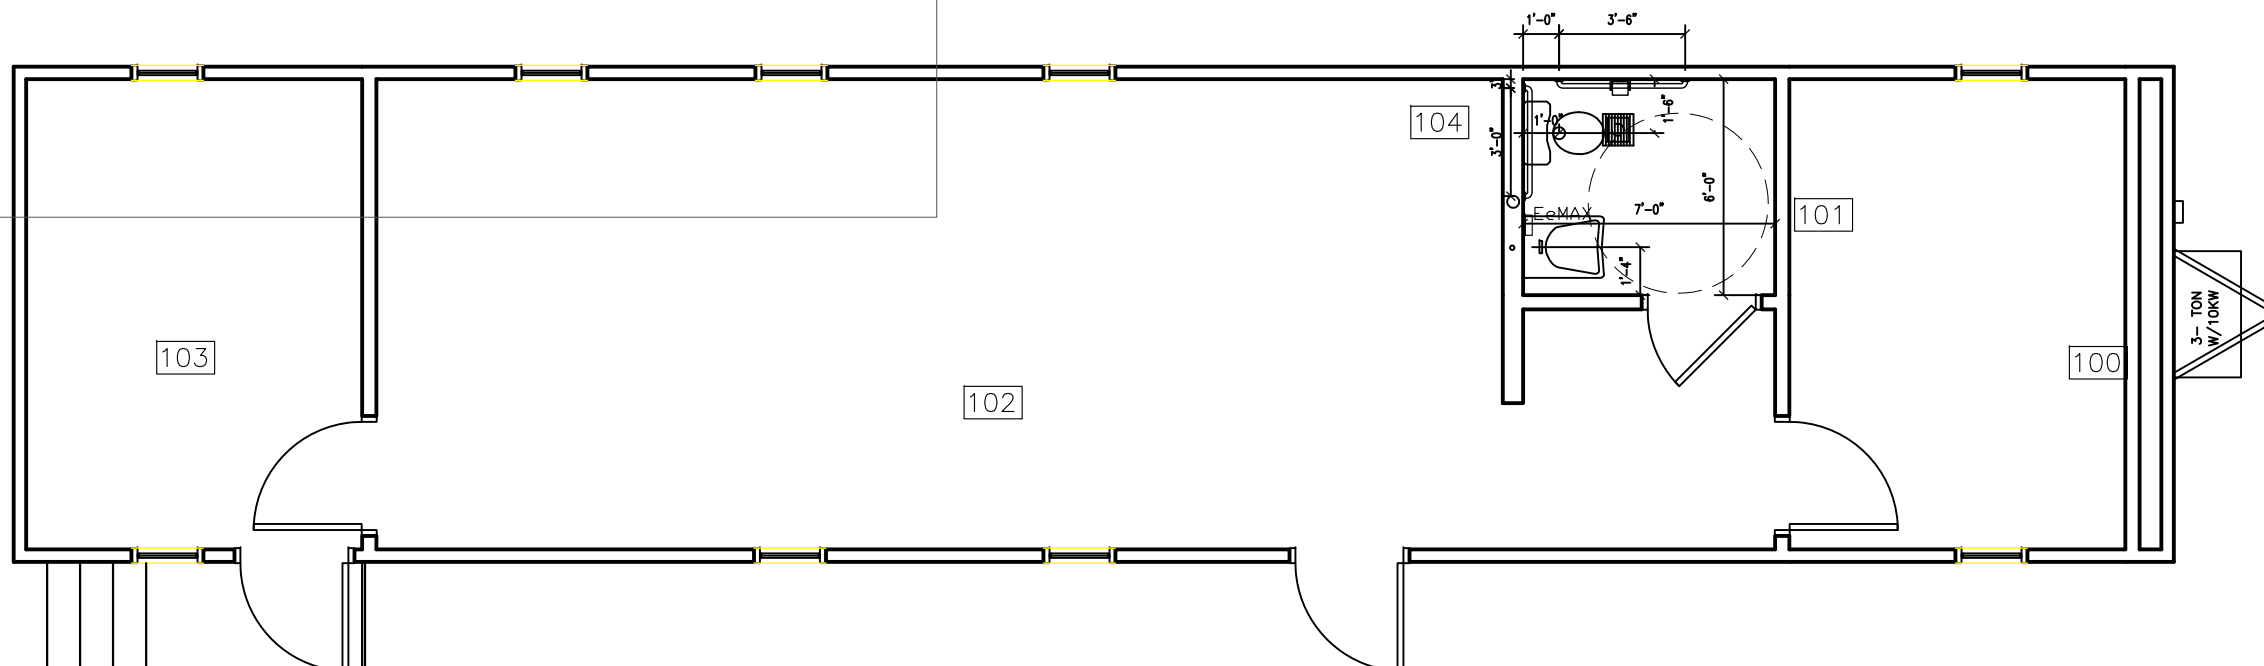

36" AND 42" GRAB BARS
ARE 35" AFF TO CENTER.
BATHROOM SINK TO BE
MOUNTED 31 1/2" AFF TO
BRACKET TOP.
SEE SHEET A-601 FOR
OTHER DETAILS.
LOCATE EeMAX UNDER SINK
AS HIGH AS POSSIBLE.

NORTEX MODULAR SPACE
CUSTOMER APPROVAL
AS IS: YES / NO.
AS NOTED: YES / NO
DATE _____ INT: _____

JOE STEEDE, P.E.
13999 GOLDMARK, SUITE 374
DALLAS, TX 75250 PHONE 972-238-1611

NORTEX MODULAR SPACE

555 JUBILEE LANE
LEWISVILLE, TX 75056
PHONE: 972-492-4040
FAX: 972-492-2704

LTR	REVISION	BY	DATE	DRAWN BY:	PROJECT:	TITLE:	DWG#	SHEET:
				REW	VALERO ENERGY	1460STD PLUMBING PLAN	1460STD	P-101
				DATE:	SCALE:			
				10/20/07	3/16" = 1'-0"			

