

JOSEPH W. STEEDE JR.

19639
REGISTERED PROFESSIONAL ENGINEER

DESIGN CRITERIA:	
PROJECT NAME: NORTEX 1644 CLASS	BUILDING SQUARE FOOTAGE: 693 SF
2008 NEC	2006 IBC
2006 IMC	2006 IECC
1994 TAS	USE GROUP: E
CONSTRUCTION TYPE: IBC: V-B	OCCUPANT LOAD: 35
PERMISSIBLE GAS TYPE: <input type="checkbox"/> LP <input type="checkbox"/> NATURAL <input checked="" type="checkbox"/> N/A	

DESIGN LOADS:	
ROOF LIVE LOAD: 20 PFS	FLOOR LIVE LOAD: 50 PFS
CONC. FLOOR LIVE LOAD: 2000 LBS	WIND LOAD: (130 MPH 3-SEC GUST)
EXPOSURE: B	SEISMIC DESIGN CATEGORY: B

SPECIAL CONDITIONS AND/OR LIMITATIONS:	
1. HANDICAP ACCESS TO BE PROVIDED PER 1994 TAS AS REQUIRED BY OTHERS.	
2. BUILDING TO BE LOCATED PER TABLE 602 OF THE 2006 IBC.	
3. ANY REQUIRED ALARM SYSTEM WILL BE INSTALLED ON SITE BY OTHERS.	
4. WATER FOUNTAIN SHALL BE FURNISHED BY OTHERS PER IPC-2006 TABLE 403.1.	

FOUNDATION NOTES:	
1. TIE DOWN ANCHORING SEE SHEET S-101	
2. CRAWL SPACE VENTILATION PROVIDED BY SITE INSTALLER PER 1203.3.1 OF 2006 IBC.	

SCOPE OF WORK:	
NOT INCLUDED IN SCOPE OF WORK	
1. UTILITIES AND UTILITY CONNECTIONS	
2. POURED CONCRETE (DRIVEWAY, SIDEWALK, SLABS, FOOTINGS, ECT.)	
3. SITE PREPARATION	
4. TAX OF ANY KIND	
5. BUILDING PERMITS	
SITE WORK	
1. NO PROVISION FOR SITE WORK HAS BEEN INCLUDED. IT IS PRESUMED THE SITE WILL PROVIDE CLEAR ACCESS FOR TRUCKS AND MODULARS. ADEQUATE DRAINAGE TO BE PROVIDED.	
2. ALL ELECTRICAL, PLUMBING, SEWER, & GAS SERVICE CONNECTIONS AND ALL CONCRETE WORK ON SITE, TO INCLUDE POURED FOOTINGS, SLABS, FOUNDATIONS, SIDEWALKS, DRIVEWAYS OF WHATEVER KIND ARE THE RESPONSIBILITY OF OTHERS.	

IDENTIFICATION	
DECALS: TDLR, MANUFACTURERS DATA PLATE, PFS, UNIT NUMBER, MBI.	LOCATION: FRONT LEFT OF BUILDING ON A METAL PLATE

FRAME / CHASSIS:	
OUTRIGGERS: 48" O.C.	CROSSMEMBERS: 48" O.C.
BEAM: 12" JR. I-BEAM	HITCH: DETACHABLE HITCH
AXLES: (4) W/ BRAKES ON TWO AXLES, DRAG ON TWO.	TIRES: L (12-PLY)
FRAME: HEAVY	

TEXAS INDUSTRIALIZED BUILDING CODE COUNCIL

This document is approved pursuant to
the Industrialized Housing and Buildings
Act.

DIR	DRA No. 7 REVISION X IRC
Date: 7/20/09	
DRA Signature:	

FLOOR:	
BOTTOM BOARD: ROLL, POLYETHYLENE FIBER MESH	INSULATION: R-22 FACED
JOIST: 2X8 #2SYP OR BETTER AT 16" O.C.	SIDEBOARD JOIST (RIM): 2X8 #2SYP OR BETTER
DECKING: 3/4" T&G OSB	UNDERLAYMENT: N/A
COVERING: 22 OZ CARPET SQUARES	BASE COVE: 4" RUBBER COLOR= GREY

EXTERIOR WALLS:	
SIDEWALL HEIGHT: 10'-1 1/8"	STUDS: 2X4 #2SYP 16" O.C.
BOTTOM PLATE: SINGLE 2X4 #3SPF MIN.	
TOP PLATES: DOUBLE 2X4 #3SPF MIN. 2SYP	HEADERS: DOUBLE 2X6 W/ 7/16" FILLER
JACK STUDS: SINGLE EACH SIDE 2X4 #2SYP, KING STUD-(2X) 2X4 #2SYP EACH SIDE	FIRE BLOCKING: 2X4 ON EDGE AT THE CEILING LINE.
INSULATION: R-15 FACED	SHEATHING: 7/16" OSB - ENDWALLS ONLY
SIDING: 3/8" SMART PANEL COLOR: SEE SHEET A-201	TRIM: 1X4 SMART PANEL COLOR: SEE SHEET A-201
SKIRTING: SHIP LOOSE (8) 4X12 SHTS SMART PNL PAINTED TO MATCH BODY	
IF SKIRTING IS ORDERED, 12"X12" VENTS TO BE SHIPPED WITH MATERIAL.	

INTERIOR WALLS:	
N/A	

WINDOWS:	
SIZE/TYPE: (2) 46"X27" H.S. BRONZE FRAME/CLEAR LOW E GLASS	BRAND: HR MIN. ENERGY VALUES: U-FACTOR=.51 SHGC=.34
COVERING: (2) ALUMINUM MINI-BLINDS COLOR: GRAY	MSC: FRAME FOR FUTURE WINDOWS ON OPPOSITED SIDEWALL (MIRROR)

DOORS:	
EXTERIOR: (1) 36"X80" 18GA STEEL W/ 5"X20" PENCIL WINDOW (TEMP)	EXTERIOR HARDWARE:
(1) DEADBOLT (SCHLAGE) B660 BD x 26D W/IC CONSTR. CORE	(1) 9305BC x AL NORTON CLOSER
(1) HOLLOW METAL FRAME	(2) PULL PLATES ROCKWOOD #107 x 70C X US28
(1) PEMCO THRESHOLD 170A-36	(1) PEMKO SWEEP 315CN-36
(1) SET PEMKO WEATHERSTRIP 303AV-3070	(1) PANIC HARDWARE
MISC: FRAME FOR ALTERNATE DOOR PLACEMENT ON OPPOSITED SIDEWALL (MIRROR)	
INTERIOR HARDWARE: N/A	


ROOF:	
RFTER: #2SYP 2X8 16" O.C.	RIM: 1.9E LVL TAPER CUT 13 1/2" TO 7 1/4"
SHEATHING: 7/16" MULE-HIDE FR DECK PANEL C	COVERING: COLOR: WHITE STANDARD .045 MULE-HIDE EPDM ADHERED WITH MULE-HIDE ACRYLIC WATER BASED BONDING ADHESIVE
BOTTOM RAFTER SHEATHING: NONE, WIRE MESH	ROOF PITCH: .25/12 TRANSVERSE
CEILING: 8'-6" HEIGHT, 2X4 LAY IN PANELS	INSULATION: (2) LAYERS R-15
PLENUM: NONE	VENTS: 1" ABOVE INSULATION

ELECTRICAL:	
SERVICE: 120/240V OR 120/208 SINGLE PHASE	LOAD CENTER: (1) 100 AMP, INT MOUNT LOAD CNT. W/ #6 BARE GROUND
ENTRANCE: 2" NIPPLE DOWN METAL	WIRING: MC #12 (#6 AT HVAC)
LIGHTS: (6) 48" T-8 (2) TUBE 32 WATT FLOUR. FIXTURES (59 FIXTUREWATTS)	(1) PHOTO CELL EXTERIOR 13 WATT @ 860 LUMENS = 66 LUMEN PER WATT
FANS: (1) J-BOX OPPOSITE SIDEWALL FOR ALT PLACEMENT OF EXTERIOR LIGHT	
SURGE PROTECT: N/A	RECEIPTS: (1) EXIT/EMERGENCY LIGHT BATTERY BACK UP J-BOX OVER ALT DOOR FRAME AS W
SWITCHES: (2) SINGLE POLE 120V -(2) J-BOX BESIDE ALT EXT DOOR PLACEMENT	(6) STD. 120V DUPLEX RECP.
J-BOXES: ALL PLATES TO BE IVORY	(1) W.P. EXT. GFCI 120V RECEPTACLE
ALARM: N/A	
MSC: GROUNDING ON SITE TO BE PER NEC 2002, 250-96	

PLUMBING:	
WATER SUPPLY:	WASTE:
WATER HEATER:	WATER CLOSET:
LAVATORY:	BAR SINK:
ACCESSORIES:	NOTE:

HVAC:	
HVAC: (1) 3 TON WITH 5KW HEAT STRIP W/ 60AMP OUTSIDE DISCONNECT.	BRAND: BARD COLOR: TAN
EFFICIENCY: SEER 10.0, EER 9.2 > MINIMUM SEER 9.7 PER 2006 IECC TABLE 503.2.(1)	
THERMOSTAT: (1) PROGRAMMABLE	
DUCTS: DUCT BOARD MAIN, FLEX TO GRILLS IN UNCOND. SPACE R-4.3 MIN. VALUE	
SUPPLY REGISTERS: 24X24 W/ NON-ADJUSTABLE DIFFUSERS	
RETURN REGISTERS: AT PLENUM WALL WITH GRILL	
MISC: FRESH AIR MAKEUP IS PROVIDED BY DAMPER IN HVAC. AND OPENABLE WINDOWS	
DISCONNECT: EXTERIOR 60AMP WITHIN 6' OF REACH.	
BALANCE: SYSTEM TO BE BALANCED IN THE FIELD BY OTHERS.	

FURNITURE OR MISC:	

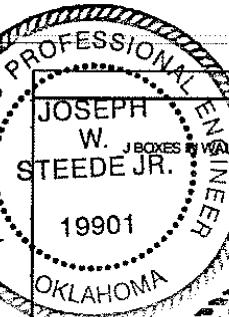

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	ROOF DECK	0.041667
2X8	ROOF RAFTER	0.6041667
7 1/2"	LVL RIM PITCH RISE	0.625
10'-1 1/8"	TALLEST WALL	10.1
0	FLOOR COVER	0
3/4"	FLOOR DECK	0.625
2X8	FLOOR JOIST	0.6041667
2'-8"	TO ROAD APPROX	2.625
		14.6625 FT
	TOTAL WEIGHT APPROX	14'-8" APPROX. 16632 LBS

ENERGY CODE COMPLIANCE	
COMCHECK CERTIFICATES TO BE USED AS CHECKLIST: 2 TUBE LIGHT FIXTURE IS 59 FIXTURE WATTS 2X2- U TUBE FIXTURE IS 38 FIXTURE WATTS EXTERIOR LIGHT IS 13 WATT@860 LUMENS = 66 LUMEN PER WATT. WINDOWS ARE U=.51 AND SHGC=.34 OR BETTER DOOR U VALUE IS DEFAULT .6	

DRAWING INDEX:
 G-001 = COVER
 A-101 = FLOOR PLAN
 A-201 = EXTERIOR ELEVATIONS
 A-202 = INTERIOR ELEVATIONS
 A-301 = SECTION
 A-601 = NOT USED
 E-101 = ELECTRICAL PLAN
 M-101 = MECHANICAL(HVAC) PLAN
 P-101 = NOT USED
 SF-101 = FLOOR FRAMING PLAN
 SF-102 = FLOOR DECKING/WALL LAYOUT PLAN
 SF-103 = ROOF FRAMING PLAN
 S-101 = BLOCKING PLAN

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DATE: 05/18/2009	DRAWN BY: JPW	PROJECT: NORTEX 1644	TITLE: COVER SHEET AND SPECIFICATIONS
DATE: 05/18/2009	SCALE: NTS	SALES PERSON: JIM ATTRELL	DWG#: 1644 CLASS
			SHEET: G-001



AREA SCHEDULE						
DESIGNATION	DESCRIPTION	FLOOR AREA	FLOOR	WALL	CEILING	BASE
100	OPEN	693	CARPET	8' VINYL COVERED GYPSUM TYPE X	2'X4' LAY IN	4" RUBBER BASE

WINDOW SCHEDULE			
DESIGNATION	DESCRIPTION	PO	QTY
WI	3/10 2/3 ALUMINUM BRONZE FRAME, DOUBLE INSULATED LOW E GLASS HORIZ. SLDR W/ ALUMINUM MINI BLINDS	46 $\frac{1}{2}$ " x 27 $\frac{1}{2}$ "	2

DOOR SCHEDULE					
DESIGNATION	SIZE	DOOR MATERIAL	FRAME	RD	QTY
D1/D2	3068P/3068L ALT	STEEL W/ PENCIL VISION	STEEL	40 $\frac{1}{2}$ " X 82 $\frac{1}{2}$ "	1

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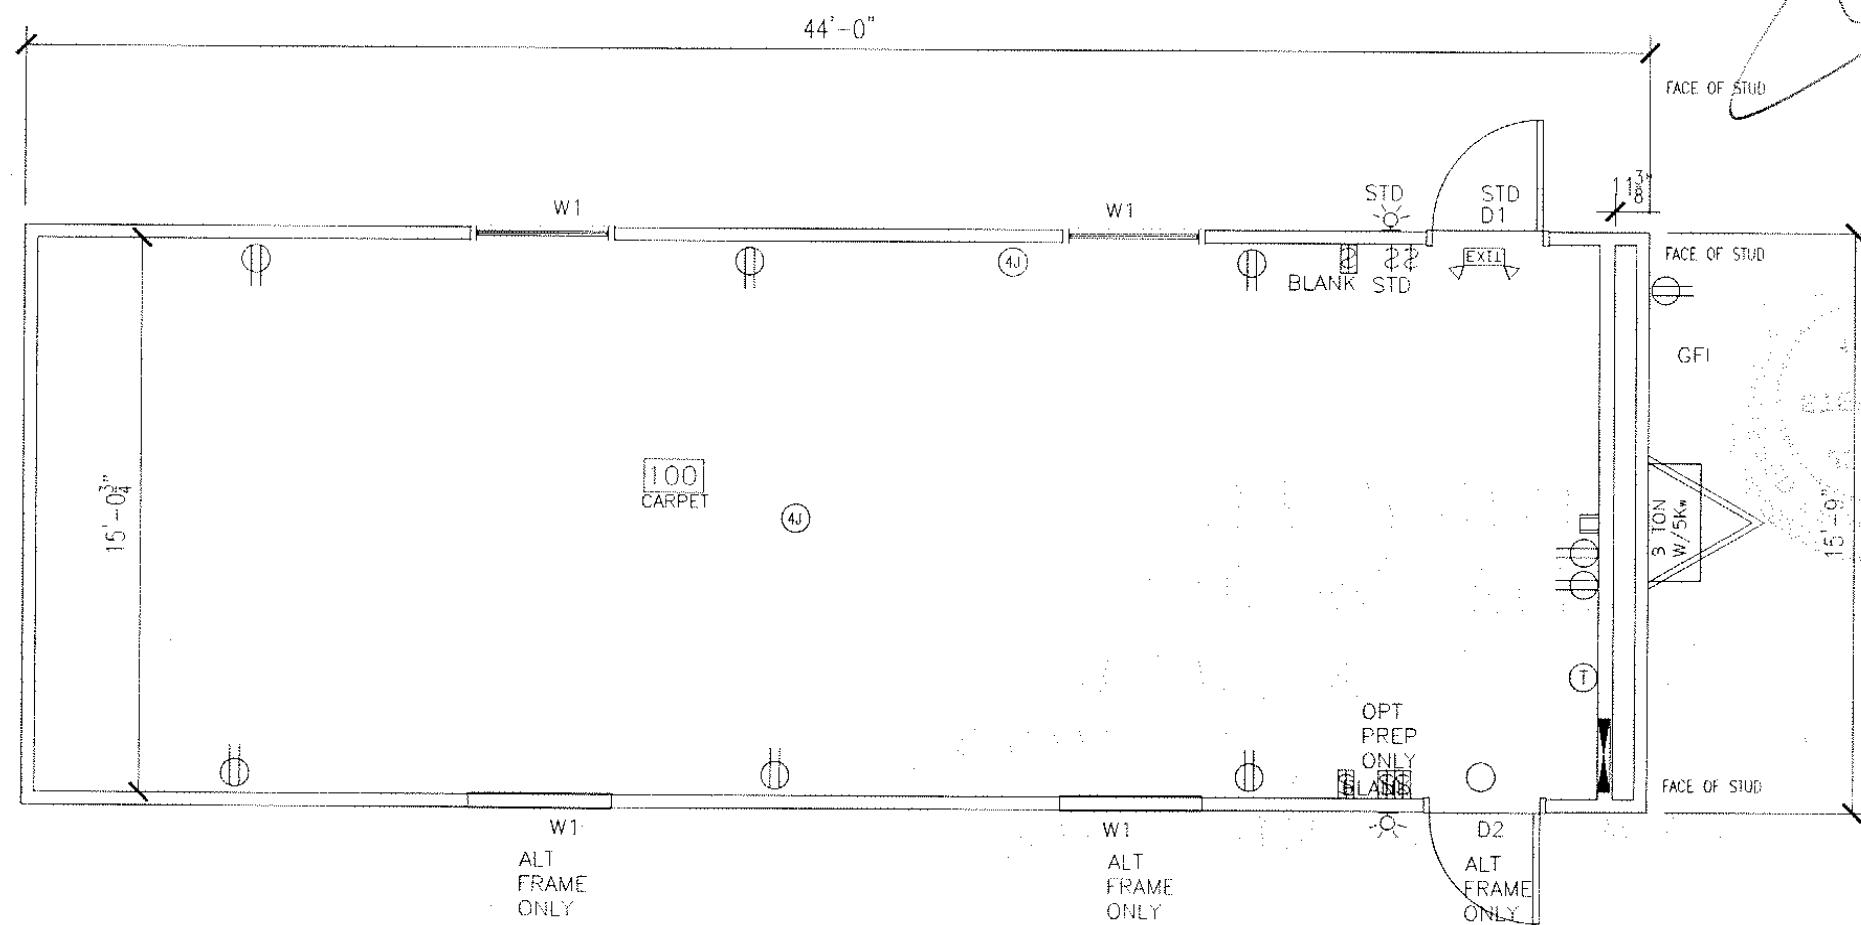
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Approval Date:

7/20/09




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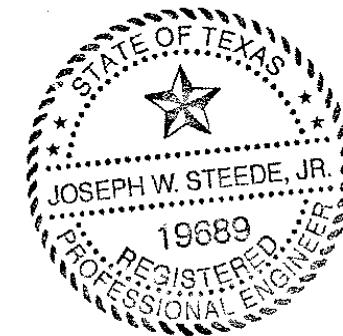
FLOOR PLAN

LTR	REVISION	BY	DATE	DRAWN BY: JPW	PROJECT: NORTEX 1644	TITLE: FLOOR PLAN		DALLAS, TX 75250 PHONE 972-238-1611
				DATE: 05/18/2009	SCALE: 1/4" = 1'-0"	SALES PERSON: JIM ATTRELL	DWG# 1644 CLASS	SHEET: A-101
							555 JUBILEE LANE LEWISVILLE, TX 75056 PHONE: 972-492-4040 FAX: 972-492-2704	



BACK ELEVATION

BACK END ELEVATION

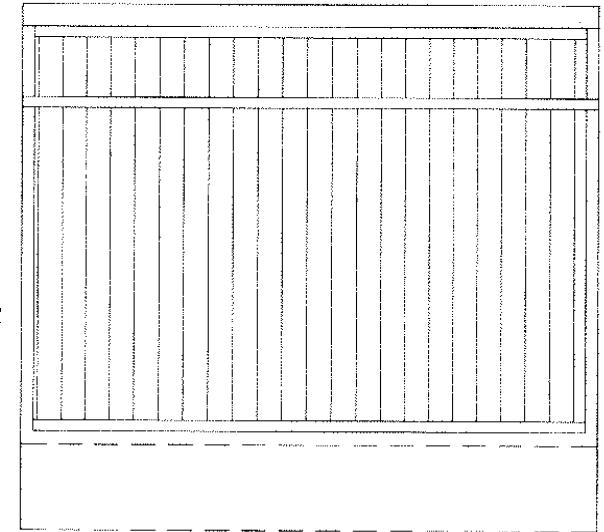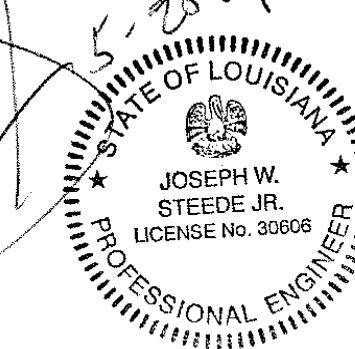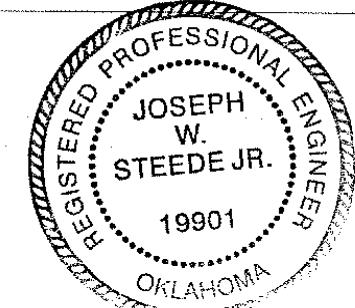


RAIN SHIELD
STEEL DOOR WITH VISION GLASS —
1/4" 12"
3 TON W/5FW
DR: SW6200 LINK GREY ALL TRIM

COLOR: SW6200 LINK GREY, A.I. TRIM
INCLUDED.

COLOR: SW6149 RELAXED KHAKI, ALL
TRIM INCLUDED

SKIRTING: FIELD APPLIED TO MATCH SIDING

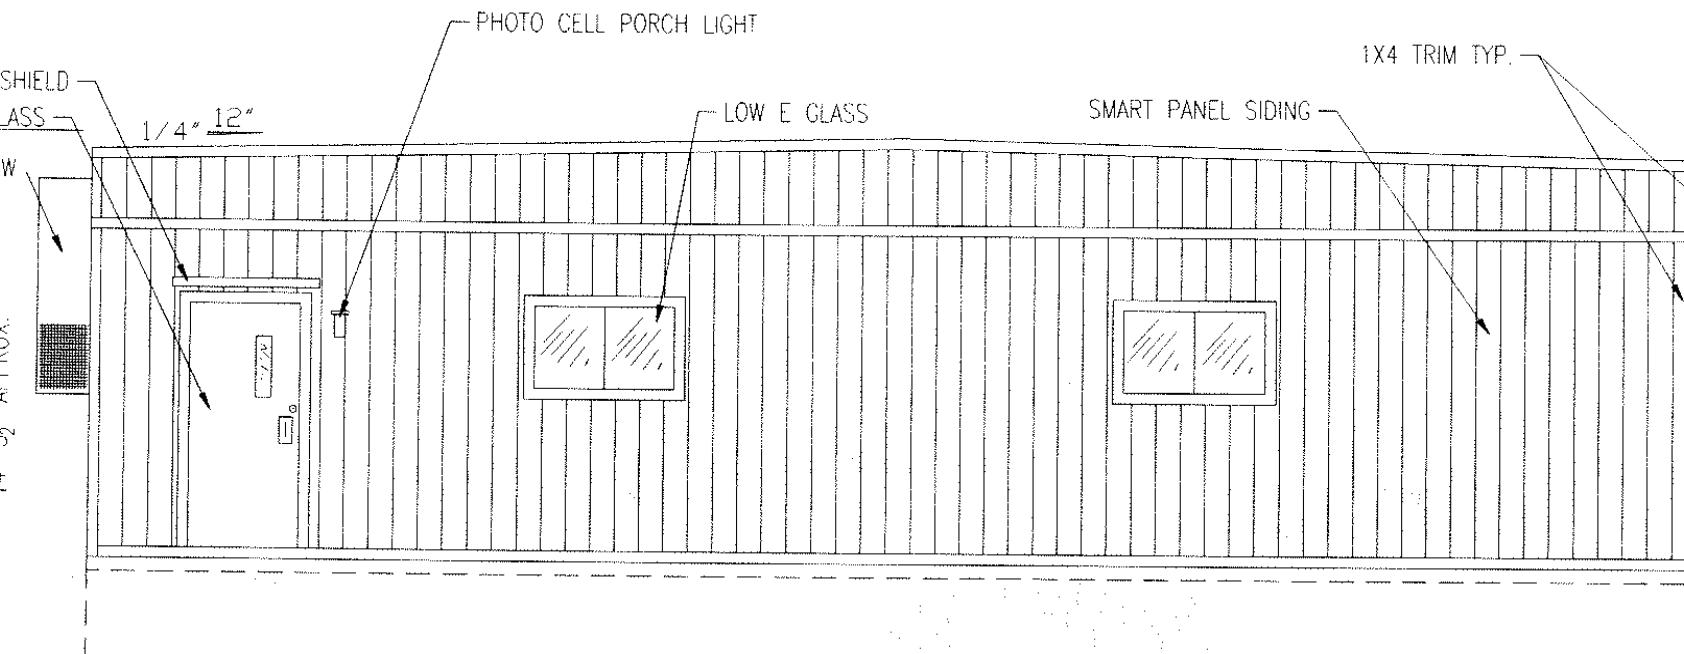


FRONT ELEVATION



HITCH END ELEVATION

REVISION	BY	DATE	DRAWN BY: JPW	PROJECT: NORTEX 1644	TITLE: ELEVATIONS		
			DATE: 05/22/09	SCALE: 3/16" = 1'-0"	SALES PERSON: JIM ATTRELL	DWG# 1644CLASS.STK	SHEET: A-203

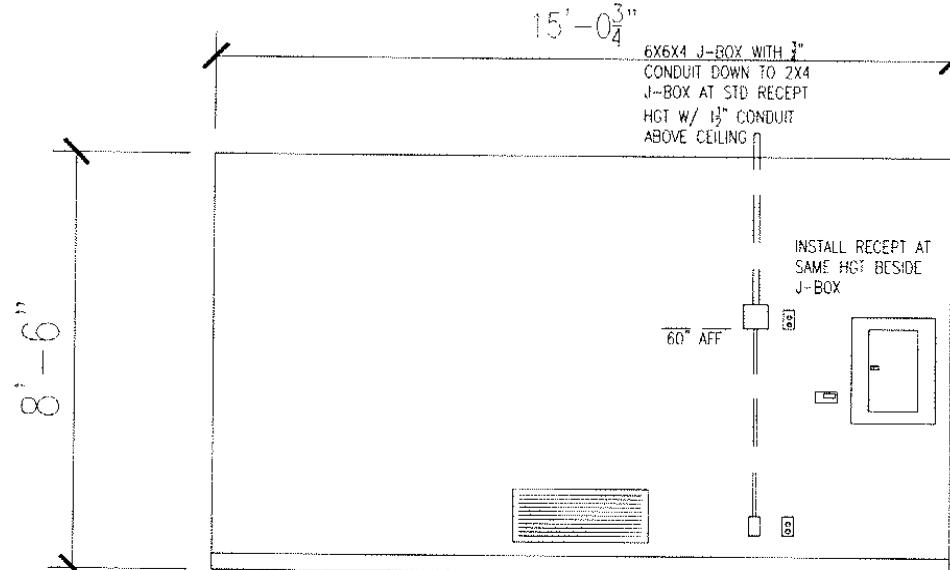

WALL ELEVATION


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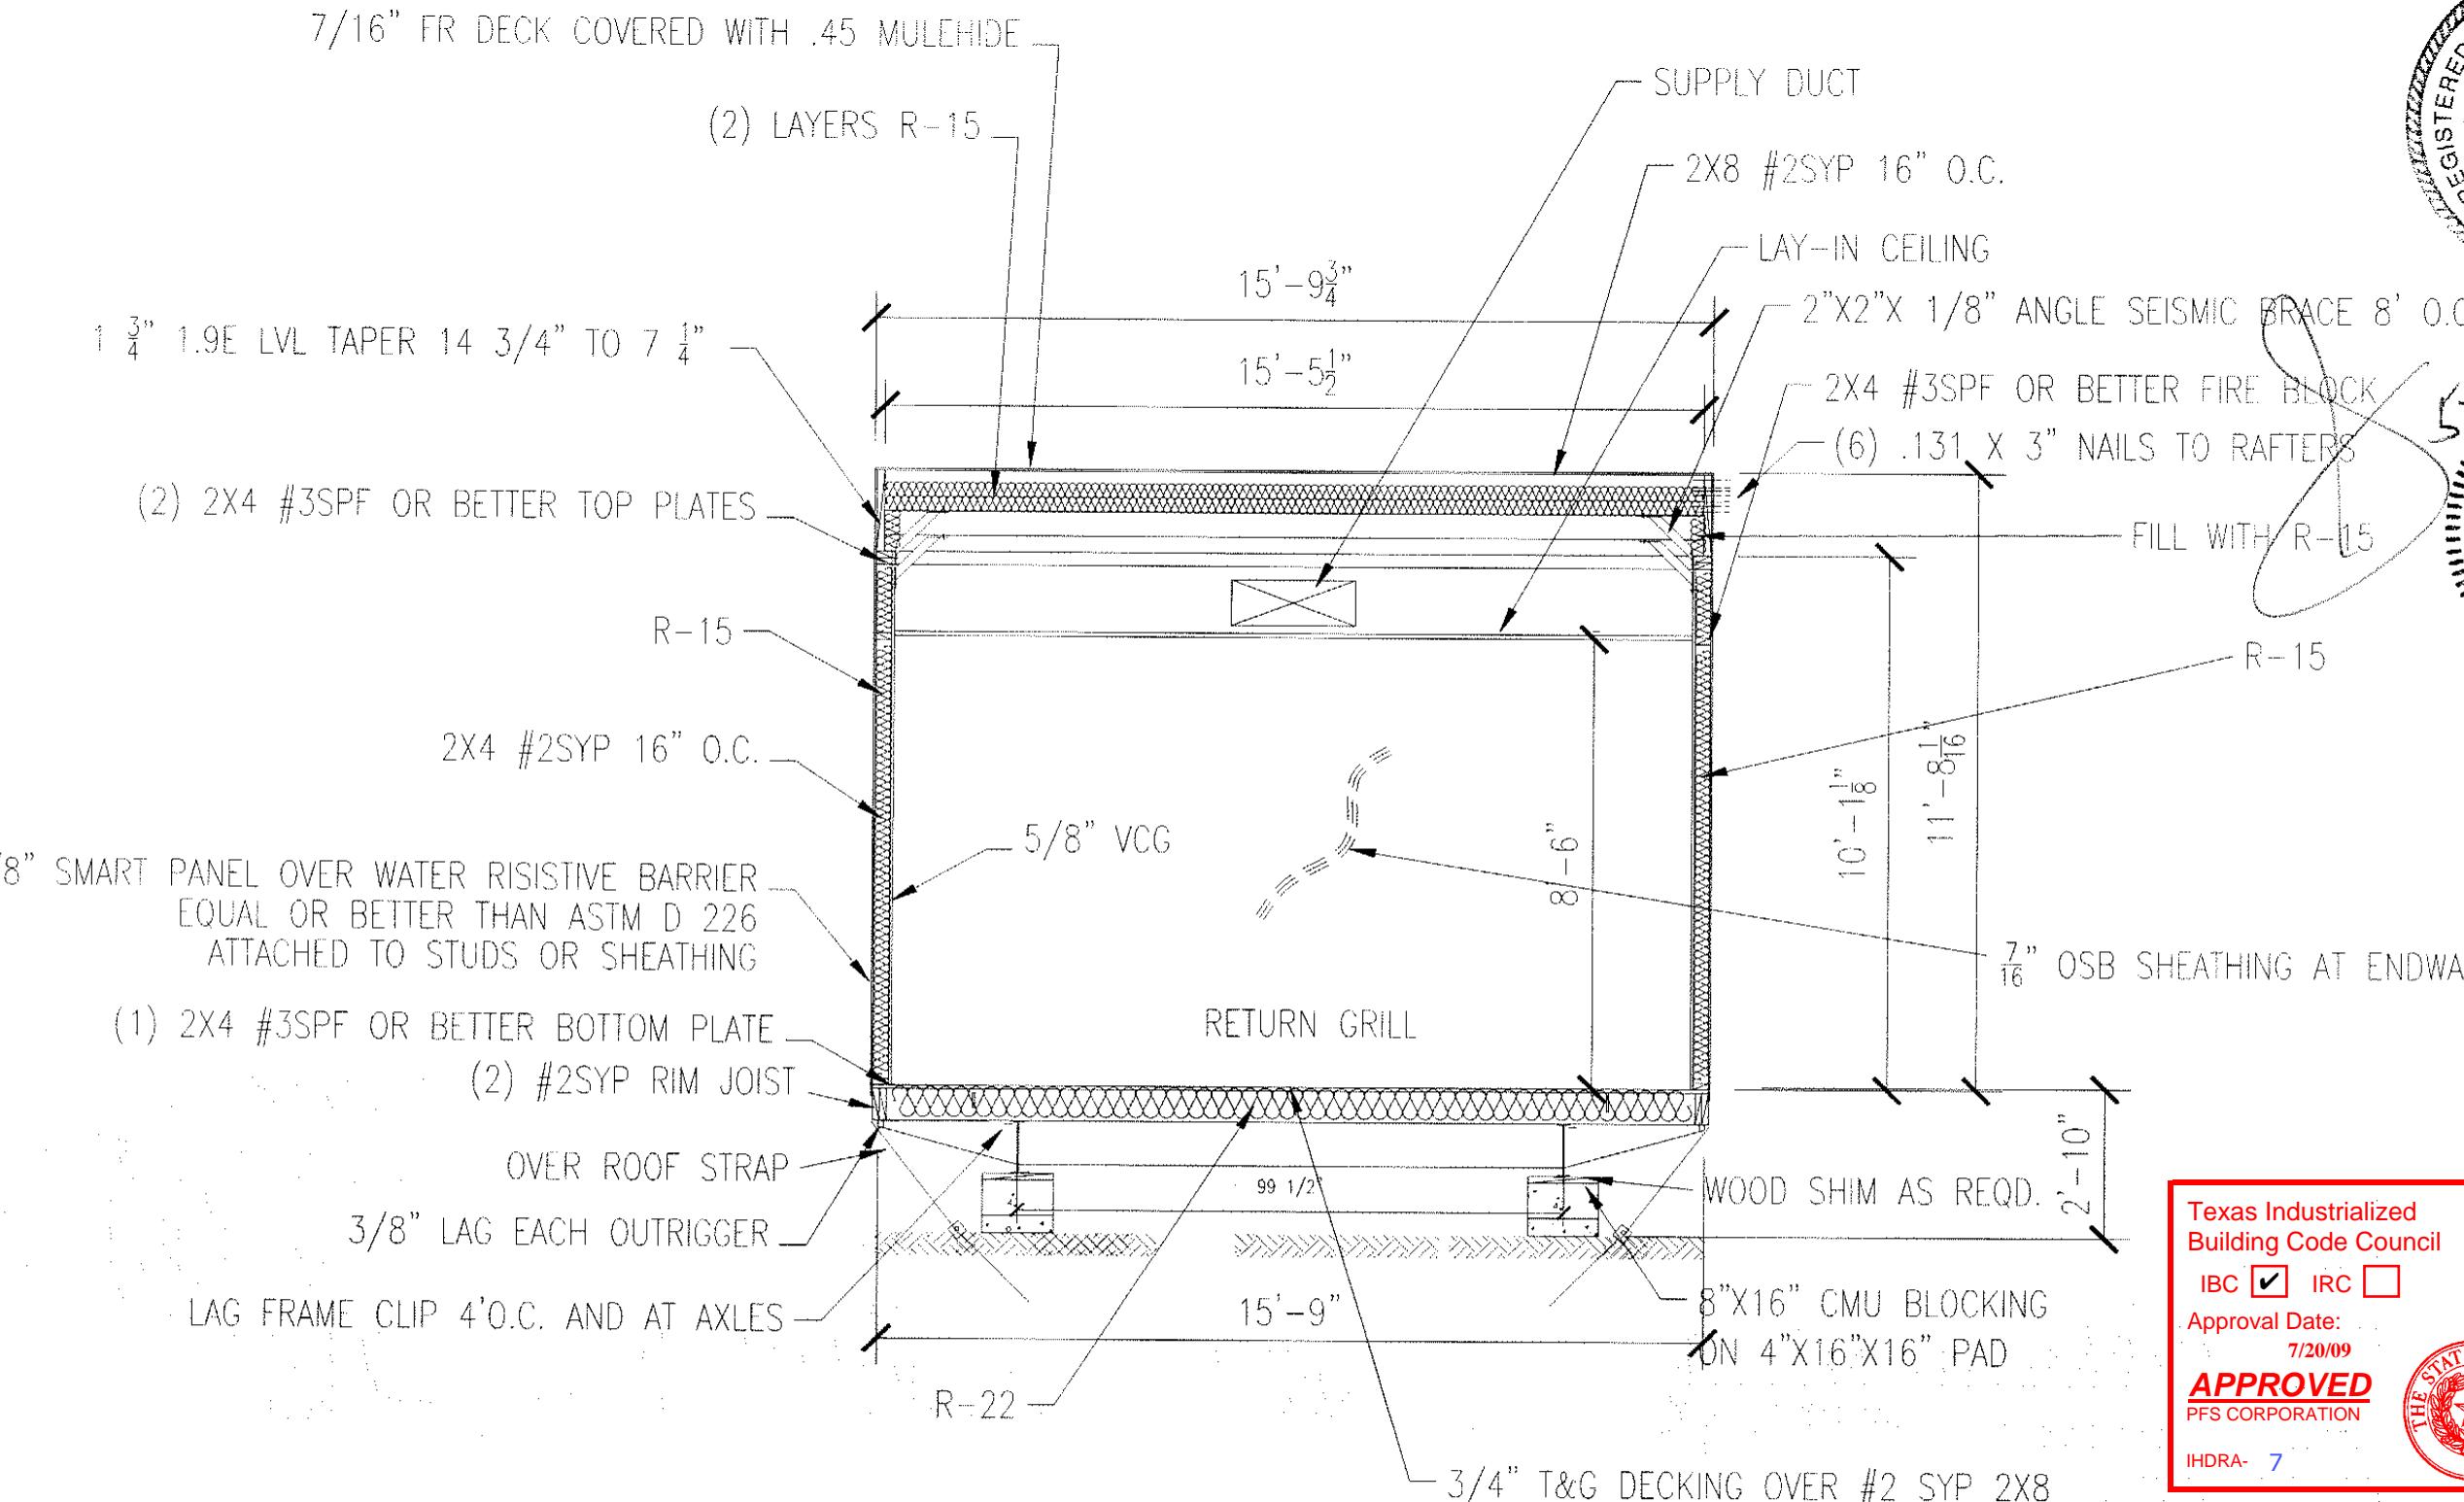
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LTR	REVISION	BY	DATE	DRAWN BY: JPW	PROJECT: NORTEX 1644	TITLE: INTERIOR ELEVATIONS		
				DATE: 05/22/09	SCALE: AS NOTED	SALES PERSON: JIM ATTRELL	DWG# 1644CLASS.STK	SHEET: A-202



SECTION VIEW

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LTR	REVISION	BY	DATE	DRAWN BY:	PROJECT:	TITLE:	DWG#	SHEET:	SECTION
				JPW	NORTEX 1644				

DATE:

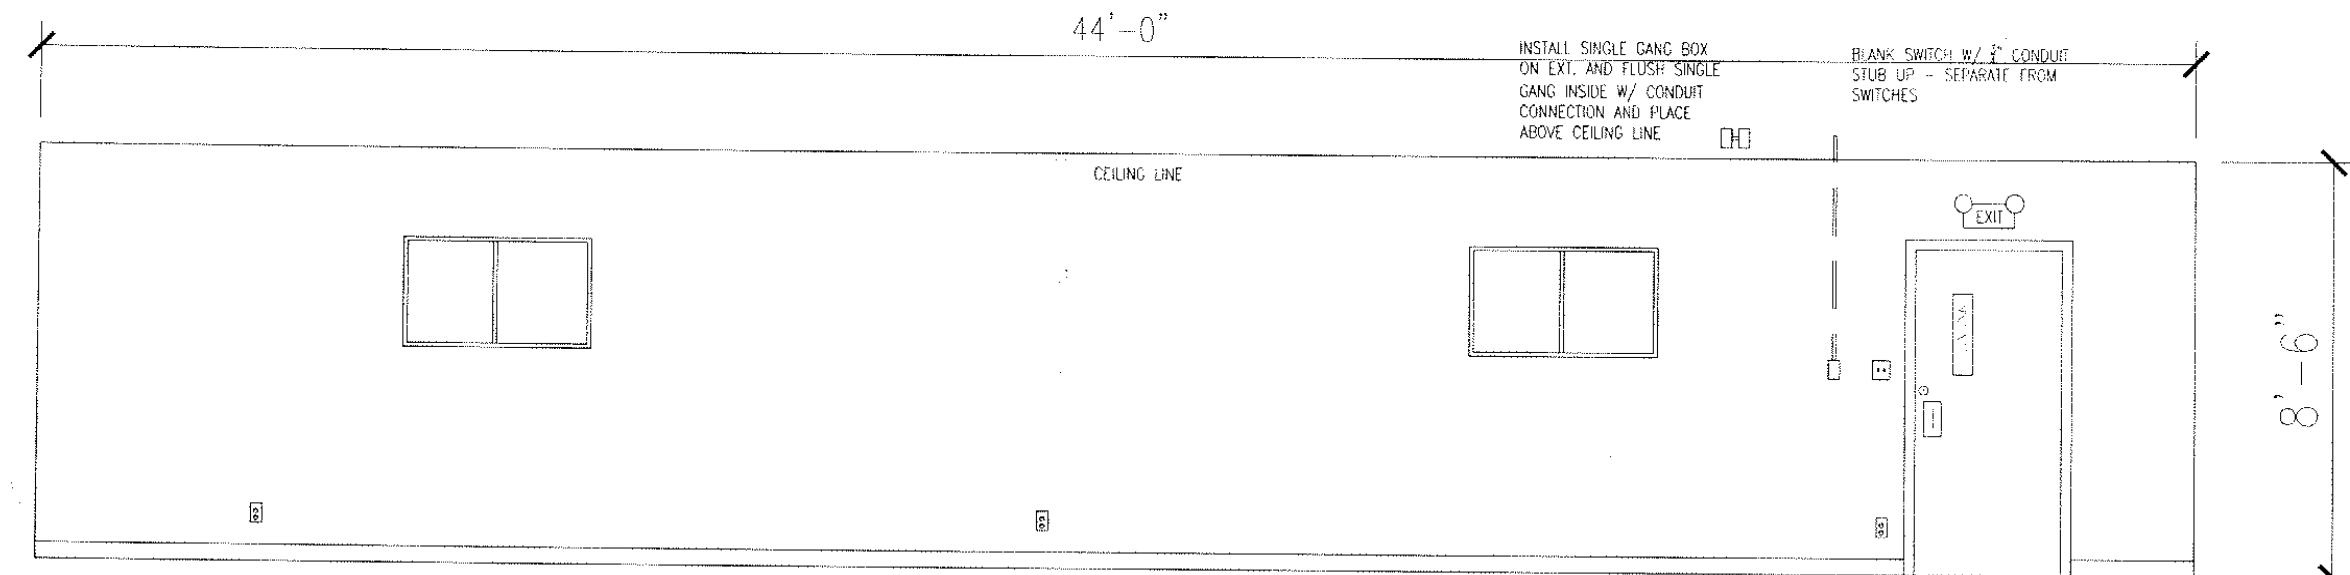05/22/09

SCALE:

1/4" = 1'-0"

SALES PERSON:

JIM ATTRELL




EO	ELECTRICAL DUPLEX OUTLET
4J	4-WAY JUNCTION BOX 110v
SBO	SURGE BLOC DUPLEX OUTLET
SS	MAIN SURGE SUPPRESSION
DO	DEDICATED OUTLET QUAD
HVAC	HEATING AND AIR UNIT
LF	LIGHT FIXTURE
GFI	GROUND FAULT INTERRUPT OUTLET
EF	EXHAUST FAN
WP	WEATHER PROOF
PL	PORCH LIGHT
SP	SERVICE PANEL
\$	SINGLE POLE SWITCH 120V
EeMAX	INSTANT WATER HEATER
EXEML	EXT/EMERGENCY LIGHT

MIN WIRE SIZE		100 AMP 2-POLE 120V/240V MAIN BREAKER	SINGLE PHASE						MIN WIRE SIZE	
			"A"		"B"					
			BREAKER	LEG	CKT	CKT	LEG	BREAKER		
	OPEN			A	1	2	A	60		
				B	3	4	B	2P		
12	RECEPTS	20	A	5	6	A	20		LIGHTS	
12	RECEPTS	20	B	7	8	B	20		GFI'S	


AMPS EA.	ITEM	WATTS EA
1.5	RECEPTS	180
0.77	LIGHTS 2'X4' 2-TUBE T-8	58
0.8	90 CFM EXHAUST FAN	88
0.31	LIGHT 2'X2' U-TUBE T-8	38
0.0333333	EMERGENCY/EXT	4
0.1083333	PORCH LIGHT	13
22.9	EeMAX	2633.5
47	HVAC	5170

PANEL SP-1 100 AMP 2-POLE 120V/240V SINGLE PHASE MAIN BREAKER CALCULATIONS				
LEG	CKT	DESCRIPTION	LEG A-AMPS	LEG B-AMPS
A	1	NOT USED	-	-
A	2	HVAC	47.00	-
B	3	NOT USED	-	-
B	4	HVAC	-	47.00
A	5	RECEPTS	4.50	-
A	6	LIGHTS	6.30	-
B	7	RECEPTS	-	6.00
B	8	GFI'S	-	1.50
A	9	NOT USED	-	-
A	10	NOT USED	-	-
B	11	NOT USED	-	-
B	12	NOT USED	-	-
			57.80	54.50
			6,358.18	5,995.00
AMPS	54.50	TOTALS	12,353.18	WATTS
W /20%	65.40		14,823.82	W / 20%
100AMP	OK	DIFF B-A	(363.18)	WATTS
		+/- 20%	-2.45%	OK
			67.38	AMPS

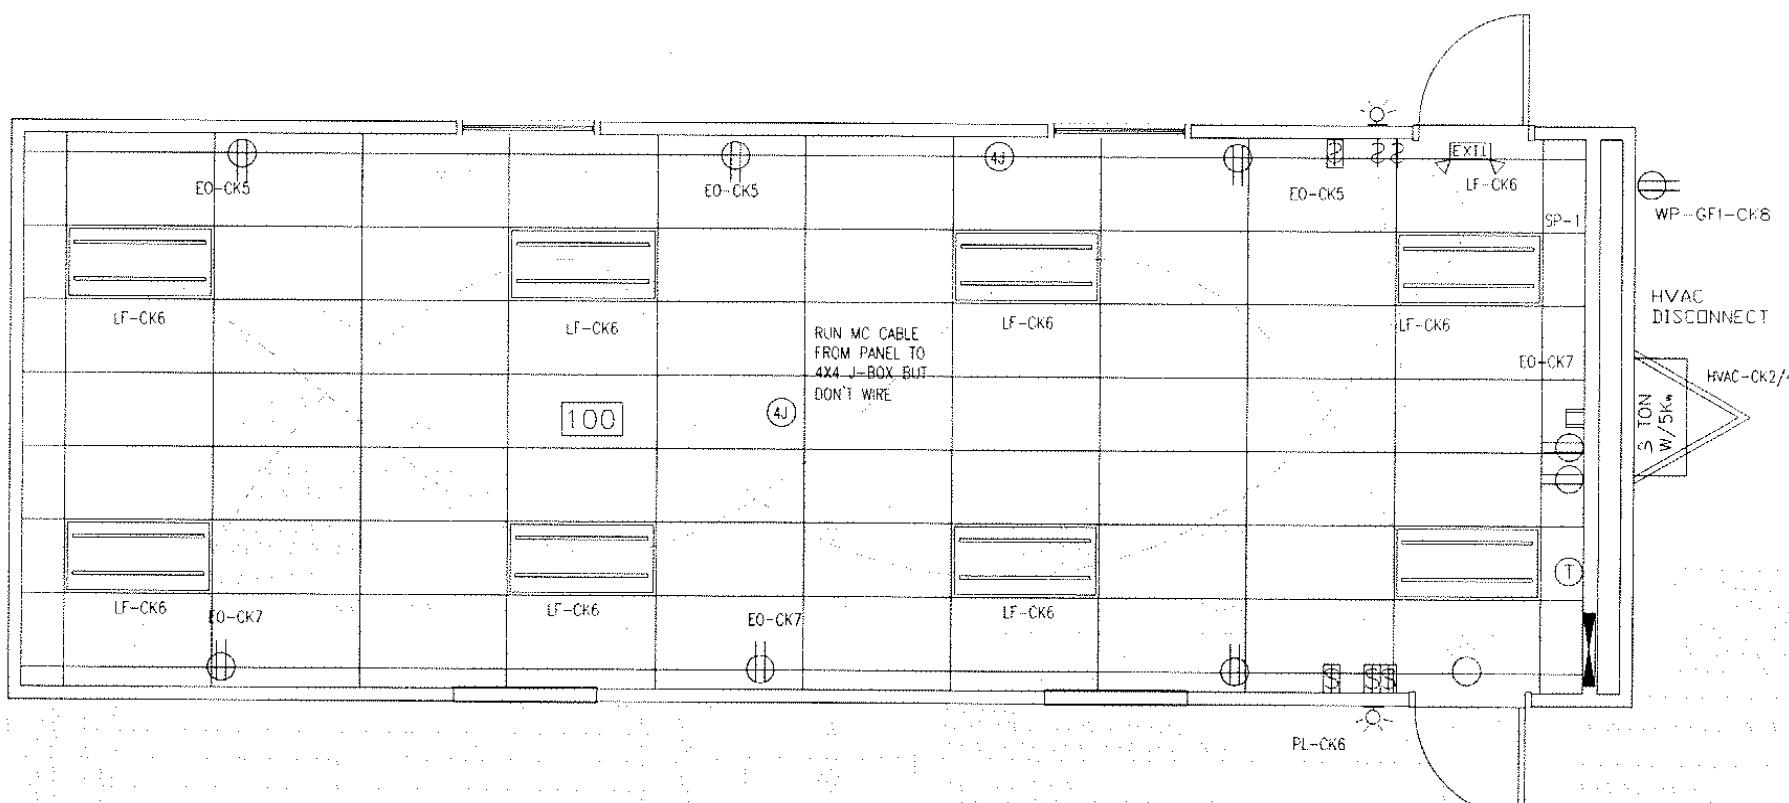

ELECTRICAL PLAN

LTR	REVISION	BY	DATE	DRAWN BY: JPW	PROJECT: NORTEX 1644	TITLE: ELECTRICAL	DWG# 1644CLASS.STK	SHEET: E-101	NORTEX MODULAR SPACE 555 JUBILEE LANE LEWISVILLE, TX 75056 PHONE: 972-492-4040 FAX: 972-492-2704
				DATE: 05/22/09	SCALE: 3/16" = 1'-0"	SALES PERSON: JIM ATTRELL			




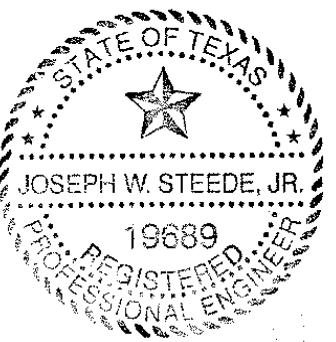


NOTES:
 1 MOUNT ALL OUTLET BOXES TO 16" AFF TO TOP OF BOX.
 2 2-TUBE LIGHT FIXTURE IS FIGURED AS 58 FIXTURE WATTS AND THE DU TUBE FIXTURE AS 38 WATTS.

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MECHANICAL SCHEDULE		
DESIGNATION	DESCRIPTION	COMMENTS
SA1	2X2 SUPPLY AIR REGISTER	NON-ADJUSTABLE
RAG	30X10 RETURN AIR GRILL	NONE
T	THERMOSTAT	PROGRAMMABLE
3 TON W/SKW	BARD MODEL	

OCCUPANTS	35
CFM REQ'D EACH	15 CFM
TOTAL OUTSIDE REQD	525 CFM

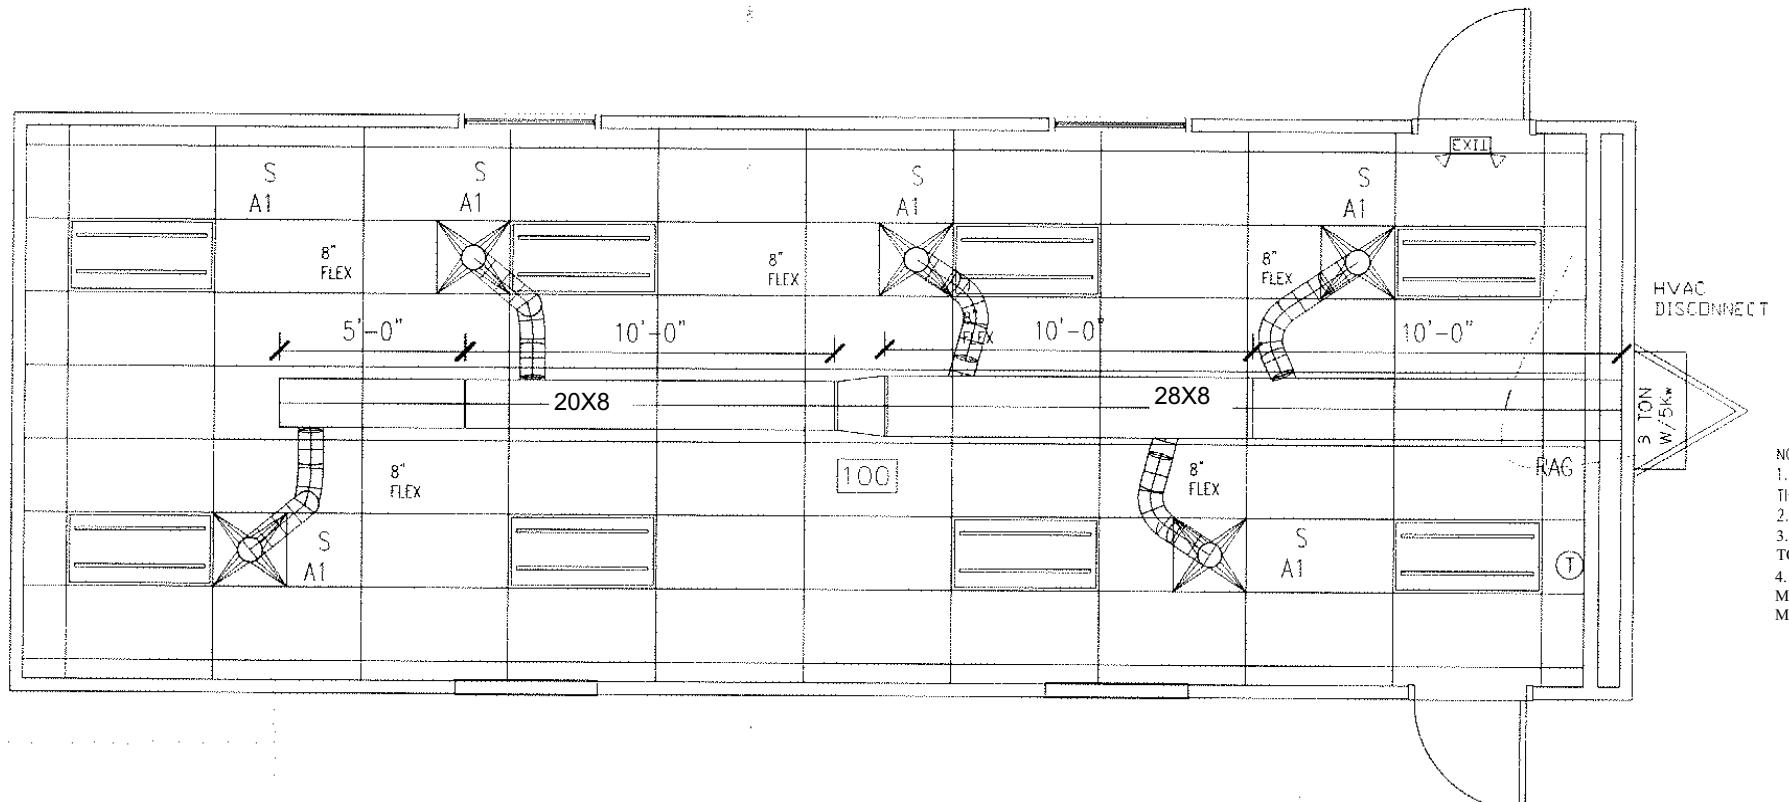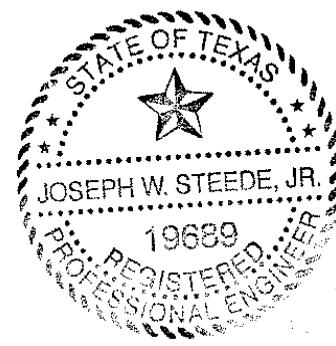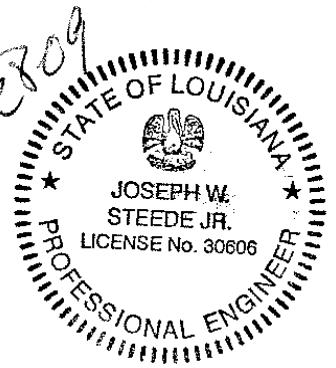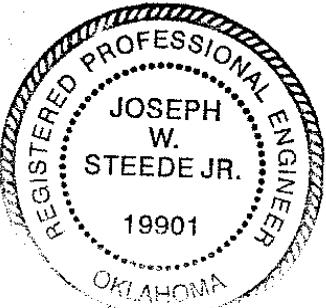

NOTES:
 1. FLEX DUCTS NOT TO BE CUT INTO MAIN DUCT LESS THAN 12" FROM A TRANSITION.
 2. ALL DUCTS TO HAVE A R-5 MINIMUM VALUE.
 3. 5Kw WILL BE REDUCED TO 3.75 IF 208V IS SUPPLIED TO PANEL.
 4. DUCT WORK SHALL BE SUPPORTED EVERY 4' (5' MAX.) W/ 1 1/2" WIDE MIN. STRAPS PER MANUFACTURERS INSTRUCTIONS.

MECHANICAL PLAN

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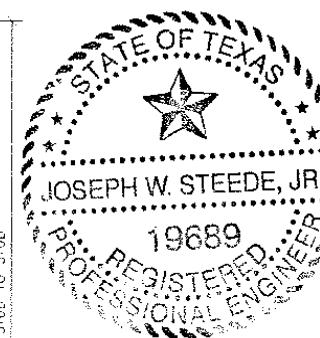
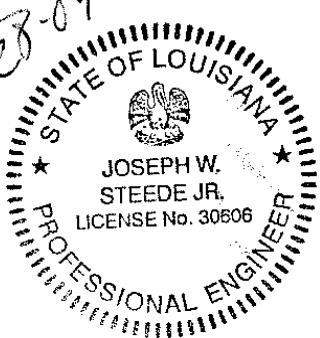
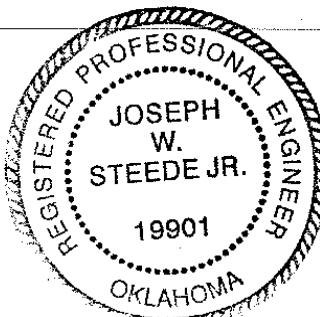
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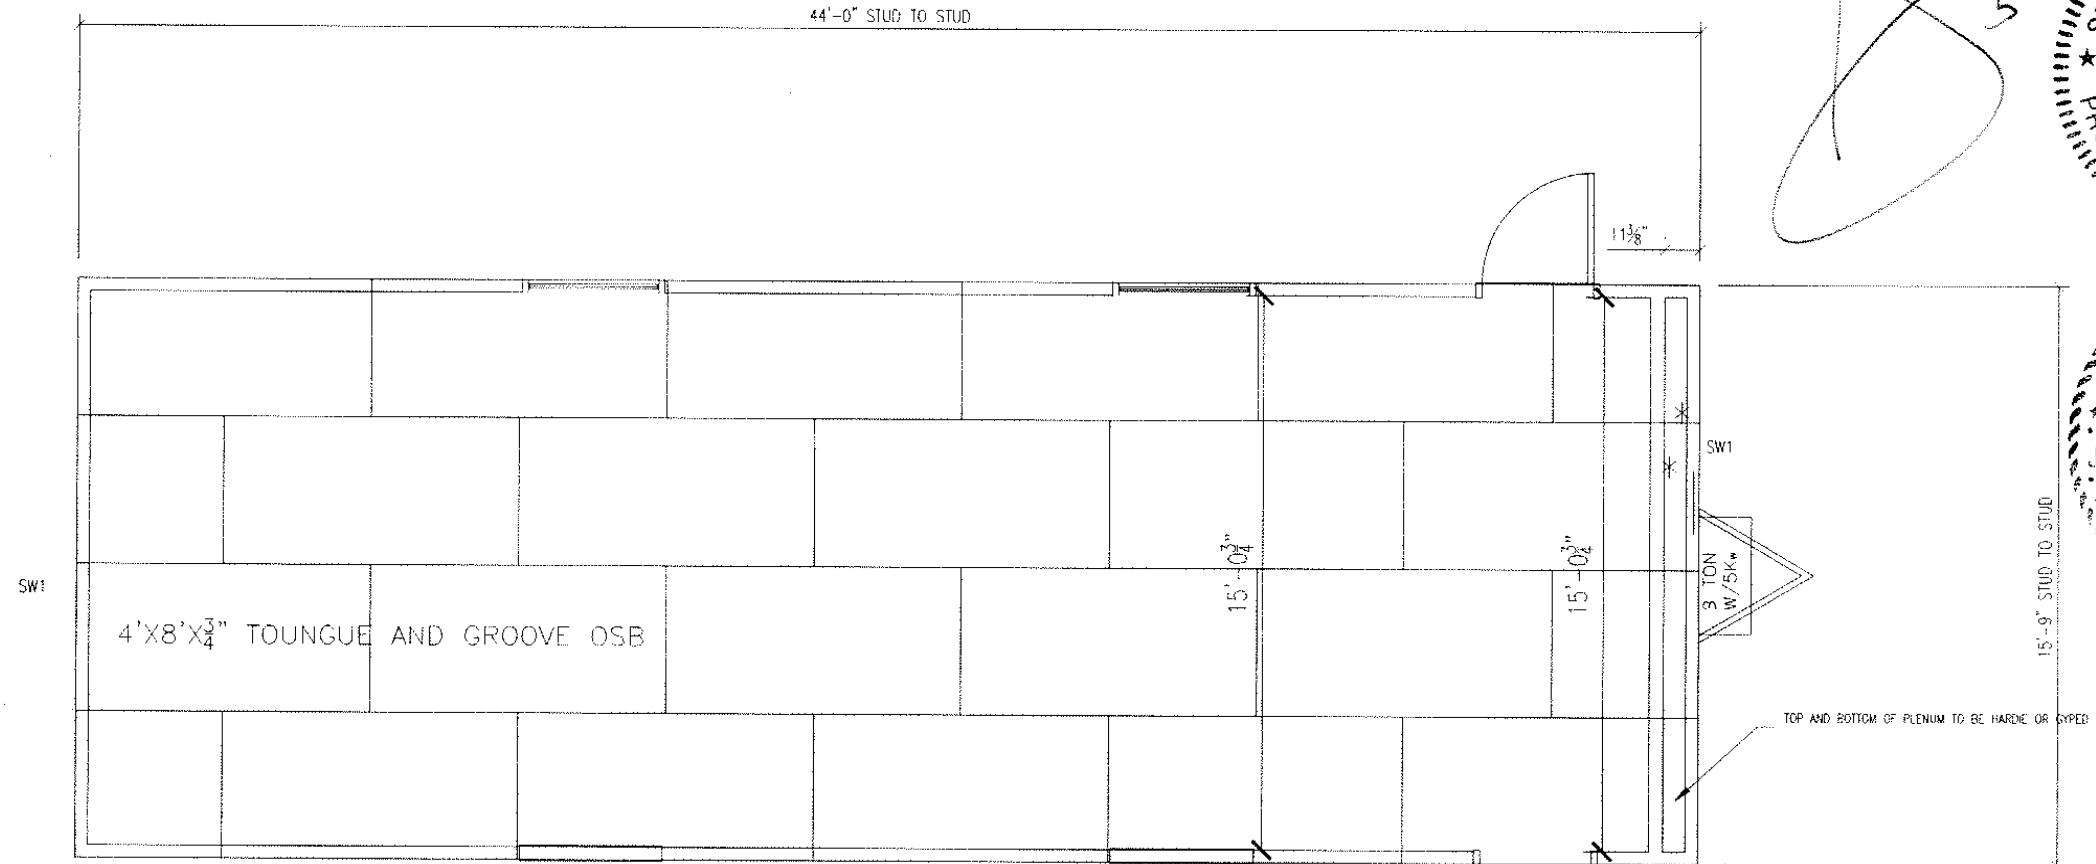


LTR	REVISION	BY	DATE	DRAWN BY: JPW	PROJECT: NORTEX 1644	TITLE: MECHANICAL	DWG#	SHEET:
				DATE: 05/22/09	SCALE: 3/16" = 1'-0"	SALES PERSON: JIM ATTRELL	1644CLASS.STK	M-101

SHEARWALL SCHEDULE					
MARK	MATERIAL	FASTEN STUDS TO SIDING	FASTEN BOTTOM PLATE TO DECK	FASTEN TOP PLATE TO LVL	FASTEN END TO SIDEWALLS
SW1	3/8" SMARTPANEL OVER 7/16" OSB ONESIDE. 5/8" VCG OTHER SIDE. 7/16" OSB SHEATHING TO STUDS W/ 0.131 NAILS 4' O.C. EDGE AND 8" O.C.	NAIL WITH .090 X 2 3/8" FOR 3/8" SMART PANEL 6"OC EDGE/12" OC FIELD. ADHESIVE VCG ON INTERIOR	0.131 X 3" NAILS 12" O.C.	0.131 X 3" NAILS 7" O.C. AND 4" O.C. WITH IN 4'-0" OF CORNERS - ADD 26GA STRAPS @ 32" W/ 6 - 8d NAILS EA END	.131 X 3" NAILS 16" O.C.



TOP AND BOTTOM EDGE OF SHEATHING SHALL BE NAILED WITH 0.148 10d NAILS 12" O.C. TO RIM JOIST



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Approval Date:

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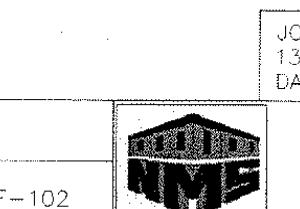
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FLOOR DECK / WALL LAYOUT PLAN


• DENOTES SIDE TO BE PREGYPED
DENOTES TO FINISH SIDE



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LTR	REVISION	BY	DATE	DRAWN BY:	PROJECT:	TITLE:	
				JPW	NORTEX 1644	FLOOR DECK/WALL PLAN	



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Building Code Council

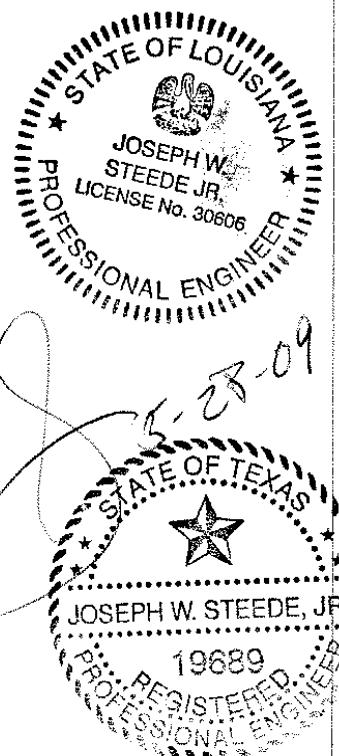IBC IRC

Approval Date

7/20/0

APPROVED
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MATERIAL:
JOIST: #2SYP 2X8 16' O.C.
RIM: 1.9E LVL TAPER CUT

**G= 20 GA STRAPS 32" O.C.
IF OCCURS AT OPENING
SPACE, ATTACH TO KING
STUDS EACH SIDE.**


ROOF JOIST PLAN

NOTES:

- NOTES:

 1. FILL CAVITY WITH (2) LAYERS R-15.
 2. BOTTOM OF JOIST TO BE NETTED.
 3. ROOF DECK TO BE FR $\frac{7}{16}$ " DECK PANEL.
 4. ROOF DECK NAILING TO BE 4"OC EDGE & 8"OC IN FIELD WITH MIN. 2 $\frac{1}{2}$ " SCREWS OR 2 $\frac{1}{2}$ " SCREW SHANK NAILS.
 5. NAIL JOIST TO LVL RIMS W/(3) .131 X 3"
 6. NAIL SPLICE BLOCKS W/(10) .131 X 3" EA. SIDE OF SPLICE

LTR	REVISION	BY	DATE	DRAWN BY: JPW	PROJECT: NORTEX 1644	TITLE: ROOF JOSIT PLAN		NORTEX MODULAR SPACE 555 JUBILEE LANE LEWISVILLE, TX 75056 PHONE: 972-492-4040 FAX: 972-492-2704
				DATE: 05/22/09	SCALE: 3/16" = 1'-0"	SALES PERSON:	DWG# 1644CLASS.STK	SHEET: SF-103

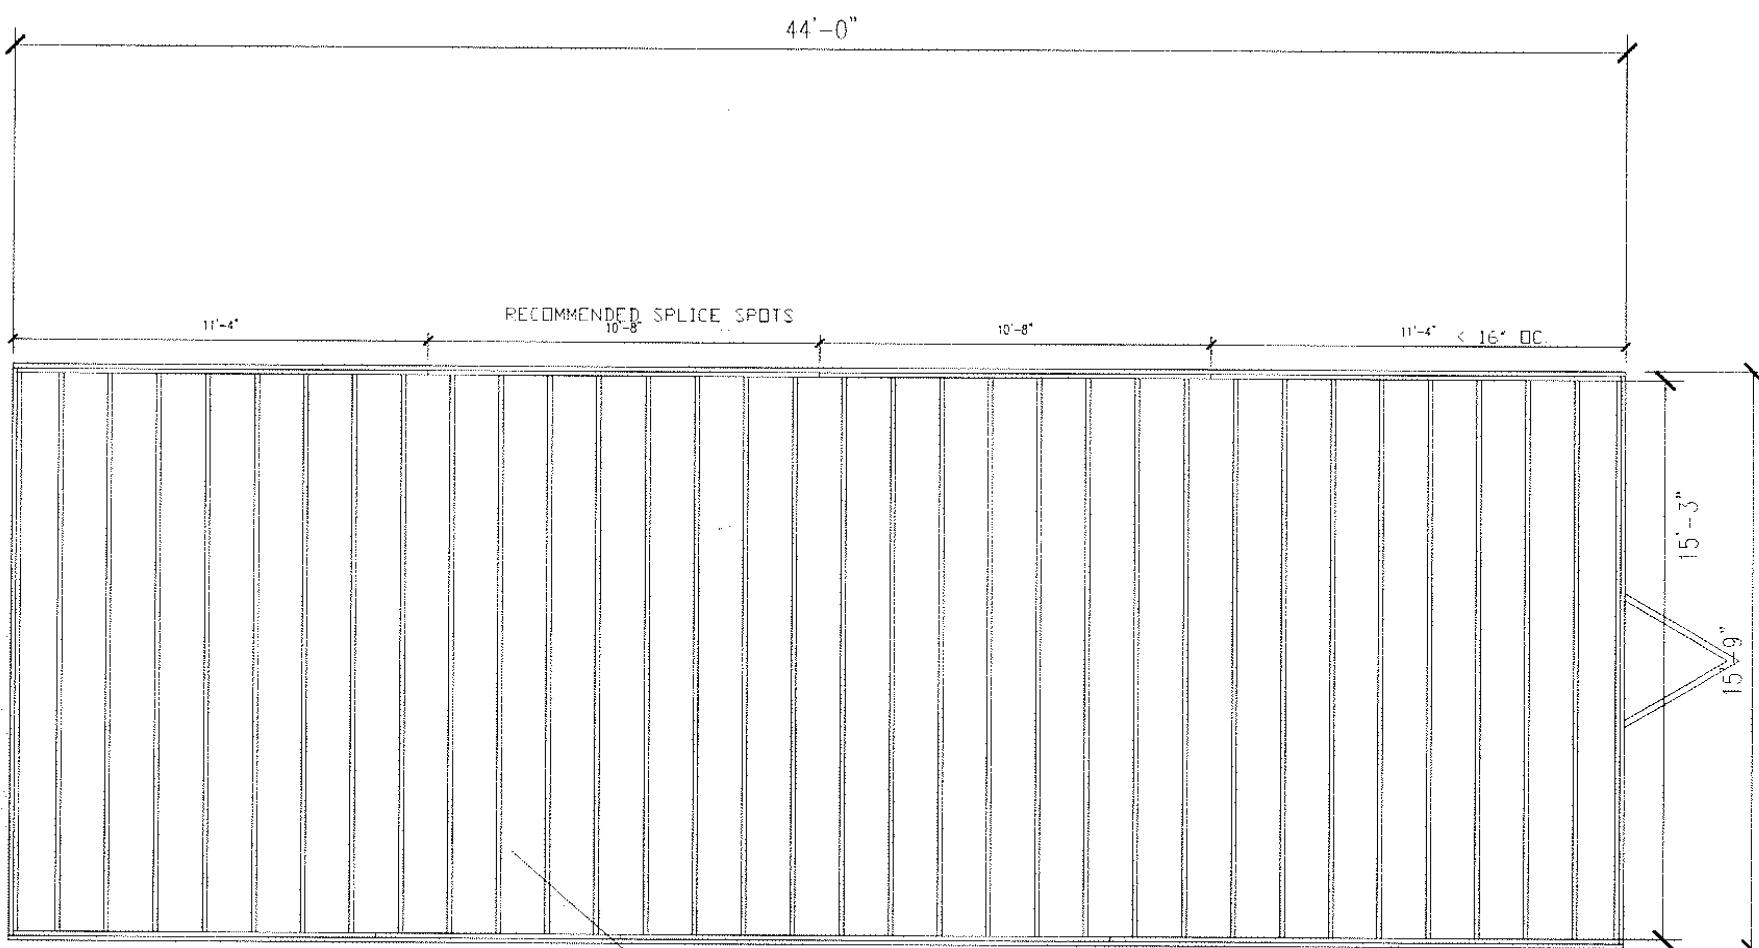

Texas Industrialized
Building Code Council

IBC IRC

Approval Date:

7/20/09

APPROVED
PFS CORPORATION

IHDRA- 7



2X8 #2SYP X15'-3" @16" O.C. TYP.

JOIST TO RIM: (5) .131x3" NAILS
OUTSIDE RIM TO ACT AS SPLICE BLOCK FOR
INSIDE RIM JOINTS, FOLLOW NAIL PATTERN IN
MANUAL (5) EACH SIDE OF JOINT.

FLOOR JOIST PLAN


JOE STEEDE, P.E.
13999 GOLDMARK, SUITE 374
DALLAS, TX 75250 PHONE 972-238-1611



NORTEX MODULAR SPACE

555 JUBILEE LANE
LEWISVILLE, TX 75056
PHONE: 972-492-4040
FAX: 972-492-2704






LTR	REVISION	BY	DATE	DRAWN BY: JPW	PROJECT: NORTEX 1644	SCALE: 3/16" = 1'-0"	SALES PERSON: JIM ATTRELL	TITLE: FLOOR JOIST	DWG# 1644CLASS.STK	SHEET: SF-101
				DATE: 05/22/09						

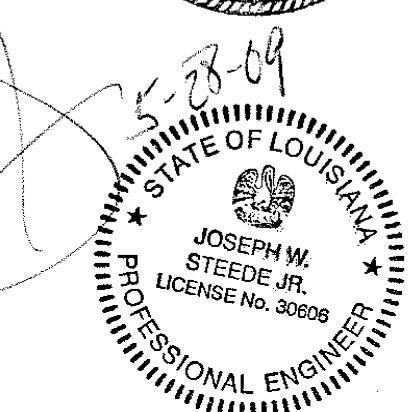

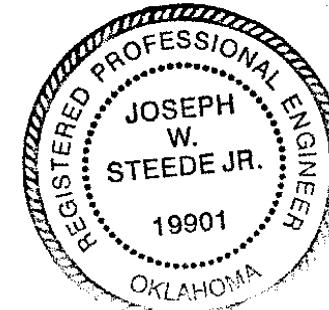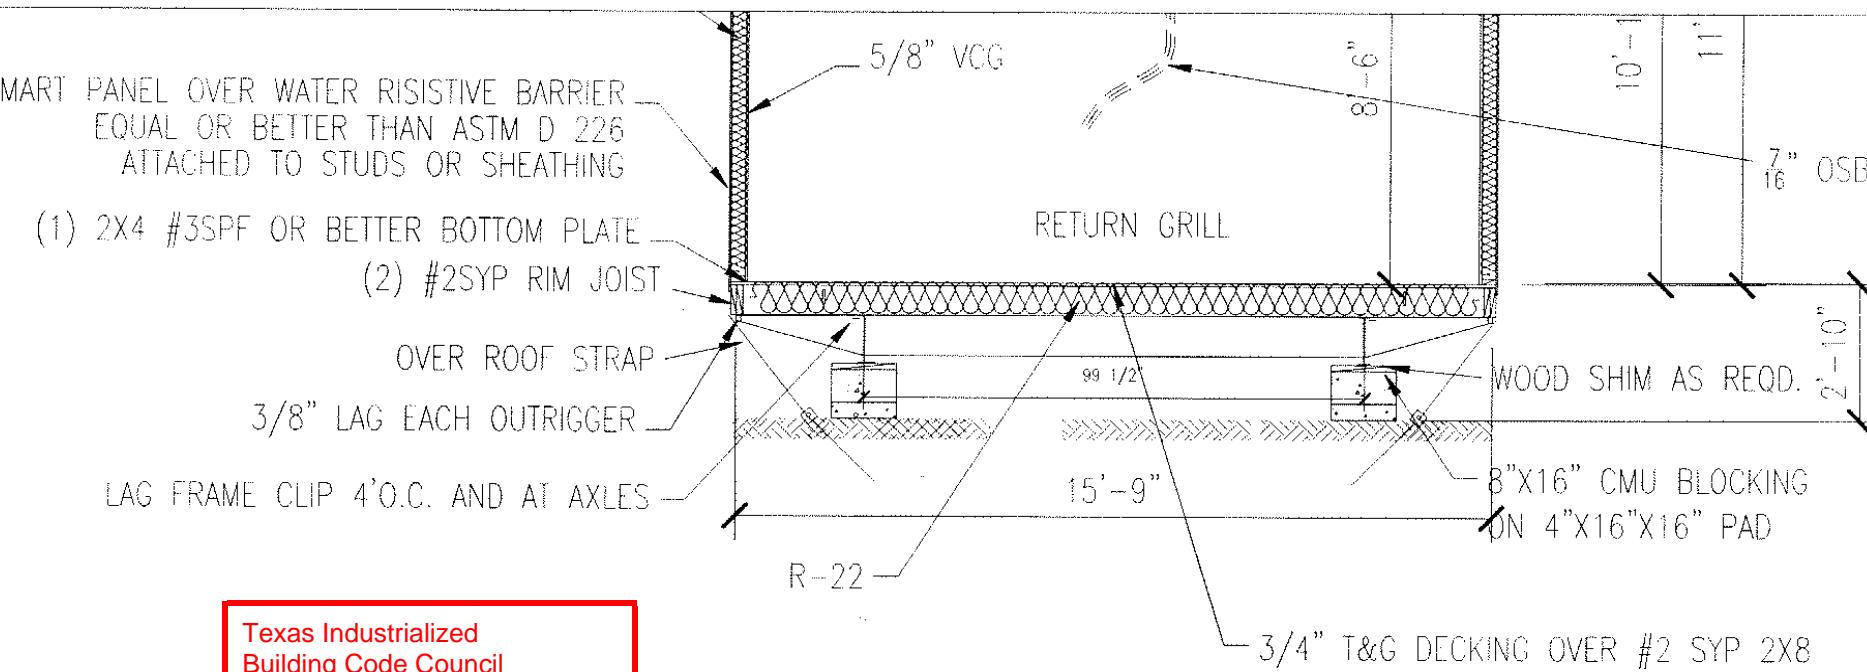

LAHUP
18-09

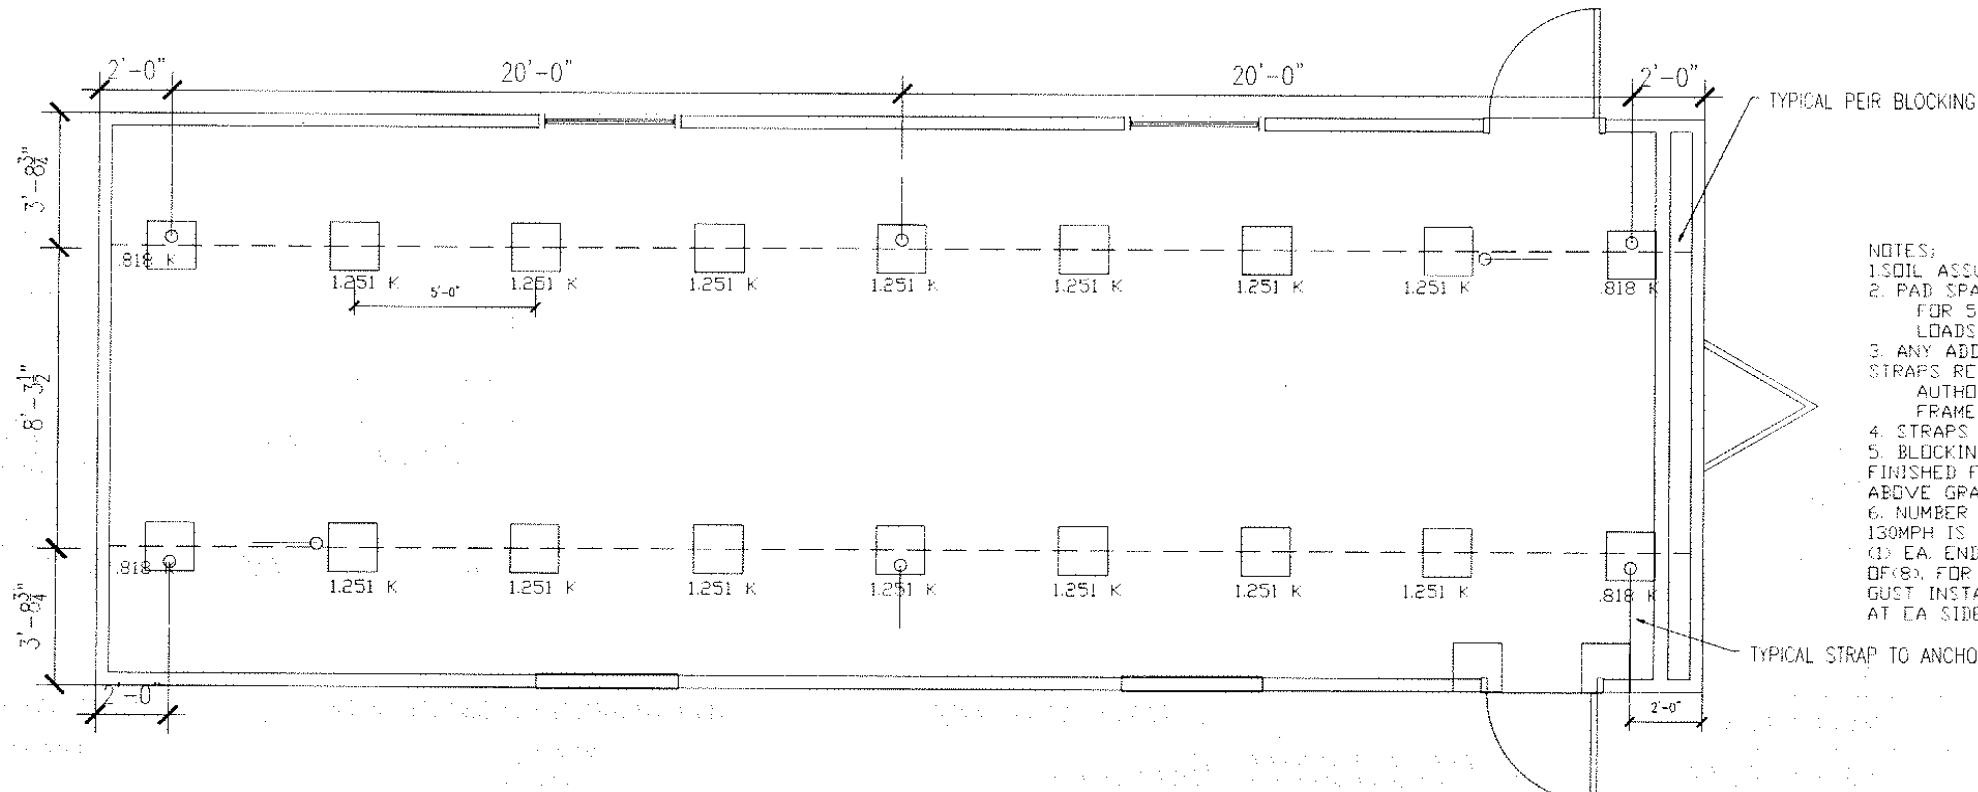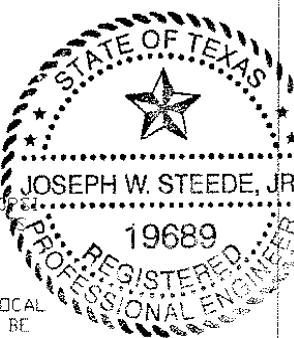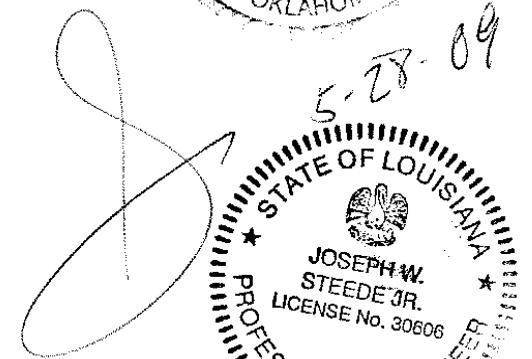

NOTES:

1. SOIL ASSUMED AT 2500PSI
2. PAD SPACING SHOWN IS FOR 50PSF FLOOR LOADS.
3. ANY ADDITIONAL TIE STRAPS REQUIRED BY LOCAL AUTHORITIES WILL BE FRAME TIE STRAPS.
4. STRAPS MAY BE +/- 1'-0"
5. BLOCKING SHOULD LEAVE FINISHED FLOOR APPROX. 34" ABOVE GRADE.
6. NUMBER OF TIES FOR 130MPH IS (3) EA. SIDE AND (1) EA. END FOR A TOTAL OF (8). FOR 90MPH/ 3 SEC GUST INSTALLATION USE (2) AT EA SIDEWALL.

BLOCKING PLAN

JOE STEEDE, P.E.
13999 GOLDFMARK, SUITE 374
DALLAS, TX 75250 PHONE 972-238-1611

LTR	REVISION	BY	DATE	DRAWN BY: JPW	PROJECT: NORTEX 1644	TITLE: BLOCKING PLAN	DWG# 1644CLASS.STK	SHEET: S-101	
				DATE: 05/22/09	SCALE: 3/16" = 1'-0"	SALES PERSON: JIM ATTRELL			