

DESIGN CRITERIA:	
PROJECT NAME: NORTEX STOCK 1460 J SERIES	BUILDING SQUARE FOOTAGE: 825 SF
2002 NEC IBC IMC 2003 IPC 2003 IECC 1994 TAS USE GROUP: B	
CONSTRUCTION TYPE: IBC: V-B	OCCUPANT LOAD: B A
PERMISSIBLE GAS TYPE: LP	NATURAL
N/A	

FLOOR:	
BOTTOM BOARD: ROLL, POLYETHYLENE FIBER MESH	INSULATION: R-19 FACED
JOIST: 2X8 #2SYP OR BETTER AT 16" O.C.	SIDEBOARD JOIST (RM): 2X8 #2SYP OR BETTER
DECKING: 3/4" T&G OSB(DRY GUARD), GLUED & ATTACHED W/ MN. 2-1/4" SCREWS	UNDERLAYMENT: 1/4" HARDIE PANEL, SCREWED
COVERING: 1/8" TILE: WHITE #51899; OFFICES 26OZ CARPET-SAND PEBBLES	BASE COVE: 4" RUBBER COLOR= GREY

ROOF:	
RAFTER: 2X6 #2SYP 16" O.C.	RM: SINGLE 2X6 #2SYP
SHEATHING: 7/16" MULE-HIDE FR DECK PANEL C A	COVERING: COLOR: BLACK STANDARD .045 MULE-HIDE EPDM ADHERED WITH MULE-HIDE A
BOTTOM RAFTER SHEATHING: 5/8" FIRE-X SHEETROCK -PERPENDICULAR TO RAFTERS	ACRYLIC WATER BASED BONDING ADHESIVE
ROOF PITCH: .25/12 TRANSVERSE	CEILING: 8'-6" HEIGHT. 2X4 LAYIN PANELS
INSULATION: R-22 FACED	PLENUM: A AREA ABOVE CEILING GRID TO BE A PLENUM RETURN.
VENTS: RAFTER SPACE TO BE IN ACCORDANCE WITH REQUIREMENTS OF LOCAL BUILDING OFFICIAL.	

TELECOM:	
WIRE: TELEPHONE CAT5E PLenum	COLOR: WHITE
LAN: CAT6 PLenum	COLOR: BLUE
JACKS: TELEPHONE R-11 (IVORY)	LAN: CAT6 (IVORY)
VOICE/DATA HOUSING: 28" TALL INCLOSURE WITH LOCKING COVER	J-BOXES: WIRED FOR (1) DATA,(1) VOICE
MODULES: 24 PORT TEL/LAN A	8 PORT SWITCH A
	4 PORT ROUTER A
PUNCH DOWN: DATA TO BE PUNCHED AS T-568A A	
DEMARC: MOUNTED AT HITCH END, WIRED TO CLOSET.	
CAT5, CAT5E AND RJ-45 RUNS TO CLOSET	
PLATES: IVORY 4-PORT, (2) COVERED	

DESIGN LOADS:	
ROOF LIVE LOAD: 30 PFS	FLOOR LIVE LOAD: 100 PFS (SEE S-101 FOR PER SPACING 50PSF)
CONC. FLOOR LIVE LOAD: 2000 LBS	WIND LOAD: (130 MPH 3-SEC GUST)
EXPOSURE: B	SEISMIC DESIGN CATEGORY: 1-D

SPECIAL CONDITIONS AND/OR LIMITATIONS:

1. HANDICAP ACCESS TO BE PROVIDED PER 1994 TAS AS REQUIRED BY OTHERS.
2. BUILDING TO BE LOCATED PER TABLE G02 OF THE 2003 IBC A
3. ANY REQUIRED ALARM SYSTEM WILL BE INSTALLED ON SITE BY OTHERS.
4. WATER FOUNTAIN SHALL BE FURNISHED BY OTHERS PER PC-2003 TABLE 403.1.
5. RAFTER SPACE VENTILATION TO BE IN ACCORDANCE WITH REQUIREMENTS OF THE A LOCAL BUILDING OFFICIAL. A

FOUNDATION NOTES:	
1. TIE DOWN ANCHORING SEE SHEET S-101	
2. CRAWL SPACE VENTILATION PROVIDED BY SITE INSTALLER PER 1203.3.1 OF 2003 IBC.	

SCOPE OF WORK:	
NOT INCLUDED IN SCOPE OF WORK	
1. UTILITIES AND UTILITY CONNECTIONS	
2. POURED CONCRETE (DRIVEWAY, SIDEWALK, SLABS, FOOTINGS, ETC.)	
3. SITE PREPARATION	
4. TAX OF ANY KIND	
5. BUILDING PERMITS	
SITE WORK	
1. NO PROVISION FOR SITE WORK HAS BEEN INCLUDED. IT IS PRESUMED THE SITE WILL PROVIDE CLEAR ACCESS FOR TRUCKS AND MODULARS.	
ADEQUATE DRAINAGE TO BE PROVIDED.	
2. ALL ELECTRICAL, PLUMBING, SEWER, & GAS SERVICE CONNECTIONS AND ALL CONCRETE WORK ONSITE, TO INCLUDE POURED FOOTINGS, SLABS, FOUNDATIONS, SIDEWALKS, DRIVEWAYS OF WHATEVER KIND ARE THE RESPONSIBILITY OF OTHERS.	

IDENTIFICATION	
STATE DECAL: TDLR DECAL AND MANUFACTURERS DATA PLATE ON ELECTRICAL PANEL.	A
DECAL: NORTEX PLACED ON FRONT LEFT OF BUILDING A	

FRAME / CHASSIS:	
OUTRIGGERS: 48" O.C.	CROSSMEMBERS: 48" O.C.
BEAM: 12" JR. I-BEAM	HITCH: DETACHABLE HITCH
AXLES: (5) W/BRAKES ON THREE AXLES, DRAG ON TWO L (10-PLY)	TRES: HEAVY
FRAME: HEAVY	

INTERIOR WALLS:	
WALL HEIGHT: FULL HEIGHT	STUDS: 2X4 #2SYP 16" O.C.
BOTTOM PLATE: SINGLE 2X4 #2SYP A	TOP PLATES: DOUBLE 2X4 #2SYP A
FIRE BLOCKS: 2X4 ON EDGE AT CEILING LINE	COVERING: 5/8" FIRE-X VCC COLOR: HAMTON GRAY
TRIM: STANDARD VCG BATTENS	5/8" GREEN BOARD AT RESTROOM COVERED WITH FRP
FRP: FULL HEIGHT AT RESTROOM	
INSULATION: R-13 UNFACED THROUGHOUT.	

DOORS:	
EXTERIOR: (1) 36"x80" 18GA STEEL W/ 5"x20" PENCIL WINDOW (TEMP)	EXTERIOR HARDWARE: (1) DEADBOLT (SCHLAGE) 6560 SD x 26D WIC CONSTR. CORE
	(1) 9305BC x AL NORTON CLOSER
	(1) HOLLOW METAL FRAME
	(2) FULL PLATES ROCKWOOD #107 x 70C X US26
	(1) PEMCO THRESHOLD 170A-36
	(1) PEMKO SWEEP 315CN-36
	(1) SET PEMKO WEATHERSTRIP 303AV-3070
INTERIOR: (3) 36"x80" MOHAWK SOLID CORE DOORS 1R/1L W/ 5x20 PENCIL WINDOW	(1) 24"x80" MOHAWK SOLID CORE DOOR
	(3) 3680 REDIFRAMES 478 BROWN 20GA
	(1) 2468 REDIFRAME 478 BROWN 20GA
INTERIOR HARDWARE: LEVER HANDLES.	(1) HEAVY DUTY PRIVACY ND40S X RHODES x 26D (SCHLAGE) RESTROOM
	(3) HEAVY DUTY ENTRY ND380 X RHODES x 26D (SCHLAGE) OFFICES W/ IC CONSTRUCTION CORE

ELECTRICAL:	
SERVICE: 120/208V SINGLE PHASE	LOAD CENTER: (1) 200 AMP, INT MOUNT LOAD CNT. W/ #6 BARE GROUND A
	ENTRANCE: 2" NIPPLE DOWN METAL
	WIRING: MC CABLE W/H #12 (#6 AT HVAC)
	LIGHTS: (11) 48" T-8 (3) TUBE 32 WATT FLUOR. FIXTURES (92 FIXTURE WATTS)
	(1) PHOTO CELL EXTERIOR 13 WATT @ 660 LUMENS = 66 LUMEN PER WATT
	(1) 24" T-8 U SHAPE (1) 32 WATT FLOURESCENT- (38 FIXTURE WATTS)
	FANS: (1) 90 CFM EXHAUST IN BATHROOM VENT THRU ROOF NUTONE 671R
	SURGE PROTECT: (1) WIRED INTO SERVICE PANEL.
	EXIT/EMERG. LIGHT: (1) EXIT/EMERGENCY LIGHT BATTERY BACK UP.
	RECEPTS: (5) STD. 120V DUPLEX RECP (10) SURGE BLOCK DUPLEX REC.
	(3) GFCI 120V STD. DUPLEX RECEPTACLES
	(1) W.P. EXT. GFCI 120V RECEPTACLE
	(1) DEDICATED 120V SURGE PROTECTED DUPLEX RECEPTACLE (COM RM)
	SWITCHES: (4) OCCUPANCY SENSORS (INFRARED ULTRA SONIC) LEVITONIZED BUILDING
J-BOXES: ALL PLATES TO BE IVORY	TEXAS INDUSTRIALIZED BUILDING
ALARM: N/A	This document is approved pursuant to the Texas Industrialized Housing and
MSC: GROUNDING ON SITE TO BE PER NEC 2002, 250-95	CODE COUNCIL

PLUMBING: No. 7 IBC ✓ IRC	
WATER SUPPLY: TYPE "L" COPPER	WASTE: PVC SCHEDULE 40
	Date 9/19/07 DPA Signature I.C. M. Kunkel A
WATER HEATER: (1) E-MAX SP55 SUPPLY TO BOTH SINKS WITH SET OF 105-110F DEGREE	
WATER CLOSET: (1) HANDICAP FLUSH VALVE ELONGATED L/HANDLE	
LAVATORY: HANDICAP WALL HUNG, COVER UNDERNEATH HANDLES	
BAR SINK: (1) STAINLESS STEEL COUNTER LAV, DUAL LEVER FAUCET.	
ACCESSORIES: 36" AND 42" GRAB BARS, TOILET PAPER HOLDER.	
NOTE: ALL FIXTURE MOUNTING PER TAS 1994	

ENERGY CODE COMPLIANCE	
NOTE: ALL MAILING PATTERNS SHOWN ON SF PAGES SHALL OVERRIDE DESIGN MANUAL.	
COMCHECK CERTIFICATES TO BE USED AS CHECKLIST.	
3 TUBE LIGHT FIXTURE IS 92 FIXTURE WATTS	
2X2- U TUBE FIXTURE IS 38 FIXTURE WATTS	
EXTERIOR LIGHT IS 13 WATT @ 660 LUMENS = 66 LUMEN PER WATT.	
WINDOWS ARE U=.87 AND SHGC=.66 OR BETTER A	
OCCUPANCY SENSORS USED AT ALL LOCATIONS	
DOOR U VALUE IS DEFAULT .7 A	

DRAWING INDEX:
 G-001 = COVER
 A-101 = FLOOR PLAN
 A-201 = EXTERIOR ELEVATIONS
 A-202 = INTERIOR ELEVATIONS
 A-301 = SECTIONS
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 E-101 = ELECTRICAL PLAN
 M-101 = MECHANICAL(HVAC) PLAN
 P-101 = PLUMBING PLAN
 P-601 = NOT USED
 SF-101 = FLOOR FRAMING PLAN
 SF-102 = FLOOR DECKING/WALL LAYOUT PLAN
 SF-103 = ROOF FRAMING PLAN
 SF-201 = WALL FRAMING PLAN
 SF-202 = WALL FRAMING PLAN
 S-101 = FOUNDATION PLAN
 S-102 = NOT USED
 S-501 = NOT USED
 T-101 = TELECOM PLAN

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AREA SCHEDULE							
DESIGNATION	DESCRIPTION	FLOOR AREA	CUBIC AREA	FLOOR	WALL	CEILING	BASE
100	OFFICE	121	1051	CARPET	8' VINYL COVERED GYPSUM TYPE X	2'X4' LAY IN	4" RUBBER BASE
101	BATHROOM	42	364	TILE	FRP OVER 8" GYPSUM TYPE X	2'X4' LAY IN	4" RUBBER BASE
102	WORK AREAS AND SINK AREA	449	3891	TILE	8" VINYL COVERED GYPSUM TYPE X	2'X4' LAY IN	4" RUBBER BASE
103	OFFICE	121	1051	CARPET	8" VINYL COVERED GYPSUM TYPE X	2'X4' LAY IN	4" RUBBER BASE
104	TELECOM	5	43	TILE	8" VINYL COVERED GYPSUM TYPE X	2'X4' LAY IN	4" RUBBER BASE

DOOR SCHEDULE					
DESIGNATION	SIZE	DOOR MATERIAL	FRAME	RD	QTY
D1	3068L	STEEL W/ PENCIL VISION	STEEL	40 $\frac{1}{2}$ " X 82 $\frac{1}{2}$ "	1
D2	3068L	MOHAWK SOLID CORE W/ VISION GLASS	REDIFRAME	37" X 81"	1
D3	3068R	MOHAWK SOLID CORE W/ VISION GLASS	REDIFRAME	37" X 81"	1
D4	3068L	MOHAWK SOLID CORE	REDIFRAME	37" X 81"	1
D5	2068R	MOHAWK SOLID CORE	REDIFRAME	25" X 81"	1


WINDOW SCHEDULE			
DESIGNATION	DESCRIPTION	RD	QTY
W1	2044 ALUMINUM BRONZE FRAME, DOUBLE INSULATED LOW E GLASS W/ ALUMINUM MINI BLINDS	24 $\frac{1}{2}$ " X 52 $\frac{1}{2}$ '	9

COMCHECK AREA


(1) SIDEWALL = 60' X 10'-0 3/4" = 618SF + PEAK AREA OF 18SF = 636SF

STANDARD WALL = 131-9" X 10'-0 3/4" = 137.95 ft

SIDEWALL X 3 = 1373SF + ENDWALL X 3 = 275.8 FOR A TOTAL OF 1547.8

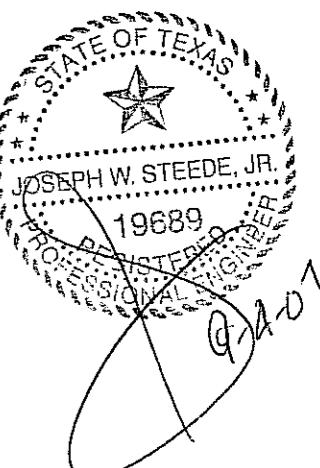


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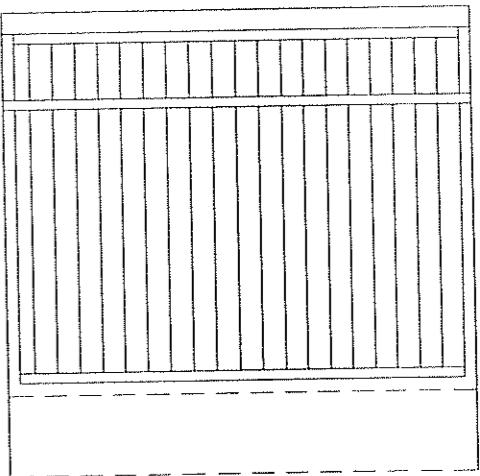
FLOOR PLAN
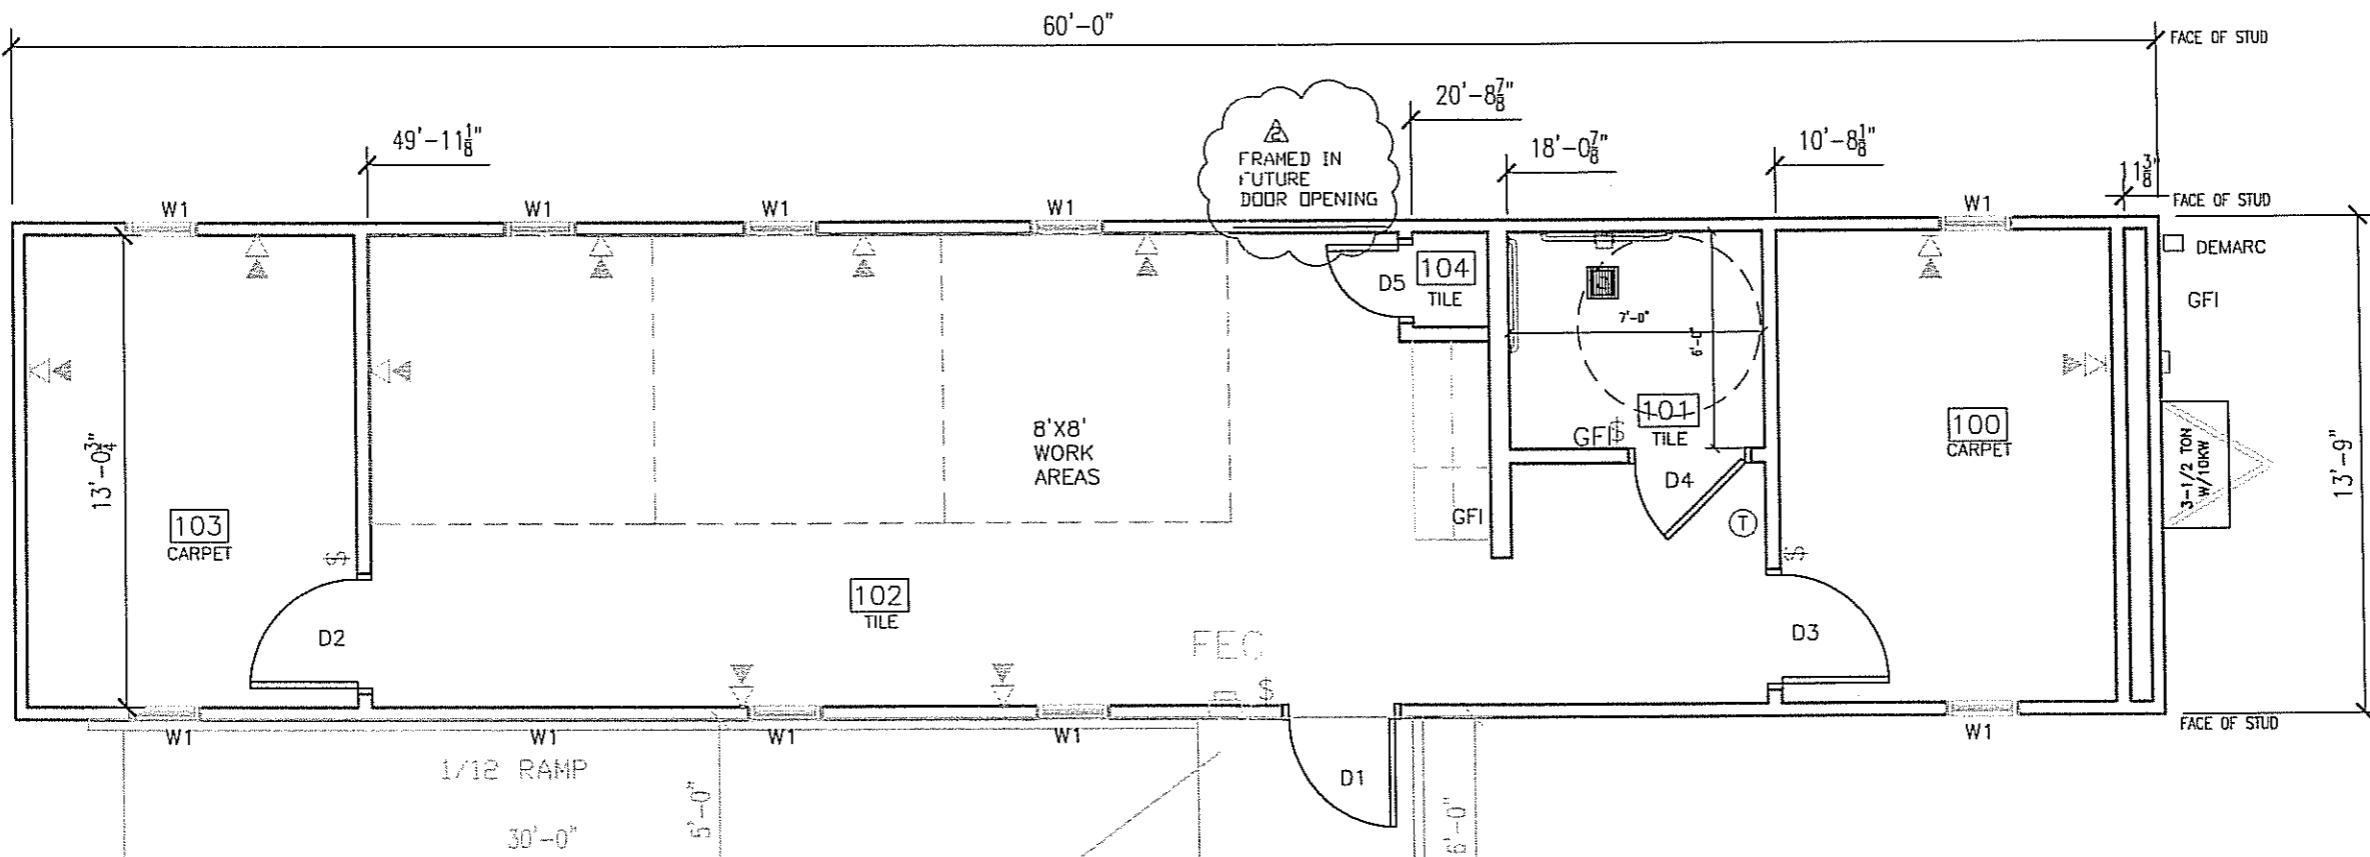
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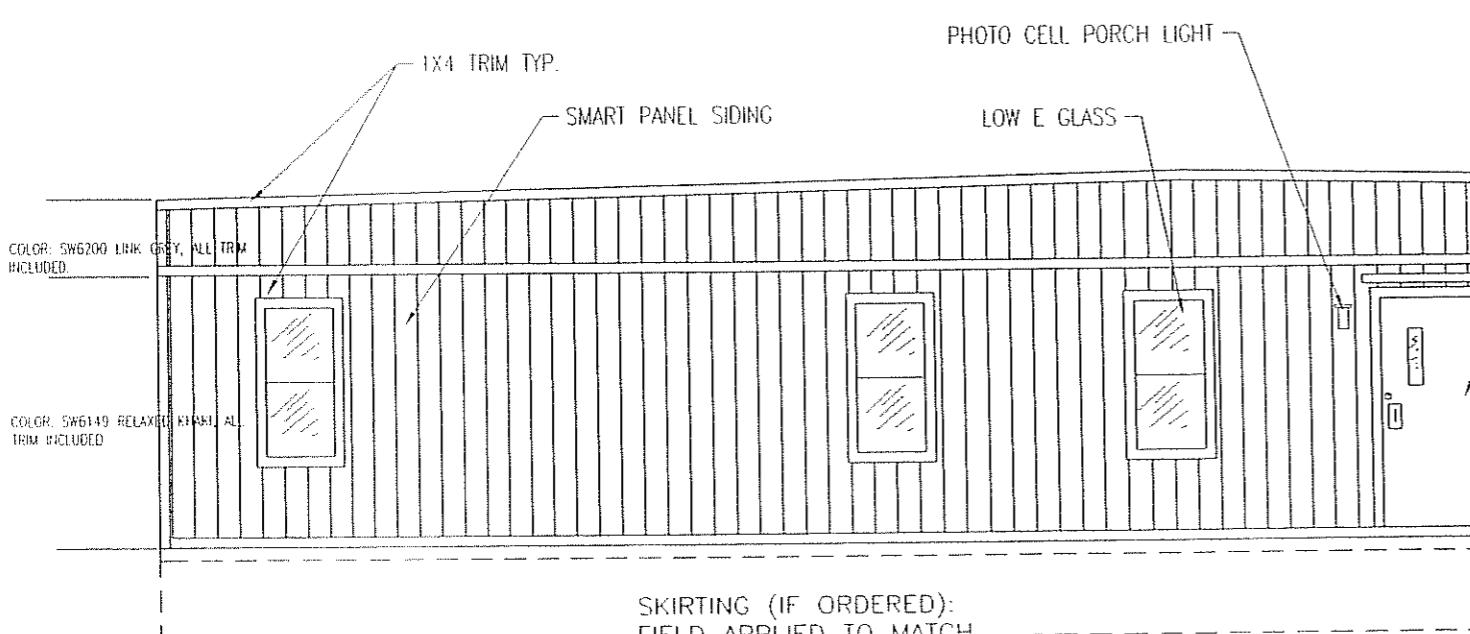
LTR	REVISION	BY	DATE	DRAWN BY:	PROJECT:	TITLE:
1	ADDED HVAC DISCONNECT	REW	4/13/07	REW	NORTEX MODULAR SPACE	STOCK 1460 FLOOR PLAN—"J" SERIES
2	SHED FRAMED IN DOOR AREA.	REW	06/21/07	DATE: 02/19/07	SCALE: 3/16" = 1'-0"	DWG# 1460STK SHEET: A-101




BACK ELEVATION

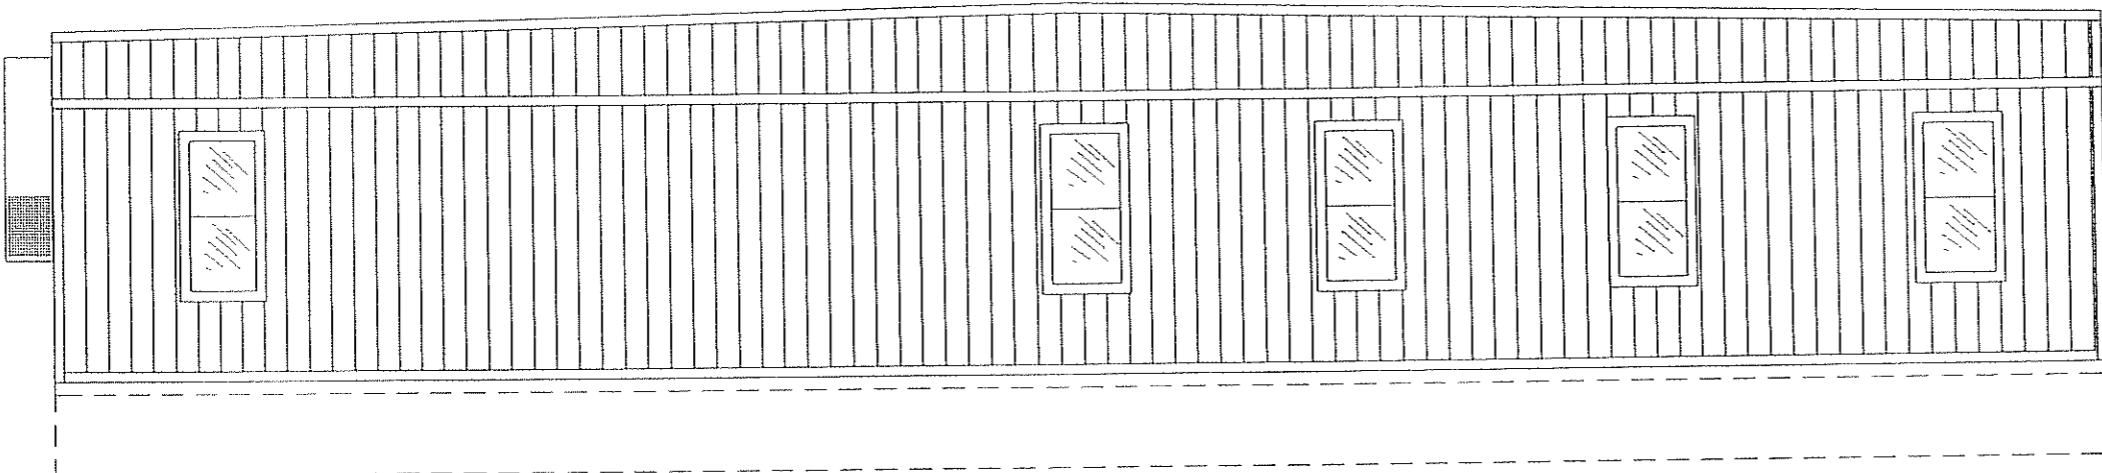

BACK END ELEVATION





FRONT ELEVATION

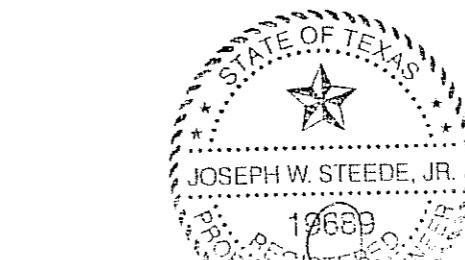

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REGISTERED
3 1/2 TON WORKING CAPACITY

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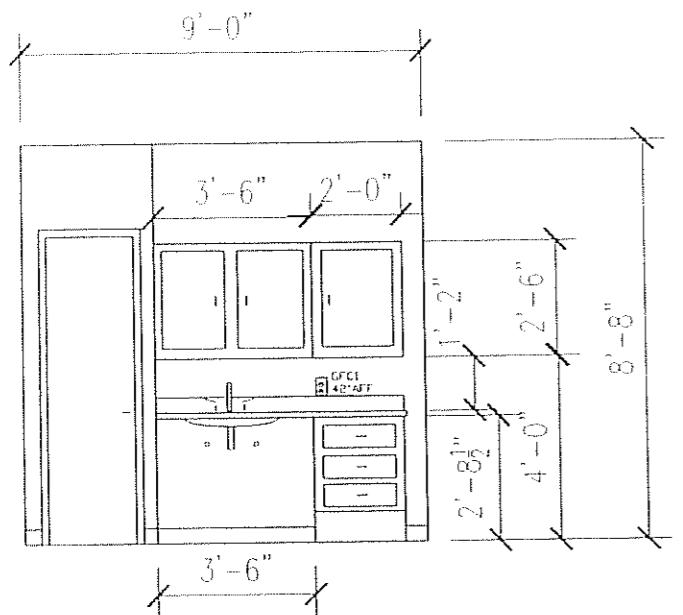
HITCH END ELEVATION

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LTR	REVISION	BY	DATE	DRAWN BY:	PROJECT:	TITLE:		
	CORRECT SPELLING	REW	4/13/07	REW	NORTEX MODULAR SPACE	STOCK 1460 ELEVATIONS—"J" SERIES	DWG#	1460STK
				DATE: 02/19/07	SCALE: 3/16" = 1'-0"		SHEET:	A-201

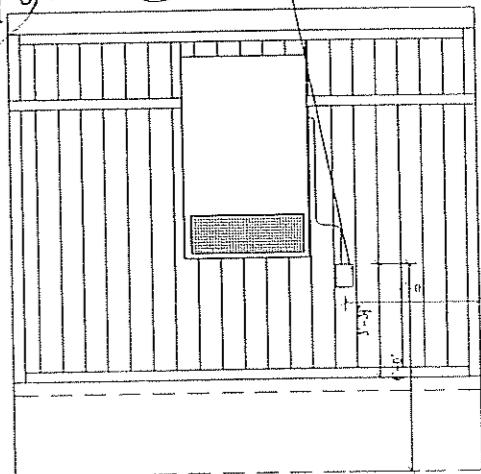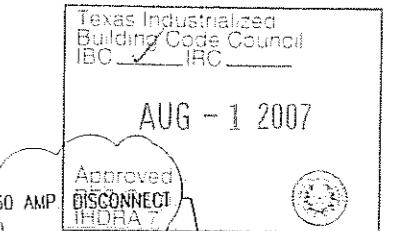


CABINET WALL ELEVATION
SCALE: 1' = 1'-0"

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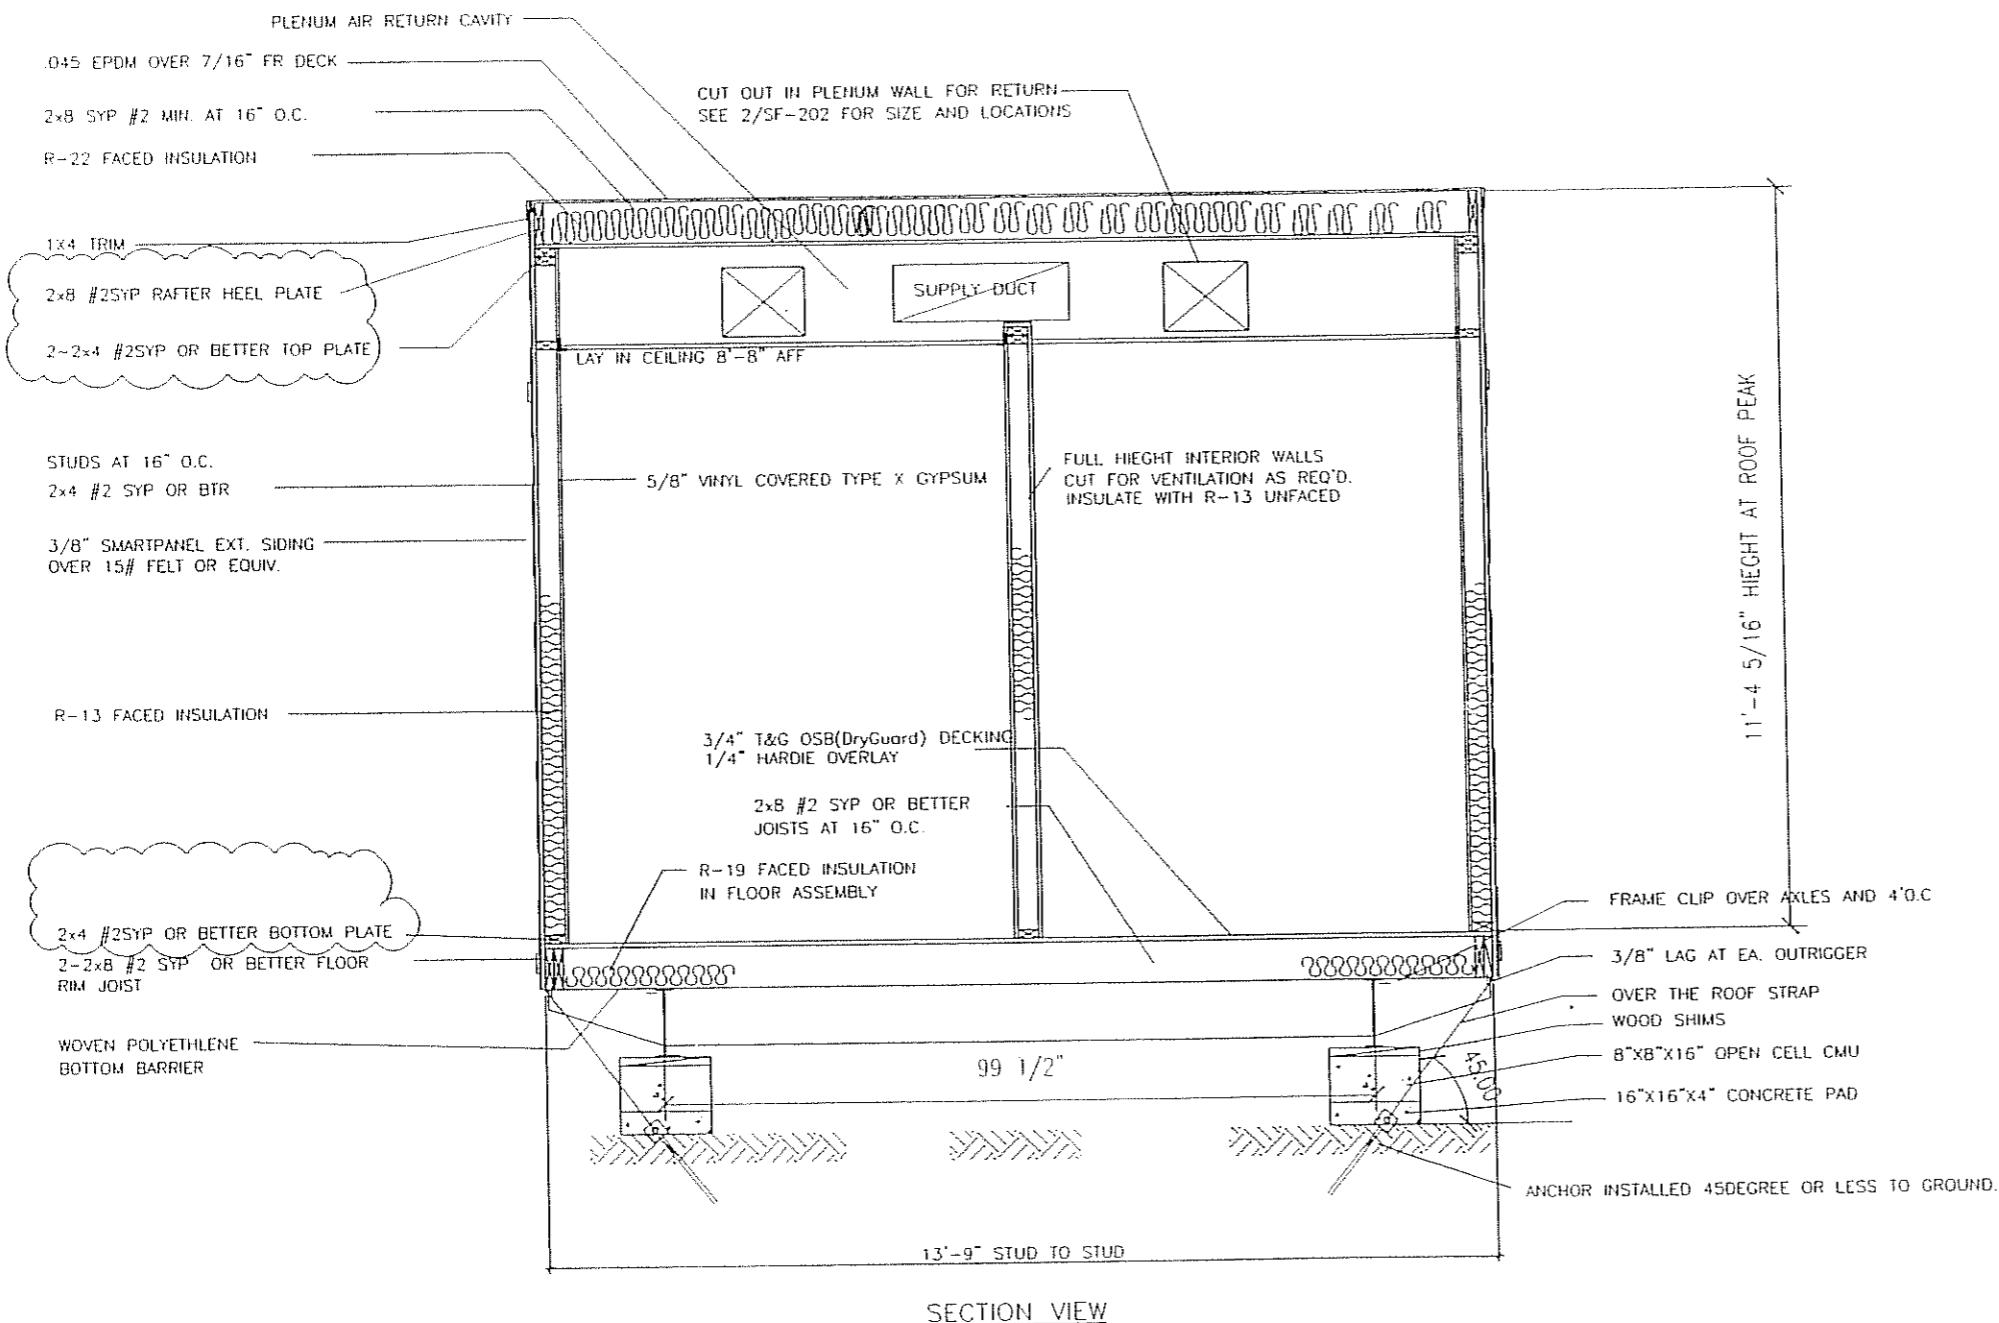


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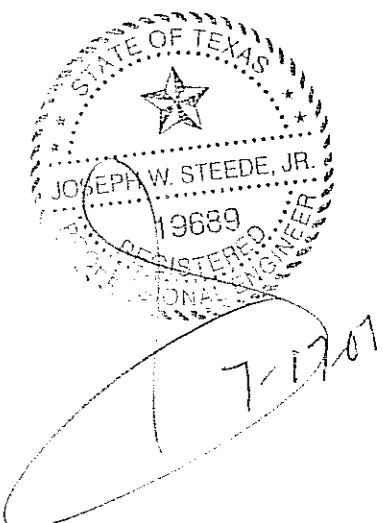
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LTR	REVISION	BY	DATE	DRAWN BY:	PROJECT:	TITLE:	DWG#	SCALE:	SHEET:
1	SHOW OUTLET LOCATION	REW	4/13/07	REW	NORTEX MODULAR SPACE	STOCK 1460 ELEVATIONS - "J" SERIES	1460STK	AS NOTED	A-202
2	REMOVED EeMAX AND PUT UNDER BATHROOM LAVATORY	REW	06/21/07	DATE: 02/19/07	SCALE: AS NOTED				

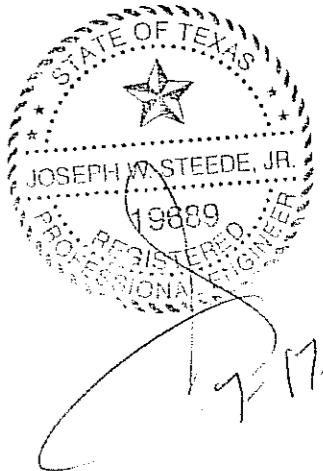

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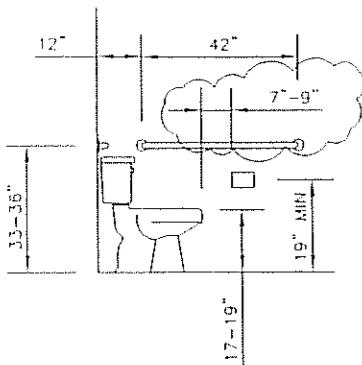
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NORTEX MODULAR SPACE


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LTN	REVISION	BY	DATE	DRAWN BY:	PROJECT:	TITLE:	
I	PER PLAN REVIEW, CERTIFICATION	REW	07/09/07	REW	NORTEX MODULAR SPACE	STOCK 1460 SECTION- "J" SERIES	DWG# 1460STK SHEET: A-301


ADA DETAILS




WATER CLOSET
SIDE VIEW

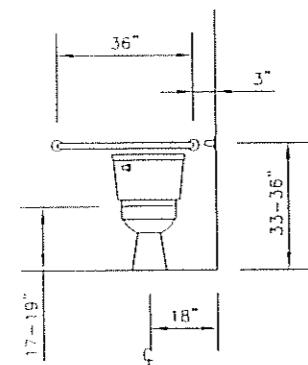

WATER CLOSET
FRONT VIEW

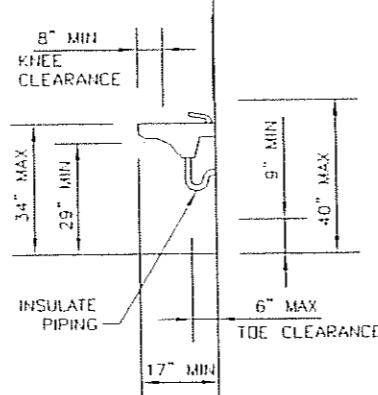

LAV CLEARANCES

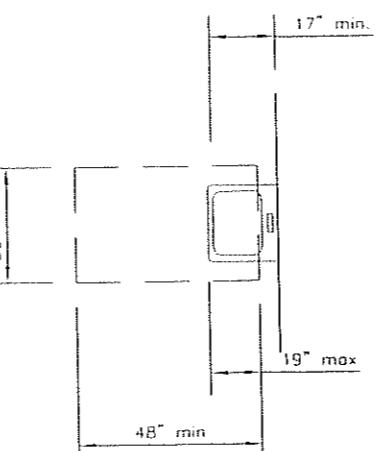


CLEAR FLOOR SPACE
AT LAVATORIES

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LTR	REVISION	BY	DATE	DRAWN BY:	PROJECT:	TITLE:		DWG#	SHEET:	
I	CLARIFIED DIMENSION PER INSPECTION.	REW	07/09/07	REW	NORTEX MODULAR SPACE	STOCK 1460 ADA-J SERIES				
				DATE:	SCALE:	02/19/07	N/A	1460STK	A-601	


		200 AMP 2-POLE 120V/240V MAIN BREAKER									
		BREAKER	LEG	CKT	CKT	LEG	BREAKER				
10	EeMAX	30	A	1	2	A	60	3-1/2 TON 10KW HVAC UNIT		6	
		2P	B	3	4	B	2P				
12	RECEPTS	20	A	5	6	A	20	LIGHTS		12	
12	RECEPTS	20	B	7	8	B	20	GFI'S		12	
12	DEDICATED QUAD OUTLET	20	A	9	10	A	20	EMERG.EXIT,PORCH		12	
12	EXHAUST FAN AND LIGHTS	20	B	11	12	B	20	LIGHTS		12	
			A	13	14	A		NOT USED			
			B	15	16	B		NOT USED			
			A	17	18	A		NOT USED			
			B	19	20	B		NOT USED			
			A	21	22	A		NOT USED			
			B	23	24	B		NOT USED			

	BULBS	32 WATT	AMPS EA.	ITEM	WATTS EA
			1.5	RECEPTS	180
	BULBS	32 WATT	0.77	LIGHTS 2'X4' 3-TUBE T-8	92
			0.8	90 CFM EXHAUST FAN	96
			0.31	LIGHT 2'X2' U-TUBE T-8	38
			0.0333333	EMERGENCY/EXIT	4
			0.1083333	PORCH LIIGHT	13
			22.9	EeMAX	2633.5
			59	HVAC	7080
					0
					0
					0

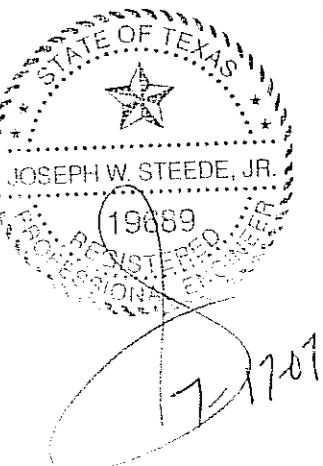EO	ELECTRICAL DUPLEX OUTLET
SBO	SURGE BLOC DUPLEX OUTLET
SS	MAIN SURGE SUPPRESSION
DO	DEDICATED OUTLET QUAD
HVAC	HEATING AND AIR UNIT
LF	LIGHT FIXTURE
GFI	GROUND FAULT INTERRUPT OUTLET
EF	EXHAUST FAN
WP	WEATHER PROOF
PL	PORCH LIGHT
SP	SERVICE PANEL
\$	OCCUPANCY SENSOR SWITCH
EeMAX	INSTANT WATER HEATER
EX/EML	EXIT/EMERGENCY LIGHT

PANEL SP-1 200 AMP 2-POLE 120V/240V SINGLE PHASE MAIN BREAKER LOAD CALCULATIONS					
LEG	CKT	DESCRIPTION	LEG A-AMPS	LEG B-AMPS	LEG A-WATTS
A	1	EeMAX	30.00	-	3,600.00
A	2	HVAC	60.00	-	7,200.00
B	3	EeMAX	-	30.00	3,600.00
B	4	HVAC	-	60.00	7,200.00
A	5	RECEPTS	9.00	-	1,080.00
A	6	LIGHTS	5.39	-	646.80
B	7	RECEPTS	-	9.00	-
B	8	GFI'S	-	4.50	540.00
A	9	DEDICATED	3.00	-	360.00
A	10	EMERG/EXIT	0.14	-	17.00
B	11	EXHAUST/LIC	-	1.93	-
B	12	LIGHTS	-	1.54	184.80
			107.53	106.97	12,903.80
					12,836.40

AMPS	107.53	TOTALS	25,740.20	WATTS
W/20%	129.04		32,175.25	W/ 25%
200AMP	OK	DIFF B-A	67.40	WATTS

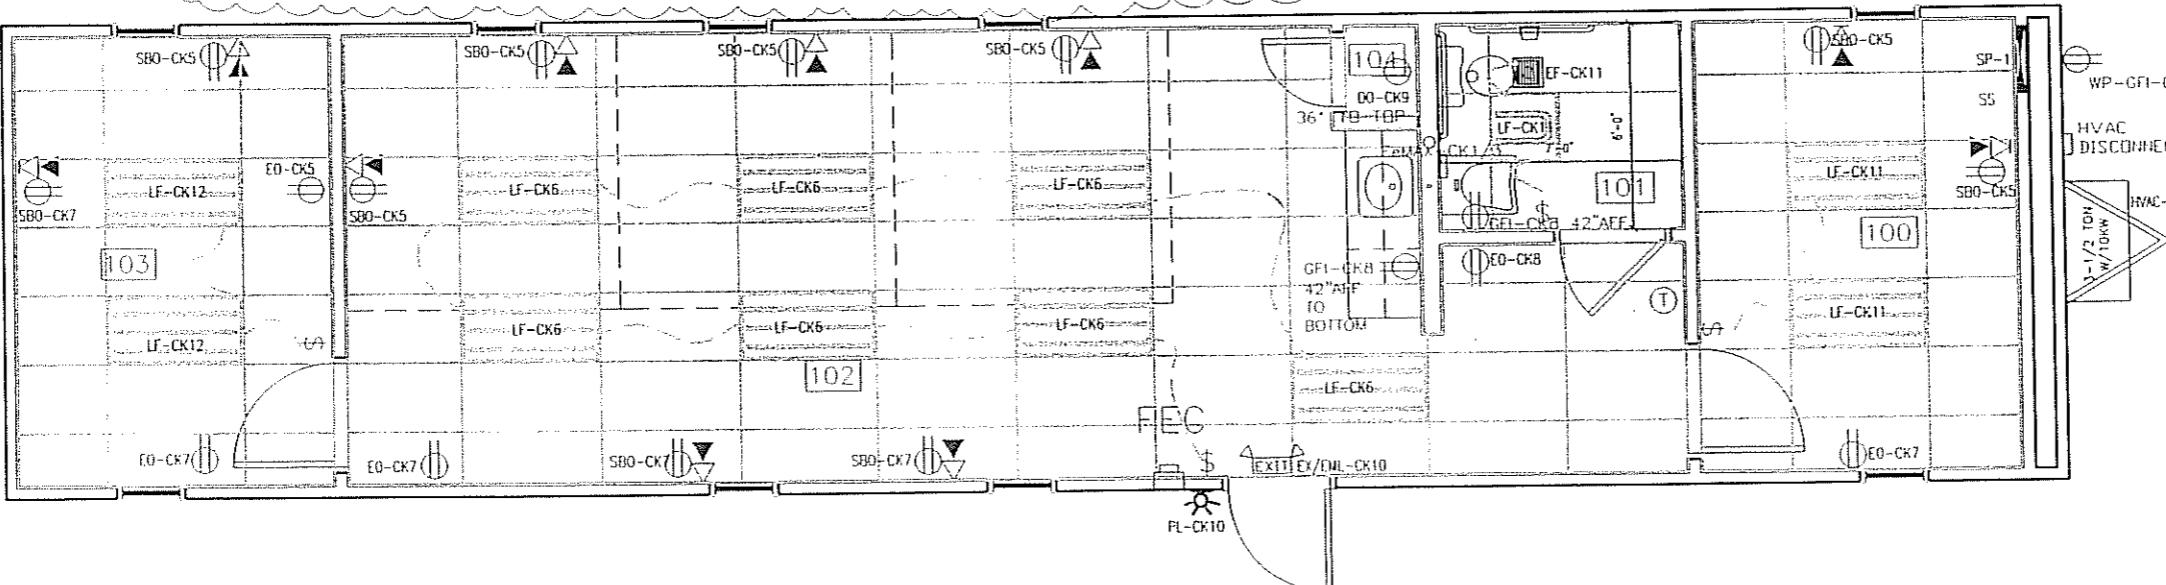

ELECTRICAL PLAN

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MECHANICAL SCHEDULE		
DESIGNATION	DESCRIPTION	COMMENTS
SA1	2X2 SUPPLY AIR REGISTER	ADJUSTABLE
SA2	12X12 SUPPLY GRILL	NONE
RA1	2X2 RETURN AIR REGISTER	NONE
T	THERMOSTAT	PROGRAMMABLE
3 1/2 TON V/10KW	BARD MODEL WA423A 2	W/ECONOMIZER
EX1	90 CFM EXHAUST FAN	THRU ROOF

DUCT SIZE	AC	CFM	FPM	RECT W	RECT H	ROUND DUCT
3-1/2 ton		1400	960	30	10	16

OCCUPANTS
CFM REQ'D EACH
TOTAL OUTSIDE REQD



6
20 CFM
120 CFM

4

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SEP 19 2007

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IHDR 7

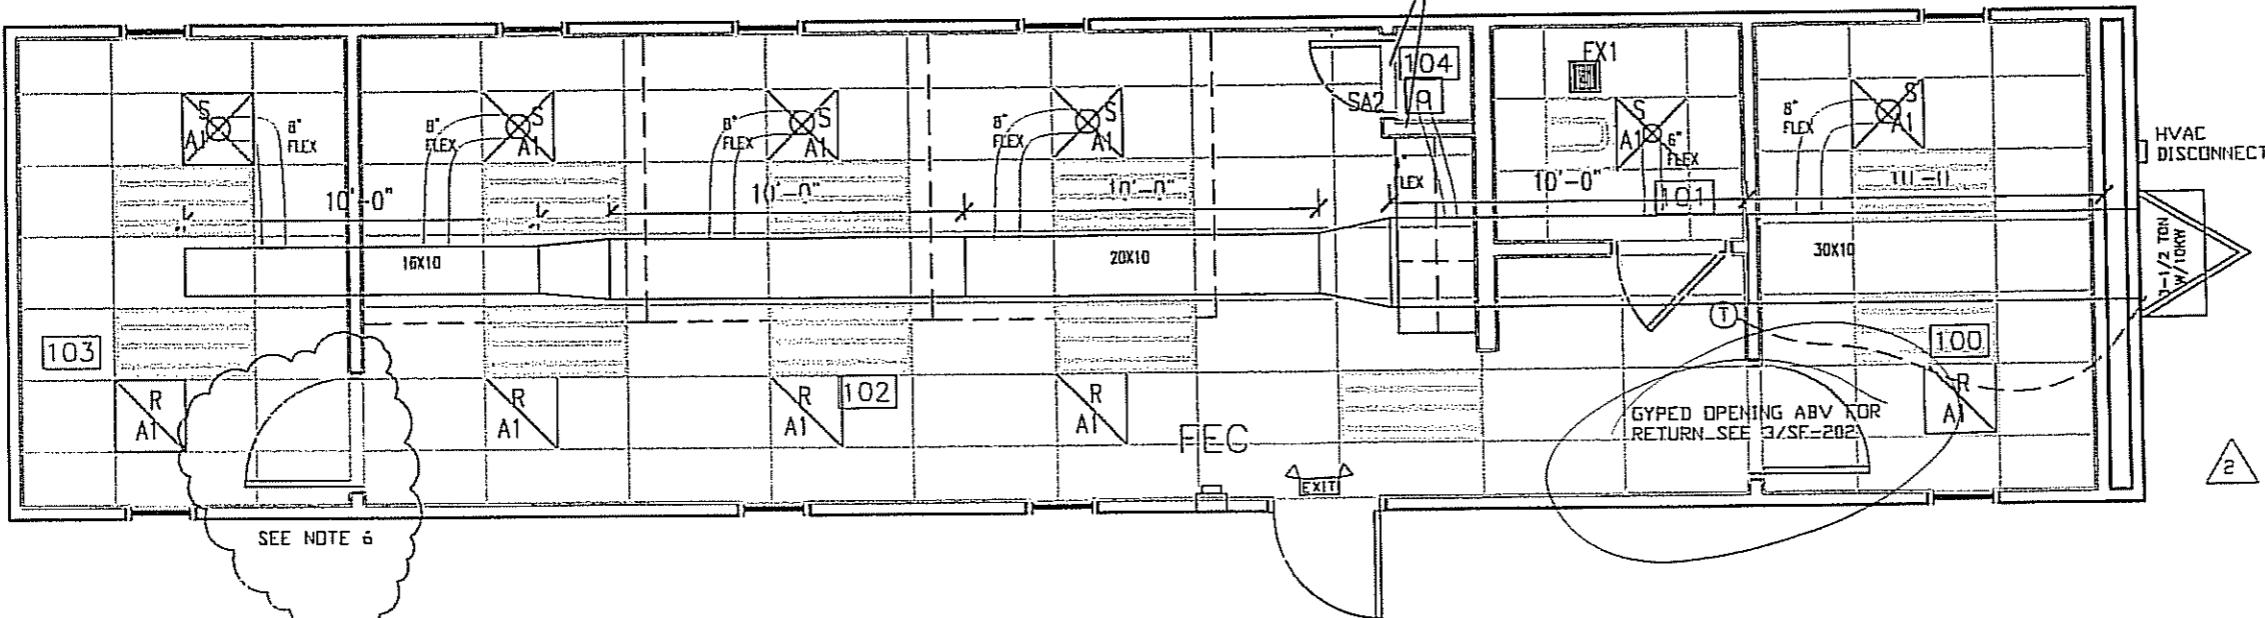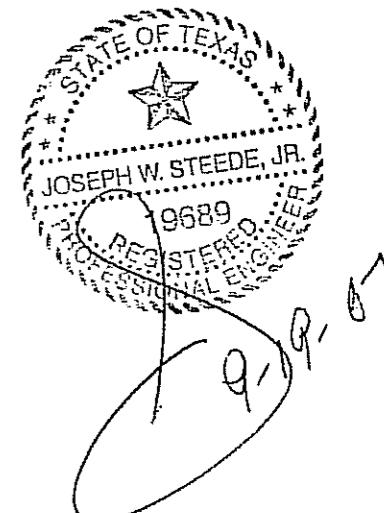


MECHANICAL PLAN

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DALLAS, TX 75250 PHONE 972-238-1611

LTR	REVISION	BY	DATE	DRAWN BY:	PROJECT:	TITLE:	
1	SHOWED HVAC DISCONNECT	REW	4/13/07	REW	NORTEX MODULAR SPACE	STOCK 1460 MECHANICAL PLAN - "J" SERIES	
2	PER TDLR REVIEW, SIZED RETURN, DROP	REW	06/20/07	DATE: 02/19/07	SCALE: 3/16" = 1'-0"	DWG# 1460STK	SHEET: M-101
3	CHANGE CALC.	REW	08/25/07				





NORTEX MODULAR SPACE
555 JUBILEE LANE
LEWISVILLE, TX 75056
PHONE: 972-492-4040
FAX: 972-492-2704

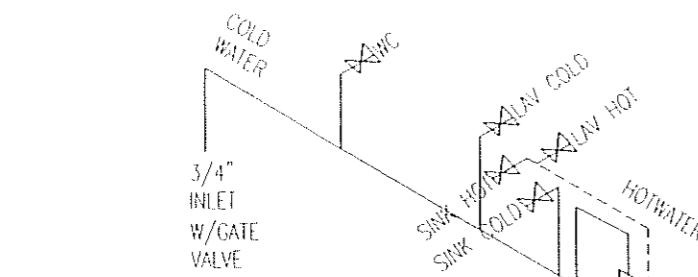

ALL SUPPLY LINES ARE 1/2"
EXCEPT AS NOTED
ALL STUB-OUTS ARE 3/8"
EXCEPT AS NOTED

NOTE: ALL SUPPLY LINES OVER
3/4" IN SIZE SHALL BE COPPER

SUPPLY RISER

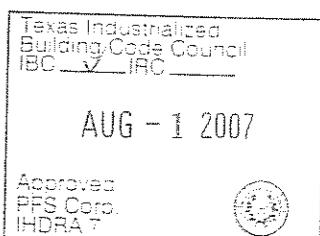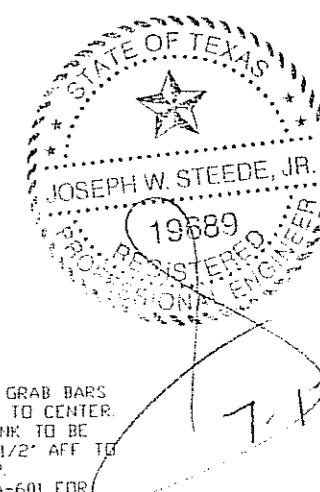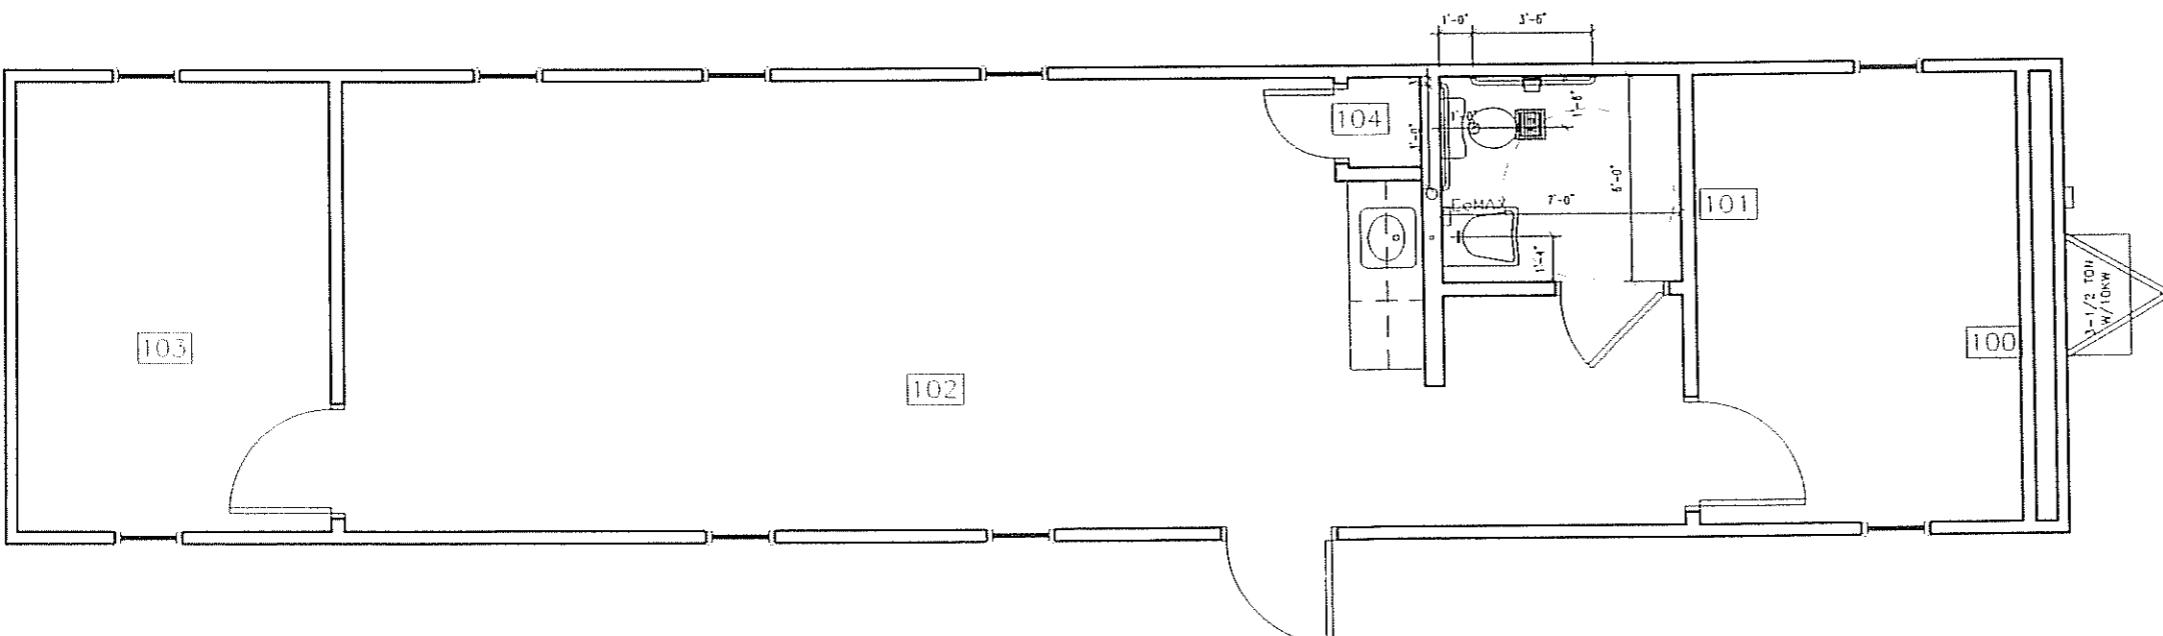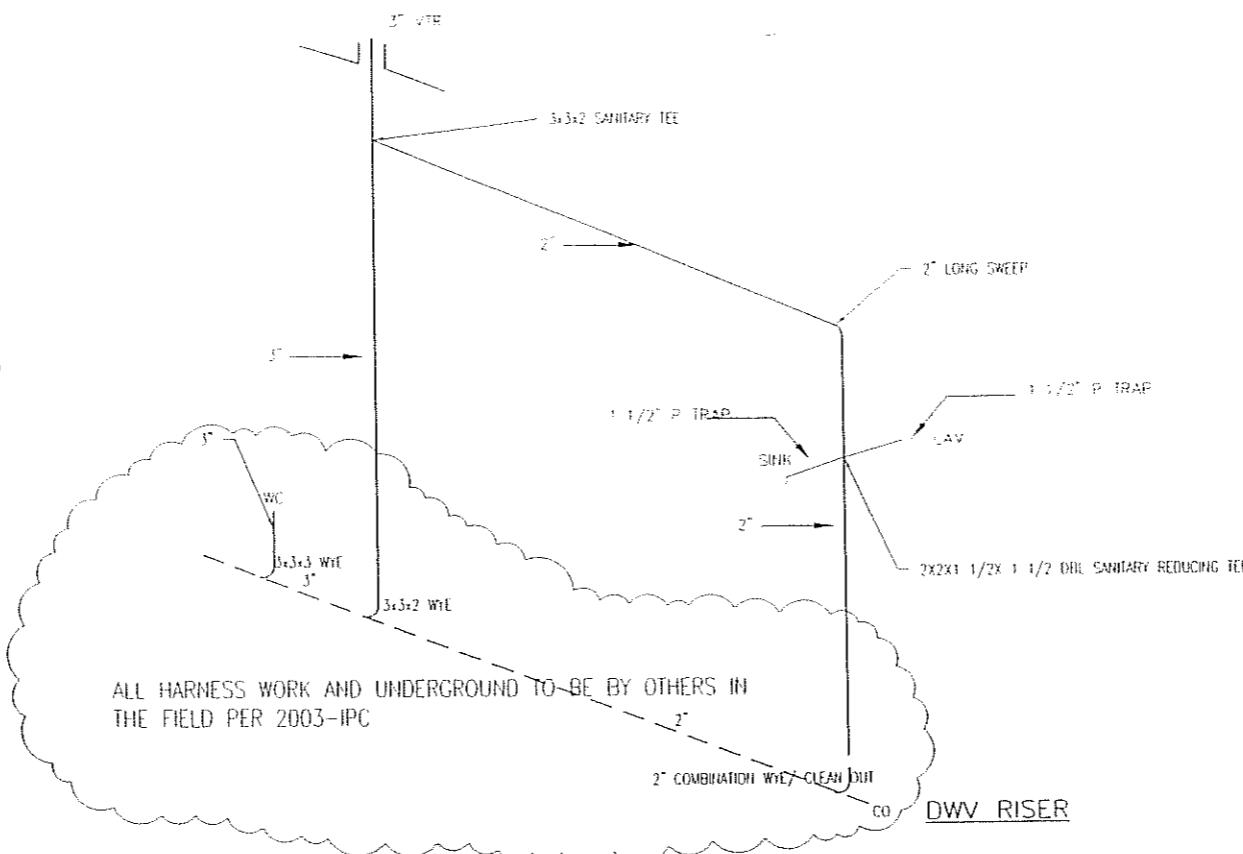


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NORTEX MODULAR SPACE

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LTR	REVISION	BY	DATE	DRAWN BY:	PROJECT:	TITLE:	DWG#	SHEET:	STAMP
1	ADDED DIM'S AND NOTES, CHANGE SINK VENT TO 2"	REW	4/13/07	REW	NORTEX MODULAR SPACE	STOCK 1460 PLUMBING PLAN-"J" SERIES	1460STK	P-101	
2	REMOVED HARNESSES IN FLOOR	REW	06/21/07	02/19/07	SCALE:	3/16" = 1'-0"			



FLOOR JOIST PLAN

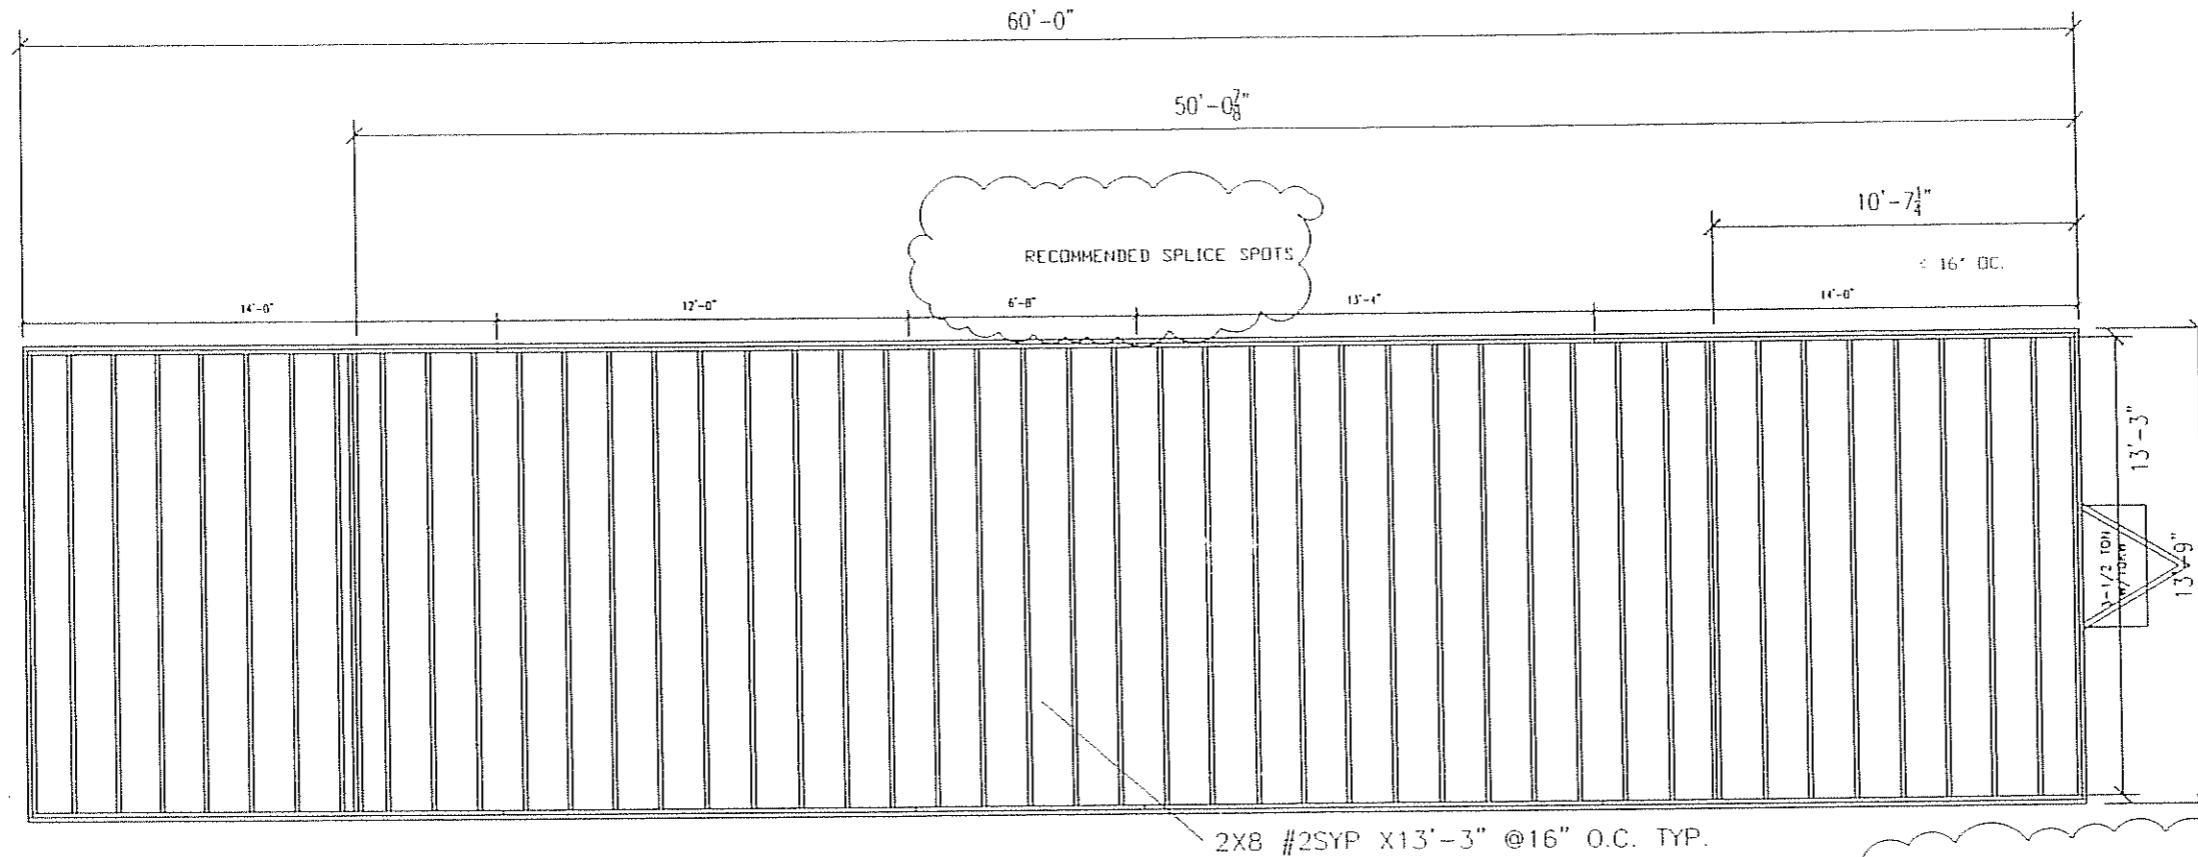JOIST TO RIM: (5) .131X3" NAILS
OUTSIDE RIM TO ACT AS SPLICE BLOCK FOR
INSIDE RIM JOINTS. FOLLOW NAIL PATTERN IN
MANUAL (5) EACH SIDE OF JOINT.

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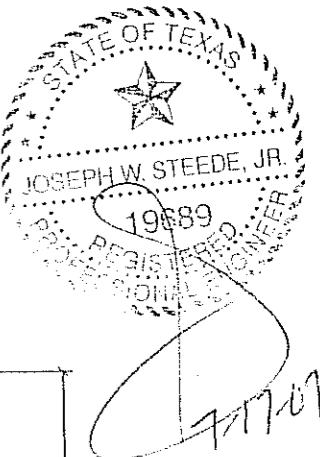
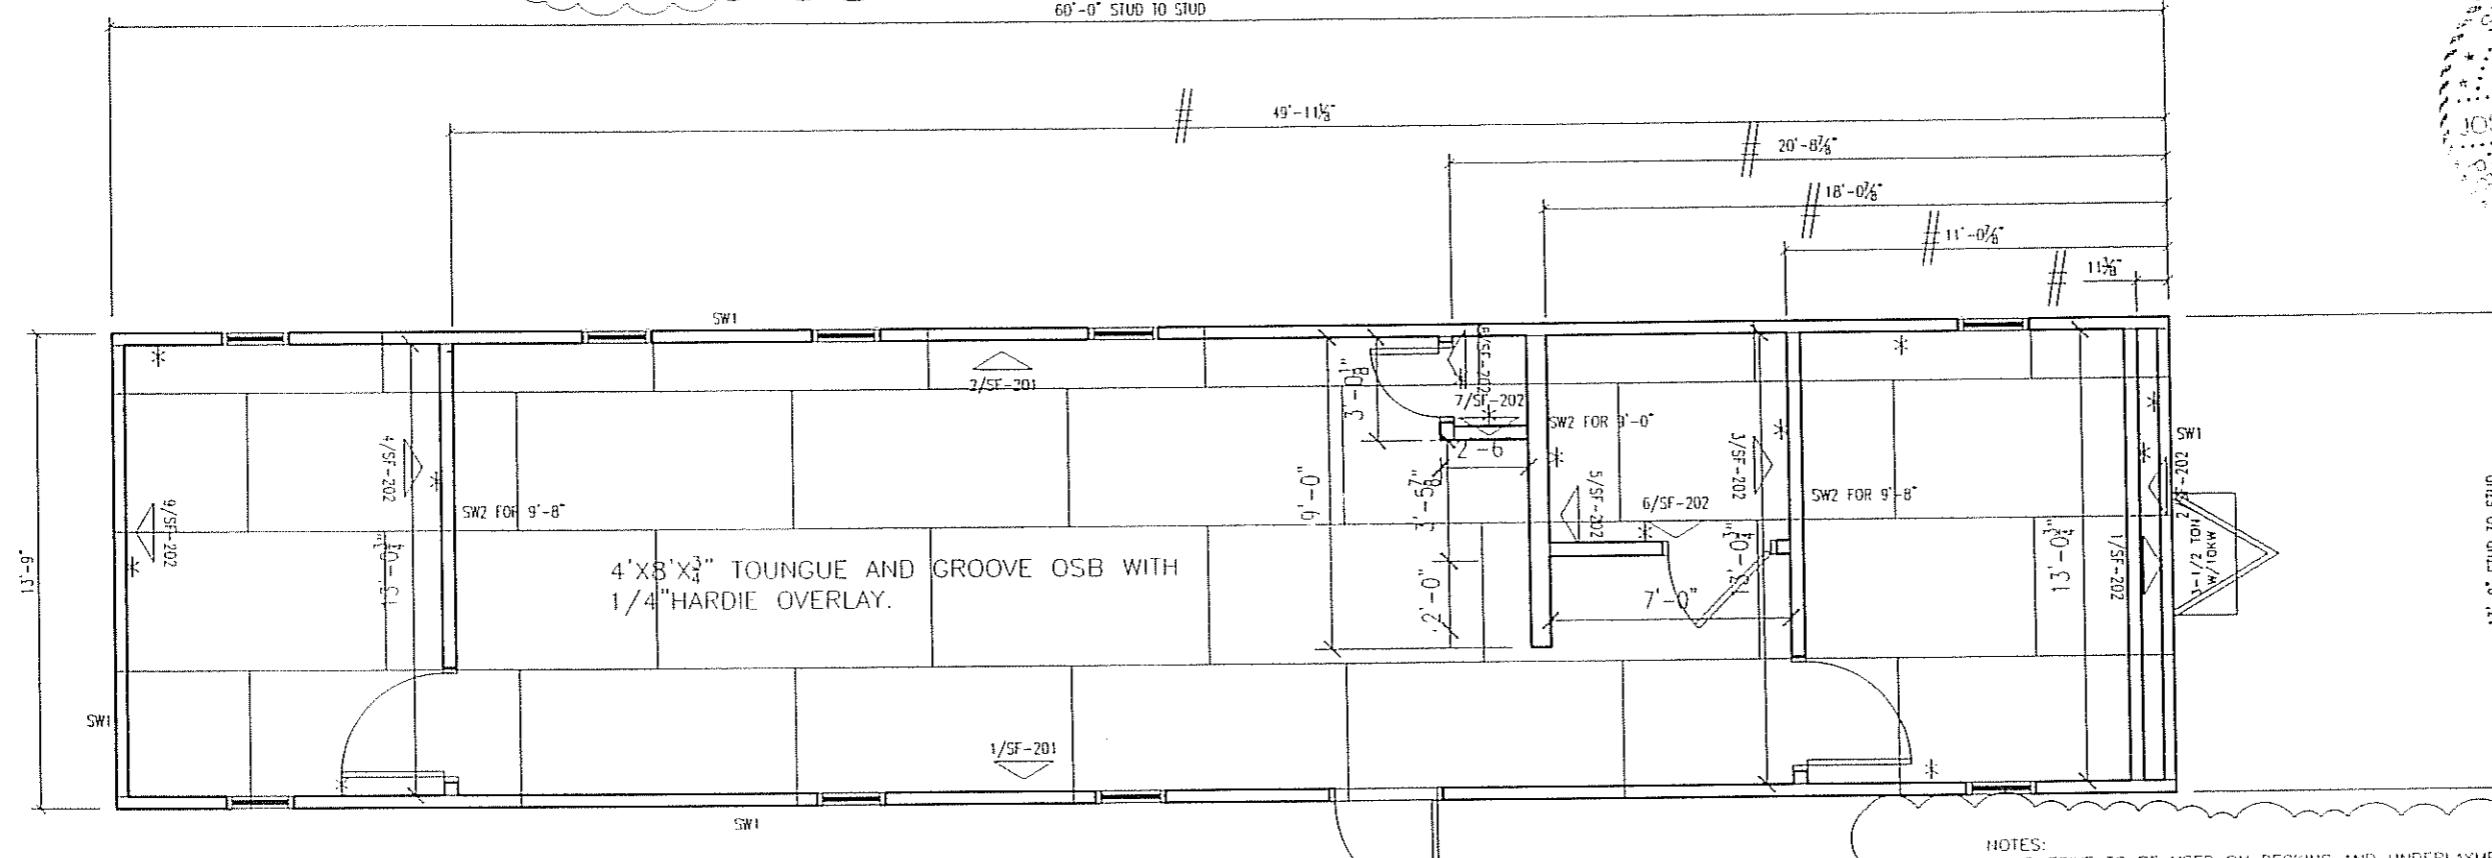
NORTEX MODULAR SPACE

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LTR	REVISION	BY	DATE	DRAWN BY:	PROJECT:	TITLE:	DWG#	SHEET:
				REW	NORTEX MODULAR SPACE	STOCK 1460 FLOOR JOIST PLAN-"J" SERIES	1460STK	SF-101

SHEARWALL SCHEDULE					
MARK	MATERIAL	FASTEN STUDS TO SIDING	FASTEN BOTTOM PLATE TO DECK	FASTEN TOP PLATE TO RAFTERS	FASTEN END TO SIDEWALLS
SW1	3/8" SMARTPANEL ONE SIDE 5/8" VCG OTHER SIDE	NAIL WITH .090 X 2 $\frac{1}{2}$ " FOR 3/8" SMART PANEL 6" DC EDGE/12" DC FIELD. ADHESIVE VCG ON INTERIOR	131 X 3" NAILS 16" O.C.	131 X 3" NAILS 16" O.C.	131 X 3" NAILS 16" O.C.
SW2	5/8" VCG EACH SIDE	ADHESIVE EACH SIDE	131 X 3" NAILS 16" O.C.	131 X 3" NAILS 16" O.C.	131 X 3" NAILS 16" O.C.

TOP AND BOTTOM EDGE OF SIDING SHALL BE NAILED WITH .090 X 2 1/2" NAILS 2 1/2" O.C. TO THE RIM JOIST.




NOTES:

1. ADHESIVE TO BE USED ON DECKING AND UNDERLAYMENT.
2. ALL EDGES ARE UNBLOCKED.
3. SCREW FLOOR DECKING 6"O.C. EDGES, 12" FIELD WITH 2 1/4" MIN. SCREWS. SCREW ATTACH UNDERLAYMENT 6"/12" WITH 1 1/2" MIN. SCREWS.
4. ALL WALLS 2X4 EXCEPT BATHROOM WET WALL, TO BE 2X6

FLOOR DECK / WALL LAYOUT PLAN

- DENOTES SIDE TO BE PREPARED
- # DENOTES TO FINISH SIDE

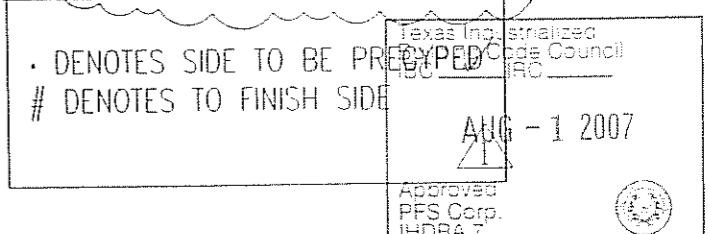


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NORTEX MODULAR SPACE

EX-NUDE-GEAR
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FAX: 972-492-2704


LTR	REVISION	BY	DATE	DRAWN BY:	PROJECT:	TITLE:
I	ADDED NOTE ABOUT BUTT/TOP NAILING	REW	06/21/07	REW	NORTEX MODULAR SPACE	STOCK 1460 FLOOR DECK PLAN- "J" SERIES
				DATE: 02/19/07	SCALE: 3/16" = 1'-0"	DWG# 1460STK SHEET: SF-102

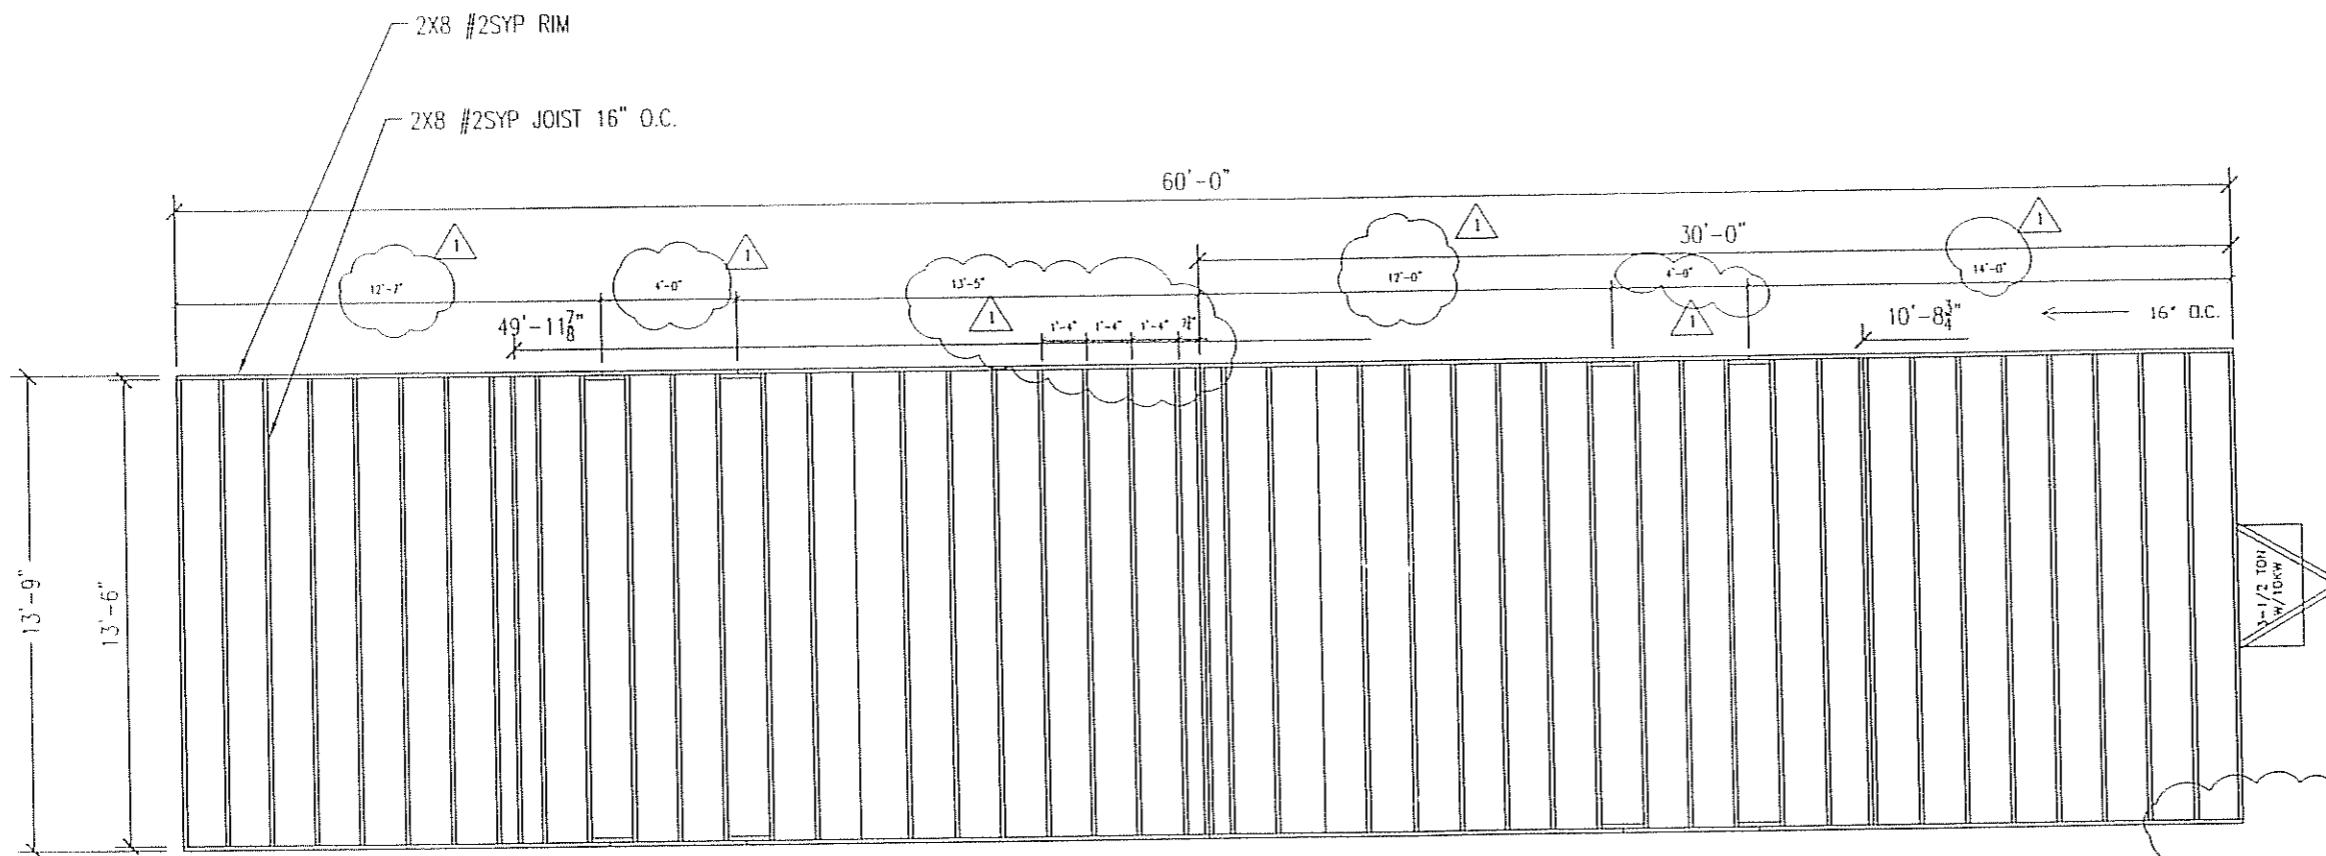


ROOF JOIST PLAN

NOTES:

1. FILL CAVITY WITH R22.
2. BOTTOM OF JOIST TO BE $\frac{1}{2}$ " GYPSUM.
3. ROOF DECK TO BE FR $\frac{1}{2}$ " DECK PANEL.
4. ROOF DECK NAILING TO BE 4"OC EDGE & 8"OC IN FIELD WITH MIN. $\frac{2}{3}$ " SCREWS.
5. ROOF IS BUILT IN 30' HALFS.
6. NAIL JOIST TO RIMS (5) 131 X 3"
7. SPLICE BLOCKS (5) 131 X 3" EA.
8. TOE NAIL RIM TO TOP WALL PLATES WITH 131 X 3" AT 4" O.C. OUTER SIDE ONLY.

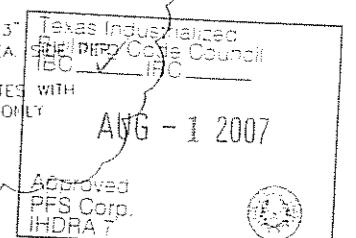

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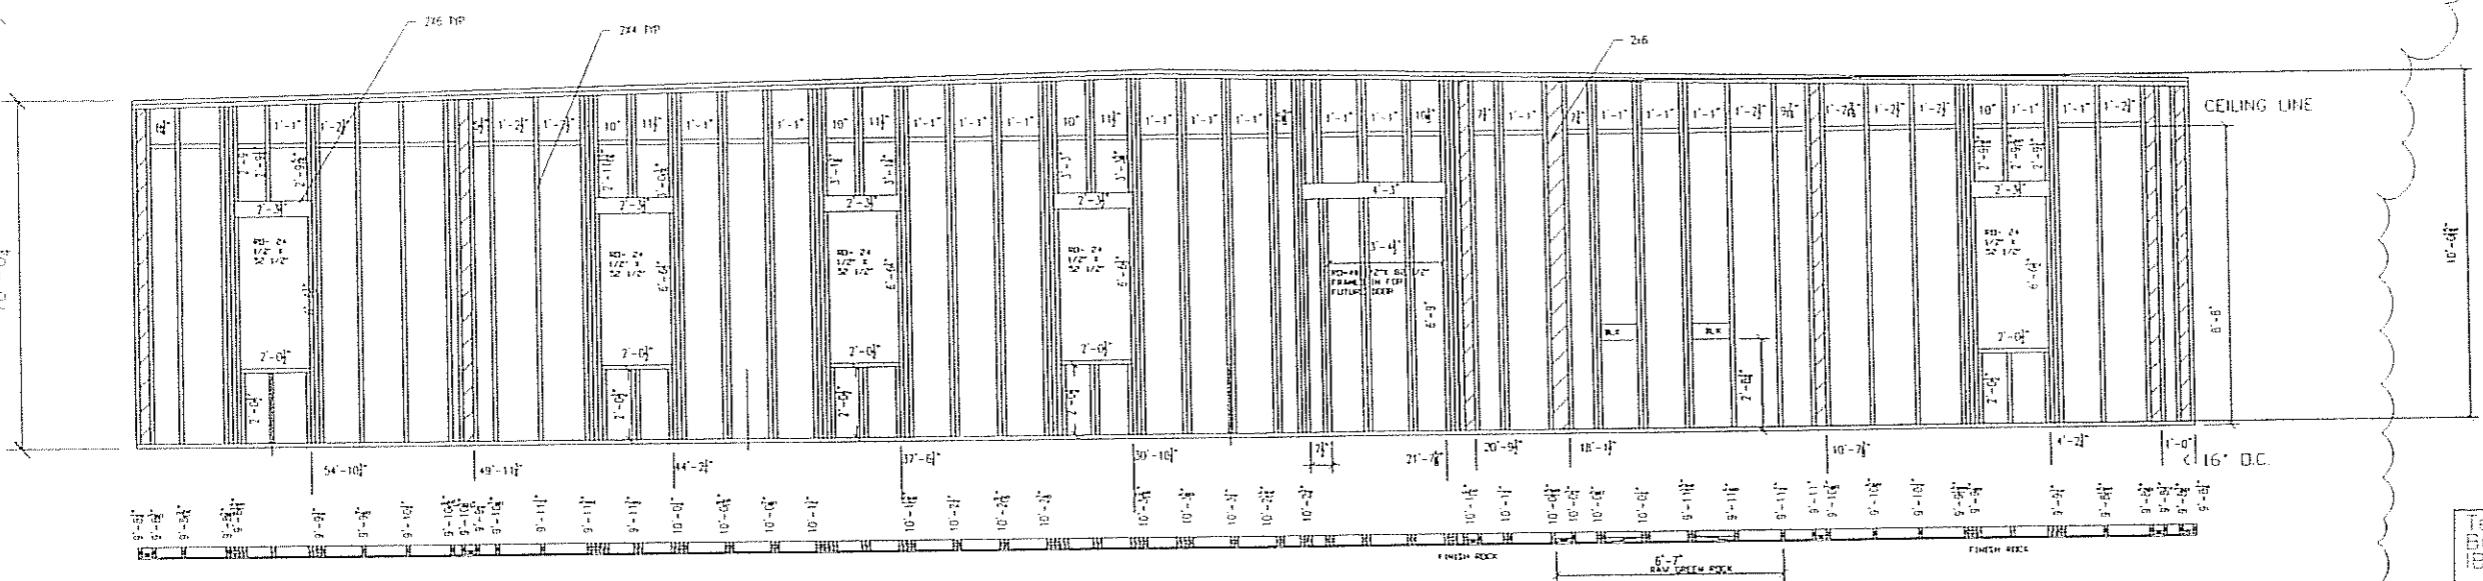

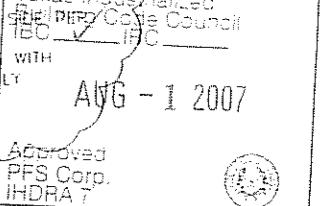
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NORTEX MODULAR SPACE

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PHONE: 972-492-4040
FAX: 972-492-2704


LTR	REVISION	BY	DATE	DRAWN BY:	PROJECT:	TITLE:	SHEET:
1	ADDED DIMENSIONS, CORRECT R VALUE	REW	07/07/07	REW	NORTEX MODULAR SPACE	STOCK 1460 ROOF JOIST PLAN-J" SERIES	SF-103



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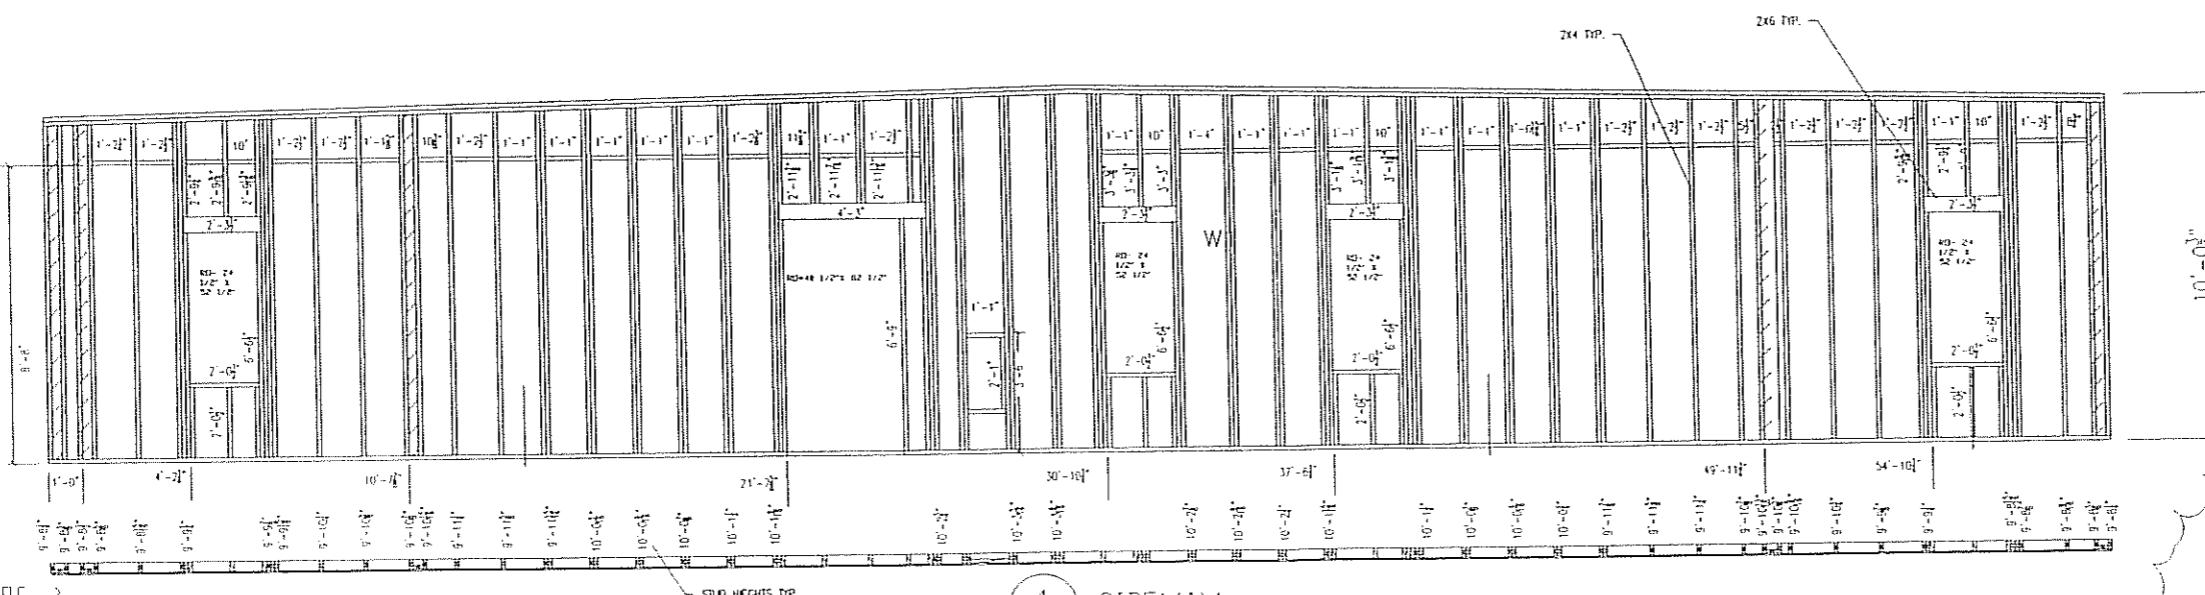


NOTES:
ALL WINDOWS AND DOOR
OPENINGS TO HAVE DOUBLE KING
STUDS AT EXTERIOR WALLS.
ALL HEADERS ARE 2X2X6'S.
ALL WALLS EXCEPT HITCH END
REQUIRE BLOCKING AT 8'-8" ELV.
SMART PANEL SIDING TO BE
INSTALLED FROM MID-FLOOR
JOIST TO TOP OF ROOF LINE.
ALL STUDS OVER 119.67" SHALL
BE DOUBLED.

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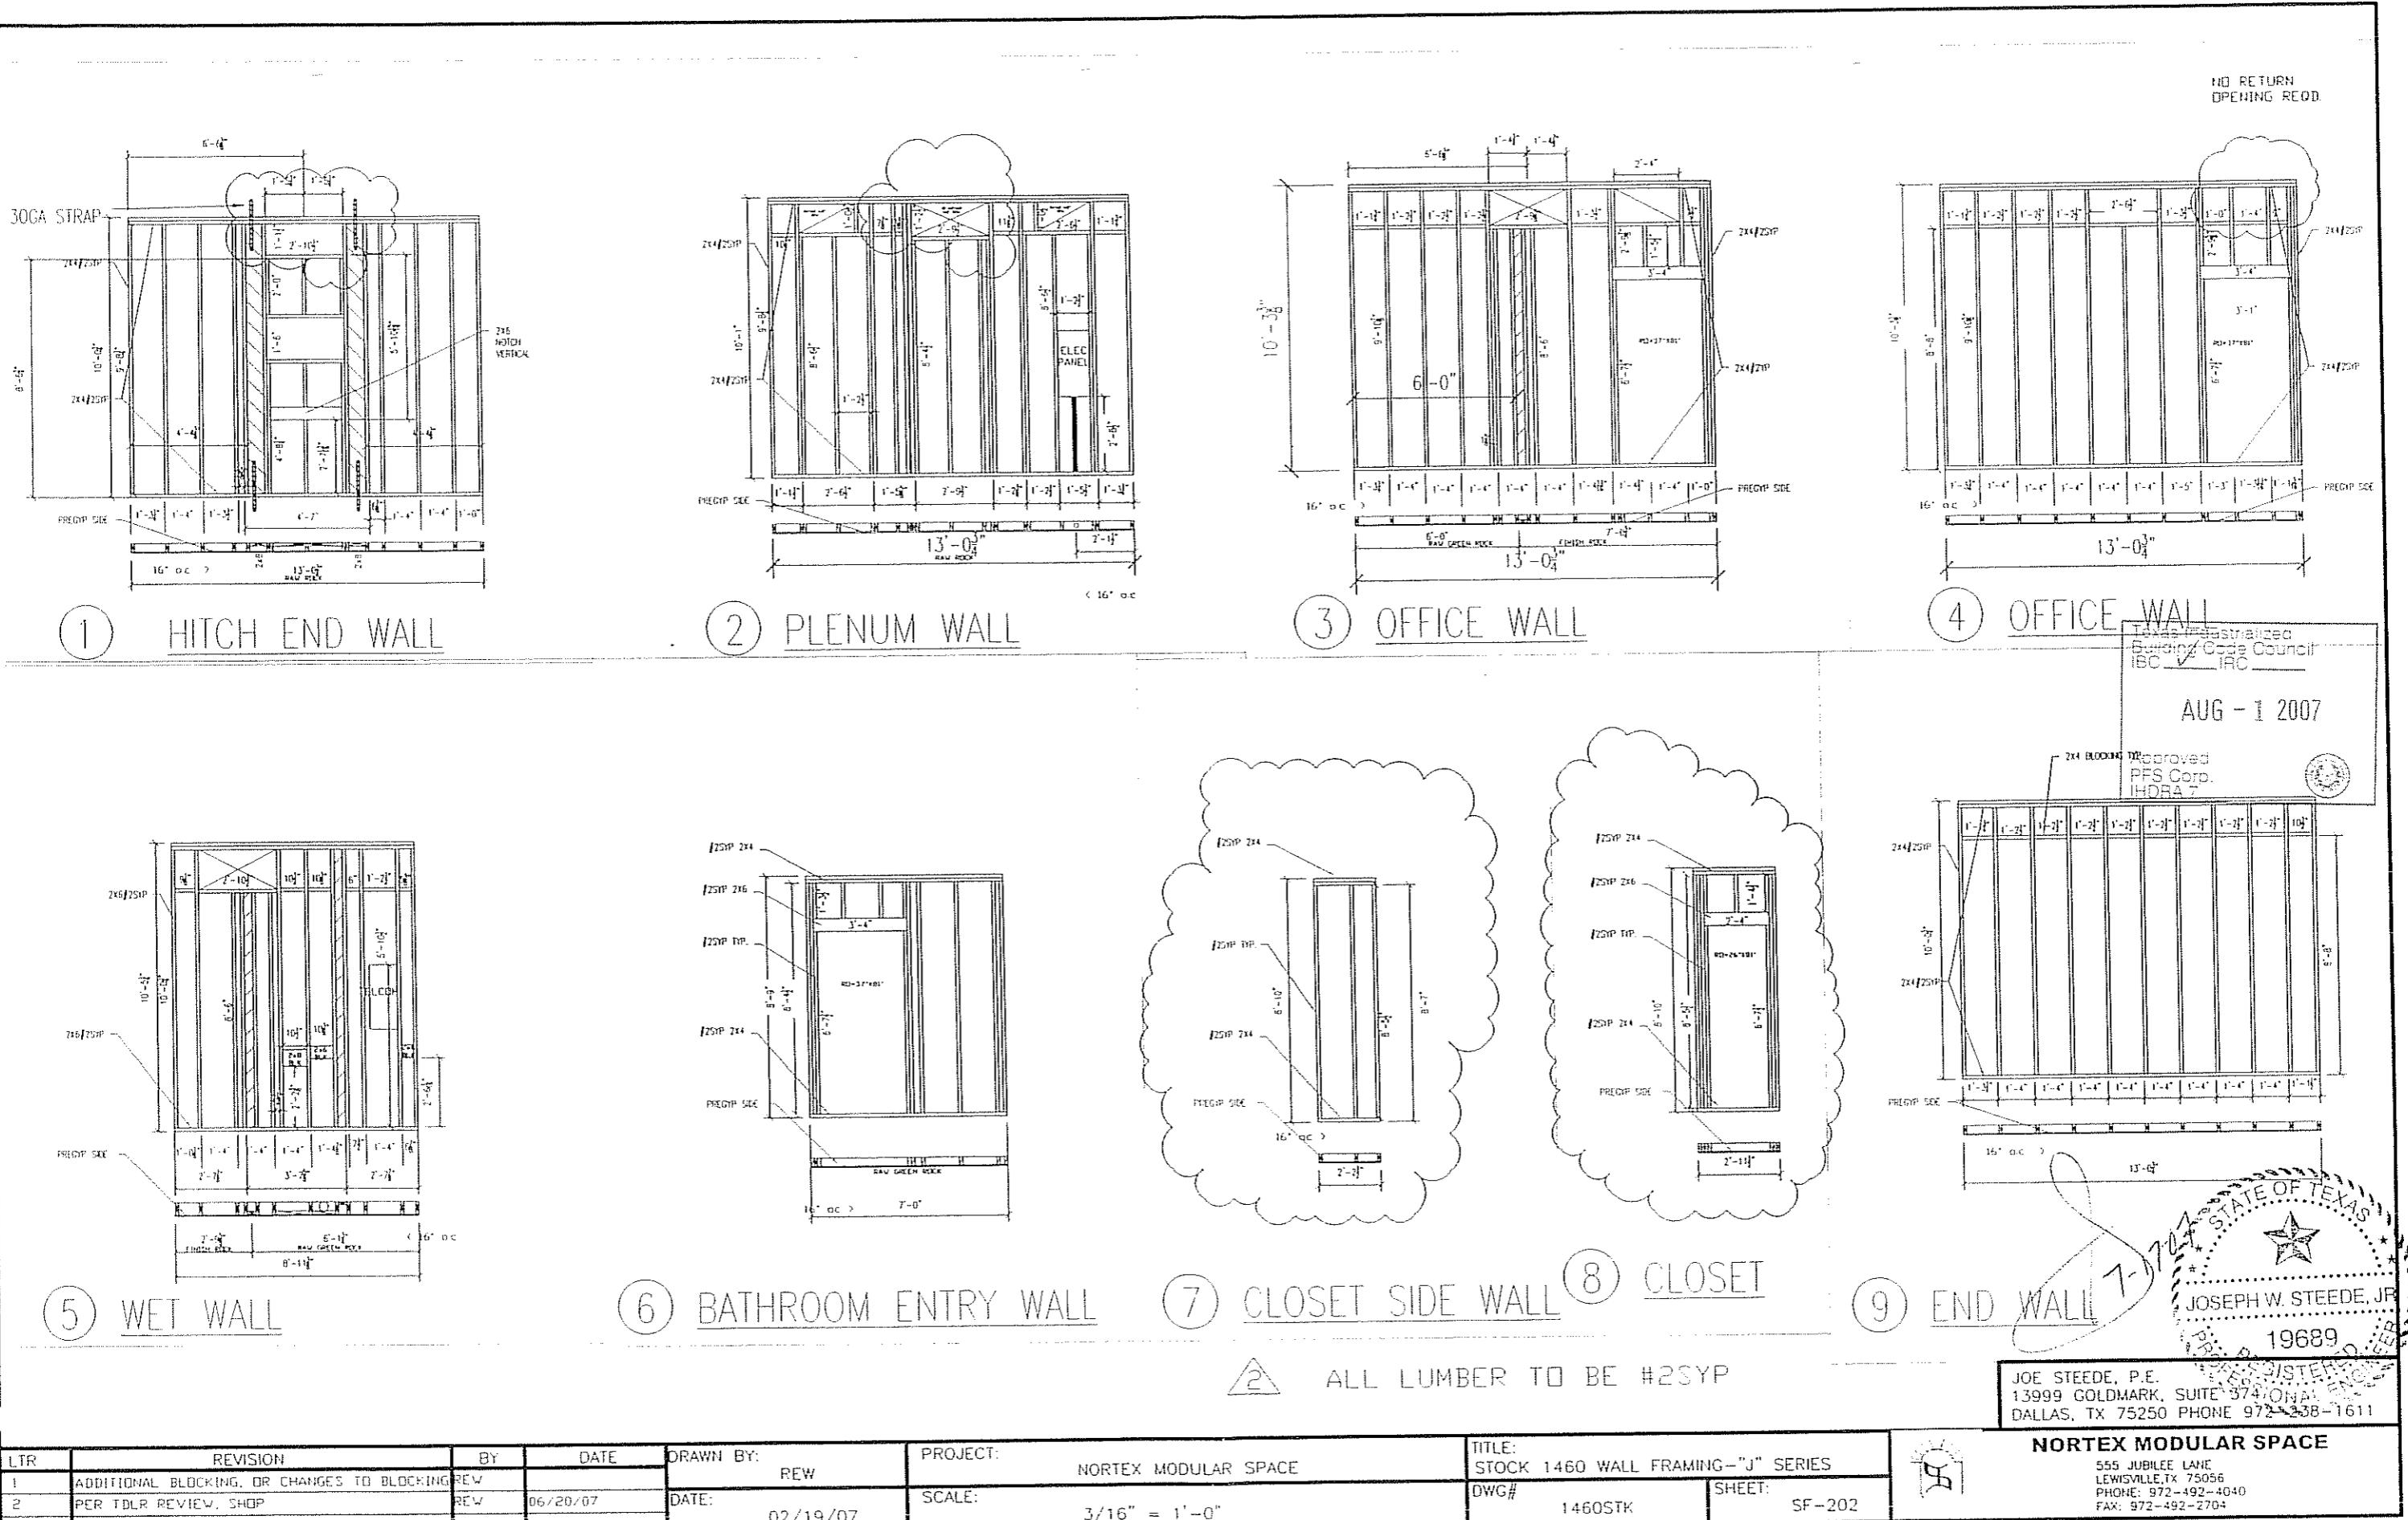
Nortex Modular Space
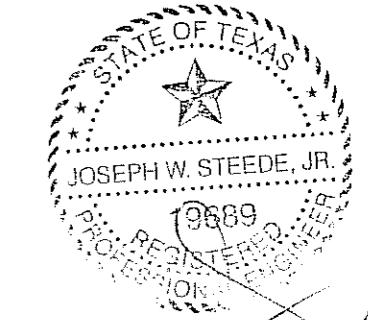
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LEWISVILLE, TX 75056
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FAX: 972-492-2704




① SIDEWALL

LTR	REVISION	BY	DATE	DRAWN BY:	PROJECT:	TITLE:	
1	MOVED FEC DOWN, ADDED PORCH LIGHT BLKNG	REW	4/13/07	REW	Nortex Modular Space	STOCK 1460 WALL FRAMING—"J" SERIES	
	MOVED GRAB BAR BLKG			DATE:	SCALE:	DWG#	SHEET:
2	REPLACED ALL WALLS TO SHOW FRAMED OPNG	REW	06/21/07	02/19/07	3/16" = 1'-0"	1460STK	SF-201




LTR	REVISION	BY	DATE	DRAWN BY:	PROJECT:	TITLE: STOCK 1460 WALL FRAMING - "J" SERIES	
1	ADDITIONAL BLOCKING, OR CHANGES TO BLOCKING	REW		REW	NORTEX MODULAR SPACE		
2	PER TDLR REVIEW, SHOP	REW	06/20/07	DATE: 02/19/07	SCALE: 3/16" = 1'-0"	DWG# 1460STK	SHEET: SF-202

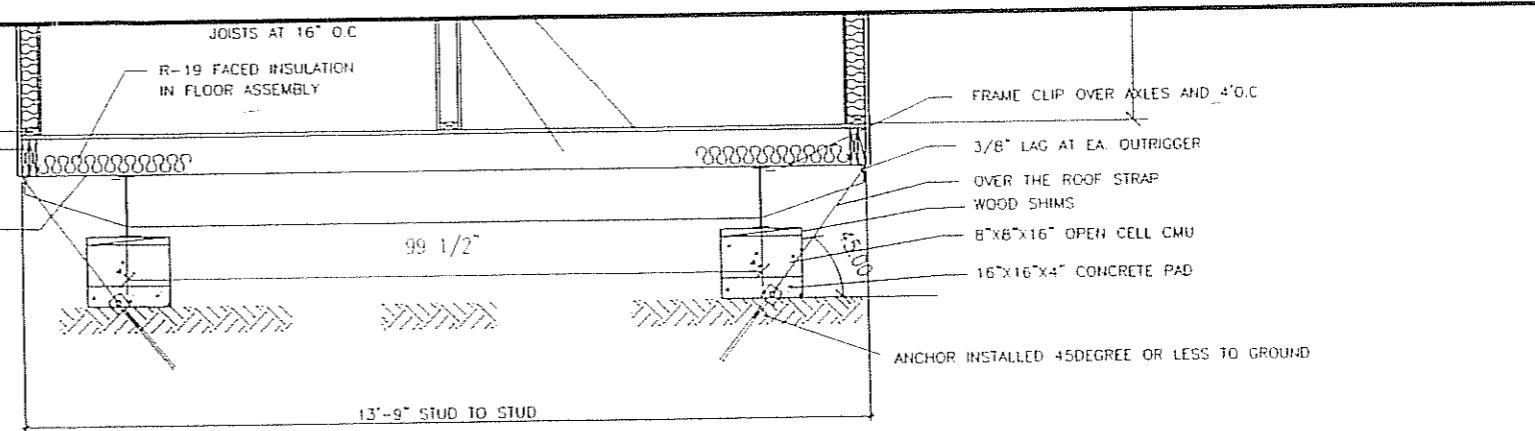

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FOUNDATION PLAN

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LTR	REVISION	BY	DATE	DRAWN BY:	PROJECT:	TITLE:	NORTEX MODULAR SPACE	
1	ADDED LOAD VALUES AT PIERS. NOTE 4	REW	06/21/07		NORTEX MODULAR SPACE	STOCK 1460 FOUNDATION PLAN-"J" SERIES	DWG#	1460STK
				DATE: 02/19/07	SCALE: 3/16" = 1'-0"		SHEET:	S-101

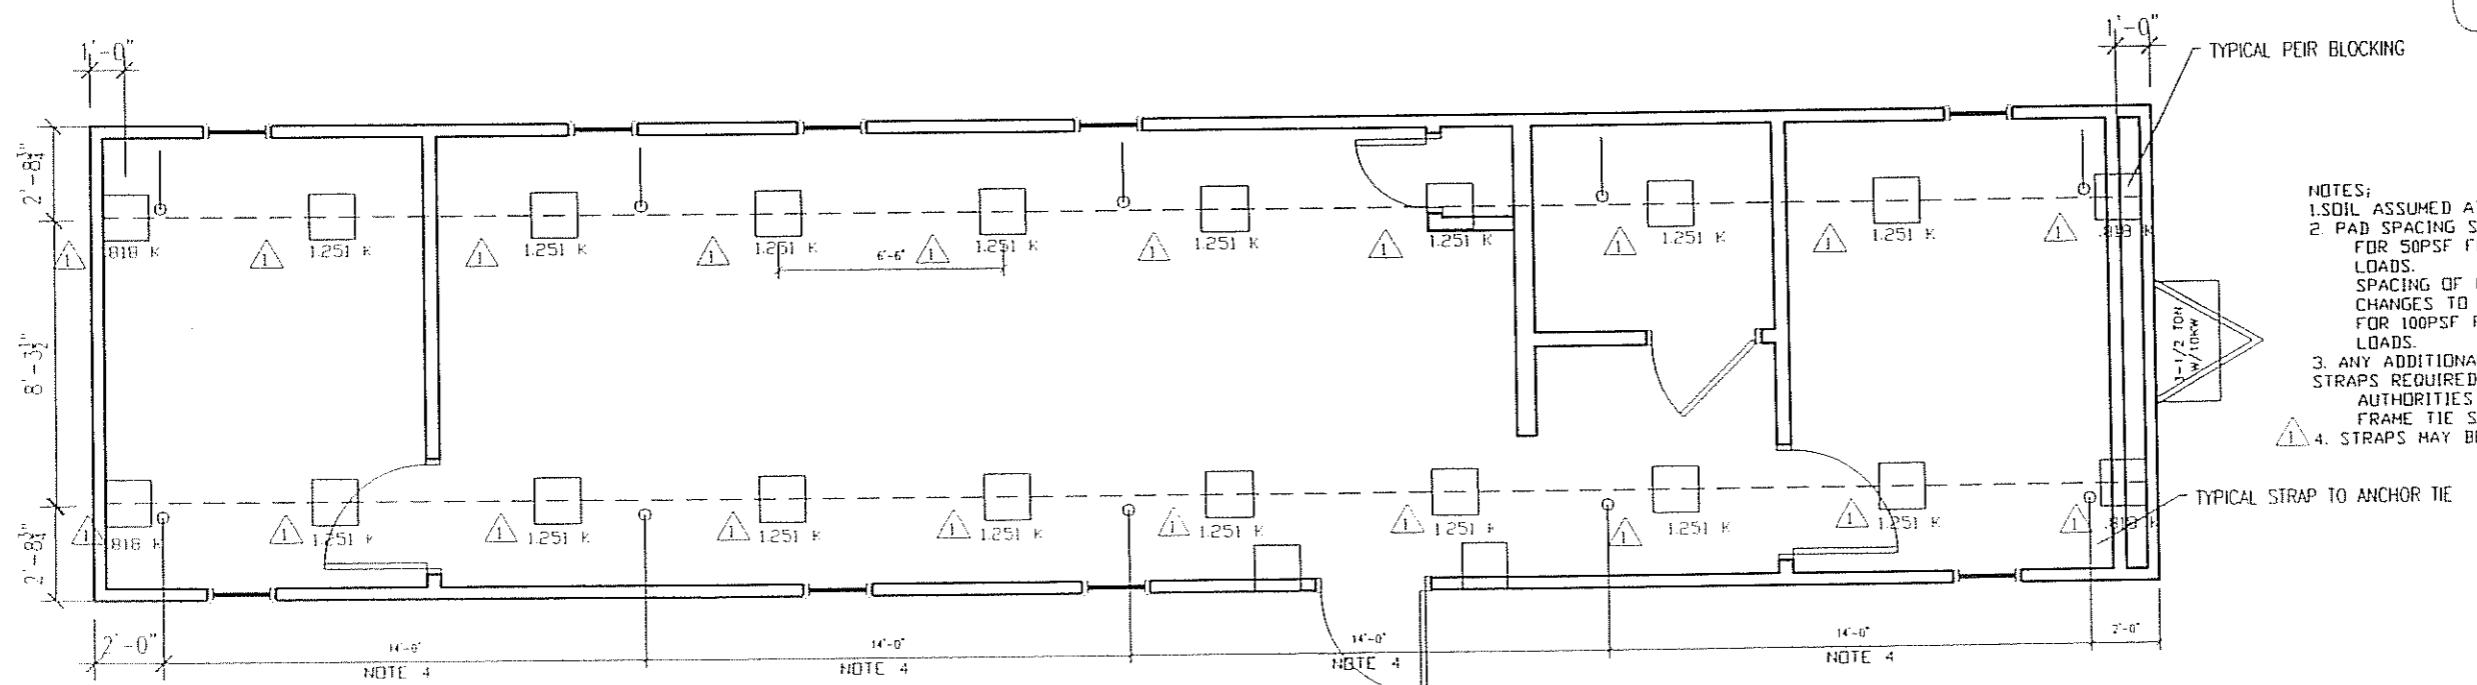