Owner

NAME: NAME
ADDRESS: ---

Project Description & Data

2-STORY SINGLE FAMILY HOME CONSTRUCTION: TYPE 5B

BUILDING AREA: GARAGE: 400 SF 1ST FLOOR: 930 SF 2ND FLOOR: 930 SF

BUILDING HEIGHT: 30'-4"

Sheet Name & Number

ARCHITECTURAL DRAWINGS:

A1 Project Data

A2 1st Floor Plans

A3 2nd Floor Plan & Sections

A4 Roof Plan & Details

A5 Elevations

FOUNDATION DRAWING:

S1 Foundation Plan &I Details

Project Loads 10 PSF 2nd FLOOR DEAD LOAD 2nd FLOOR LIVE LOAD 30 PSF 10 PSF ROOF DEAD LOAD 50 PSF GROUND SNOW LOAD, Pa 31 PSF FLAT ROOF SNOW LOAD, Pf SNOW EXPOSURE FACTOR, Ce SNOW LOAD IMPORTANCE FACTOR, I 1.0 THERMAL FACTOR, Ct BASIC WIND SPEED 115 MPH MIND EXPOSURE SEISMIC DESIGN CATEGORY SEISMIC SITE CLASS ALLOWABLE SOIL BEARING CAPACITY 4000 PSF

Drawings ARCHITECTURAL & FOUNDATION DRAWINGS: The Milovia Group Olivia Cellini. PE

Olivia Cellini, PE 2575 Johnson Rd. Scotia, NY 12302 518-250-9676

olivia@milovia.com

STRUCTURAL DRAWINGS
Fourd Panel Inc.

PO Box 185, M. Chesterfield, NH 03466 603-256-8800

SITE DRAWINGS:

Name
Consulting Engineer

Address Phone

Email

ROOM	AREA (sq.ft)	LIGHT (sq.ft)		VENT (sq.ft)		EGRESS (sq.ft)		EGRESS OPENING (inches- $W \times H$)	
		code	actual	code	actual	code	actual	code	actual
SEDROOM 1	173	14		7		5.0	6.7	20"×24"	
SEDROOM 2	260	21		10		5.7	6.0	20"×24"	
SEDROOM 3	215	17		9		5.7	6.0	20"×24"	
TUDY	174	14		7		5.7	6.0	20"×24"	

DOOR SCHEDULE							
NUMBER	FLOOR	QTY	MIDTH	HEIGHT	R/0	DESCRIPTION	
D01	1	1	30 "	80 "	32"X82 1/2"	HINGED-DOOR P04	
D02	1	1	30 "	80 "	32"X82 1/2"	2 DR. BIFOLD-LOUVERED	
D03	1	1	36 "	80 "	38"X82 1/2"	POCKET-DOOR P04	
D04	1	2	36 "	80 "	38"X83"	EXT. HINGED-DOOR E21	
D05	1	1	96 "	80 "	98"X83"	EXT. SLIDER-DOOR F01	
D06	1	1	48 "	80 "	50"X82 1/2"	SLIDER-DOOR P04	
D07	1	1	192 "	84 "	194"X8 7 "	GARAGE-GARAGE DOOR CHD05	
D08	2	2	32 "	80 "	34"X82 1/2"	POCKET-DOOR P04	
D11	2	ო	32 "	80 "	34"X82 1/2"	HINGED-DOOR P04	
D12	2	1	30 "	80 "	32"X82 1/2"	HINGED-DOOR P04	
D14	2	1	36 "	80 "	38"X82 1/2"	2 DR. BIFOLD-LOUVERED	
D15	2	1	72 "	80 "	74"X82 1/2"	SLIDER-DOOR P04	
DOOR NOTES:							

1. SEE STRUCTURAL DRAWINGS FOR HEADER SIZES IN SIP WALLS.

2. ROUGH OPENING (RO) SHALL ADD A MINIMUM OF 2" TO THE WIDTH, & 3" TO THE HEIGHT. SEE MANUFACTURER FOR RECOMMENDED RO. DIMENSIONS ON PLAN ARE TO CENTER OF RO.

MINDOM SCHEDULE							
NUMBER	FLOOR	QTY	MIDTH	HEIGHT	R/0	DESCRIPTION	
M01	1	1	12 "	80 "	13"X81"	FIXED GLASS	
M02	1	1	36 "	12 "	37"X13"	FIXED GLASS	
M03	1	1	36 "	54 "	37"X55"	SNGL CASEMENT-HR	
M04	1	2	36 "	72 "	37"X73"	FIXED GLASS	
M05	1	2	62 "	40 "	63"X41"	DBL CASEMENT-LHL/RHR	
M06	1	1	96 "	16 "	97"X17"	FIXED GLASS	
M07	2	1	31 "	12 "	32"X13"	FIXED GLASS	
M08	2	2	31 "	40 "	32"X41"	FIXED GLASS	
M09	2	2	31 "	40 "	32"X41"	SNGL CASEMENT-HR	
W10	2	1	36 "	40 "	37"X41"	SNGL CASEMENT-HR	
W11	2	4	36 "	62 "	37"X63"	FIXED GLASS	
W12	2	2	62 "	40 "	63"X41"	DBL CASEMENT-LHL/RHR	

MINDOM NOTES:

1. WINDOWS SHALL BE ANDERSEN 400 SERIES, UNO. ALL SOUTHERN GLASS


SHALL BE "PASSIVE SOLAR" GLASS.

2. ALL HEADERS SHALL BE (2) 2×6

3. ROUGH OPENING (RO) SHALL ADD A MINIMUM OF 2" TO BOTH THE HEIGHT AND WIDTH. SEE MANUFACTURER FOR RECOMMENDED RO. DIMENSIONS ON PLAN

ARE TO CENTER OF RO.

LIGHT, VENTILATION & EGRESS SCHEDULE

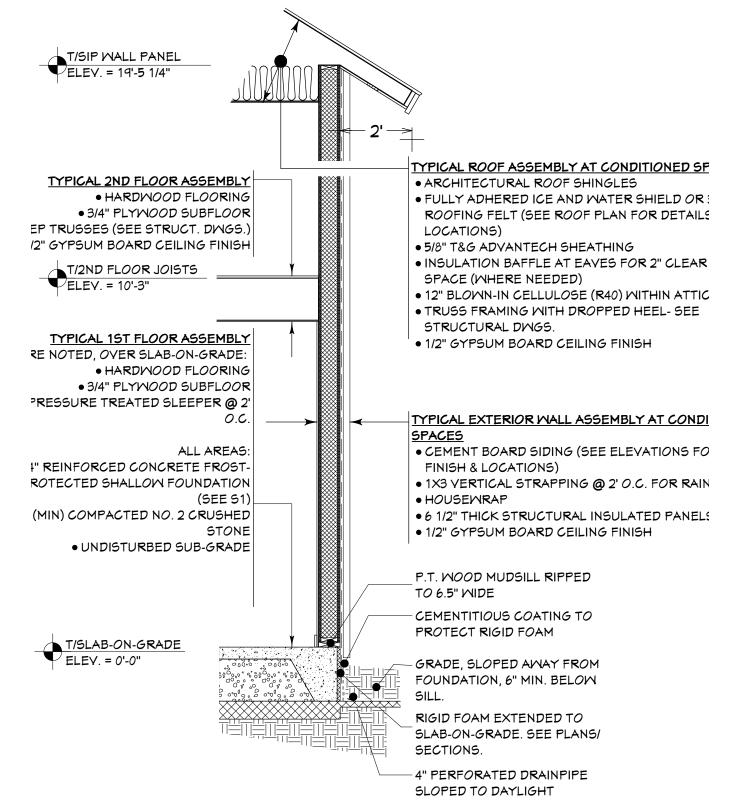


TYPICAL EXTERIOR WALL DETAIL

SCALE: 3/8" = 1'-0"



PROGRESS SET- NOT FOR CONSTRUCTION

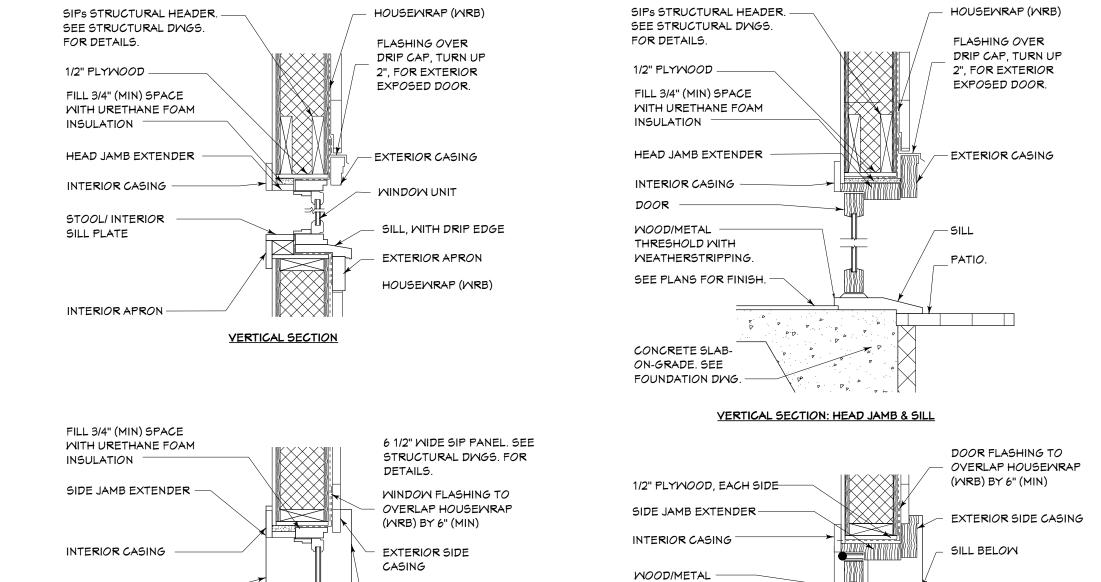

TYPICAL DOOR DETAIL SCALE: 3/4" = 1'-0"

HORIZONTAL SECTION

STOOL/SILL BELOW

SILL BELOW

TYPICAL MINDOM DETAIL

SCALE: 3/4" = 1'-0"

HORIZONTAL SECTION: SIDE JAMB

All construction meets or exceeds the NY State Energy Conservation Code & the NY State Building Construction Code applicable to one & two family dwellings.

THRESHOLD WITH

MEATHERSTRIPPING

NO. DESCRIPTION

1 - OJC Date

2 OJC DATE

OJC DATE

OJC DATE

OJC DATE

OJC DATE

t. Project Data

572 Columbia S

SCALE:

1/4" = 1'-0"

DATE:

9/15/2015

SHEET:

A1

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