


## GENERAL NOTES

- MISCELLANEOUS NOTES
- SQUARE CORNER BEAD AT ALL INTERIOR OUTSIDE CORNERS AND WINDOWS SURROUNDS.
  - ALL EXTERIOR DOORS AND WINDOWS TO BE STANDARD HEIGHT W/ STANDARD FRAME OPENINGS UNLO. ON PLAN.
  - DOOR HEIGHTS  
3.1. FRONT ENTRY DOOR IS TO BE 6'-0" IN HEIGHT.  
3.2. ALL OTHER DOORS ARE TO BE 6'-0" IN HEIGHT UNLESS NOTED OTHERWISE IN PLANS.
  - WALL FRAMING  
4.1. EXTERIOR WALLS - 2X6 AT 16" O.C.  
4.2. INTERIOR BEARING WALLS - 2X4 AT 16" O.C. UNLESS NOTED OTHERWISE IN STRUCTURAL PLANS.  
4.3. INTERIOR WALLS (NON-BEARING) - 2X4 AT 24" O.C.  
4.4. INTERIOR PLUMBING WALLS - 2X6 AT 24" O.C.
  - INSULATION  
5.1. ROOF / CEILING - R38  
5.2. EXTERIOR WALLS - R19  
5.3. INTERIOR WALLS BETWEEN GARAGE & HOUSE - R13  
5.4. GARAGE CEILING - R13
  - VERIFY DIMENSIONS WITH PLUMBING FIXTURE MANUFACTURER FOR ACTUAL DRAIN LOCATIONS.
  - PROVIDE A CATWALK & WORKING PLATFORM IN ATTIC FOR THE SERVICE OF COMBUSTION AND VENTILATION AIR UNITS. PROVIDE A PERMANENT ELECTRICAL OUTLET AND SWITCHED LIGHT FIXTURE IN ATTIC AREAS AT HVAC EQUIPMENT THAT REQUIRE SERVICING. SWITCH TO BE LOCATED AT THE ACCESS OPENING.
  - ALL DIMENSIONS INDICATED ARE FROM / TO FACE OF STUD. UNLO.
  - A DOOR STOOP IS REQUIRED AT ALL EXTERIOR DOORS. STOOP IS TO BE 6" WIDER THAN THE WIDTH OF THE DOOR OPENING, CENTERED ON DOOR AND A MIN. OF 36" IN THE DIRECTION OF TRAVEL.
  - EXTERIOR DOORS SHALL BE PROVIDED WITH A SWITCHED LIGHT TO ILLUMINATE THE EXTERIOR EXIT LANDING.
  - THE DESIGN OF THE VAPOR BARRIER SHALL NOT CREATE CONDITIONS OF ACCELERATED DETRIORATION FROM MOISTURE CONDENSATION IN ALL CEILINGS NOT VENTILATED.
  - TWO LAYERS OF GRADE "D" PAPER ARE REQUIRED OVER OSB OR PLYWOOD AT ALL EXTERIOR WALLS PRIOR TO APPLICATION OF METAL LATH OR EPS BOARD. THIS APPLIES TO ANY WOOD BASED PRODUCT.
  - THE INTERIOR OF THE BUILDING SHALL BE SEPARATED FROM FOAM PLASTIC INSULATION BY USING AT LEAST THE MINIMUM RED JERMENTS AS PRESCRIBED IN IRC R308.
  - ALL GUARDRAILS TO BE A MIN. OF 36" HIGH W/ INTERMEDIATE RAILS SPACED SUCH THAT A 4" SPHERE WILL NOT PASS THROUGH.
  - ESCAPE OR RESCUE WINDOWS SHALL HAVE A MIN. NET CLR. OPENABLE AREA OF 5.7 SQ. FT. THE MIN. NET CLR. OPENABLE DIM. SHALL BE 24" IN HT. AND 20" IN WIDTH. WHEN WINDOWS ARE PROVIDED AS A MEANS OF ESCAPE OR RESCUE, THEY SHALL HAVE A FINISHED SILL HT. NOT MORE THAN 44" ABOVE THE FLR.
  - FUEL-BURNING CLOTHES DRYERS LOCATED IN A CLOSET SHALL BE PROVIDED A MINIMUM OPENING OF 100 SQUARE INCHES FOR MAKE-UP AIR IN THE DOOR OR BY OTHER APPROVED MEANS (WHERE OCCURS).
  - FACTORY-BUILT FIREPLACES AND CHIMNEYS AND THEIR INSTALLATION SHALL COMPLY WITH 2018 IRC CHAPTER 10, SECTION R9005 INCLUDING LOCAL AMENDMENTS. A GAS FIREPLACE SHALL BE PROVIDED WITH AN UNOBSTRUCTED FRESH AIR SUPPLY DIRECTLY FROM THE EXTERIOR OF THE STRUCTURE TO THE FIRE BOX.
  - DRYER VENT NOT TO EXCEED 14 FEET IN TOTAL LENGTH INCLUDING TWO 90° ELBOWS PER 2018 IMC 504.4.2.1. EXHAUST DUCTS TO BE INSTALLED PER 2018 IMC 504.4. DRYER VENT & EXHAUST DUCTS TO TERMINATE THREE FEET FROM ANY BUILDING OPENING & BE EQUIPPED WITH A BACKDRAFT DAMPER. SCREENS SHALL NOT BE INSTALLED TO THE FIRE BOX.
  - STUCCO & ROOF SYSTEMS SHALL BE INSTALLED PER MANUFACTURERS SPECIFICATIONS & COMPLIANT WITH 2018 IRC SECTIONS R703.17 & R905, RESPECTIVELY.

SEPARATE PERMIT APPROVAL IS REQUIRED FOR WALLS, FENCES, POOLS, SPAS, SIGNS AND ACCESSORY STRUCTURES.

APPROVAL OF THIS PERMIT DOES NOT CONSTITUTE APPROVAL OF ANY OTHER EXISTING OR PROPOSED STRUCTURES OR USES. SEPARATE PERMITS AND POSSIBLE LAND USE MAY BE REQUIRED.

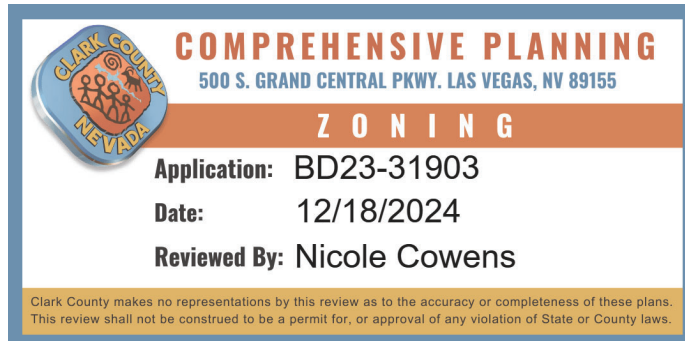


WINDOW SCHEDULE (X)						
MARKER	LOCATION	TYPE	QUANTITY	WIDTH	HEIGHT	HEAD HEIGHT
1	ENTRY	FIXED	1	5'-0"	3'-0"	12'-0"
2	ENTRY	FIXED	2	4'-0"	1'-6"	15'-0"
3	ENTRY	FIXED	2	6'-0"	1'-6"	15'-0"
4	GREAT ROOM	FIXED	2	6'-0"	2'-0"	15'-0"
5	GREAT ROOM	FIXED	4	5'-0"	2'-0"	12'-0"
6	THEATER ROOM	SINGLE HUNG	1	3'-0"	8'-0"	8'-0"
7	BED 2 / BED 3 / BED 4	SINGLE HUNG	5	3'-0"	8'-0"	8'-0"
8	BATH 2 / BATH 3	SINGLE HUNG	2	2'-0"	4'-0"	8'-0"
9	BATH 3 / CLOSET AT BED 3	FIXED	2	2'-0"	1'-6"	8'-0"
10	KITCHEN	FIXED	2	5'-0"	1'-0"	9'-6"
11	OWNER'S SUITE	SLIDER	3	5'-0"	6'-0"	8'-0"
12	OWNER'S SUITE	FIXED	3	5'-0"	1'-0"	10'-0"
14	OWNER'S BATH	FIXED	1	4'-0"	1'-6"	8'-0"
15	BED 4	FIXED	1	4'-0"	1'-6"	4'-0" / 6'-0" / 8'-0"
18	KITCHEN	FIXED	1	4'-0"	5'-0"	9'-0"

- WINDOW NOTES:
- PROVIDE SAFETY GLAZING AS REQUIRED PER 2018 IRC SECTION R308.4 (TEMPERED OR LAMINATED).
  - WINDOWS MAY BE CUSTOM FABRICATED PER SCHEDULE.
  - SCREEN COLOR TO BE OWNER SELECTED. 18X16 FIBERGLASS MESH WITH FRAMES TO MATCH WINDOW, WHERE OCCURS.
  - VERIFY WINDOW ORDER AND ROUGH FRAMING PRIOR TO PLACEMENT OF THE WINDOW ORDER.
  - WINDOW MANUFACTURER TO PROVIDE SHOP DRAWINGS FOR SPECIAL WINDOWS FOR REVIEW, WHERE OCCURS.
  - APPLY G.I. FLASHING EXTERIOR OPENINGS.
  - PROVIDE CONTINUOUS CAULK AROUND ALL WINDOW AND DOOR OPENINGS WITH A SILICONE ACRYLIC OR SIMILAR.
  - ALL MANUFACTURED WINDOWS TO BE CERTIFIED AND LABELED MEETING TITLE 24 REQUIREMENTS.
  - ALL OPERABLE WINDOWS TO HAVE REMOVABLE SCREENS.
  - SEE EXTERIOR ELEVATIONS AND WINDOW SCHEDULE FOR HEAD HEIGHTS.
  - ALL WINDOW GLAZING SHALL BE 88" CLEAR, DUAL PANELED INSULATED GLASS - LOW E.
  - FOR WINDOWS WITHIN 1'-6" OF FLOOR, ALL BOTTOM OF GLAZING TO BE A MINIMUM OF 1'-7" ABOVE FINISHED FLOOR.
  - EMERGENCY ESCAPE OPENING REQUIREMENTS (1 PER BEDROOM):  
CLEAR AREA = 5.7 SQ. FT. AT GROUND LEVEL  
MINIMUM CLEAR WIDTH = 20 INCHES  
MINIMUM CLEAR HEIGHT OF 24 INCHES  
MAXIMUM SILL HEIGHT = 44 INCHES A.F.F.

DOOR SCHEDULE (X)					
MARKER	LOCATION	TYPE	QUANTITY	WIDTH	HEIGHT
1	GARAGE	OVERHEAD	1	18'-0"	8'-0"
2	GARAGE	OVERHEAD	1	9'-0"	8'-0"
3	GARAGE	INTERIOR	1	3'-0"	8'-0"
4	GARAGE	SOLID CORE	2	3'-0"	8'-0"
5	ENTRY	SOLID CORE	1	5'-0"	8'-0"
6	LAUNDRY / PAU CLOSETS / THEATER	INTERIOR	4	3'-0"	8'-0"
7	BED / BATH CLOSETS / PANTRY	INTERIOR	15	2'-0"	8'-0"
8	OWNER'S SUITE	INTERIOR	1	5'-0"	8'-0"
9	OWNER'S BATH	INTERIOR	1	3'-0"	8'-0"
10	GREAT ROOM	SGD	1	24'-0"	8'-0"
11	AUDIO/VIDEO CONTAINERS CLOSETS	INTERIOR	3	2'-4"	8'-0"

- DOOR NOTES:
- PROVIDE DEADBOLT LOCKS ON ALL EXTERIOR DOORS.
  - PROVIDE PRIVACY HARDWARE FOR ALL BEDROOM AND BATH DOORS.
  - ALL DOOR GLAZING, INCLUDING SIDE LIGHTS TO BE TEMPERED.
  - ALL EXTERIOR DOOR GLAZING TO BE 88" DUAL GLAZED INSULATED LOW-E GLASS.
  - ALL DOORS BETWEEN CONDITIONED AND UN-CONDITIONED SPACES TO BE FULLY WEATHER STRIPPED.
  - ALL DOOR TOPS AND BOTTOMS TO BE SANDED, FINISHED AND SEALED.
  - GARAGE DOORS TO BE SECTIONAL OVERHEAD DOORS.
  - GARAGE INTERIOR DOOR TO BE FIRE RATED (MIN 20 MINUTED RATED DOOR).
  - ALL WOOD DOORS TO BE SOLID CORE CONSTRUCTION WITH (MINIMUM 1 3/4" THICK) OR WITH PANELS NO LESS THAN 9/16" THICK.
  - INACTIVE LEAF OF DOUBLE DOORS SHALL BE EQUIPPED WITH METAL FLUSH BOLTS HAVING A MINIMUM EMBEDMENT OF 5/8" INTO THE HEAD AND THRESHOLD OF THE DOOR FRAME.
  - GLAZING IN EXTERIOR DOORS TO BE FULLY TEMPERED GLASS OR RATED BURGLARY RESISTANT GLAZING.
  - ALL INTERIOR DOORS TO BE SEMI-SOLID 5-PANEL, UNLESS NOTED OTHERWISE.
  - NFR = NON-REMOVABLE FIN.
  - LANDINGS OUTSIDE EXTERIOR EGRESS DOOR SHALL NOT BE MORE THAN 1 1/2" LOWER THAN THE TOP OF THE THRESHOLDS, AT ALL OTHER DOORS THE EXTERIOR SIDE SHALL BE NO MORE THAN 7 3/4" BELOW THE TOP OF THE THRESHOLD.

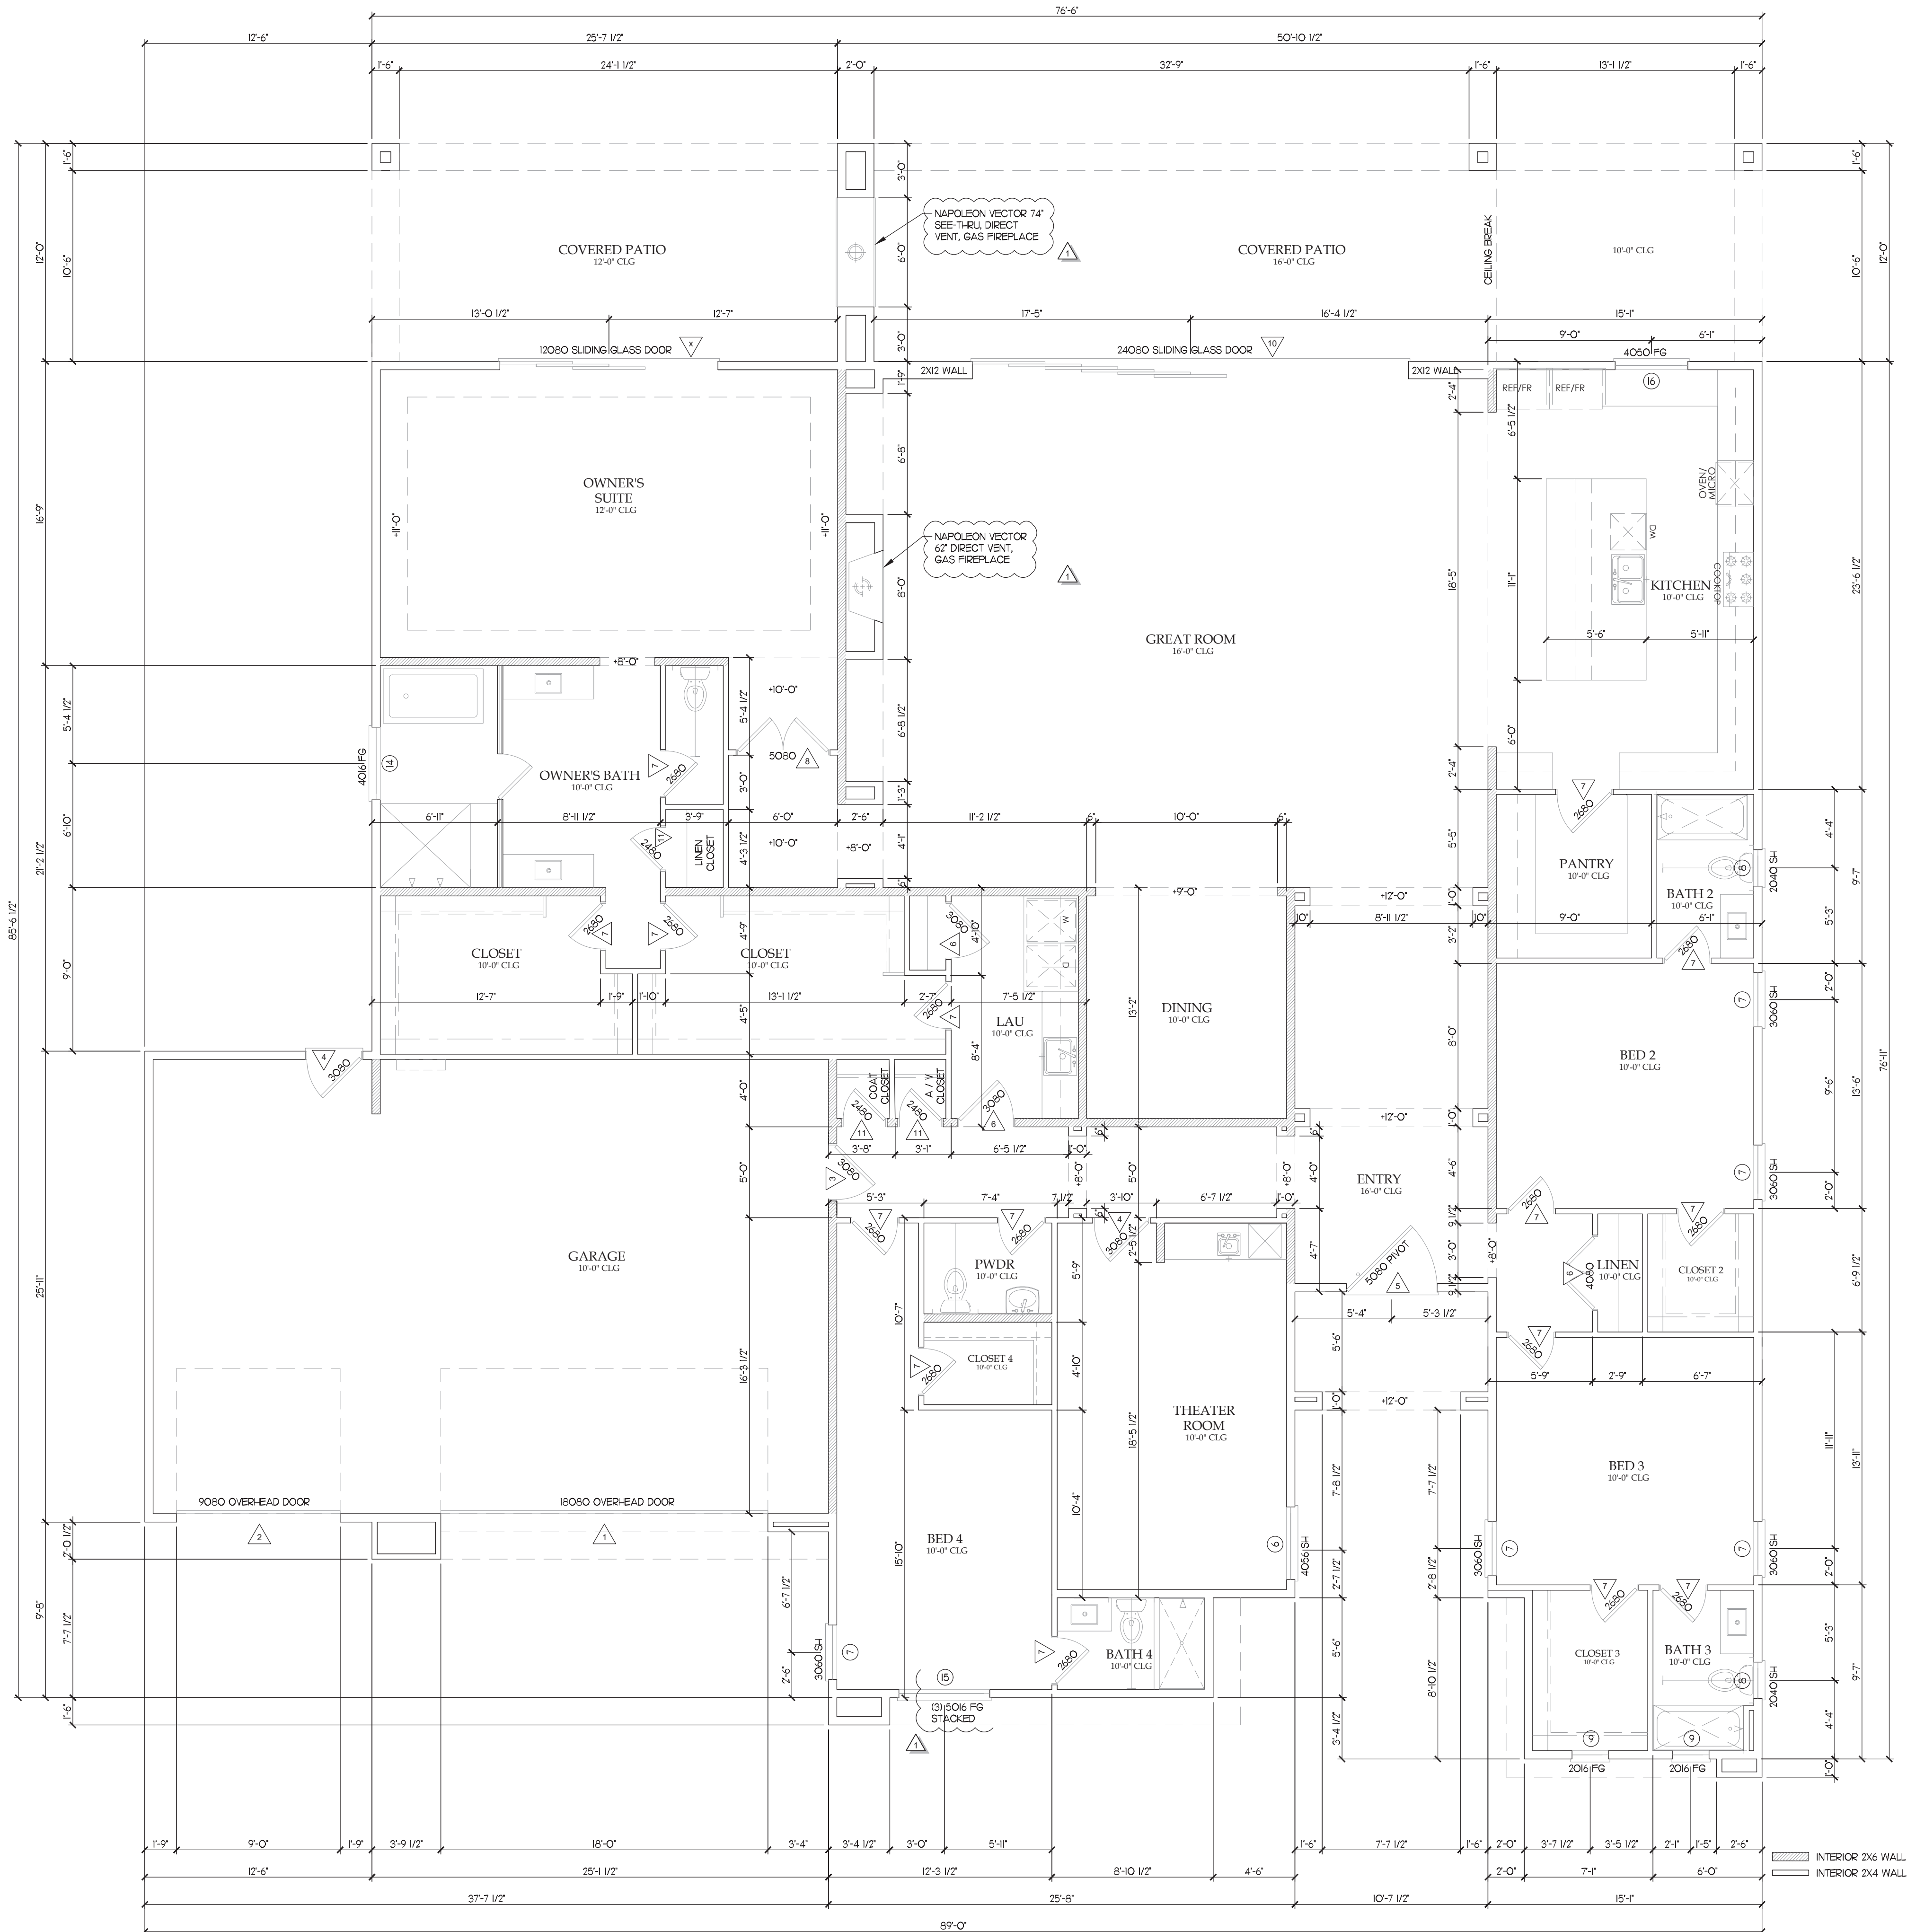

## FLOOR PLAN

SCALE: 1/4" = 1'-0"

## FLOOR PLAN

SINGLE FAMILY CUSTOM HOME  
APN 176-15-401-021

DESIGNED BY: EDM


DRAWN BY: EDM

CHECKED BY:

DATE ISSUED:

JOB NUMBER: 028-0022

SCALE: 1/4" = 1'-0"

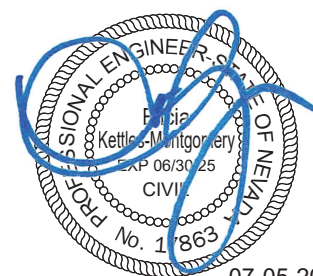

SHEET NUMBER

A-2.1



GENERAL NOTES

- MISCELLANEOUS NOTES:
- SQUARE CORNER BEAD AT ALL (INTERIOR) OUTSIDE CORNERS AND WINDOWS SURROUNDS.
  - ALL EXTERIOR DOORS AND WINDOWS TO BE STANDARD HEIGHT W/ STANDARD FRAME OPENINGS UNLO. ON PLAN.
  - DOOR HEIGHTS:  
3.1. FRONT ENTRY DOOR IS TO BE 6'-0" IN HEIGHT.  
3.2. ALL OTHER DOORS ARE TO BE 6'-0" IN HEIGHT UNLESS NOTED OTHERWISE IN PLANS.
  - WALL FRAMING:  
4.1. EXTERIOR WALLS - 2X6 AT 16" O.C.  
4.2. INTERIOR BEARING WALLS - 2X4 AT 16" O.C. UNLESS NOTED OTHERWISE IN STRUCTURAL PLANS.  
4.3. INTERIOR WALLS (NON-BEARING) - 2X4 AT 24" O.C.  
4.4. INTERIOR PLUMBING WALLS - 2X6 AT 24" O.C.
  - INSULATION:  
5.1. ROOF / CEILING - R38  
5.2. EXTERIOR WALLS - R19  
5.3. INTERIOR WALLS BETWEEN GARAGE & HOUSE - R13  
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  - VERIFY DIMENSIONS WITH PLUMBING FIXTURE MANUFACTURER FOR ACTUAL DRAIN LOCATIONS.
  - PROVIDE A CATWALK & WORKING PLATFORM IN ATTIC FOR THE SERVICE OF COMBUSTION AND VENTILATION AIR UNITS. PROVIDE A PERMANENT ELECTRICAL OUTLET AND SWITCHED LIGHT FIXTURE IN ATTIC AREAS AT HVAC EQUIPMENT THAT REQUIRE SERVICING. SWITCH TO BE LOCATED AT THE ACCESS OPENING.
  - ALL DIMENSIONS INDICATED ARE FROM / TO FACE OF STUD. UNLO.
  - A DOOR STOOP IS REQUIRED AT ALL EXTERIOR DOORS. STOOP IS TO BE 6" WIDER THAN THE WIDTH OF THE DOOR OPENING, CENTERED ON DOOR AND A MIN. OF 36" IN THE DIRECTION OF TRAVEL.
  - EXTERIOR DOORS SHALL BE PROVIDED WITH A SWITCHED LIGHT TO ILLUMINATE THE EXTERIOR EXIT LANDING.
  - THE DESIGN OF THE VAPOR BARRIER SHALL NOT CREATE CONDITIONS OF ACCELERATED DETEIORATION FROM MOISTURE CONDENSATION IN ALL CEILINGS NOT VENTILATED.
  - TWO LAYERS OF GRADE "D" PAPER ARE REQUIRED OVER OSB OR PLYWOOD AT ALL EXTERIOR WALLS PRIOR TO APPLICATION OF METAL LATH OR EPS BOARD. THIS APPLIES TO ANY WOOD BASED PRODUCT.
  - THE INTERIOR OF THE BUILDING SHALL BE SEPARATED FROM FOAM PLASTIC INSULATION BY USING BT USING AT LEAST THE MINIMUM REQUIREMENTS AS PRESCRIBED IN IRC R308.
  - ALL GUARDRAILS TO BE A MIN. OF 36" HIGH W/ INTERMEDIATE RAILS SPACED SUCH THAT A 4" SPHERE WILL NOT PASS THROUGH.
  - ESCAPE OR RESCUE WINDOWS SHALL HAVE A MIN. NET CLR. OPENABLE AREA OF 5.7 SQ. FT. THE MIN. NET CLR. OPENABLE DIM. SHALL BE 24" IN HT. AND 20" IN WIDTH. WHEN WINDOWS ARE PROVIDED AS A MEANS OF ESCAPE OR RESCUE, THEY SHALL HAVE A FINISHED SILL HT. NOT MORE THAN 44" ABOVE THE FLR.
  - FUEL-BURNING CLOTHES DRYERS LOCATED IN A CLOSET SHALL BE PROVIDED A MINIMUM OPENING OF 100 SQUARE INCHES FOR MAKE-UP AIR IN THE DOOR OR BY OTHER APPROVED MEANS (WHERE OCCURS).
  - FACTORY-BUILT FIREPLACES AND CHIMNEYS AND THEIR INSTALLATION SHALL COMPLY WITH 2018 IRC CHAPTER 10, SECTION R1005 INCLUDING LOCAL AMENDMENTS. A GAS FIREPLACE SHALL BE PROVIDED WITH AN UNOBSTRUCTED FRESH AIR SUPPLY DIRECTLY FROM THE EXTERIOR OF THE STRUCTURE TO THE FIRE BOX.
  - DRYER VENT NOT TO EXCEED 14 FEET IN TOTAL LENGTH INCLUDING TWO 90° ELBOWS PER 2018 UMC 504.4.21. EXHAUST DUCTS TO BE INSTALLED PER 2018 UMC 504.4. DRYER VENT & EXHAUST DUCTS TO TERMINATE THREE FEET FROM ANY BUILDING OPENING & BE EQUIPPED WITH A BACKDRAFT DAMPER. SCREENS SHALL NOT BE INSTALLED.
  - STUCCO & ROOF SYSTEMS SHALL BE INSTALLED PER MANUFACTURER'S SPECIFICATIONS & COMPLIANT WITH 2018 IRC SECTIONS R703.1 & R703.2, RESPECTIVELY.

WINDOW SCHEDULE (X)						
MARKER	LOCATION	TYPE	QUANTITY	WIDTH	HEIGHT	HEAD HEIGHT
1	CASITA	SLIDING	2	5'-0"	5'-0"	7'-0"
2	RV GARAGE AREA	FIXED	4	6'-0"	3'-0"	14'-0"


WINDOW NOTES:

- PROVIDE SAFETY GLAZING AS REQUIRED PER 2018 IRC SECTION R308.4 (TEMPERED OR LAMINATED).
- WINDOWS MAY BE CUSTOM FABRICATED PER SCHEDULE.
- SCREEN COLOR TO BE OWNER SELECTED. 18X18 FIBERGLASS MESH WITH FRAMES TO MATCH WINDOW. WHERE OCCURS.
- VERIFY WINDOW ORDER AND ROUGH FRAMING PRIOR TO PLACEMTN OF THE WINDOW ORDER.
- WINDOW MANUFACTURER TO PROVIDE SHOP DRAWINGS FOR SPECIAL WINDOWS FOR REVIEW, WHERE OCCURS.
- APPLY G.I. FLASHING OR SIMILAR AROUND ALL EXTERIOR OPENINGS.
- PROVIDE CONTINUOUS CAULK AROUND ALL WINDOW AND DOOR OPENINGS WITH A SILICONE ACRYLIC OR SIMILAR.
- ALL MANUFACTURED WINDOWS TO BE CERTIFIED AND LABELED MEETING TITLE 24 REQUIREMENTS.
- ALL OPERABLE WINDOWS TO HAVE REMOVABLE SCREENS.
- SEE EXTERIOR ELEVATIONS AND WINDOW SCHEDULE FOR HEAD HEIGHTS.
- ALL WINDOW GLAZING SHALL BE 58" CLEAR, DUAL PANELED INSULATED GLASS - LOW E.
- FOR WINDOWS WITHIN 1'-6" OF FLOOR, ALL BOTTOM OF GLAZING TO BE A MINIMUM OF 1'-7" ABOVE FINISHED FLOOR.
- EMERGENCY ESCAPE OPENING REQUIREMENTS (1 PER BEDROOM):  
CLEAR AREA = 5.0 SQ. FT. AT GROUND LEVEL  
MINIMUM CLEAR WIDTH = 20 INCHES  
MAXIMUM SILL HEIGHT = 44 INCHES A.F.F.
- CLEAR AREA = 5.7 SQ. FT. AT ALL OTHER LOCATIONS  
MINIMUM CLEAR HEIGHT OF 24 INCHES

DOOR SCHEDULE (V)						
MARKER	LOCATION	TYPE	QUANTITY	WIDTH	HEIGHT	NOTES
1	GARAGE	OVERHEAD	1	16'-0"	14'-0"	STANDARD ROLL UP GARAGE DOOR
2	GARAGE MAN DOOR	SOLID CORE	1	3'-0"	6'-8"	METAL CLAD, EXTERIOR GRADE
3	CASITA FRONT	EXTERIOR	1	3'-0"	6'-8"	EXTERIOR GRADE WITH GLAZING
4	CASITA BATH EXTERIOR	EXTERIOR	1	2'-6"	6'-8"	EXTERIOR GRADE WITH GLAZING
5	INTERIOR DOORS	INTERIOR	4	2'-6"	6'-8"	


DOOR NOTES:

- PROVIDE DEADBOLT LOCKS ON ALL EXTERIOR DOORS.
- PROVIDE PRIVACY HARDWARE FOR ALL BEDROOM AND BATH DOORS.
- ALL DOOR GLAZING, INCLUDING SIDE LIGHTS TO BE TEMPERED.
- ALL EXTERIOR DOOR GLAZING TO BE 58" DUAL GLAZED INSULATED LOW-E GLASS.
- ALL DOORS BETWEEN CONDITIONED AND UNCONDITIONED SPACES TO BE FULLY WEATHER STRIPPED.
- ALL DOOR TOPS AND BOTTOMS TO BE SANDED, FINISHED AND SEALED.
- GARAGE DOORS TO BE SECTIONAL OVERHEAD DOORS.
- GARAGE INTERIOR DOOR TO BE FIRE RATED (MIN. 20 MINUTED RATED DOOR).
- ALL WOOD DOORS TO BE SOLID CORE CONSTRUCTION WITH (MINIMUM 1 3/4" THICK) OR WITH PANELS NO LESS THAN 8/16" THICK.
- INACTIVE LEAF OF DOUBLE DOORS SHALL BE EQUIPPED WITH METAL FLUSH BOLTS HAVING A MINIMUM EMBEDMENT OF 5/8" INTO THE HEAD AND THRESHOLD OF THE DOOR FRAME.
- GLAZING IN EXTERIOR DOORS TO BE FULLY TEMPERED GLASS OR RATED BURGLARY RESISTANT GLAZING.
- ALL INTERIOR DOORS TO BE SEMI-SOLID 5-PANEL, UNLESS NOTED OTHERWISE.
- NRP = NON-REMOVABLE PIN
- LANDINGS OUTSIDE EXTERIOR EGRESS DOOR SHALL NOT BE MORE THAN 1 1/2" LOWER THAN THE TOP OF THE THRESHOLDS. AT ALL OTHER DOORS THE EXTERIOR SIDE SHALL BE NO MORE THAN 7 3/4" BELOW THE TOP OF THE THRESHOLD.

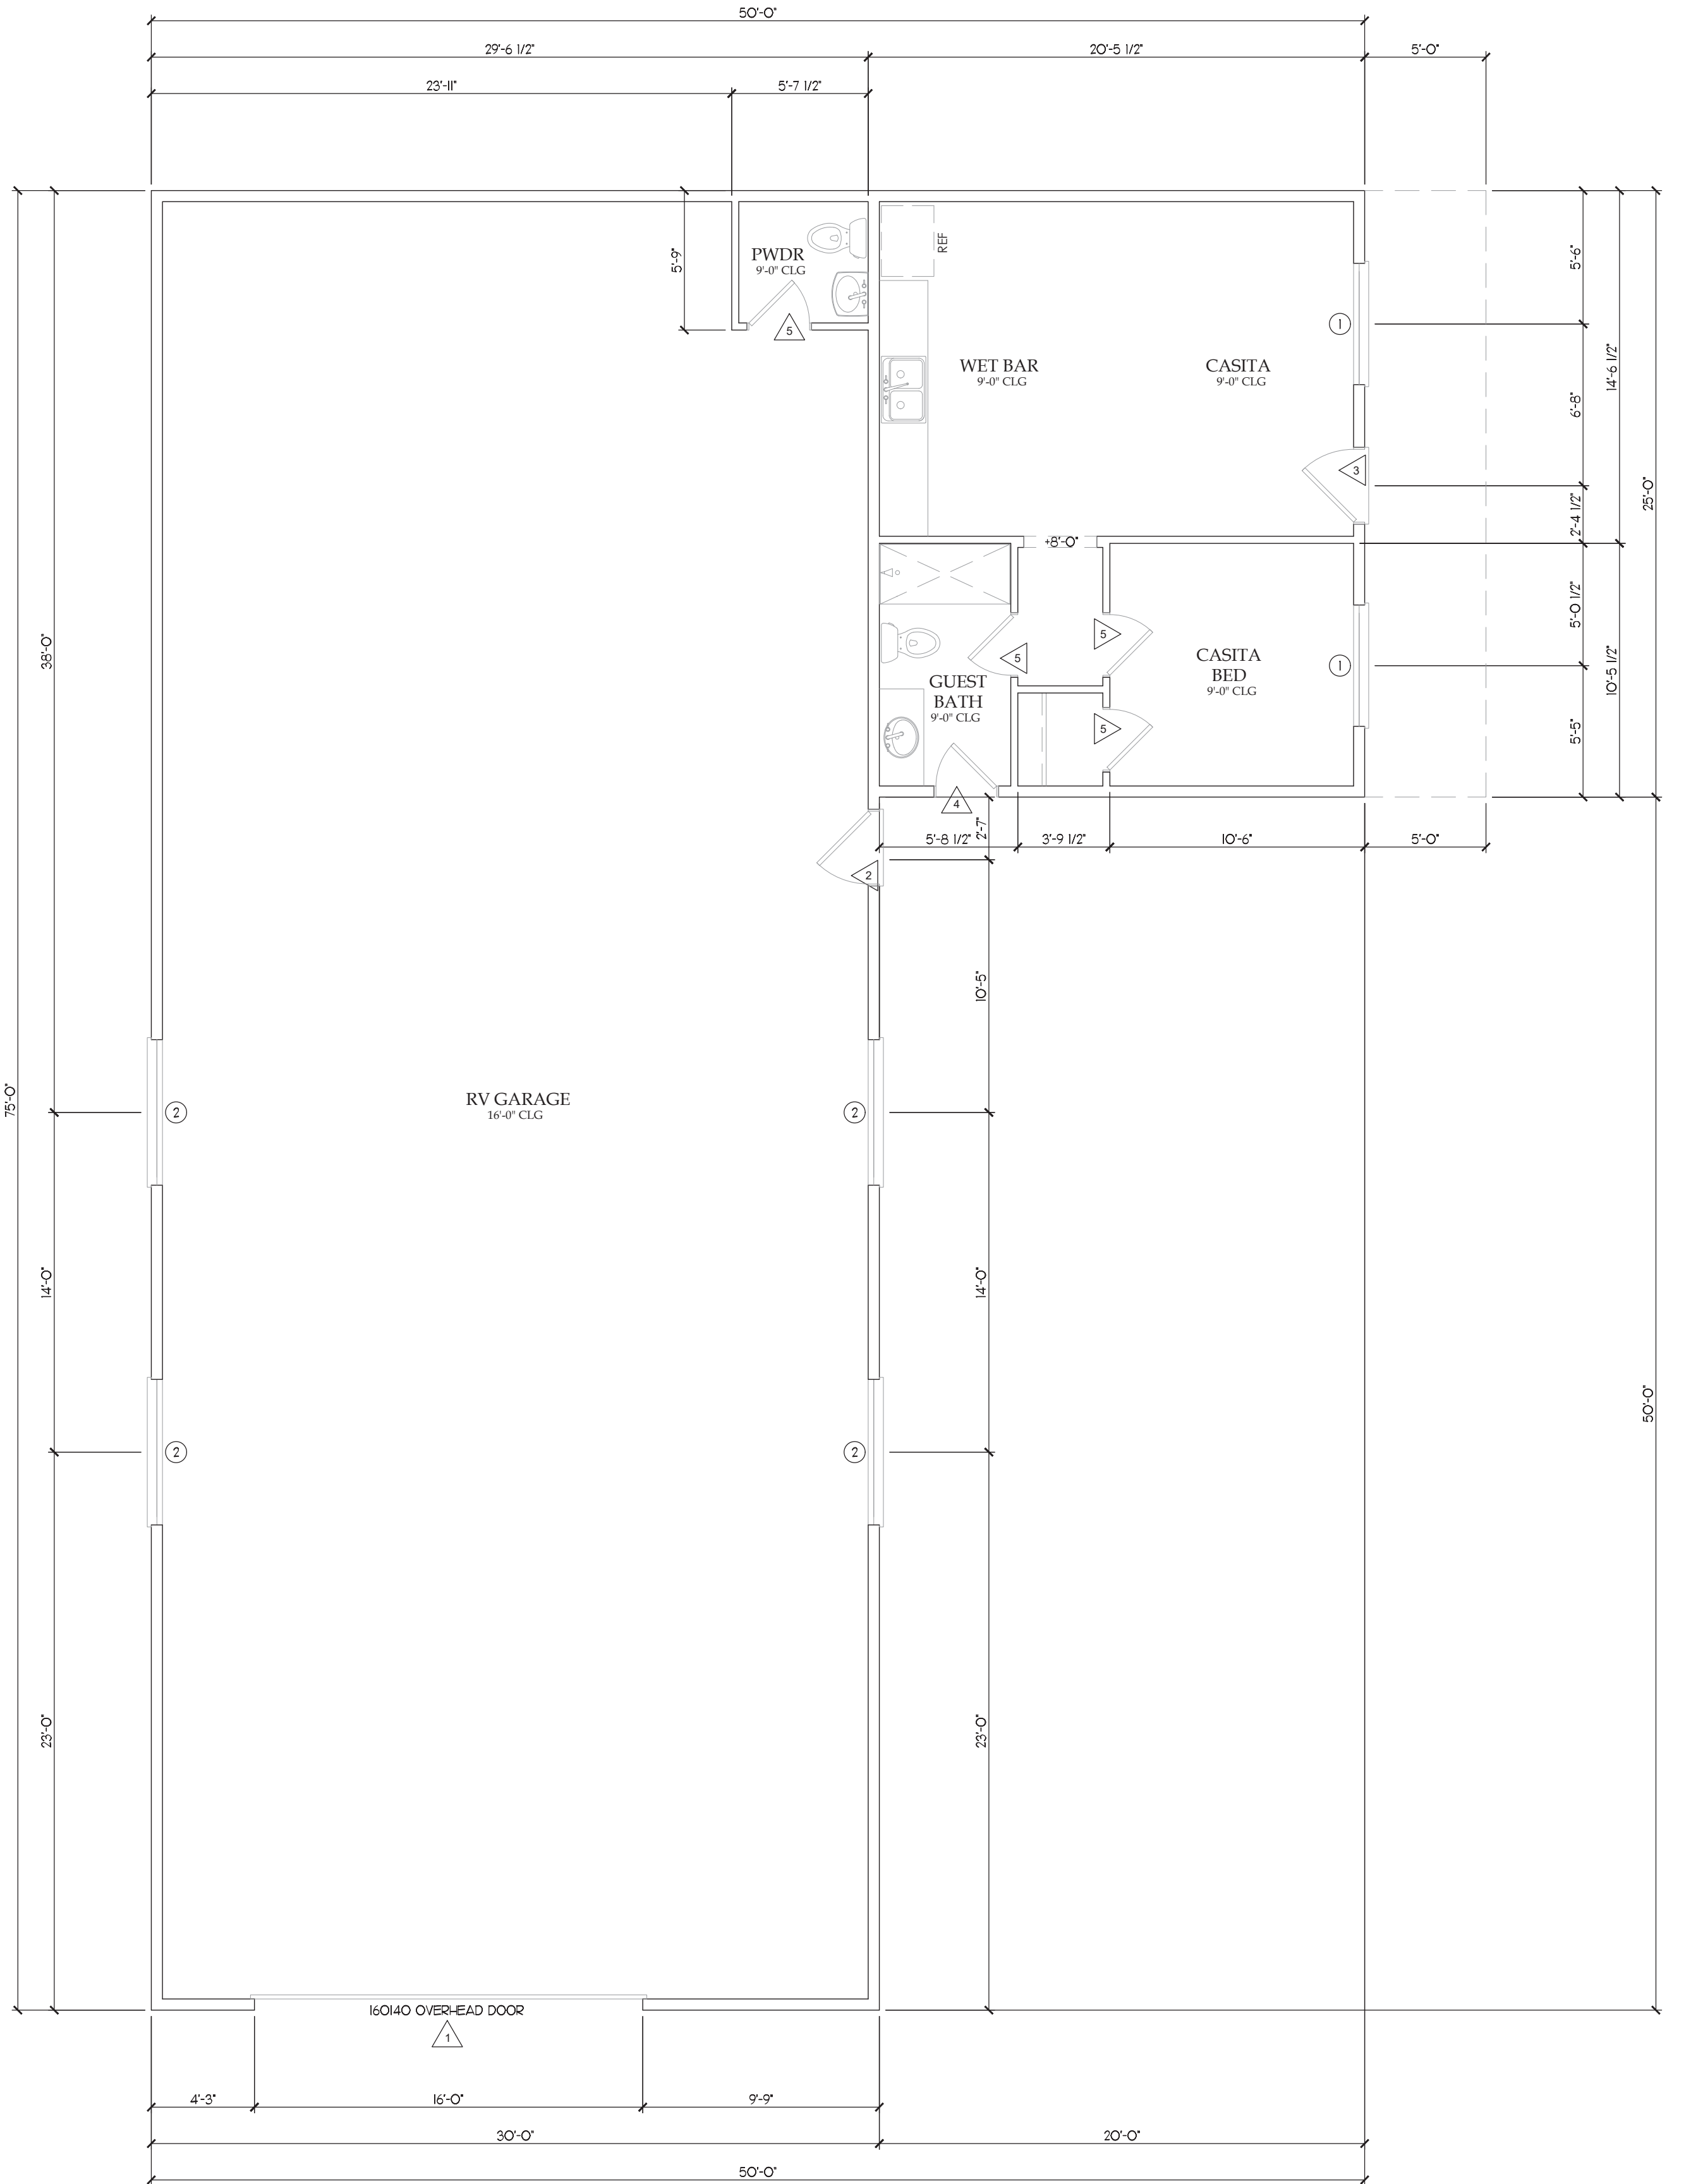

FLOOR PLAN

SCALE: 1/4" = 1'-0"

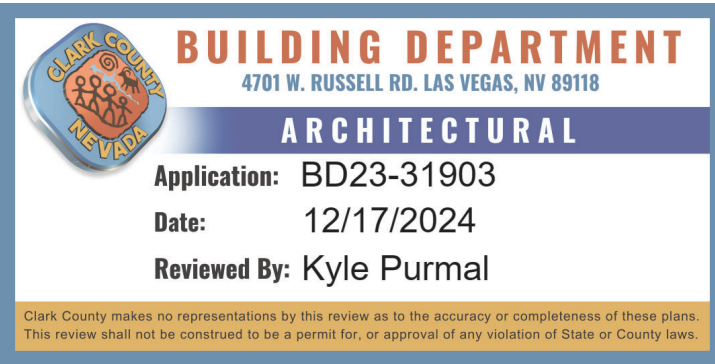

BD23-31904

SEPARATE PERMIT APPROVAL IS REQUIRED  
FOR WALLS, FENCES, POOLS, SPAS, SIGNS  
AND ACCESSORY STRUCTURES.




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APPROVAL OF ANY OTHER EXISTING OR PROPOSED  
STRUCTURES OR USES. SEPARATE PERMITS AND  
POSSIBLE LAND USE MAY BE REQUIRED.

REV.	DATE	BY:	REVISION:
1	7.5.24	EDM	REV per Planscheck
1	12.10.24	EDM	REV per Planscheck



**CASITA FLOOR PLAN**  
**SINGLE FAMILY CUSTOM HOME**  
APN 176-15-401-042

DESIGNED BY: EDM
DRAWN BY: EDM
CHECKED BY:
DATE ISSUED:
JOB NUMBER: 028-022
SCALE: 1/4" = 1'-0"

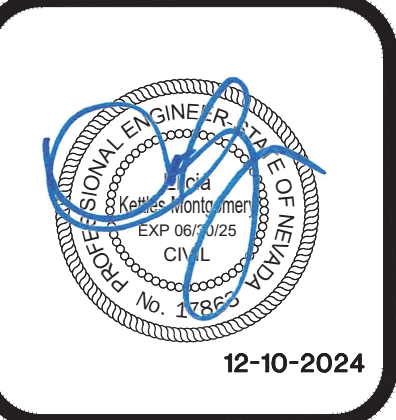

SHEET NUMBER  
**A-3.1**