

NEW AUTOMATED CARWASH FACILITY "GRAND WASH"


ALMAVILLE ROAD & GENERAL F SMYRNA, TN PERMIT SET - NOT FOR CONSTR

FORREST


◬	06.02.23	ISSUED FOR PERMIT REV
	04.11.23	ISSUED FOR PERMIT
$\overline{\Lambda}$	01.04.23	ZONING SUBMITTAL
	12.05.22	ZONING SUBMITTAL
		REVISIONS
DRA	AWN BY:	RAM
API	PROVED BY	: GCN / MAM
SCA	ALE:	AS NOTED
DES	CRIPTION:	SITE PLAN

M-2.0

SHEET NO.

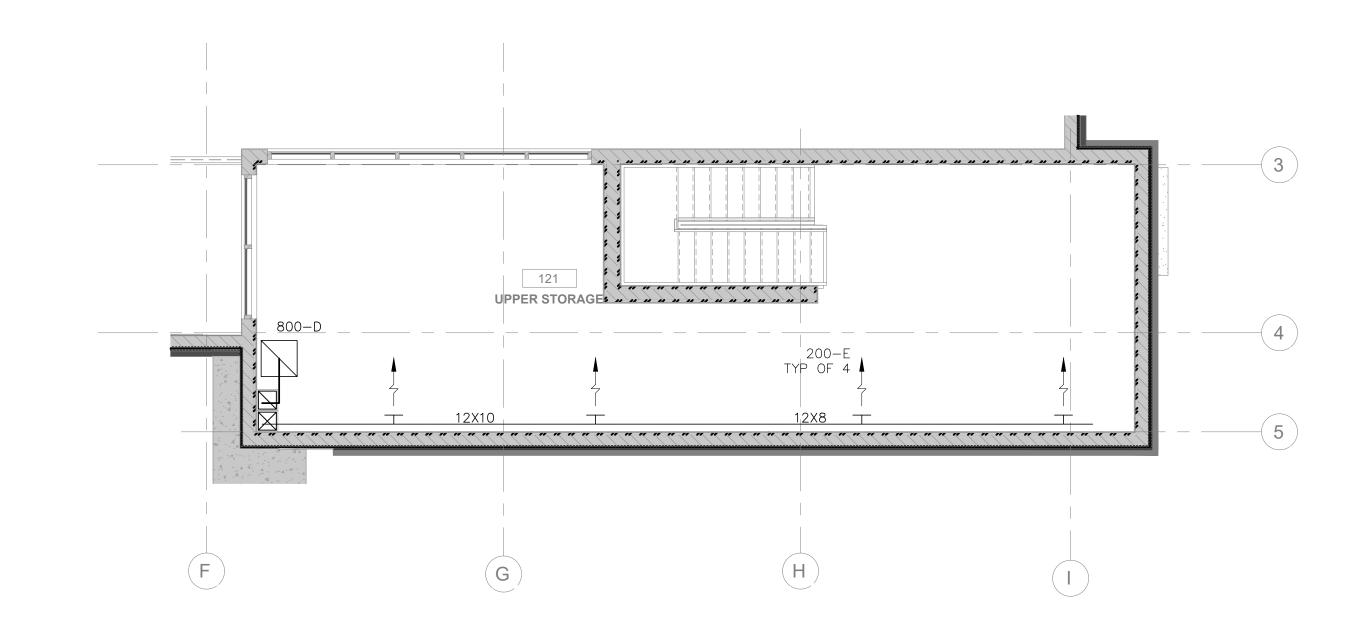



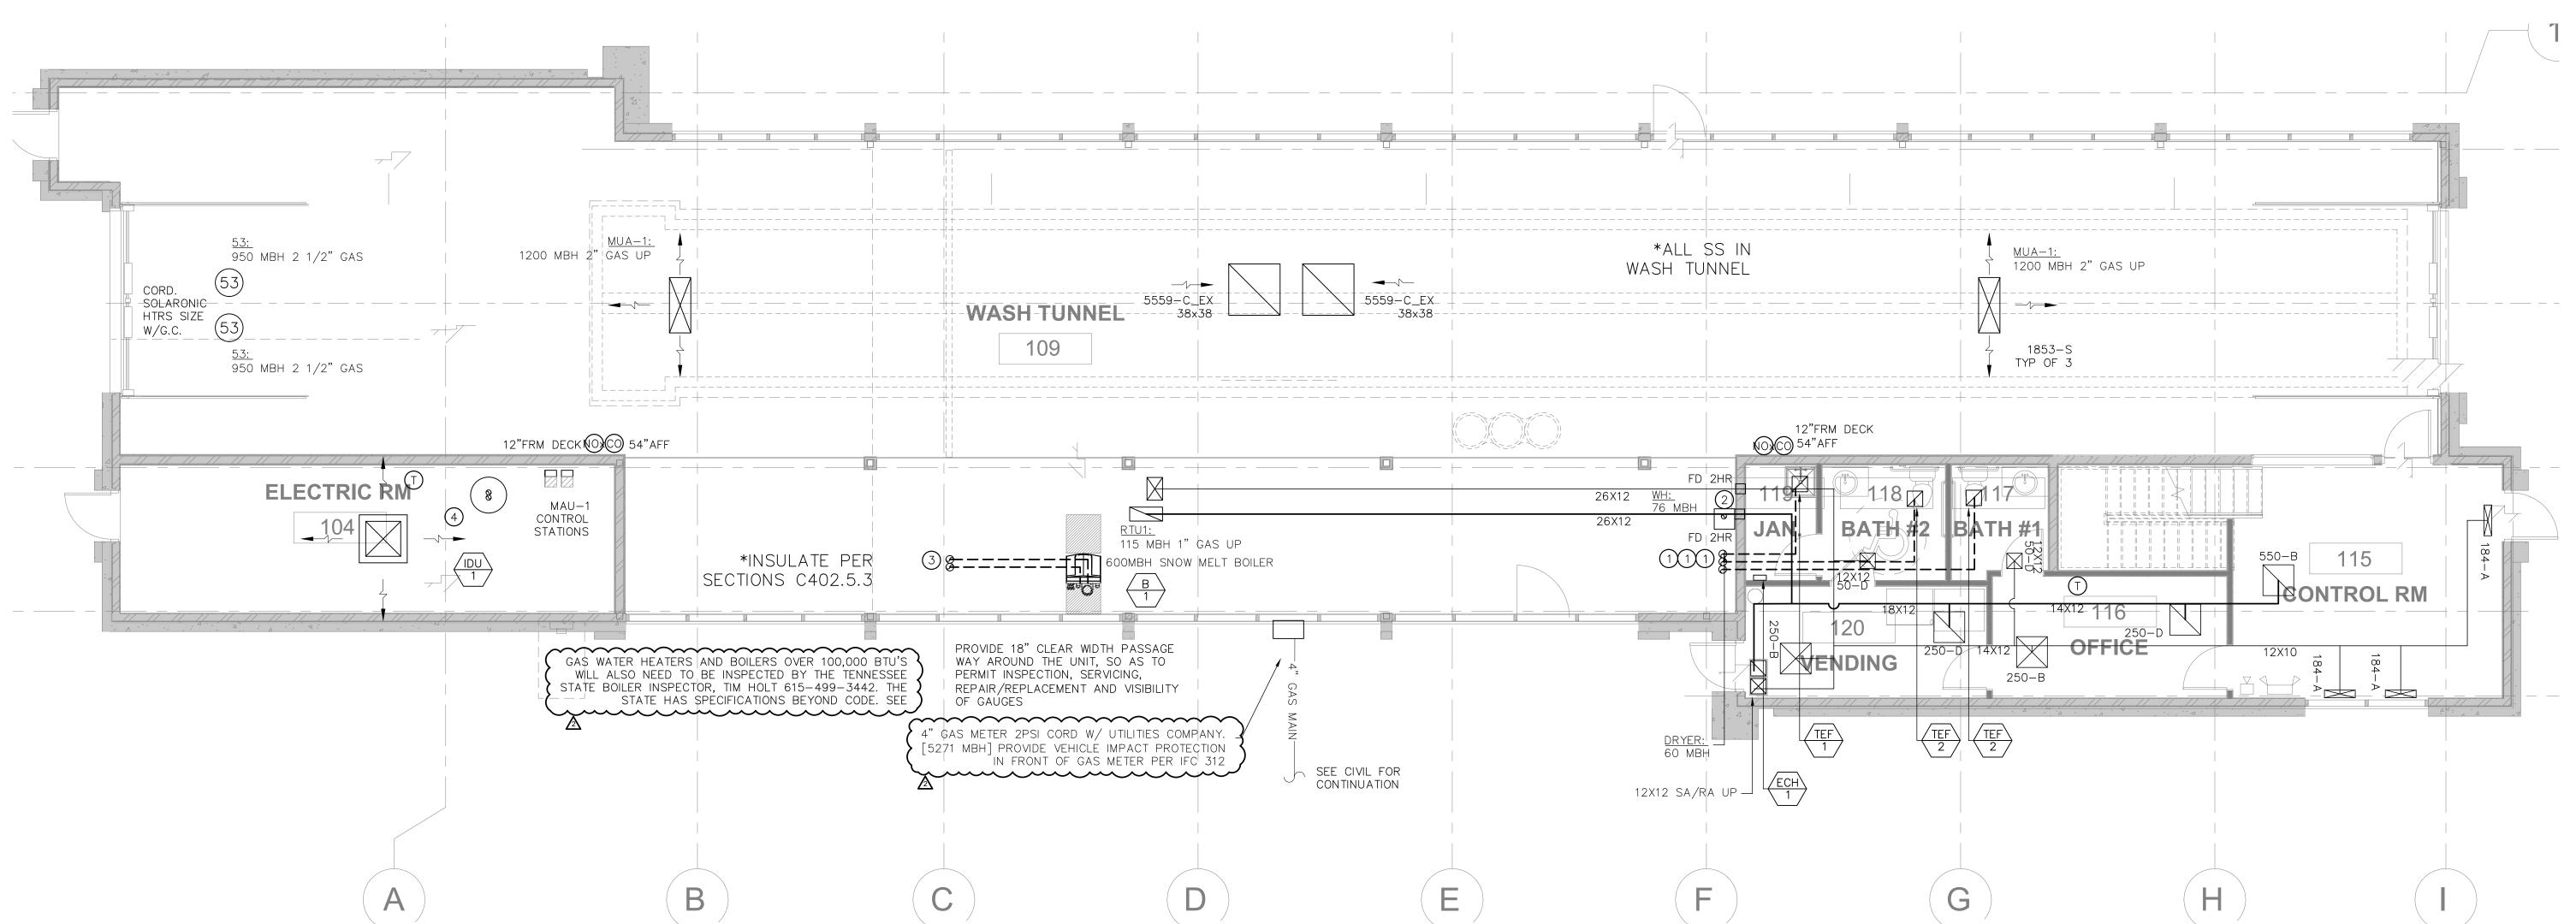


MECHANICAL NOTES:

- 1) 6"ø TE/EX UP THRU ROOF
- 2 4"ø DRYER VENT PER FBC M504
- (2) 4"ø PVC/CAI FROM BOILER
- 4 (2) 3"ø PVC/CAI FROM WATER HTR DIRECT VENT TE OR PVC/CAI TERMINATE THRU WALL PROVIDE WALL CAP & BIRD SCREEN.

FIRE/SMOKE DAMPER NOTES:

FIRE/SMOKE DAMPERS SHALL BE PROVIDED WITH AN APPROVED MEANS OF ACCESS, LARGE ENOUGH TO PERMIT INSPECTIONS AND MAINTENANCE OF THE DAMPER AND ITS OPERATING PARTS. ACCESS POINTS SHALL BE PERMANENTLY IDENTIFIED ON THE EXTERIOR BY A LABEL HAVING LETTERS NOT LESS THAN HALF INCH (0.5") READING "SMOKE DAMPER" OR "FIRE DAMPER" SMOKE DAMPERS SHALL CLOSE UPON ACTUATION OF A LISTED SMOKE DETECTOR OR DETECTORS INSTALLED IN ACCORDANCE WITH SECTION 907.3 OF THE INTERNATIONAL BUILDING CODE.



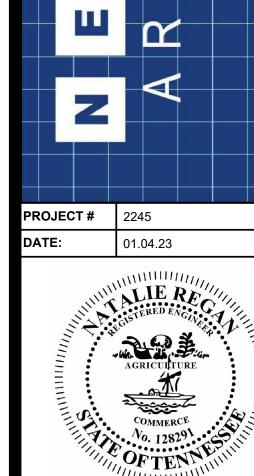

NEW AU"GRAND


PERMIT ⚠ 06.02.23 ISSUED FOR PERMIT REV ISSUED FOR PERMIT 1 01.04.23 ZONING SUBMITTAL **ZONING SUBMITTAL REVISIONS** APPROVED BY: GCN / MAM SCALE: AS NOTED

DESCRIPTION: FLOOR & UPPER

SHEET NO.


STORAGE PLAN

M-2.1

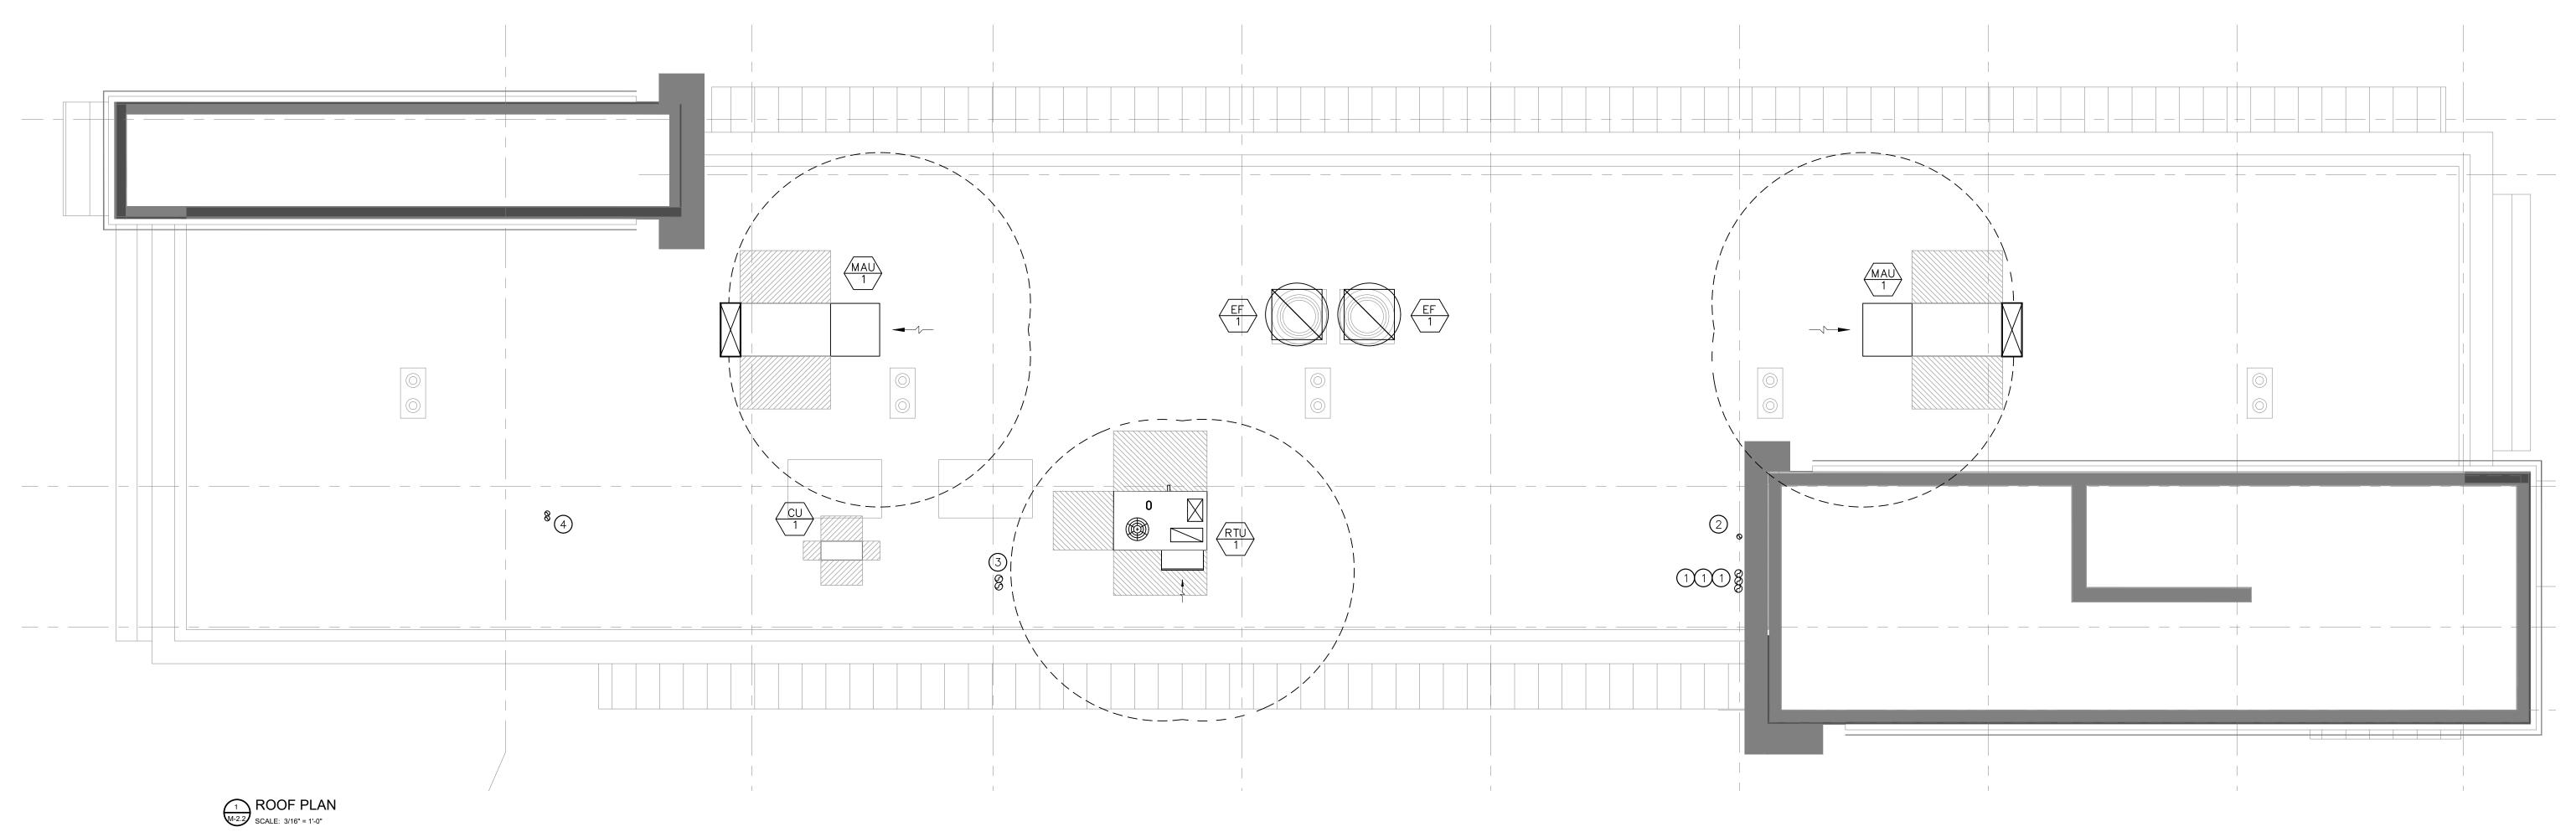

MECHANICAL NOTES:

- 1) 6"ø TE/EX UP THRU ROOF
- 2) 4"ø DRYER VENT PER FBC M504
- (2) 4"ø PVC/CAI FROM BOILER (2) 3"ø PVC/CAI FROM WATER HTR DIRECT VENT TE OR PVC/CAI TERMINATE THRU WALL PROVIDE WALL CAP & BIRD SCREEN.

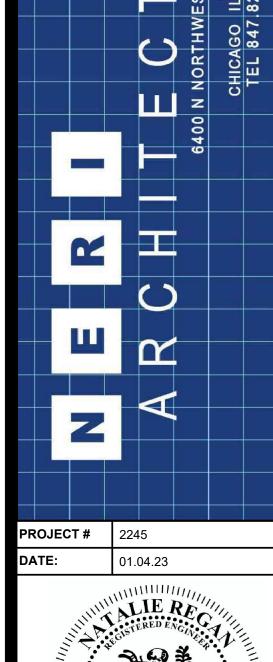

PERMIT △ 06.02.23 ISSUED FOR PERMIT REV 04.11.23 ISSUED FOR PERMIT 101.04.23 ZONING SUBMITTAL 12.05.22 ZONING SUBMITTAL **REVISIONS** DRAWN BY: RAM APPROVED BY: GCN / MAM AS NOTED DESCRIPTION: ROOF PLAN

M-2.2

SHEET NO.

*PER ARCH FLOOR PLANS, WOOD GRILLES TO MATCH FLOORS

(2) UNIT MTD. DISCONNECT SW (4) LOW-VOLTAGE CONTACTOR

LOCATION

ROOF

LOCATION

ROOF

MANUFACTURER &

MODEL No.

LOCHINVAR FTX600

RTU-

TAG

MAU-1

TAG

SUPPLY AIR DATA

ESP

0.5

Ο.Α.

200

TESP

0.3

TYPE

CONDENSING

SUPPLY AIR DATA

5559

BHP

1.11

HEATING COIL DATA

INP/OUT [MBH]

DISCHARGE DUCT. ECONOMIZER FAULT DETECTION PER SECTION C403.2.4.7. PROVIDE POWERED CONVENIENCE OUTLET

INLET GAS

PRES. IN.

MISCELLANEOUS EQUIPMENT SCHEDULE

GAS TYPE

NG

TITUS JSAL

D SUPPLY

SURF MTD | OBD

**PROVIDE HEAVY DUTY CORE IN ALL FLOOR APLICATIONS, CORDINATE LOCATIONS OF ALL DIFFUSERS, REGISTERS, GRILLES AND LOUVERS WITH ARCH PRIOR TO INSTALL

BWE 12X6 MODULE

	EXHAUST FAN SCHEDULE											
UNIT	MODEL	AREA SERVED	CFM	S.P. IN W.G.	FPM	FAN RPM	DRIVE	MOTOR				REMARKS
No.								HP	RPM	VOLT	PHASE	
TEF-1	Panasonic FV-05-11VK1	TOILET RMS	80	0.10	_	659	DD	16.1W	1205	120	1	NOTE 1
TEF-2A,2	₿anasonic FV-11-15VK1	Toilet RMS	130,150	0.5	_	832	DD	21.7W	904	120	1	NOTE 1
EF-1	Greenheck CUBE300	TUNNEL	5559	0.2	_	402	BD	0.5HP	402	460	3	NOTE 2

NOTE 1: WALL SW, ROOF CAP, INSULATED DAMPER & PROVIDE FABRIC FLEX CONNECTION FOR THERMAL BREAK AT EXTERIOR PENETRATION, WIRED TO TIMER NOTE 2: BDD, BIRDSCREEN, DS, ROOFCURB, SPEED CONTROL, VIBRATION ISOLATION, NOTE 2: ISOLATORS, MBD, TIED TO CO, DS, WALL CAP/LOUVER

CABINET/UNIT HEATER SCHEDULE											
LFV — LOUVER FIN (VERTICAL) H — HORIZONTAL TYPE FG — FAN GUARD LFH — LOUVER FIN (HORIZONTAL) P — PROTECTION TYPE LCD — LOUVER CONE DIFFUSER											
UNIT No.	UNIT DESCRIPTION	LOCATION	HP	RPM	MOTOR VOLT	PHASE	TOTAL KW	FINAL AIR TEMP.			
ECH-1	MARKEL F3422	VARIES	9.6A	1400	208	1	2.0	_	245	1 2 4	
ECH-2	MARKEL UH Series	VARIES	9.1	_	480	3	5	_	400	1 2 4 WALL BRACKET	
ECH-3	BROAN 124	VARIES	12.5A	_	120	1	1.5	_	_	1 2 4 *, PROVIDE RECESSED HOUSING, LOW	
(1) UNIT I	MTD. THERMOSTAT. (3) 4-WIRE SERV	/ICE					МС	FS-MIN.	CIRCUIT FUSE SIZE	

UNIT HEATERS SHALL BE INSTALLED IN ACCORDANCE WITH THE LISTING AND THE MANUFACTURER'S INSTALLATION INSTRUCTIONS. SUSPENDED TYPE HEATERS SHALL BE SUPPORTED BY ELEMENTS TAHT ARE DESIGNED TO ACCOMMODATE THE WEIGHT AND DYNAMIC LOADS. HANGERS AND BRACKETS SHALL BE OF NON-COMBUSTIBLE MATERIAL. IMC 2012 SECTION 920

POWER EX. DATA

ESP

0.25

TEMPERATURE

RISE [°F]|INLET [°F]

CAPACITY

CONDENSATE NEUTRALIZATION KIT, SMART SYSTEM CONTROL PACKAGE. BOILER RECIRCULATING PUMP PROVIDED BY MANUFACTURER. (4"0 PVC CAI & EA)

FROM ELEĆTRICAL PANEL, PROVIDE WIND BAFFLES FOR COOLING DOWN TO -40F

-10

95

VFD CONTROLLER, PROVIDE ECONOMIZER IN ACCORDANCE W SECTION C403.3, ECONÓMIZER FAULT DETÉCTION PER SECTION C403.2.4.7, PROVIDE POWERED CONVENIENCE OUTLET

CFM

2000

FLA-FULL LOAD AMP

77

*CORD COLOR W/ARCH

EAT/DB | EAT/WB | LAT/DB | LAT/WB |

MAKEUP AIR UNIT SCHEDULE

GAS. DATA

SUPPLY PRESSURE INLET

2PSI

OPER.

NOTE 1: RAINHOOD WITH INTEGRAL INLET BIRD SCREEN, TWO POSITION MOTORIZED DISCHARGE DAMPER, INSULATED DOWNTURN WITH TURNING VANES, DIRECTIONAL ELBOWS — QUANTITY 3, 24" MOUNTING

CURB WITH COUNTERFLASHING, 12" MOUNTING RAIL, 12" ADJUSTABLE MOUNTING STANDS, CAMBRIDGE ENGINEERING STAINLESS STEEL BURNER, HIGH PRESSURE REGULATOR PROVIDED (MUST BE VENTED 15' FROM INTAKE), EDL GAS CONTROLS, DISCHARGE TEMPERATURE DIAL IN HEATER, •INTEGRAL NON-FUSED DISCONNECT SWITCH, PREMIUM EFFICIENCY ODP MOTOR WITH ADJUSTABLE SHEAVES, INTEGRAL

NOTE 1: STAINLESS STEEL HEAT EXCHANGER, FLOW SW, LOW WEAR CUTOFF W/ MANUAL RESET AND ST, MODULATING BURNER W 5:1 TURNDOWN, 50PSI RELIEF VALVE, AUTOMATIC RESET LIMIT, LOW Nox OPERATION, LOW GAS PRESSURE OPERATION, OUTDOOR RESET, PUMP RELAY W/ FREEZE PROTECTION, LOW WATER FLOW INDICATION, SIDEWALL VENT TERMINALS, ON/OFF SW, CONTACTS ON ANY FAILURE,

MITSUBISHI MINI SPLIT PLA-A36EA7, PUY-A36NKA7, DS, COOLING ONLY UNIT, 208/230V, 1PH, 2MCA (INDOOR), 25/31 MCA/MOCP

(OUTDOOR) WIRED PROGRAMMABLE TSTAT, CORD CONDENSATE WITH PLUMBER. IOSLATION HANGERS, OUTDOOR STAND. LOCATE IDU ACROSS

MOTOR STARTER WITH THERMAL OVERLOADS, REMOTE CONTROL STATION INCLUDING: - ELECTRONIC SETBACK THERMOSTAT. DIRECT FIRED ASHRAE 90.1 COMPLIANT. S/S DIRECTIONAL ELBOWS, 50" SS

BOILER SCHEDULE

CAPACITY

| INPUT (MBH) | OUTPUT (MBH) | EFF. (%) |

55.2

1/4NPT

EWT

(°F)

180

LWT

(°F)

160

ROOFTOP UNIT SCHEDULE

58.5

TMBH | SMBH | NOM.CAP. TON

47.2

ELECTRICAL DATA

RATE (GPM)

VOLT

MAX FLOW MAX P.D. MAX WORKING

PRES. (PSI)

(FT.)

THE EQUIPMENT SHALL BE INSTALLED IN ACCORDANCE WITH THE MANUFACTURER'S INSTALLATION INSTRUCTIONS. THESE INSTRUCTIONS SHALL BE ON-SITE AND AVAILABLE FOR ALL INSPECTIONS.

COOLING COIL DATA

53.5

GENERAL MECHANICAL NOTES:

DUCTWORK.

NECK SIZE

(1) DIFFUSER SHALL BE LAY-IN CEILING TYPE.

COORDINATE WITH DIFFUSER SCHEDULE.

SQUARE | ROUND | PRESSURE |

TOTAL

0.04

0.04

0.04

0.04

0.04

0.04

HEATING COIL DATA

INP/OUT [MBH]

115/93

MODEL

120

1035 CAMBRIDGE S1200 SEE NOTES 1

REMARKS

- ALL WORK SHALL BE FURNISHED AND INSTALLED IN ACCORDANCE WITH BUILDING STANDARDS AND ALL APPLICABLE CODES.
- MEDIUM/LOW PRESSURE DUCTWORK SHALL BE CONSTRUCTED IN ACCORDANCE WITH THE LATEST SMACNA STANDARDS.
- PROVIDE MANUAL DAMPER ON ALL LOW PRESSURE SUPPLY BRANCH TAKE-OFFOF
- ALL DUCT SIZES SHOWN SHALL BE CLEAR INSIDE DIMENSIONS.
- DIFFUSERS, REGISTERS ARE AS SCHEDULED IN THE DRAWING. CONTRACTOR TO VERIFY AND COORDINATE WITH ARCHITECT TYPE OF CEILING TO DETERMINE FRAME TYPE.
- BLANK-OFF WITH BLACK PAINTED PANEL WHERE SHOWN. DO NOT PAINT EXPOSED DUCTS
- OR REGISTERS. 7. PROVIDE UL APPROVED FIRE DAMPERS. PROVIDE UL APPROVED FIRE DAMPERS IN ALL
- 8. FLEXIBLE DUCTWORK: NOT TO BE USED
- 10. PROVIDE LINNING ON ALL SUPPLY AND RETURN AIR DUCTWORK AT A MIN. OF 15'-0" FROM THE HEAT PUMPS/FURNACES.
- 11. INSULATE ALL DUCTWORK LOCATED IN UNCONDITIONED SPACES. PER IECC C403.2.9

DUCT PENETRATIONS THRU FIRERATED ASSEMBLIES WHETHER INDICATED OR NOT.

12. ALL LONGITUDINAL AND TRANSVERSE JOINTS. SEAMS AND CONNECTIONS IN METALLIC AND NONMETALLIC DUCTS SHALL BE CONSTRUCTED AS SPECIFIED IN SMACNA HVAC DUCT CONSTRUCTION STANDARDS——METAL AND FLEXIBLE AND NAIMA FIBROUS GLASS DUCT CONSTRUCTION STANDARDS. ALL JOINTS, LONGITUDINAL AND TRANSVERSE SEAMS AND CONNECTIONS IN DUCTWORK SHALL BE SECURELY FASTENED AND SEALED WITH WELDS, GASKETS, MASTICS (ADHESIVES), MASTIC-PLUS-EMBEDDED-FABRIC SYSTEMS, LIQUID SEALANTS OR TAPES. CLOSURE SYSTEMS USED TO SEAL DUCTWORK LISTED AND LABELED IN ACCORDANCE WITH UL 181A SHALL BE MARKED "181A-P" FOR PRESSURE-SENSITIVE TAPE, "181 A-M"FOR MASTIC OR "181 A-H"FOR HEAT-SENSITIVE TAPE. CLOSURE SYSTEMS USED TO SEAL FLEXIBLE AIR DUCTS AND FLEXIBLE AIR CONNECTORS SHALL COMPLY WITH UL 181B AND SHALL BE MARKED "181B-FX"FOR PRESSURE-SENSITIVE TAPE OR "181B-M" FOR MASTIC. DUCT CONNECTIONS TO FLANGES OF AIR DISTRIBUTION SYSTEM EQUIPMENT SHALL BE SEALED AND MECHANICALLY FASTENED. MECHANICAL FASTENERS FOR USE WITH FLEXIBLE NONMETALLIC AIR DUCTS SHALL COMPLY WITH UL 181B AND SHALL BE MARKED "181B-C."CLOSURE SYSTEMS USED TO SEAL METAL DUCTWORK SHALL BE INSTALLED IN ACCORDANCE WITH THE MANUFACTURER'S INSTALLATION INSTRUCTIONS. UNLISTED DUCT

EXCEPTION: CONTINUOUSLY WELDED AND LOCKING-TYPE LONGITUDINAL JOINTS AND SEAMS IN DUCTS OPERATING AT STATIC PRESSURES LESS THAN 2 INCHES OF WATER COLUMN (500 PA) PRESSURE CLASSIFICATION SHALL NOT REQUIRE ADDITIONAL CLOSURE SYSTEMS.

- 13. DUCTS SHALL BE SUPPORTED AT INTERVALS NOT TO EXCEED 10 FEET AND SHALL BE IN ACCORDANCE WITH SMACNA HVAC DUCT CONSTRUCTION STANDARDS-METAL AND FLEXIBLE. FLEXIBLE AND OTHER FACTORY-MADE DUCTS SHALL BE SUPPORTED IN ACCORDANCE WITH THE MANUFACTURER'S INSTRUCTIONS.
- 14. ALL EQUIPMENT AND APPLIANCES, INCLUDING THE AIR CONDITIONER, WATER HEATER AND FURNACE, SHALL BE INSTALLED IN ACCORDANCE WITH THEIR LISTINGS AND THE MANUFACTURER'S INSTALLATION INSTRUCTIONS. A COPY OF THE MANUFACTURER'S INSTALLATION INSTRUCTIONS MUST BE PROVIDED ON SITE AT THE TIME OF INSPECTION.
- 15. ALL SYSTEMS >4.5 TONS REQUIRE ECONOMIZER FAULT DETECTION AND DIAGNOSIS. PER
- 16. INSULATE ALL PIPING PER TABLE IECC C403.2.1

Gas Piping/Tubing Material Matrix(Based on IFGC 403)

N.G. DISTRIBUTION PIPING SHALL BE SCHEDULE 40 STEEL PIPE MEETING THE

Note: The gas piping design shall conform to all the requirements of IFGC 403.

REQUIREMENTS OF ASTM A 53/A 53M WITH 150# MALLEABLE IRON FITTINGS. GAS

PIPING LARGER THAN 3" OR MORE THAN 5 PSIG TO BE WELDED TO BE SCHEDULE 40

Permitted

Standards to Follow

ASME B 36.10.10M or ASTM A35 or ASTM A106

ASME B 36.10.10M or ASTM A35 or ASTM A106

IECC C403.2.4.7

ELECTRICAL DATA

VOLT

208

MOCP

45

30

REMARKS

AMPS

REMARKS

Permitted

r better

Schedule 40

<12 | SEE NOTE1

Wrought-Iron |Schedule 40

TAPE IS NOT PERMITTED AS A SEALANT ON ANY DUCT.

17. SYSTEM ADJUST AND BALANCE PROVIDE TEST AND BALANCE REPORT PER IECC C408.2.5.3. PROVIDE REPORT TO THE MUNICIPALITY PRIOR TO THE FINAL INSPECTION FOR THEIR FILE. ALSO PROVIDE TO THE FIELD INSPECTOR AT TIME OF FINAL INSPECTION.

REMARKS

PERMIT NOTES:

- 1. EQUIPMENT NOISE LEVEL NOT TO EXCEED 55 DB AT THE LOT LINE.
- 2. ALL EXPANSION VALVES, DEVICES AND CONNECTIONS SHALL BE REMOVED FROM THE AIRSTREAM OF ALL MECHANICAL EQUIPMENT AS PER LOCAL CODES.
- 3. THE MECHANICAL CONTRACTOR SHALL GUARANTEE, AS APPLICABLE. THAT THE PLENUM CHAMBER USED FOR RECIRCULATION OF AIR WILL BE OF TIGHT CONSTRUCTION AND THAT ALL SOURCES OF AIR CONTAMINANTS FROM TRAPS, SOIL STACKS, DOWN SPOUTS, VENTS. EXHAUST DISCHARGES AND OTHER SOURCES WILL BE ENCLOSED SO THAT NO CONTAMINATED AIR WILL BE RECIRCULATED.
- THE MECHANICAL CONTRACTOR SHALL FURNISH AND INSTALL A SAFETY RELIEF VALVE DESIGNED TO RELIEVE AND/OR PREVENT THE BUILDUP OF EXCESSIVE REFRIGERANT PRESSURE WITHIN THE DIRECT EXPANSION SYSTEMS. THE PRESSURE RELIEF DEVICE SHALL BE SET AT 400 PSI AND SHALL BE INSTALLED ON THE HIGH PRESSURE SIDE AT THE DISCHARGE OF THE COMPRESSOR AND UPSTREAM OF THE COMPRESSOR SHUTOFF (STOP) VALVE.
- 5. ALL FRESH AIR INTAKE OPENINGS SHALL BE A MINIMUM OF 10'-0" AWAY FROM ANY EXHAUST OR POINT OF CONTAMINATE DISCHARGE.
- 6. ALL DUCTWORK SHALL BE IN ACCORDANCE WITH "SMACNA" LOW VELOCITY DUCT MANUAL AND "ASHRAE" RECOMMENDATIONS.
- 7. THE EQUIPMENT IN THE VENTILATING AND HEATING SYSTEM SHALL BE SUFFICIENT TO MAINTAIN 72 DEGREES F WITHIN THE AREA SERVED AT ALL TIMES WHEN 33-1/3 PERCENT OF CODE REQUIRED AIR IS SUPPLIED FROM OUTDOORS AT -10 DEGREES
- 8. VOLUME DAMPERS OF LOCKING TYPE SHALL BE PLACED IN EACH FORCED WARM AIR RUN.

VENTILATION NOTES:

- 1. CLEARANCES FOR FORCED AIR FURNACES MUST CONFORM TO MANUFACTURERS REQUIREMENTS (OR SHOW CLEARANCES ON THE DRAWINGS).
- 2. ALL DUCTWORK MUST BE GALVANIZED STEEL OR STAINLESS STEEL
- SMOKE DETECTORS AND CARBON MONOXIDE DETECTORS ARE SHOWN ON ELECTRICAL DRAWING(S)
- 4. IF THE PROJECT INCLUDES A PLENUM CEILING OR FLOOR: THE CONTRACTOR SHALL GUARANTEE THAT THE PLENUM CHAMBER USED FOR RECIRCULATION OF AIR WILL BE OF TIGHT CONSTRUCTION AND THAT ALL SOURCES OF AIR CONTAMINATION FROM TRAPS, SOIL STACKS, DOWNSPOUTS, VENTS AND ALL OTHER SOURCES OF CONTAMINATION WILL BE ENCLOSE SUCH THAT NO CONTAMINATED AIR WILL BE RECIRCULATED.

ROJECT#

DATE:

2245

01.04.23

LIE RE

No. 128291

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ALMAVILLE SMYRNA, TN

06.02.23 ISSUED FOR PERMIT REV

REVISIONS

AS NOTED

DESCRIPTION: MECH SCHEDULES

1 01.04.23 ZONING SUBMITTAL

12.05.22

APPROVED BY: GCN / MAM

DRAWN BY:

SHEET NO.

ISSUED FOR PERMIT

ZONING SUBMITTAL

NOTES, & DETAILS


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ERMIT

COMMERCE

GENERAL COORDINATION NOTES:

- EACH TRADE CONTRACTOR SHALL VISIT CONSTRUCTION SITE PRIOR TO BIDDING. EXAMINE SCOPE AND CONDITIONS OF OTHER CONTRACT WORK, EXAMINE EXISTING CONDITIONS AND ALL INTERFERENCES AND REQUIRED COORDINATION IN ORDER TO INCLUDE EFFECT OF SAID CONDITIONS IN THEIR BID. BID DRAWINGS ARE DIAGRAMMATIC AND DO NOT INDICATE ALL REQUIRED RELOCATIONS, OFFSETS, CHANGE IN ASPECT RATIOS, OR ROUTING CHANGES REQUIRED TO INTEGRATE WORK WITH ALL OTHER CONDITIONS OR TRADES. WORK INSTALLED BEFORE COORDINATING SO AS TO CAUSE INTERFERENCES WITH OTHER TRADES SHALL BE REMOVED AND REWORKED WITHOUT COST TO OWNER. COST OF PROVIDING SUCH RELOCATIONS, OFFSETS, SIZE, CHANGES, REROUTING, ETC. SHALL BE INCLUDED IN BID. CODE CONFORMING SCALED (1/4") COORDINATED DRAWINGS SHALL BE PREPARED BY EACH TRADE TO FACILITATE AND VERIFY FIT AND CONGRUENCE OF THEIR INSTALLATION WITH OTHER TRADES.
- WHERE ADDITIONAL DETAILS, DIAGRAMS, EQUIPMENT DATA, AND ISOMETRICS ARE REQUIRED BY BUILDING DEPARTMENT OR CODE AUTHORITIES FOR PERMIT OR APPROVAL, CONTRACTOR SHALL PROVIDE SAME AT NO ADDITIONAL COST.
- 3. BUILDING PLANS SHOWN ARE COMPILED FROM SOURCES BELIEVED TO BE ACCURATE. HOWEVER, THE INFORMATION SHOWN ON THESE PLANS IS SCHEMATIC AND CONTRACTOR SHALL BE RESPONSIBLE FOR ALL PROPER DIMENSIONS, SIZES, SYSTEM VOLTAGES, QUANTITIES AND EXTENT OF WORK.
- THE CONTRACTOR SHALL REFER TO THE ARCHITECTURAL, STRUCTURAL, PLUMBING, FIRE PROTECTION, MECHANICAL AND ELECTRICAL DRAWINGS AND SPECIFICATIONS FOR COORDINATION AND EXTENT OF THE WORK OF THE VARIOUS TRADES AND IMPACT ON THEIR WORK.
- 5. WITH THE APPROVAL OF THE ARCHITECT AND WITHOUT ADDITIONAL COST TO THE OWNER, MAKE MODIFICATIONS IN THE WORK INCLUDING REROUTING AS REQUIRED BY INTERFERENCE WITH STRUCTURAL, GENERAL AND WORK OF OTHER TRADES FOR PROPER EXECUTION OF THE WORK.
- 6. REFER TO THE ARCHITECTURAL DRAWINGS, FIELD CONDITIONS AND DETAILS FOR EXACT LOCATION OF PARTITIONS.
- 7. CUTTING AND PATCHING FOR THEIR WORK SHALL BE PERFORMED BY EACH TRADE CONTRACTOR UNLESS NOTED OTHERWISE.

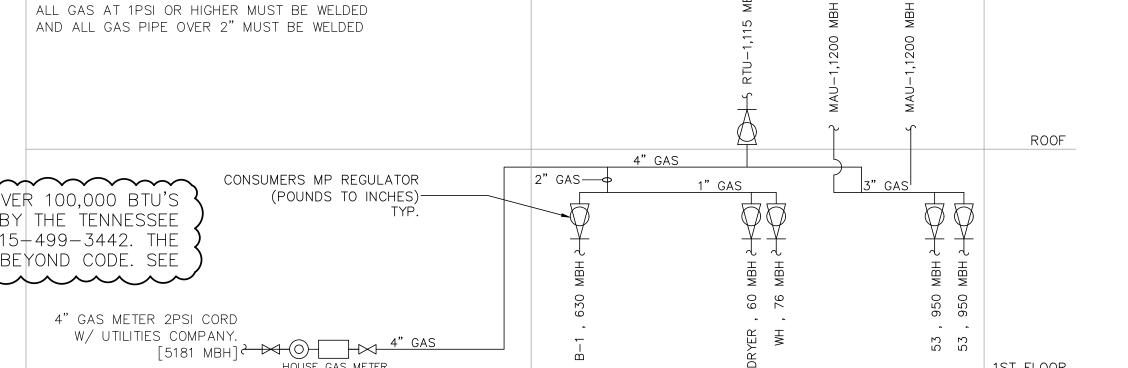

- 1. FUEL GAS PIPING AND CONTROLS MUST CONFORM TO THE INTENTIONAL FUEL GAS CODE(IFGC), CHAPTER 4 (WITH MODIFICATIONS AS NOTED IN ARTICLE 14).
- EXCEED 5 PSIG (SOME EXCEPTIONS ARE NOTED). [IFGC 402.5]
- REQUIREMENTS). [IFGC 403]
- 18 INCHES BELOW GRADE). [IFGC 404.9]
- 7. GAS PIPES MUST BE SLOPED AT 1/4 INCH IN EVERY 15 FEET. [IFGC 408.1]
- VISUALLY AN PRESSURE TESTED. SOAP TESTING IS NOT ACCEPTABLE. MECHANICAL GAUGES USED TO MEASURE TEST PRESSURES, SHALL HAVE A RANGE SUCH THAT THE HIGHEST END OF THE SCALE IS NOT GREATER THAN FIVE (5) TIMES THE TEST PRESSURE. THE TEST SHALL BE WITNESSED BY THE LOCAL INSPECTOR AND REPORT PROVIDÉD.

ALL FUEL GAS PIPING MATERIALS, SIZES AND CONTROLS SHALL CONFORM TO THE NATIONAL FUEL GAS CODE (IFGC).

PAINT ALL GAS PIPING THAT IS EXPOSED TO THE ELEMENTS

METALLIC PIPE OR TUBING EXPOSED TO CORROSIVE ACTIONS, SUCH AS SOIL CONDITION OR MOISTURE, SHALL BE PROTECTED IN AN MANNER. ZINC COATING (GALVANIZING) SHALL NOT BE DEEMED ADEQUATE PROTECTION FOR GAS PIPING UNDERGROUND. WHERE DISSIMILAR MÈTALS ARE JOINED UNDERGROUND, AN INSULATING COUPLING OR FITTING

| Carrier 48TC06 3 SEE NOTES 1 NOTE 1: COOLING CAPACITY AT 95F AMBIENT, ASHRAE 90.1 COMPLIANT, GAS FIRED, FILTER INDICATOR, CO2 CONTROLS, MODULATING CENTRIFUGAL POWER EXHAUST, SS DRAIN PAN, DISCONNECT SWITCH, CONVENIENCE OUTLET. 7-DAY PROGRAMMABLE T-STAT., GAS WATER HEATERS AND BOILERS OVER 100,000 BTU'S WILL ALSO NEED TO BE INSPECTED BY THE TENNESSEE STATE BOILER INSPECTOR, TIM HOLT 615+499-3442. THE STATE HAS SPECIFICATIONS BEYOND CODE. SEE HOUSE GAS METER 1ST FLOOR

Gas Distribution Building

VERIFY ALL ACTUAL LOADS [125FTMAX]

GENERAL GAS PIPING NOTES:


- 2. GAS PIPING MUST BE SIZED IN ACCORDANCE WITH IFGC TABTES 402.(1) THROUGH 402.3(34). [IFGC 402.3]
- 3. THE MAXIMUM DESIGN OPERATING PRESSURE FOR GAS PIPING SYSTEMS LOCATED INSIDE BUILDINGS SHALL NOT
- 4. GAS PIPING MATERIALS MUST CONFORM TO THE GAS PIPING & TUBING MATERIAL MATRIX (IFGC 403
- 5. PIPING IN CONCEALED LOCATIONS MUST CONFORM TO THIS IFGC 404.3. [IFGC 404.3]
- 6. MINIMUM REQUIRED BURIAL DEPTH FOR UNDERGROUND PIPING SYSTEMS MUST CONFORM TO IFGC 404.9. (MINIMUM
- 8. ALL NEW GAS PIPING SHALL BE TESTED IN ACCORDANCE WITH SECTION 406 OF IFGC. THE SYSTEM SHALL PURGED


GAS PIPING GREATER THAN 2" INSIDE DIAMETER OR CARRYING MORE THAN 5 POUNDS(PSIG) SHALL BE SCHEDULE 40 STANDARD WELD

SHALL BE USED. PIPING SHALL NOT BE LAID IN CONTACT WITH CINDERS [IFGC 404.11]



DESCRIPTION | SPECIFICATION

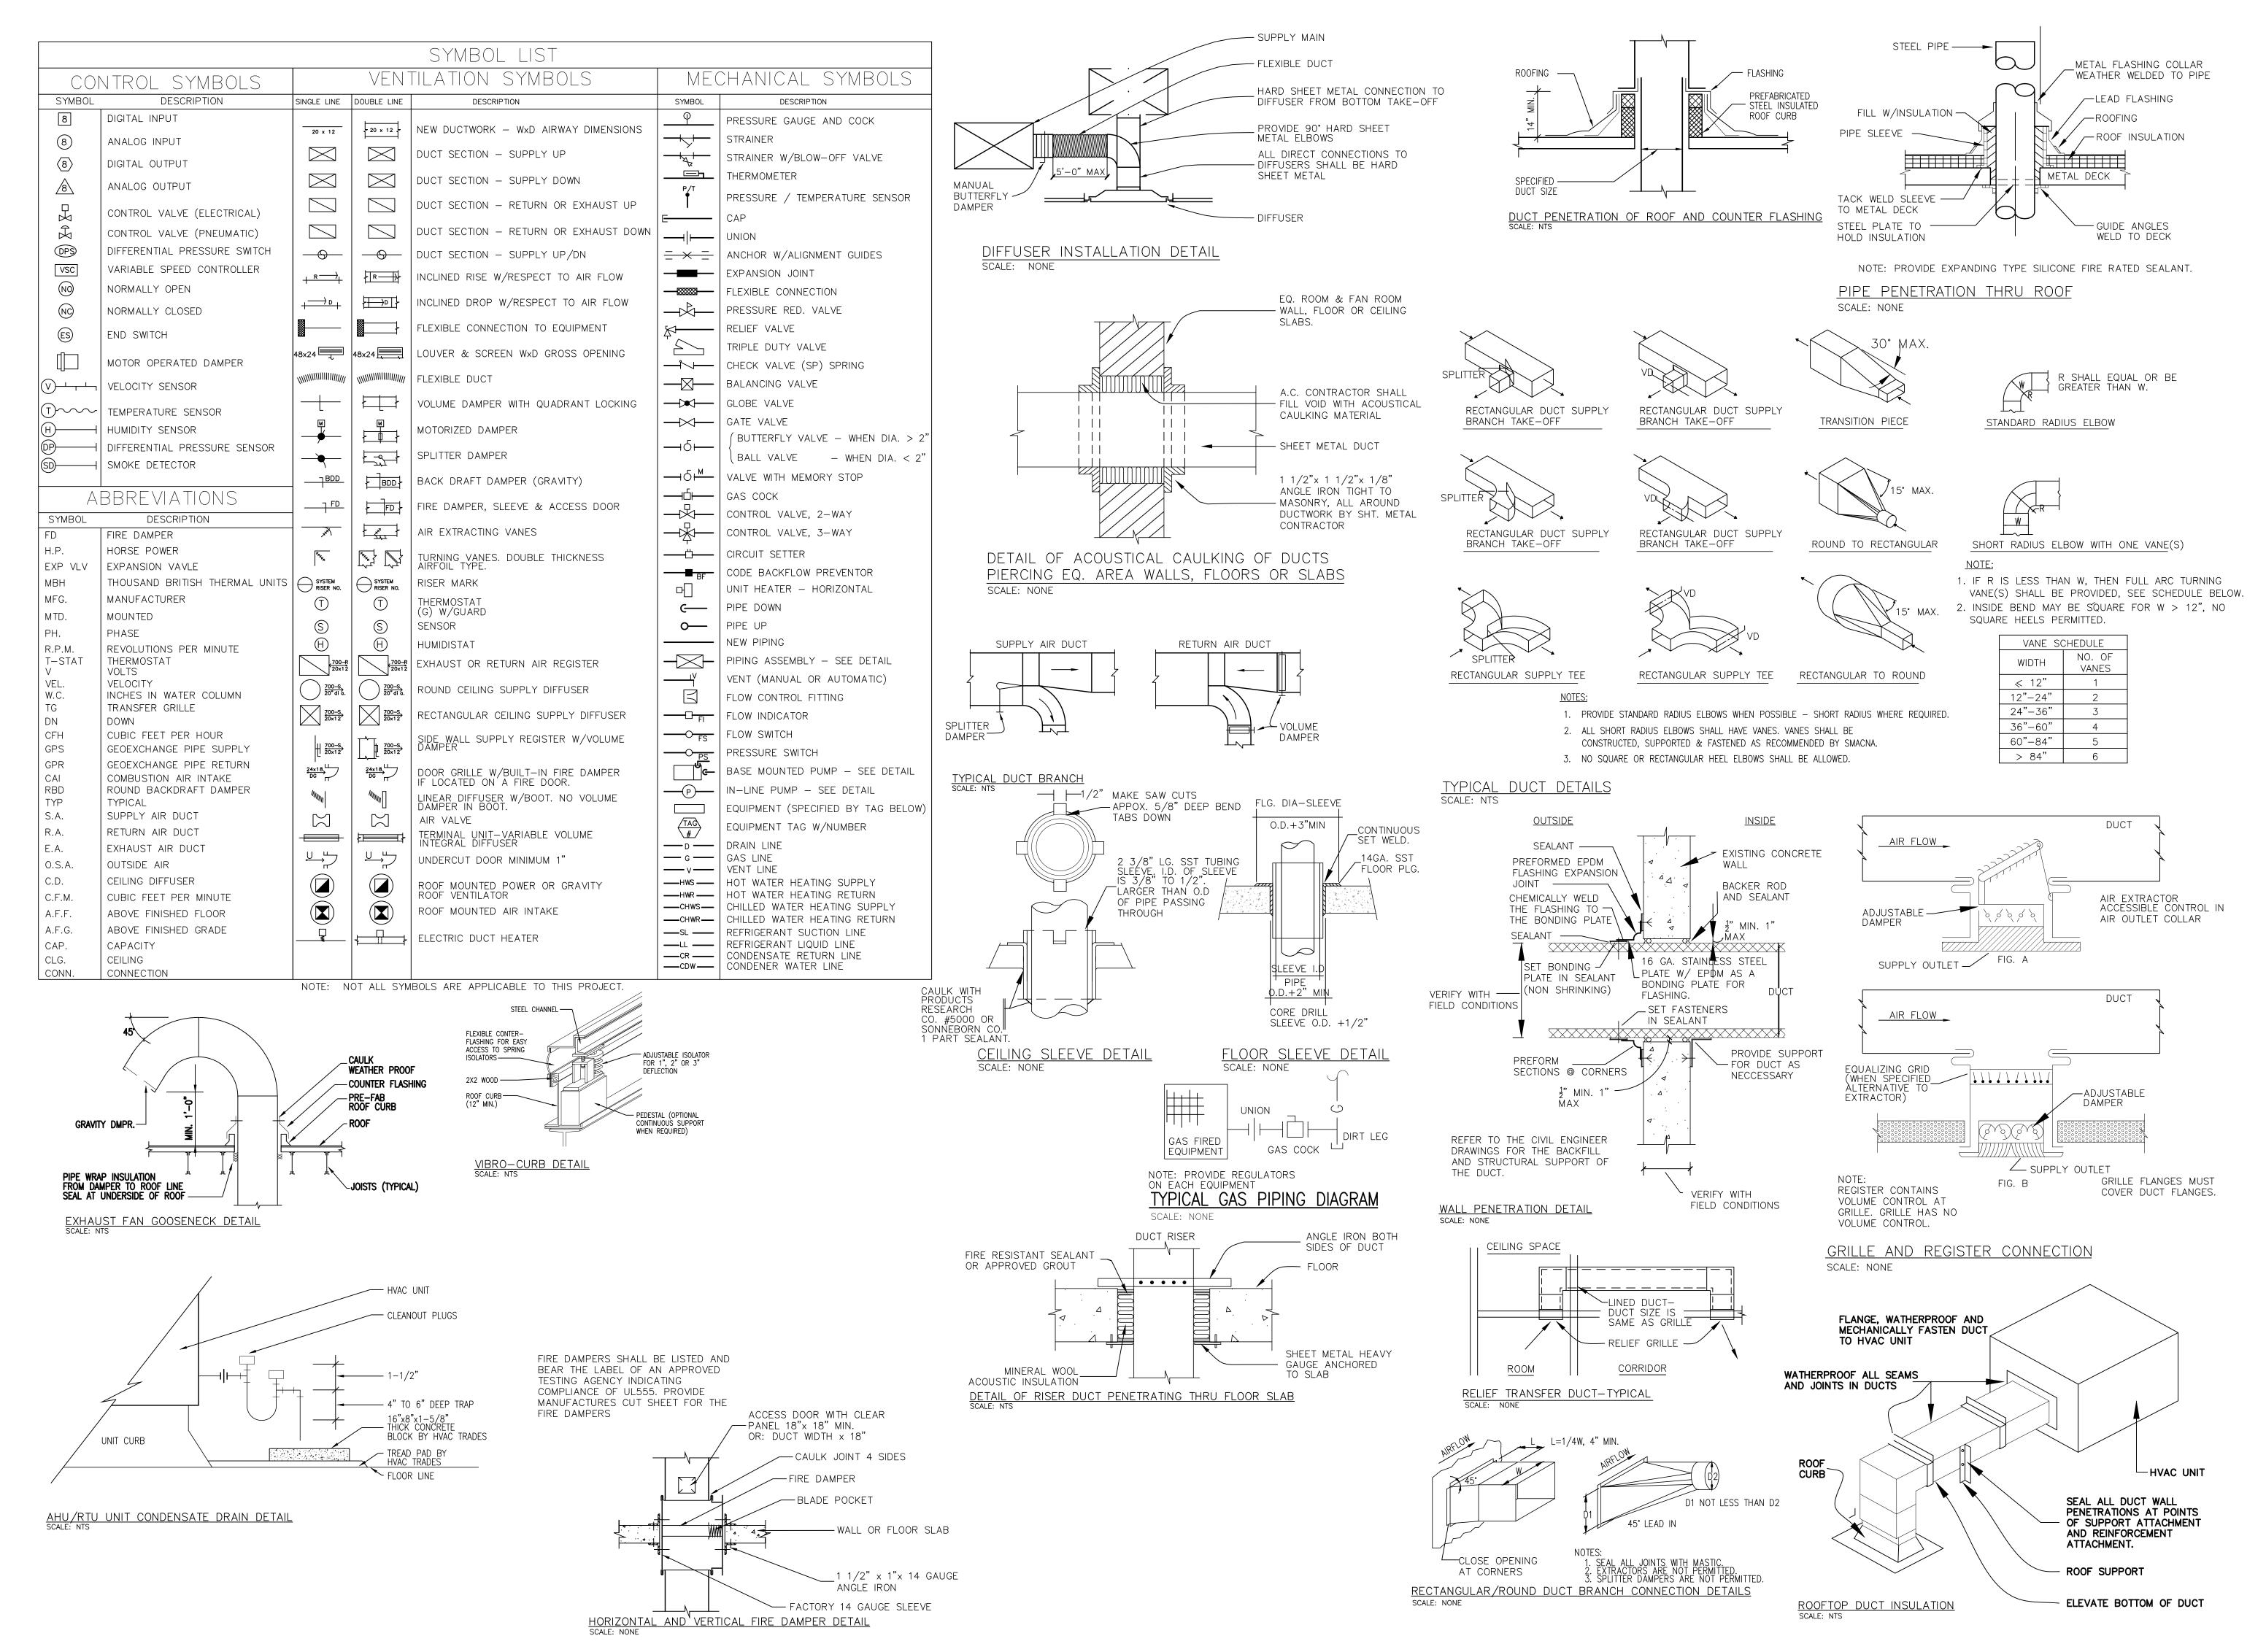

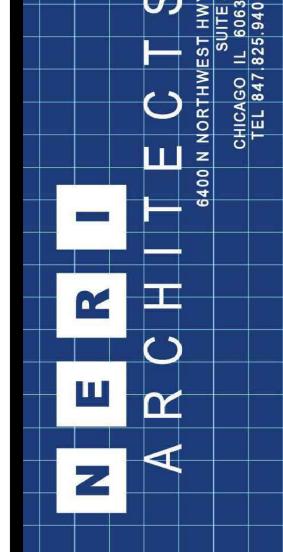

LIE REC COMMERCE

2245

01.04.23

PROJECT #

DATE:

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ALMAVILLE SMYRNA, TN NEW AU" PERMIT

OMAT


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lack		REVISIONS					
DR	AWN BY:	RAM					
API	PROVED BY	:GCN / MAM					
SCALE:		AS NOTED					
DESCRIPTION:		MECH SCHEDULES, NOTES, & DETAILS					
SH	EET NO.	M-3.1					


AIR BALANCE SCHEDULE										
TAG	O.A.	R.A.	S.A.	E.A.	PRESSURE					
RTU-1	250	1750	1750	250	_					
MUA-1	11118	_	_	ı	+11118					
EF-1	_	_	_	-11118	-11118					
TEF	_	_	_	-460	-460					
TOTALS	11368	1750	1750	11828	460					

TOILET EXHAUST FANS DO NOT RUN CONTINUOUSLY, THE BUILDING IS NEUTRAL

S1200 SERIES

ROOF TOP DIMENSIONAL DRAWING

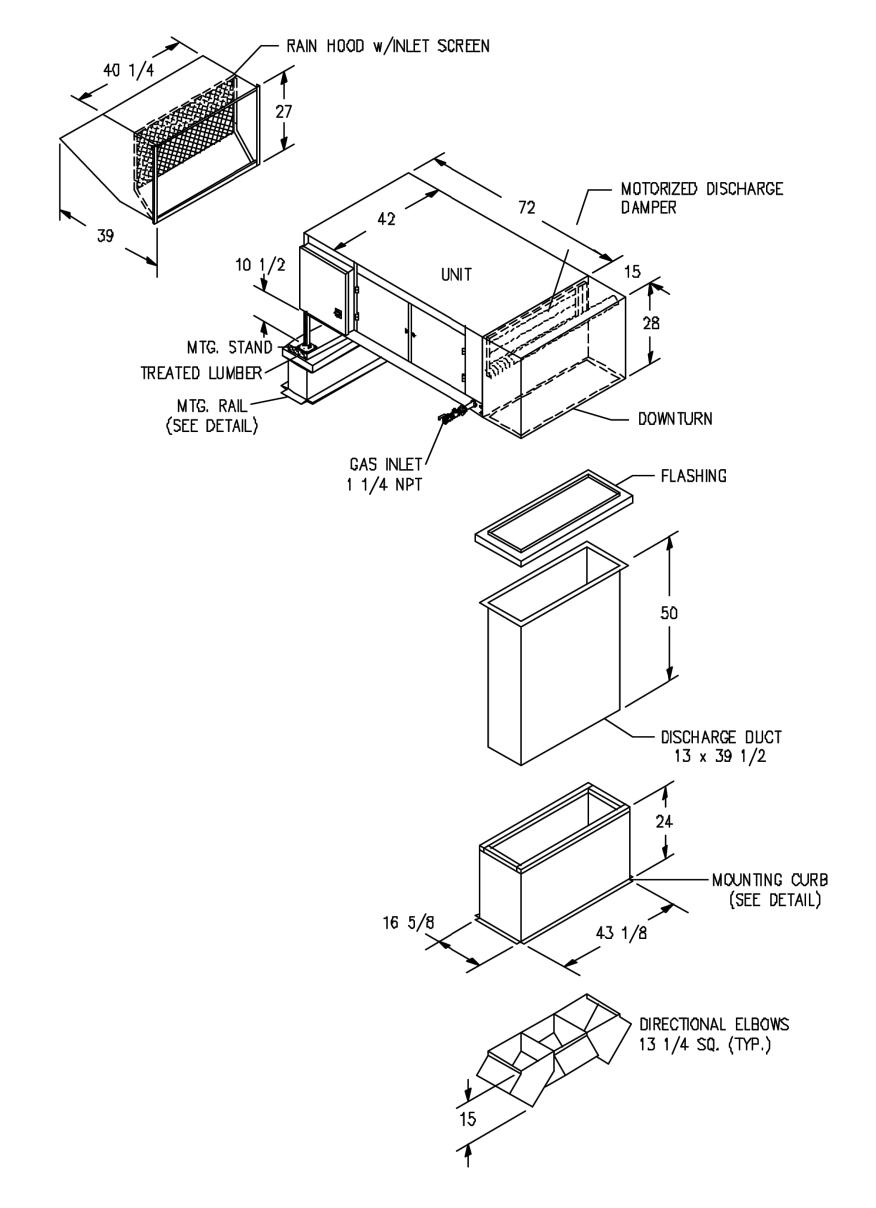

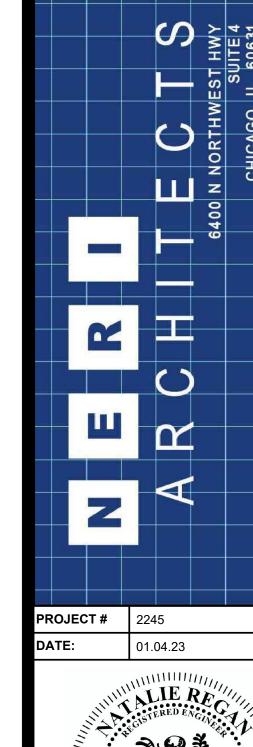



OAD & GENERAL FORREST

CARWAS

NEW AUTOMATED CA
"GRAND WASH"
ALMAVILLE ROAD & GE
SMYRNA, TN

APPROVED BY:

GCN / MAM

APPROVED BY:

GCN / MAM

SCALE:

DESCRIPTION:


MECH SCHEDULES, NOTES, & DETAILS


SHEET NO.

MANAGEMAN

MAPPROVED BY:

MECH SCHEDULES, NOTES, & DETAILS

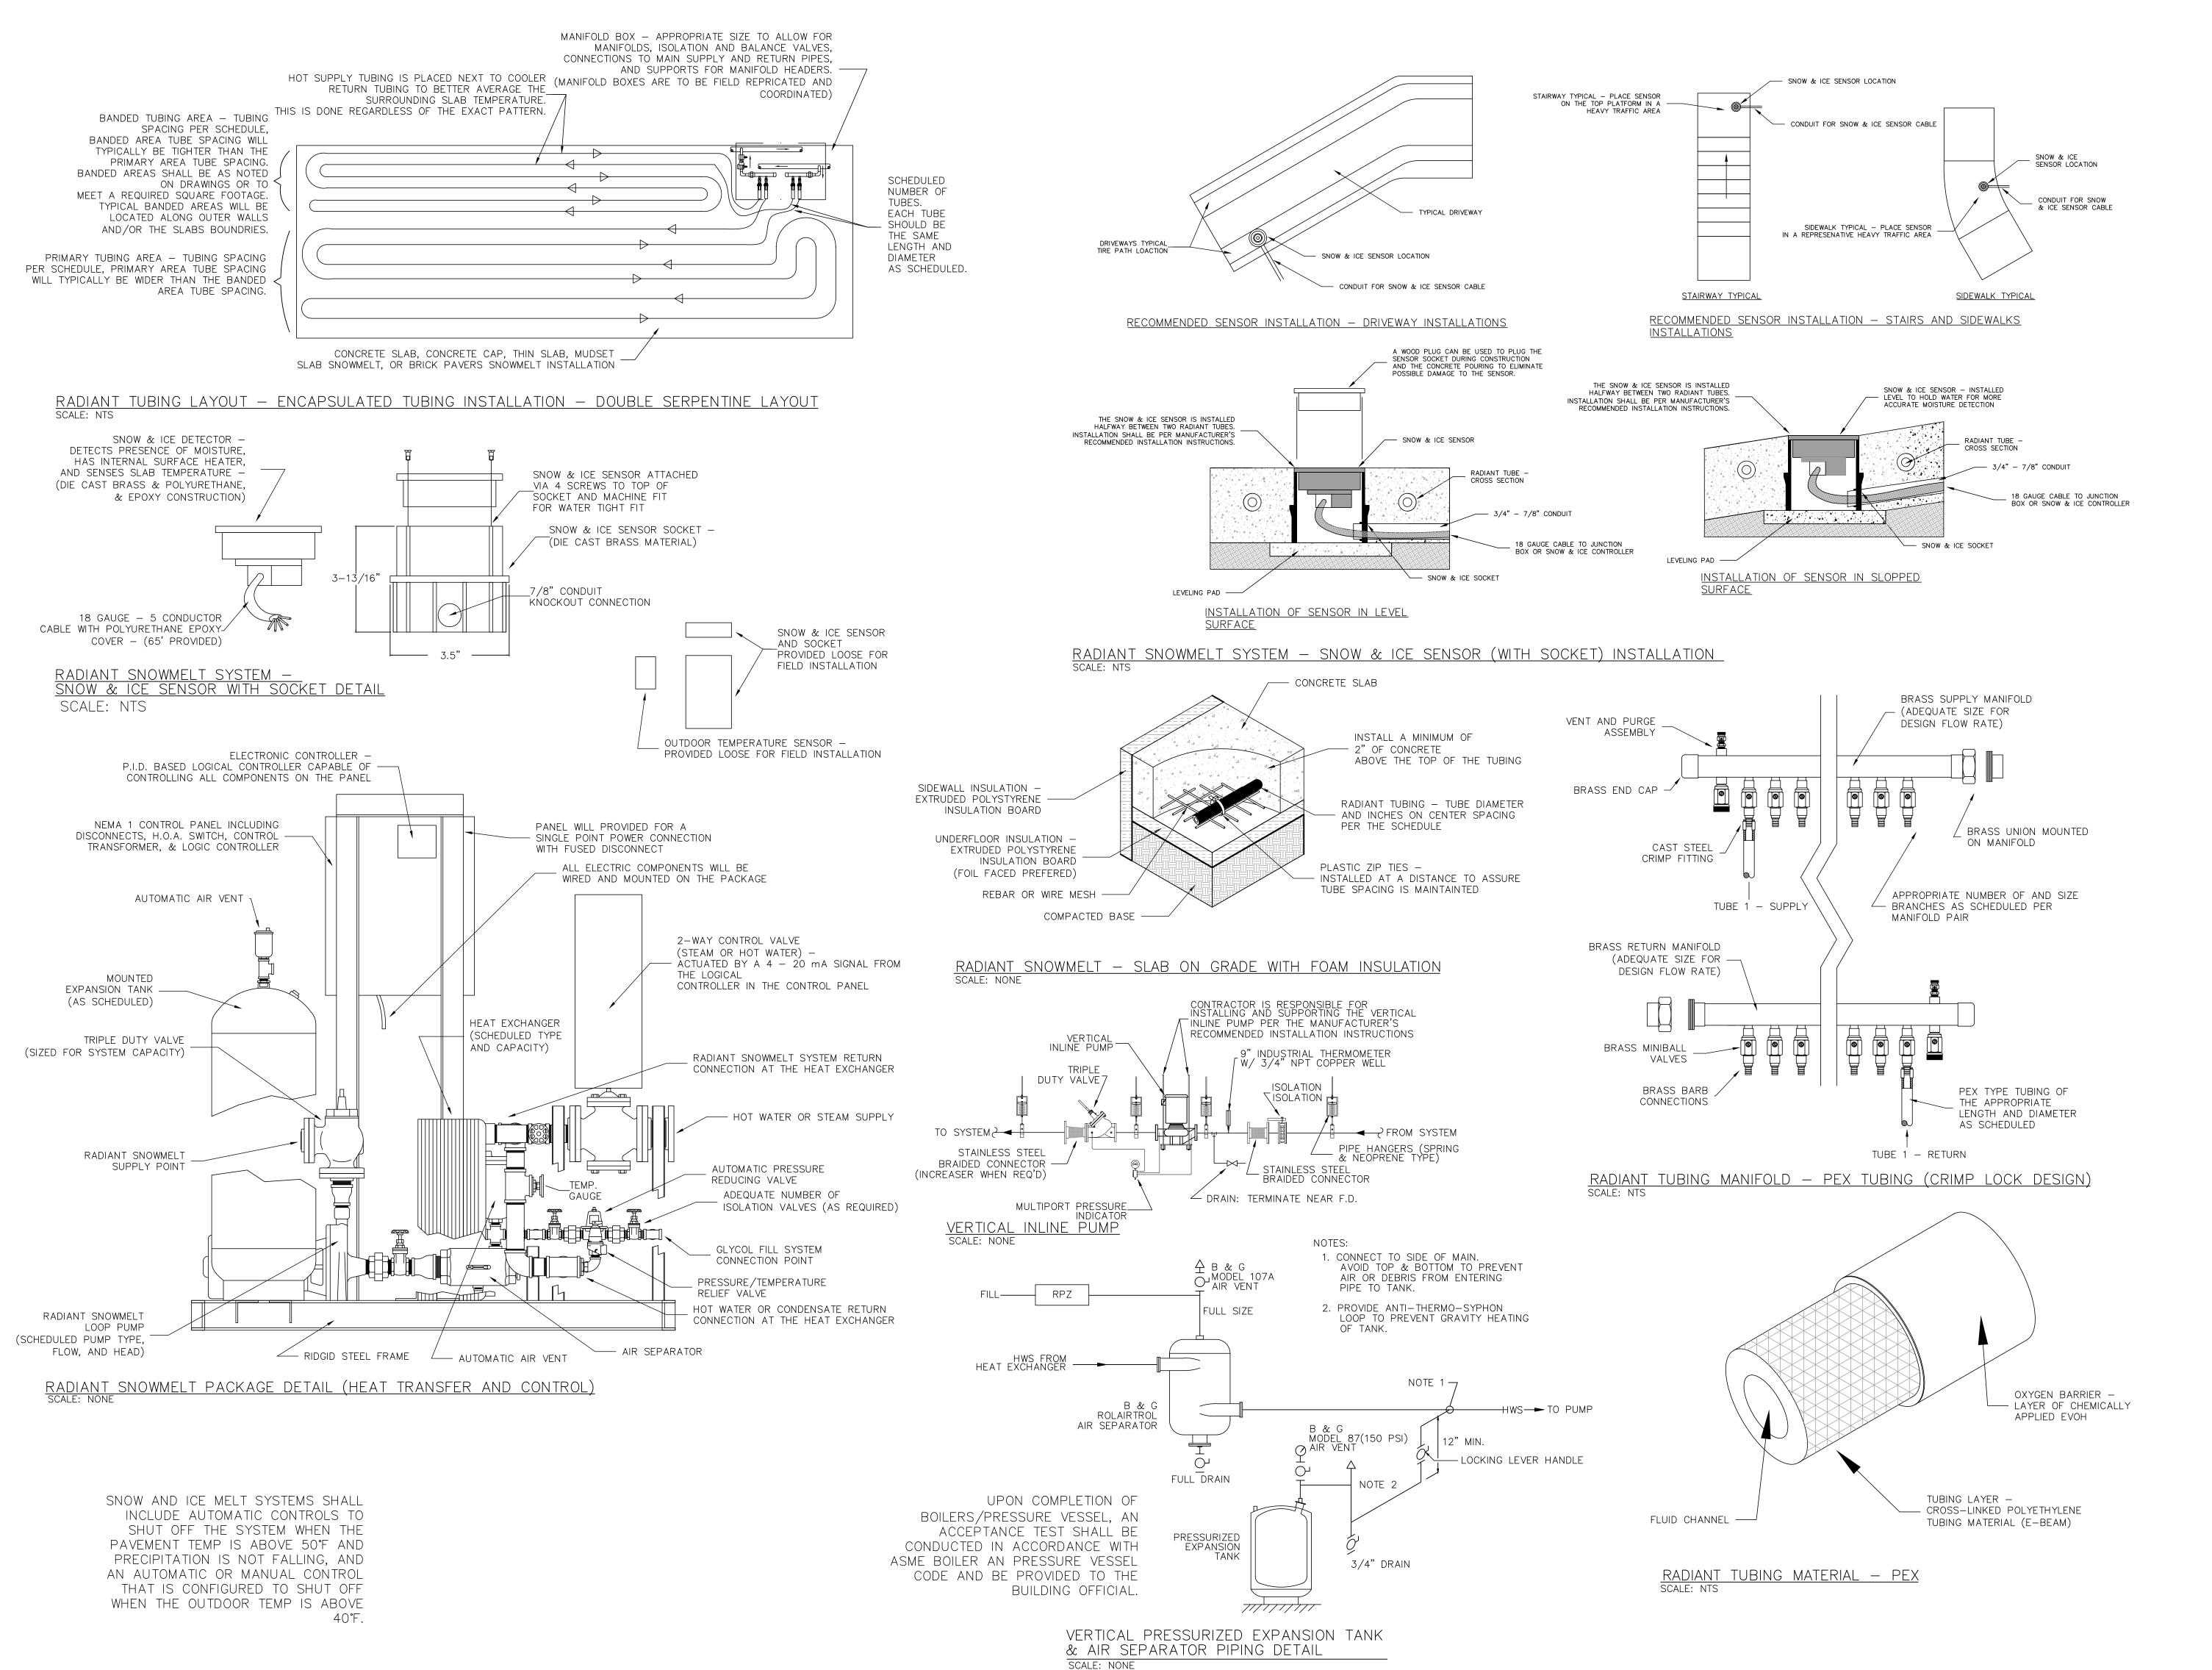

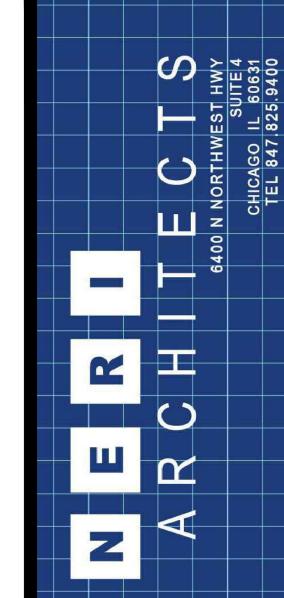

AGRICULTURE

COMMERCE

No. 12829

NOIL

PERMIT

2245

PROJECT #

NEW AUTOMATED CARWASH FACILI
"GRAND WASH"

ALMAVILLE ROAD & GENERAL FORRES
SMYRNA, TN