

# Safe Haven Renovations at Murfreesboro Fire Rescue Department Station #4

Murfreesboro, Tennessee

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Johnson + Bailey Architects P.C.



Consultants:  
Entech Engineering, Inc.  
Latta Structural Engineers, LLC





City Center  
100 East Vine St.  
Murfreesboro Tennessee  
37130  
615-890-4560  
Fax: 615-890-4564

Safe Haven  
Renovations at  
Murfreesboro  
Fire Rescue  
Department  
Station #4


Murfreesboro, Tennessee

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## MASTER FLOOR PLAN



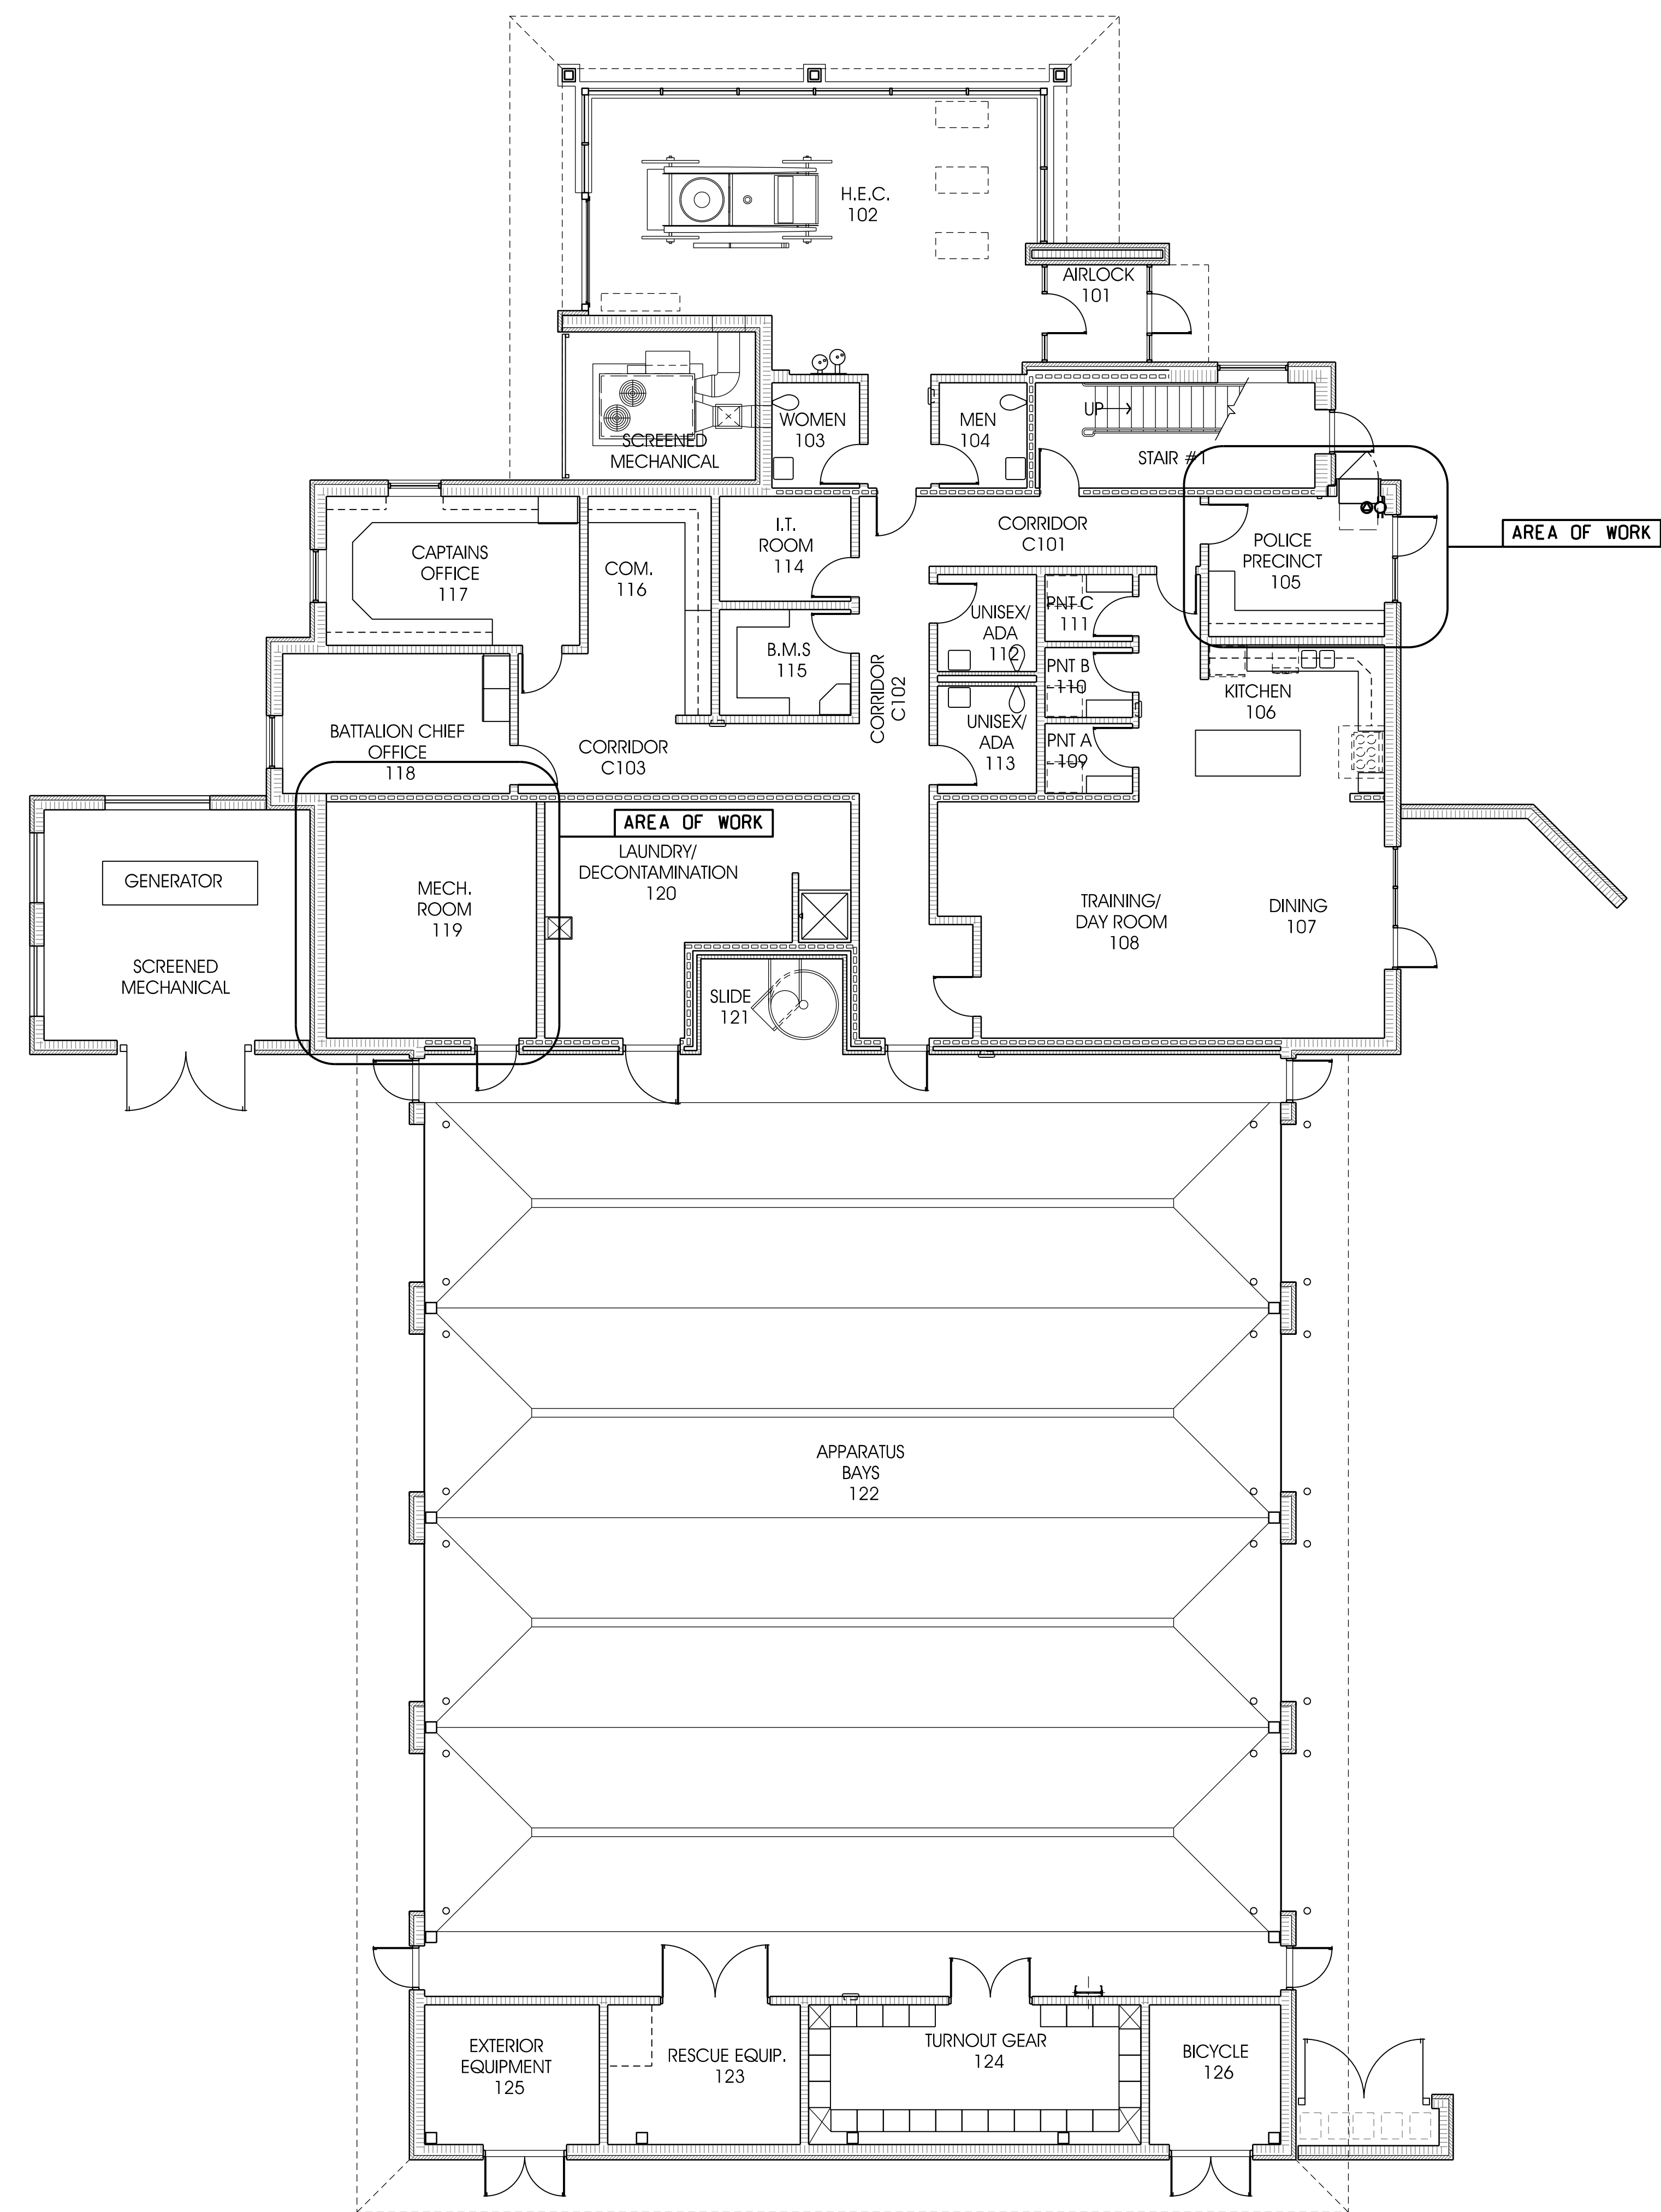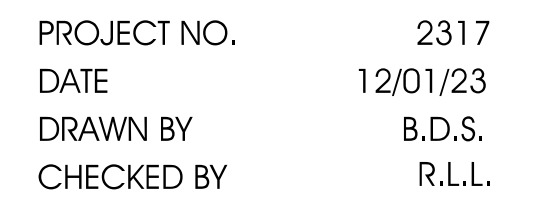

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Murfreesboro, Tennessee

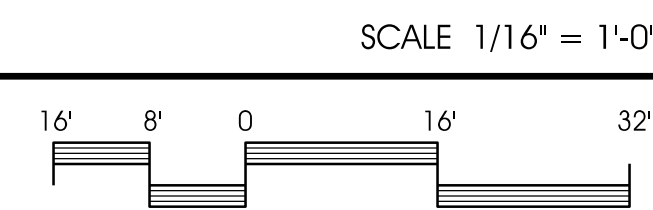REVISIONS DATE


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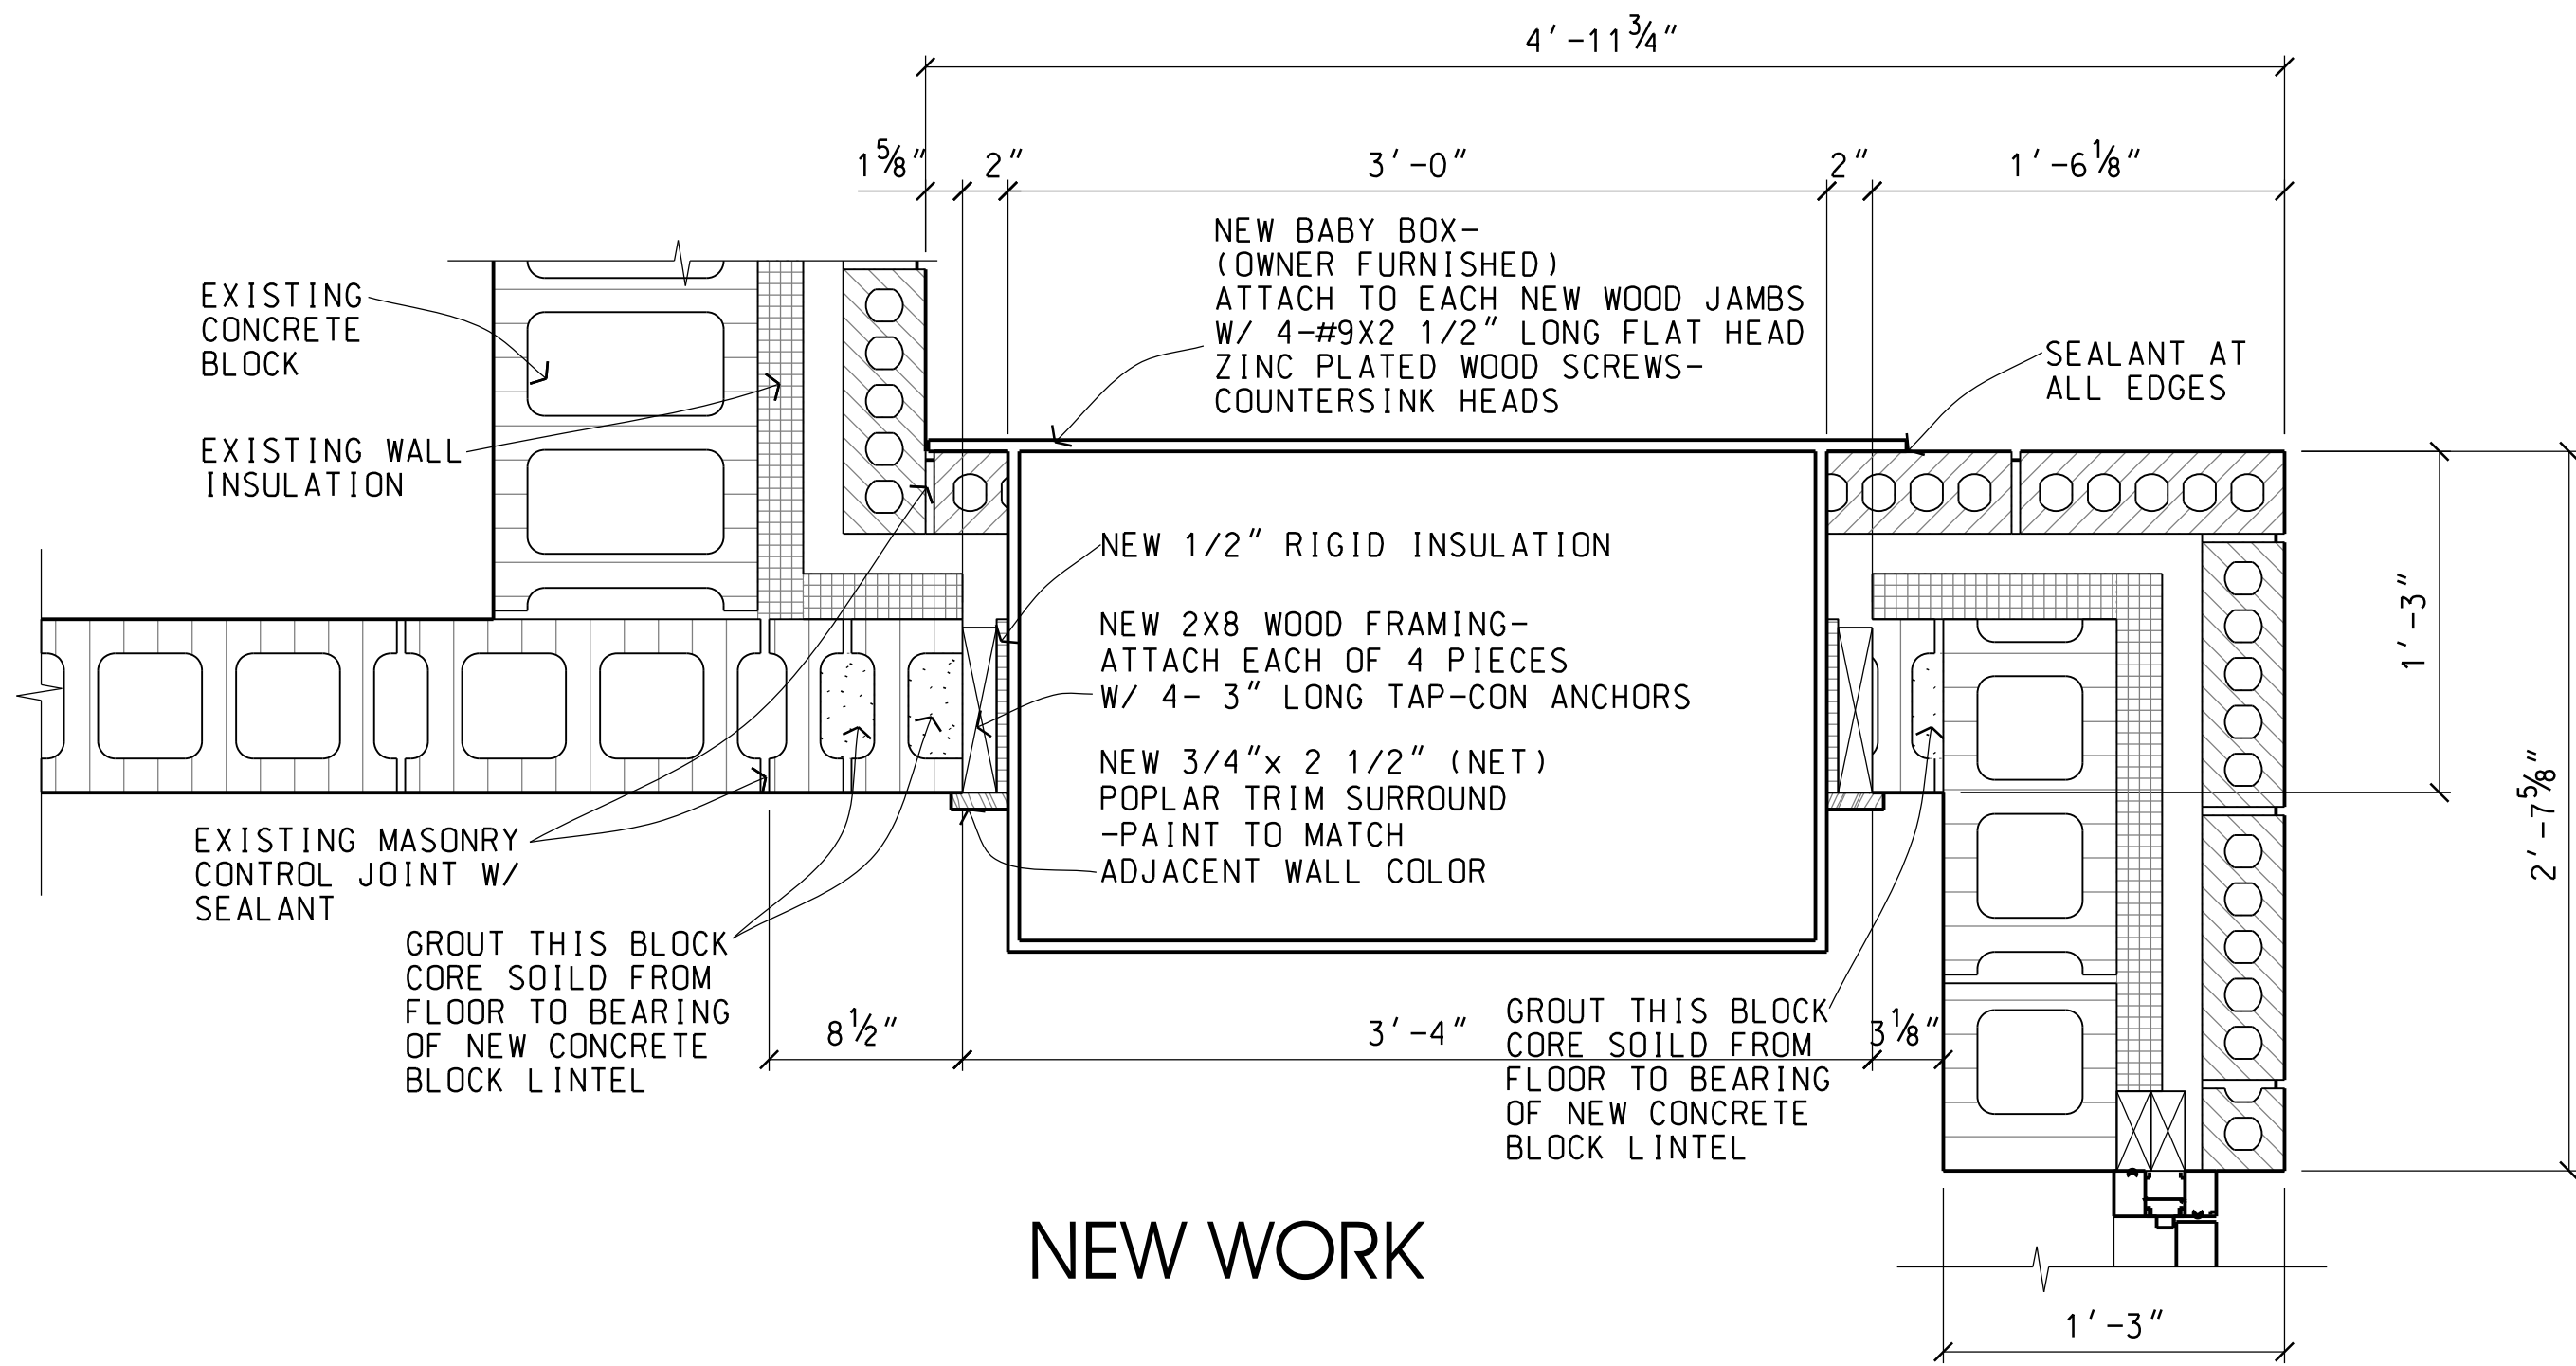


PROJECT NO. 2317  
DATE 12/01/23  
DRAWN BY B.D.S.  
CHECKED BY R.L.L.

A2.1




DEMOLITION

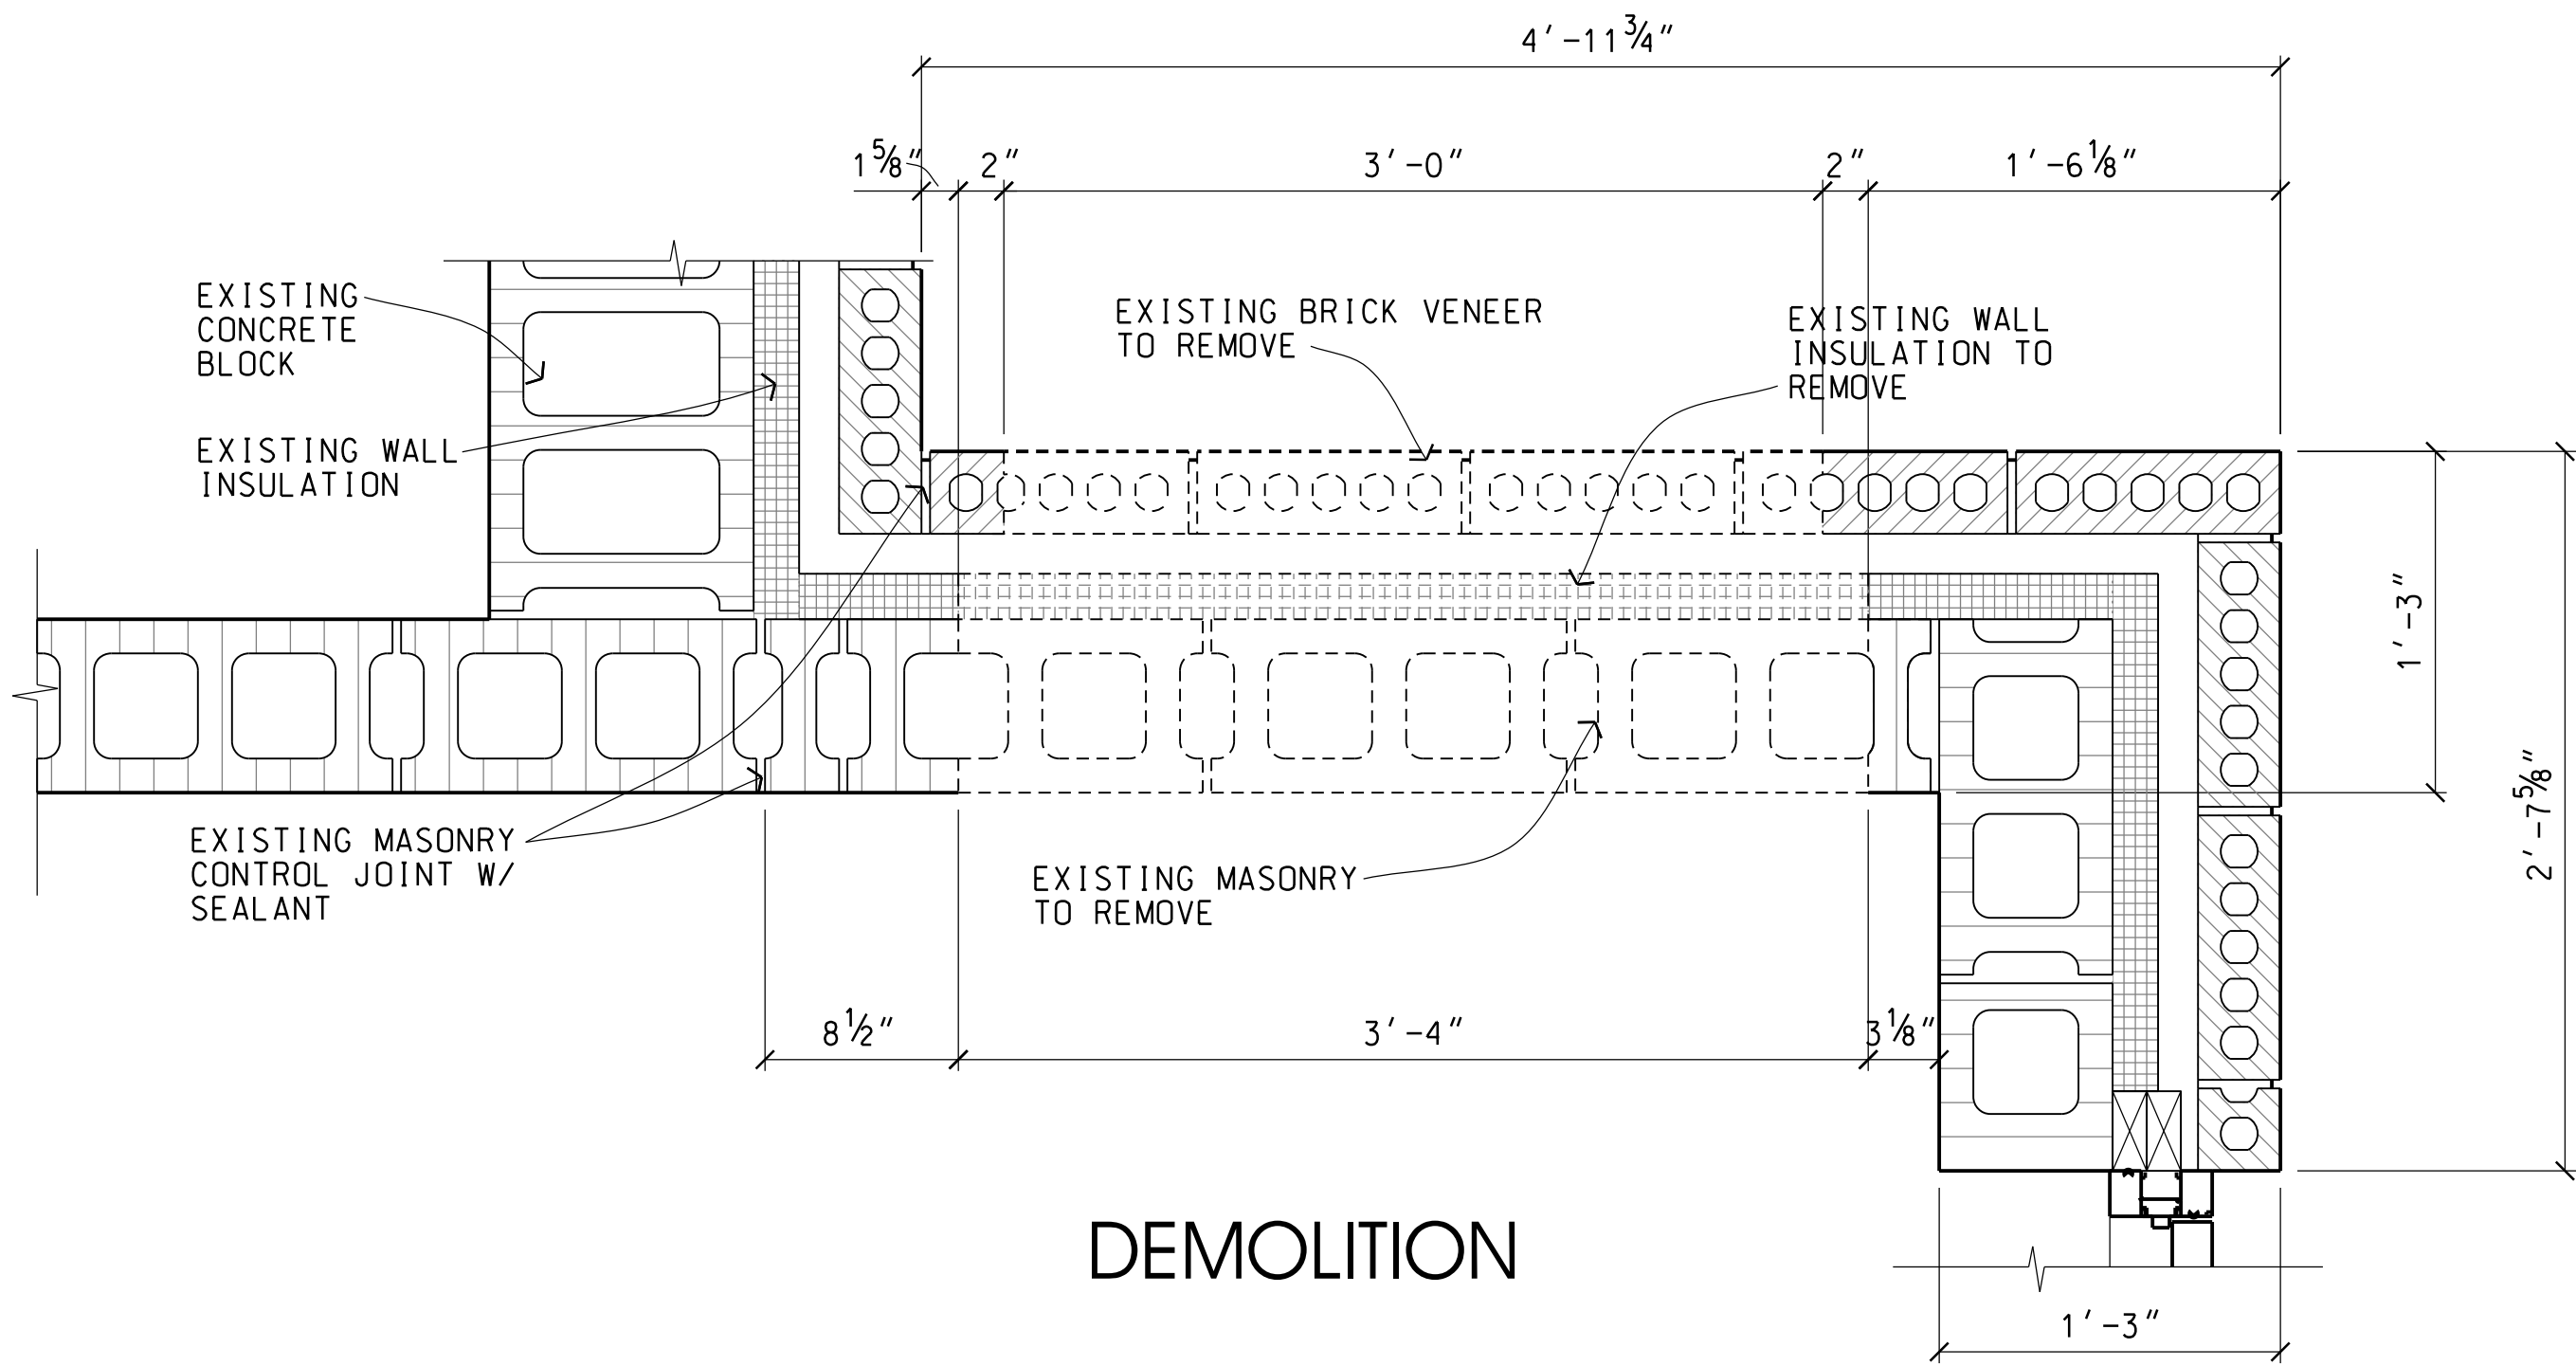


NEW WORK

PLAN DETAIL

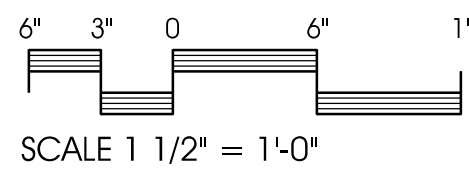

1  
A2.1

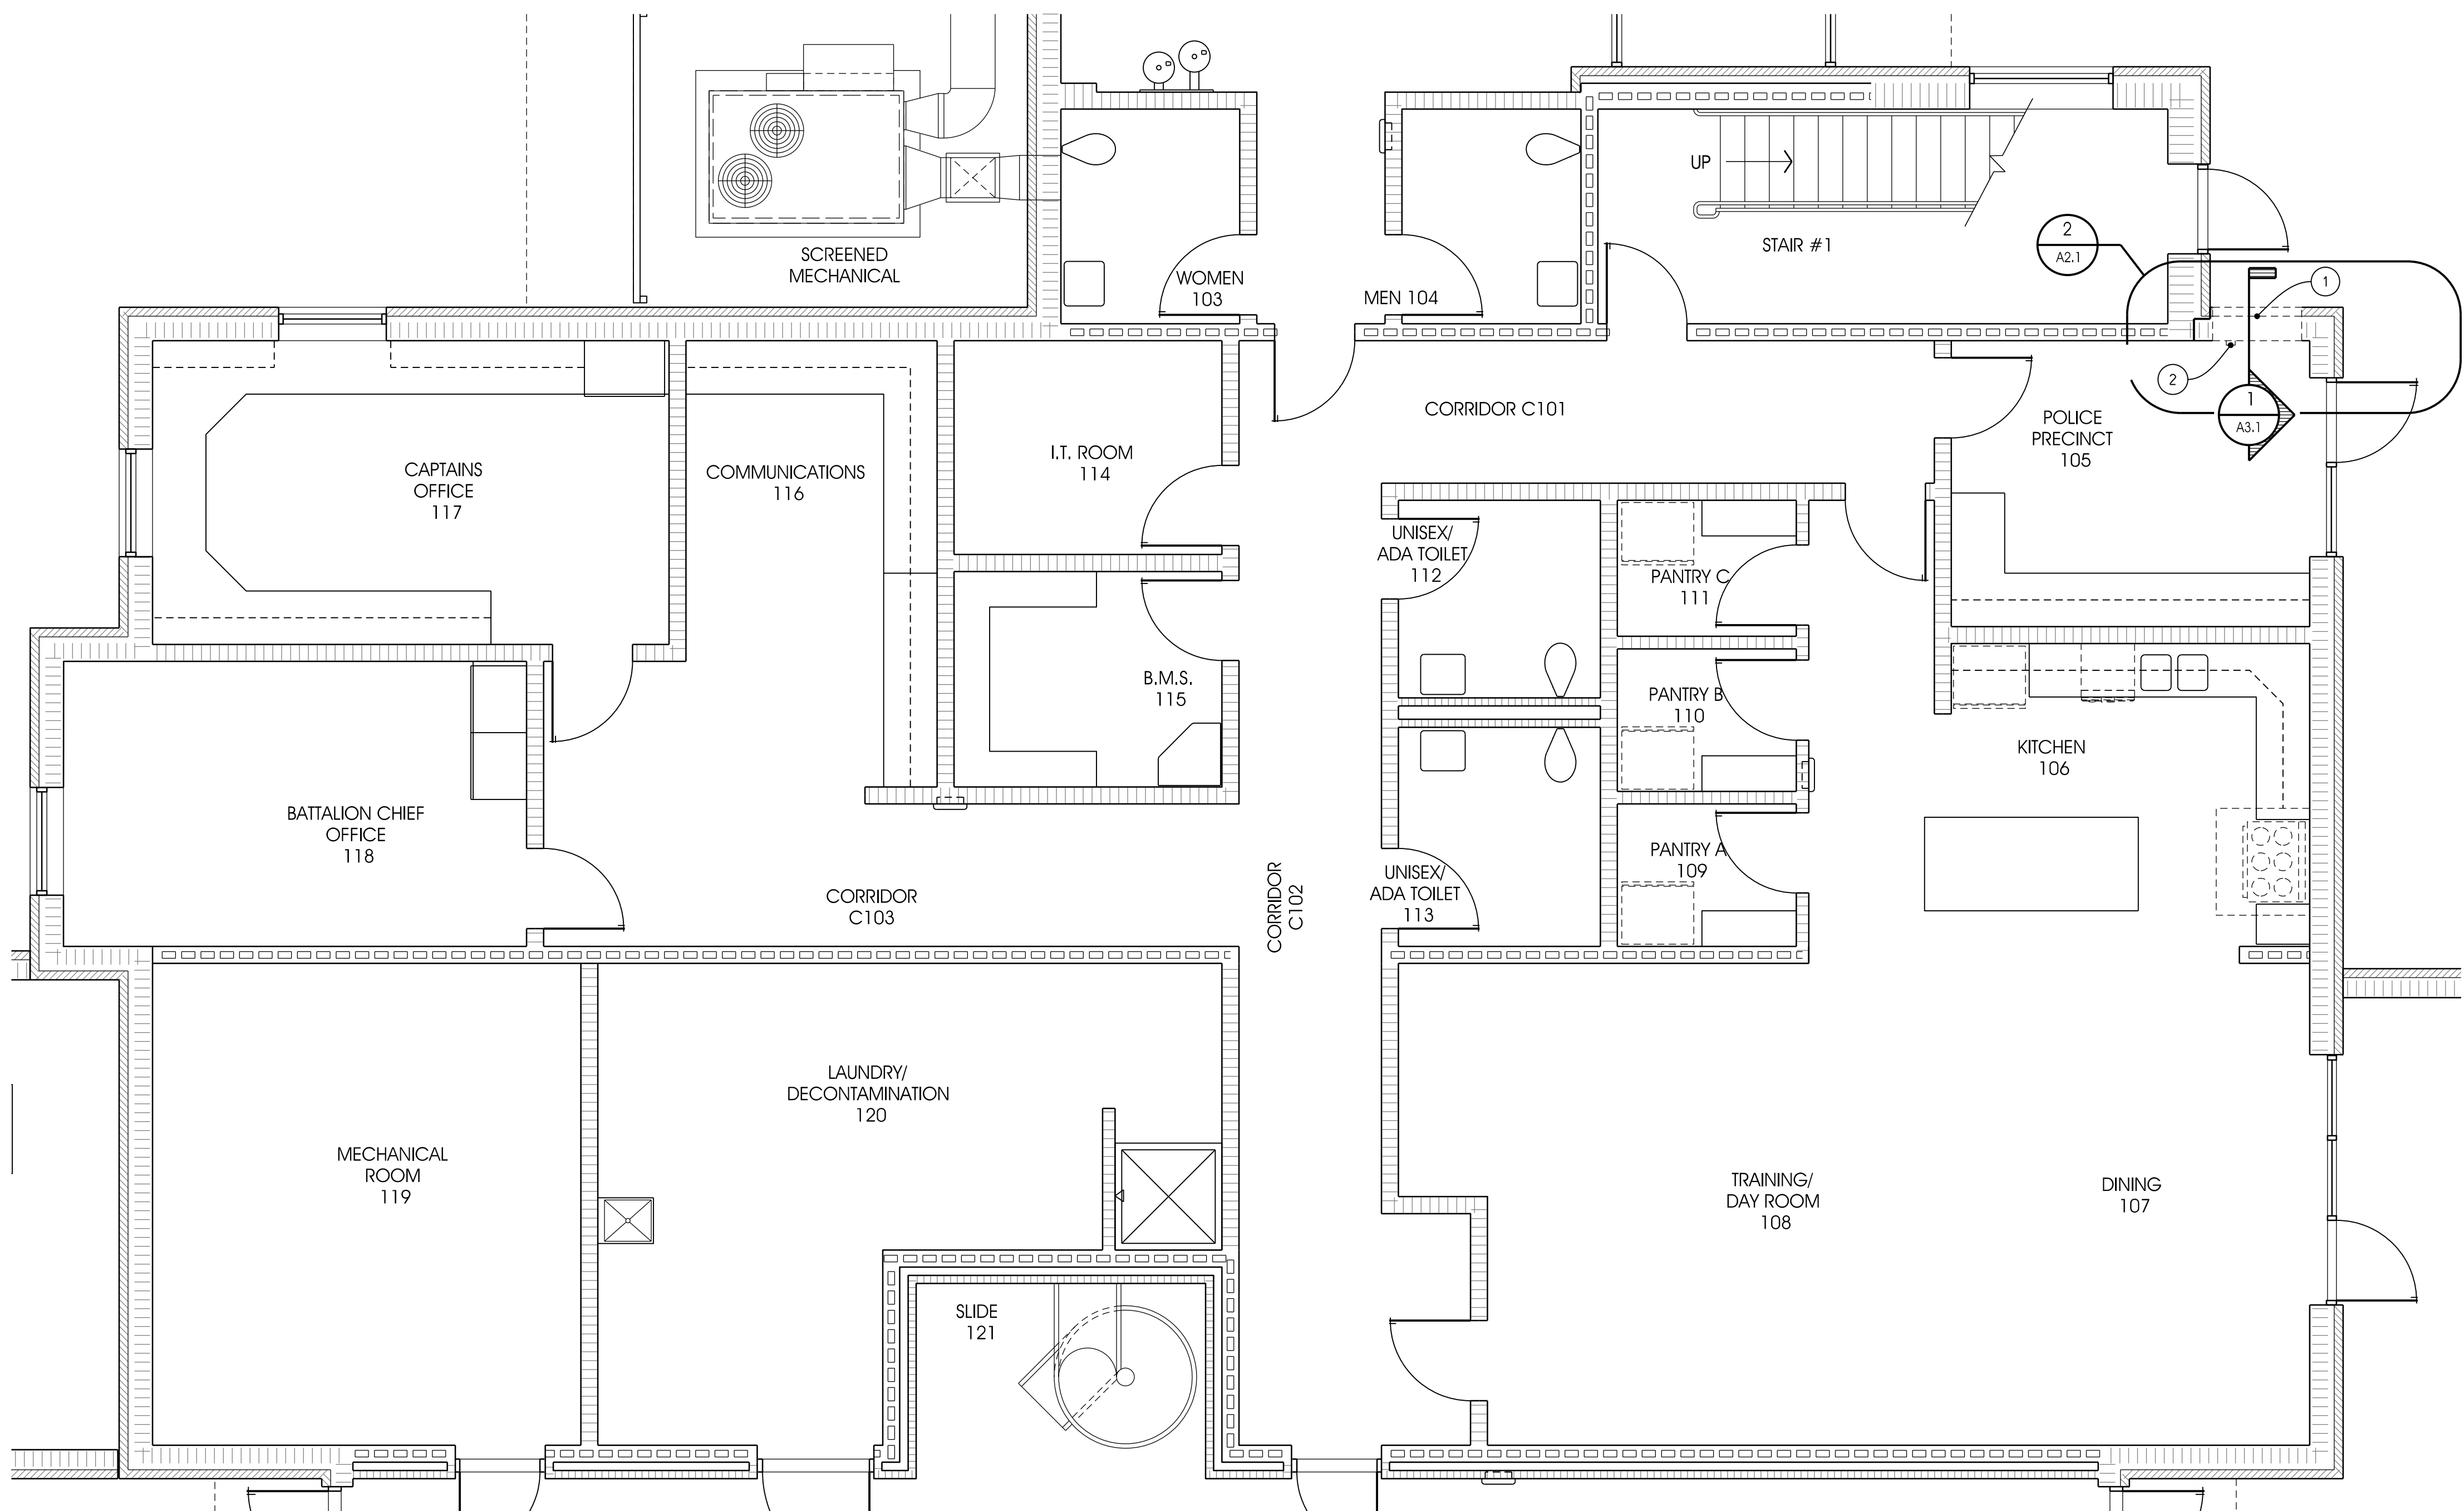

DEMOLITION FLOOR PLAN


SCALE 1/4" = 1'-0"





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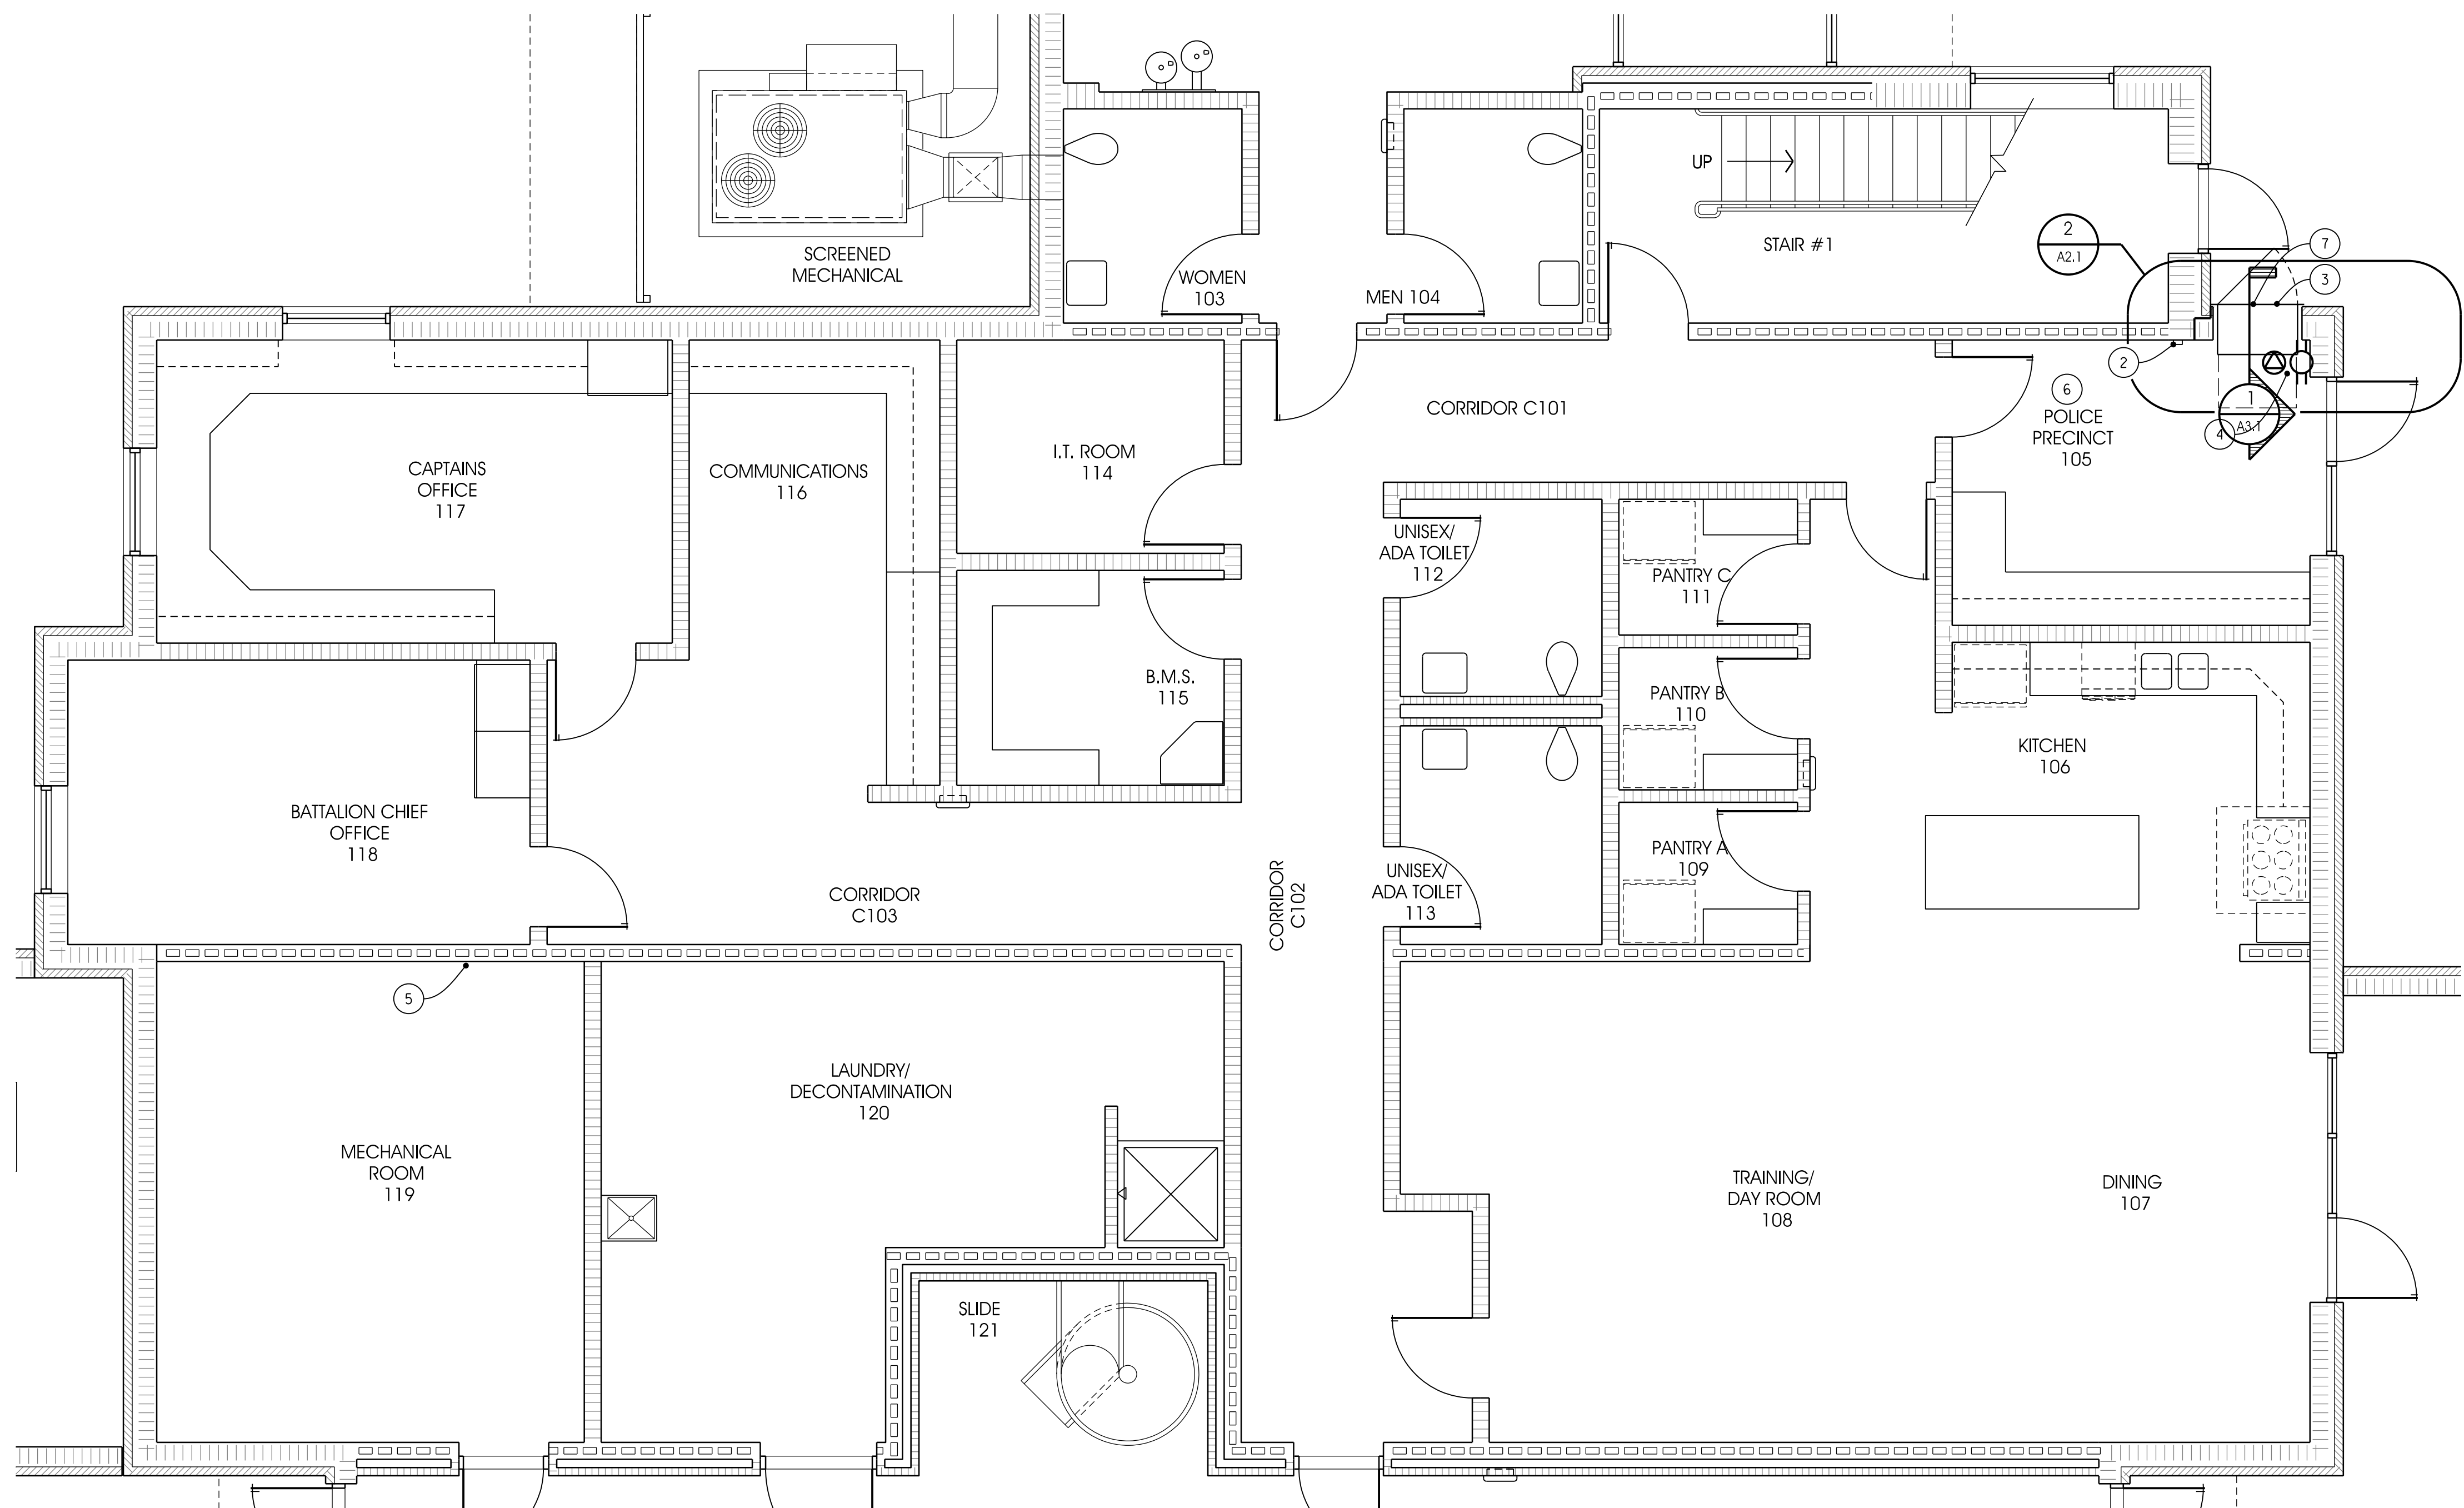


DEMOLITION  
WALL SECTION

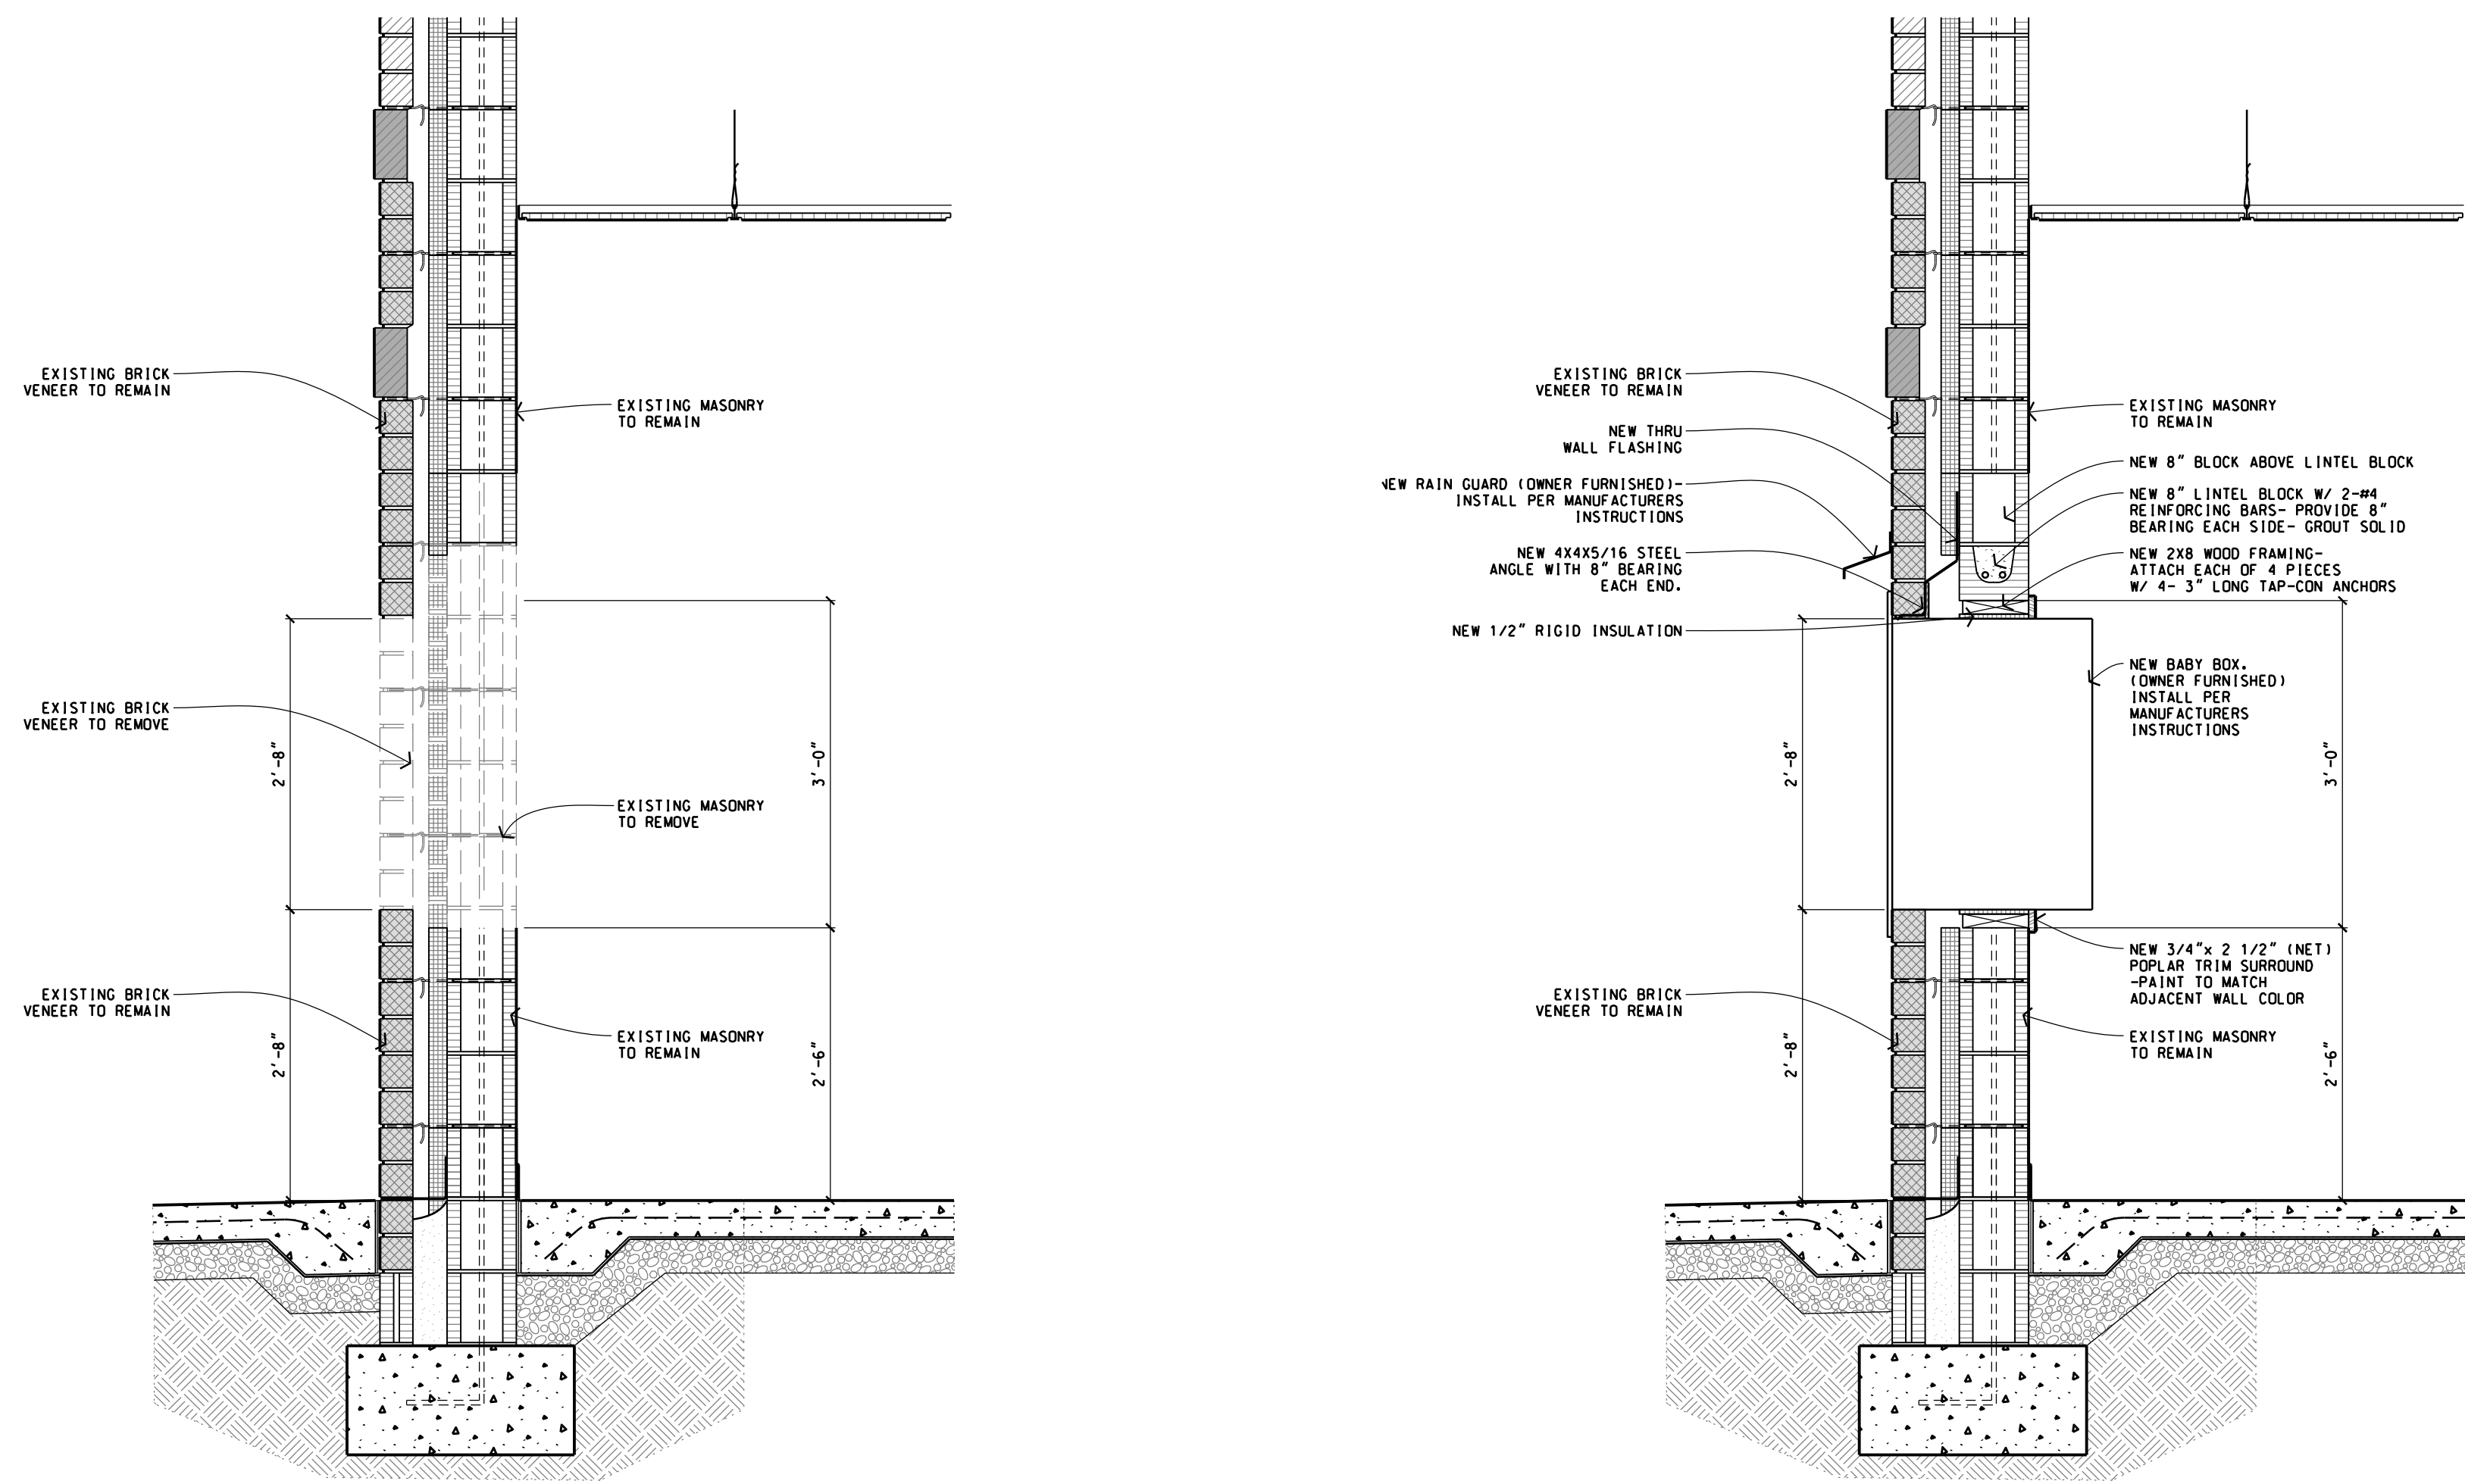NEW WORK

1  
A3.1

SCALE 3/4" = 1'-0"



NEW WORK FLOOR PLAN

SCALE 1/4" = 1'-0"

4' 2' 0' 4' 8'

REVISIONS DATE

NOTES:

GENERAL RENOVATION NOTES

1. WORK AREA IS TO BE SECURED AT END OF EACH WORK DAY.
2. PATCH & REPAIR EXISTING CONSTRUCTION WHERE EXISTING ITEMS ARE REMOVED TO MATCH ADJACENT EXISTING CONSTRUCTION.
3. PROTECT EXISTING INTERIOR FINISHES FROM DAMAGED DURING CONSTRUCTION. REPAIR ANY DAMAGE TO PRE-CONSTRUCTION CONDITION

KEYED RENOVATION PLAN NOTES

- ① REMOVE AND SAVE EXISTING BRICK AND BLOCK MASONRY AS REQUIRED TO INSTALL NEW BABY BOX AND LINTELS. REINSTALL AS SHOWN AFTER NEW LINTELS ARE IN PLACE.
- ② REMOVE AND RELOCATE EXISTING FIRE ALARM PULL STATION TO LOCATION SHOWN ON PLANS. NEW EXPOSED ELECTRICAL CONDUIT AND BOX MAY BE SURFACE MOUNTED (WIREMOLD OR EQUAL).
- ③ INSTALL NEW BABY BOX (OWNER FURNISHED) PER MANUFACTURE'S INSTRUCTIONS.
- ④ INSTALL NEW DEDICATED 20 AMP ELECTRICAL RECEPTACLE AT 18" A.F.F. CIRCUIT TO EXISTING PANEL A. NEW EXPOSED ELECTRICAL CONDUIT AND BOX MAY BE SURFACE MOUNTED (WIREMOLD OR EQUAL). INSTALL NEW DATA CONNECTION FOR BABY BOX ALARM PER MANUFACTURERS INSTRUCTIONS. CONNECT THREE BABY BOX ALARM CIRCUITS TO EXISTING EDWARDS VIS-GO FIRE ALARM CONTROL PANEL. PROVIDE REMOTE MODULES AND OTHER ITEMS REQUIRED TO MAKE A COMPLETE OPERABLE SYSTEM.
- ⑤ INSTALL NEW 20AMP CIRCUIT BREAKER ON EXISTING PANEL 'A'
- ⑥ INSTALL ONE COAT OF NEW PAINT ON WALLS OF THIS SPACE. .
- ⑦ INSTALL NEW WALL MOUNTED EXTERIOR SIGNS (OWNER FURNISHED) PER MANUFACTURE'S INSTRUCTIONS.

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