





VICINITY MAP 1/4 MILE 1/2 MILE 3/4 MILE 1 MILE 0 FF 5280 FF

SITE PLAN BASED ON USGS QUAD MAP CONVENT QUADRANGLE CONVENT, LOUISIANA 2009


MOSAIC — UNCLE SAM PLANT PROPOSED SHIP DOCK VICINITY MAP MISSISSIPPI RIVER 160.4 MILES ST JAMES PARISH, LA URS


SCALE NOTED DWG NO. 1 OF 18 REV. A DWN OKL CHK'D APR'D JOB 38987942

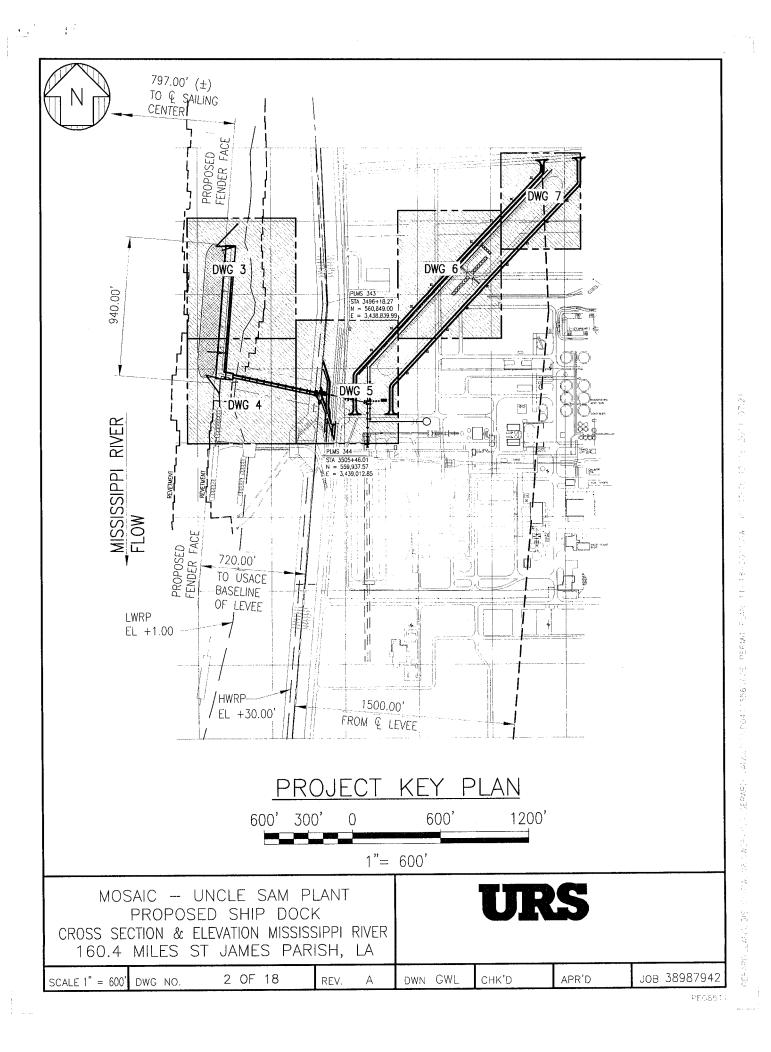


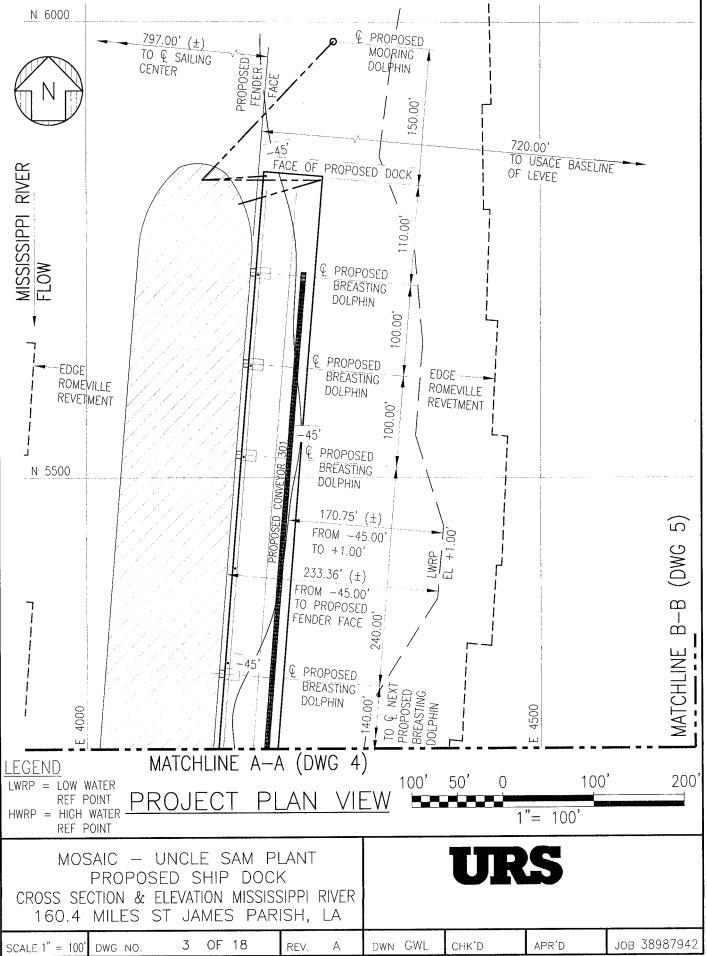

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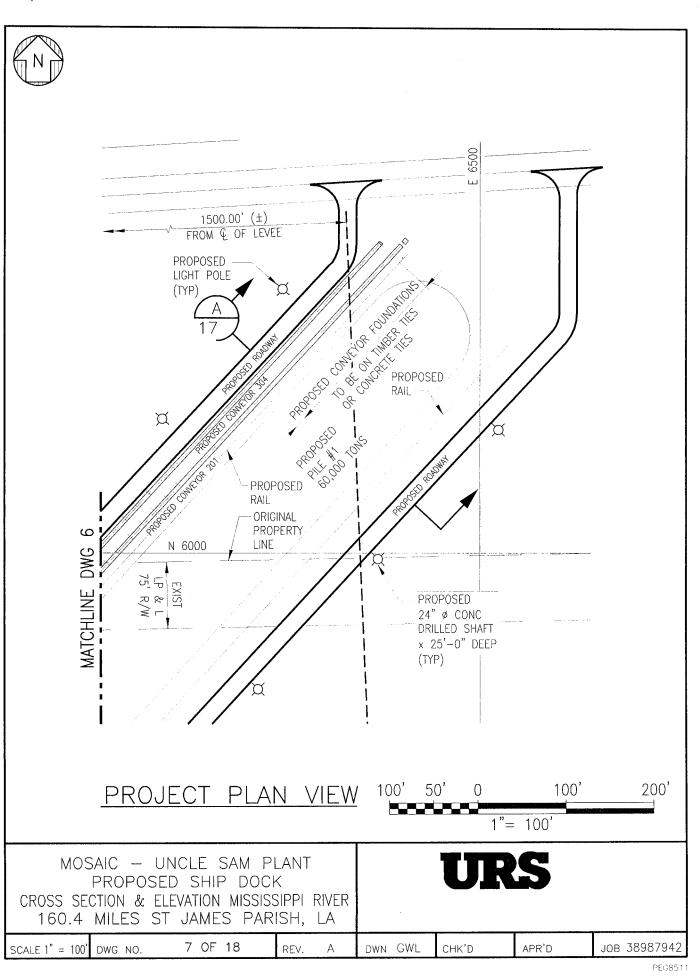


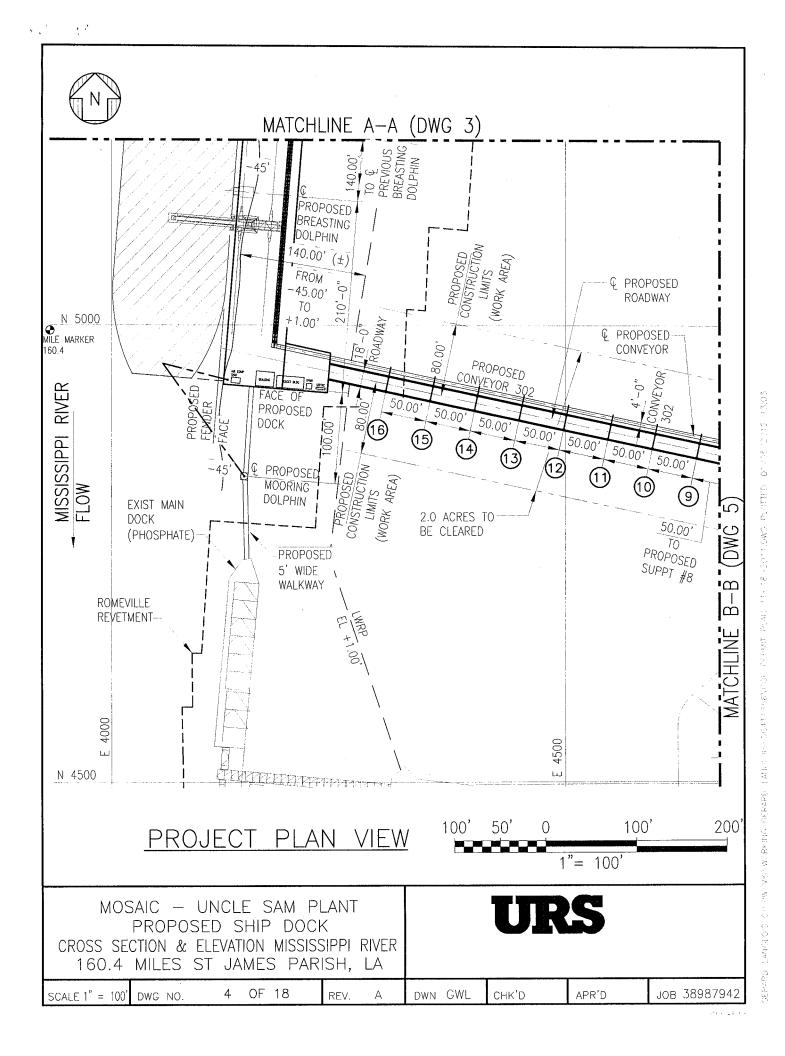


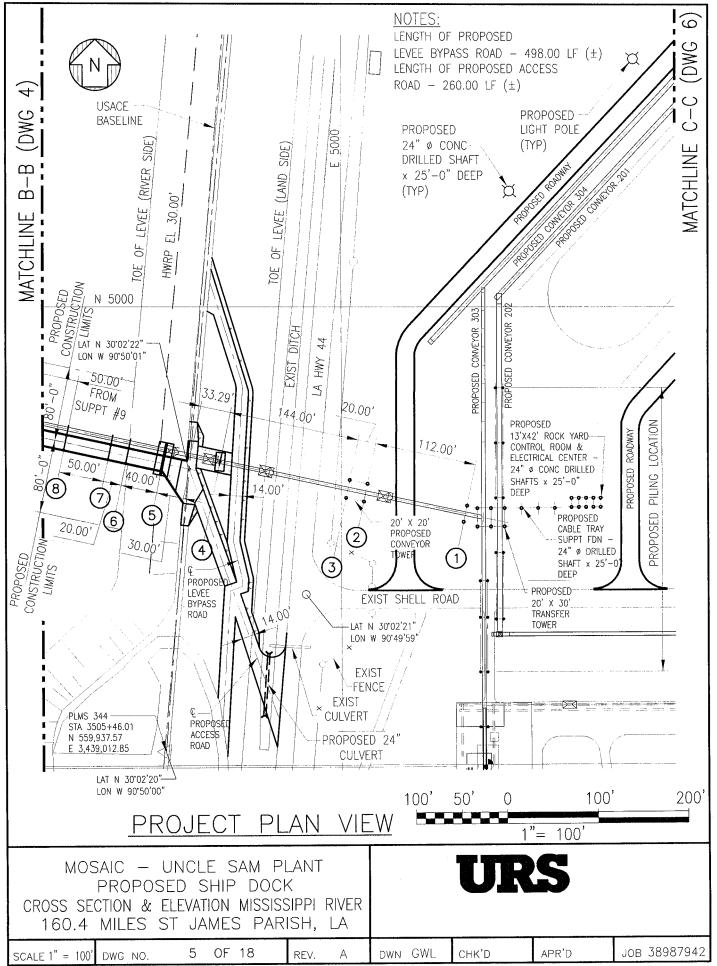
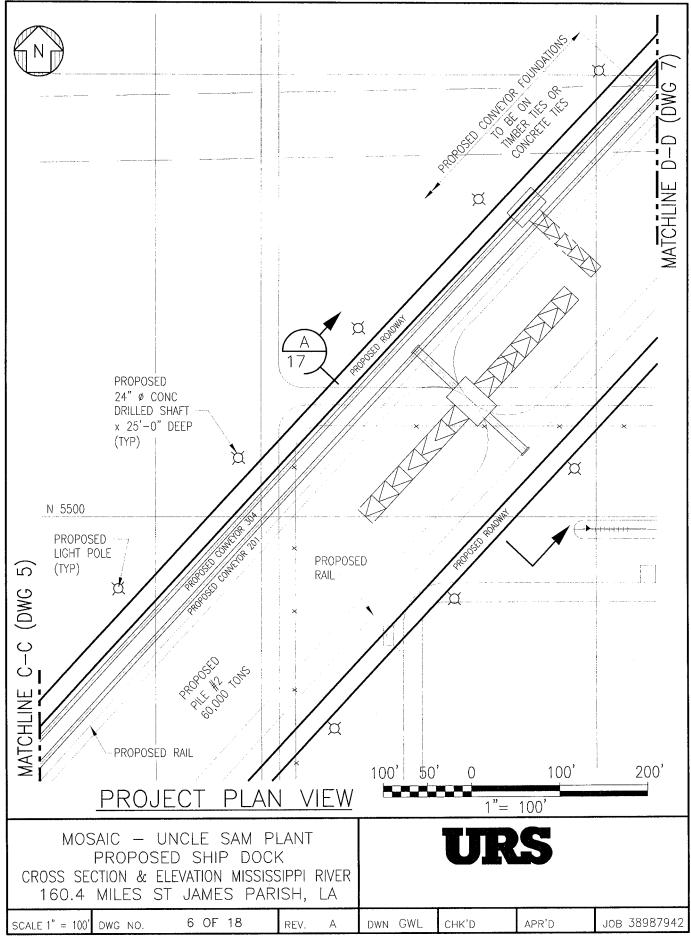
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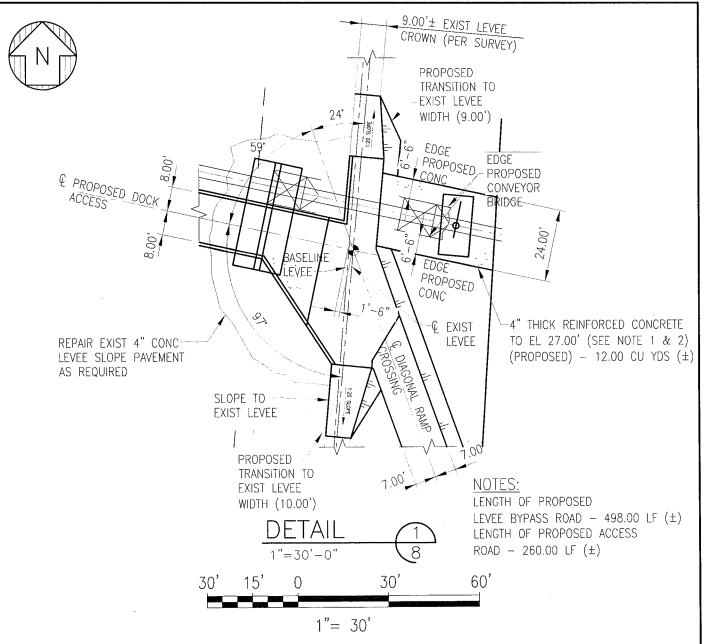
1990 | 196 | 1901 | 1903 | 1904 | 1905 | 1905 | 1905 | 1905 | 1905 | 1905 | 1905 | 1905 | 1905 | 1905 | 1905 |



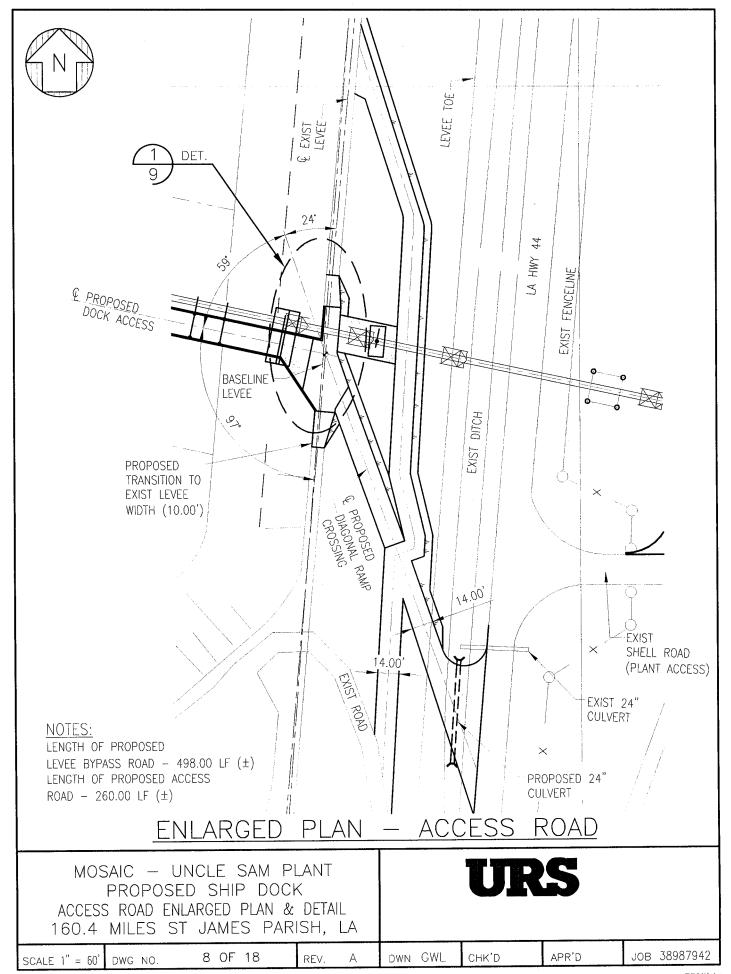

41.3


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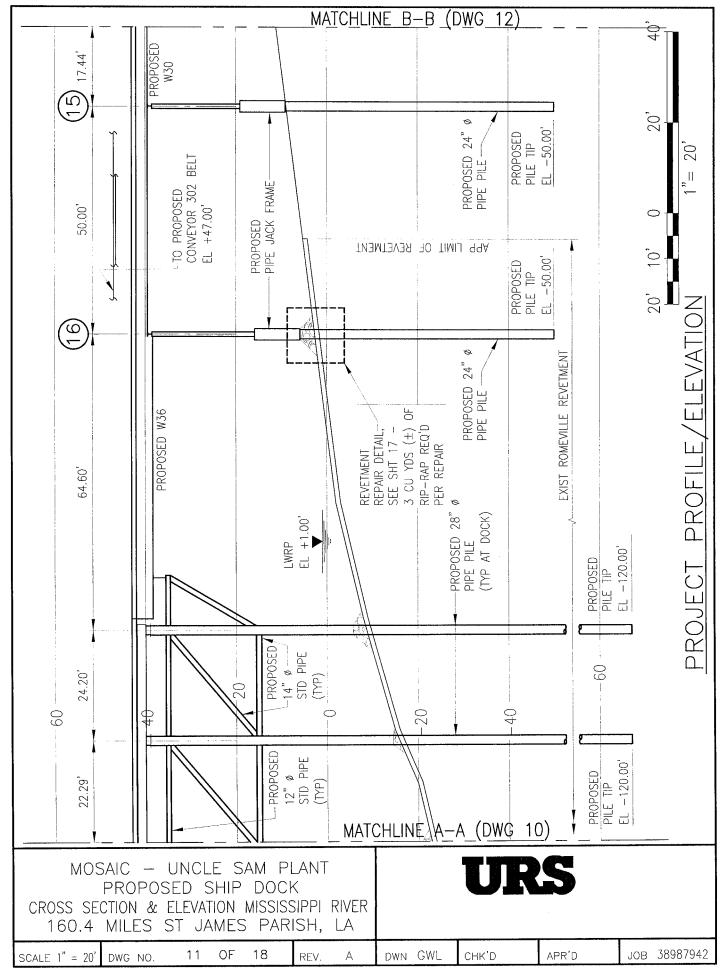
NOTES:


- 1. ALL PAVING AT THE LEVEE WILL BE PER CORPS OF ENGINEERS SURFACE CROSSING DETAILS FOR TYPICAL RIVER LEVEES, FILE NUMBER H-8-29027 DWG 4 OF 9.
- 2. ALL ROADS ON THE LEVEE SHALL BE PER CORPS OF ENGINEERS SURFACE CROSSING DETAILS FOR TYPICAL RIVER LEVEES, FILE NUMBER H-8-29027 DWG 6 OF 9.


MOSAIC — UNCLE PROPOSED SHII ACCESS ROAD ENLARGED 160.4 MILES ST JAME	P DOCK PLAN & DETAIL		UR	S		
SCALE 1" = 30' DWG NO. 9 OF	18 REV.	Α	DWN GWL	CHK'D	APR'D	ЈОВ 38987942



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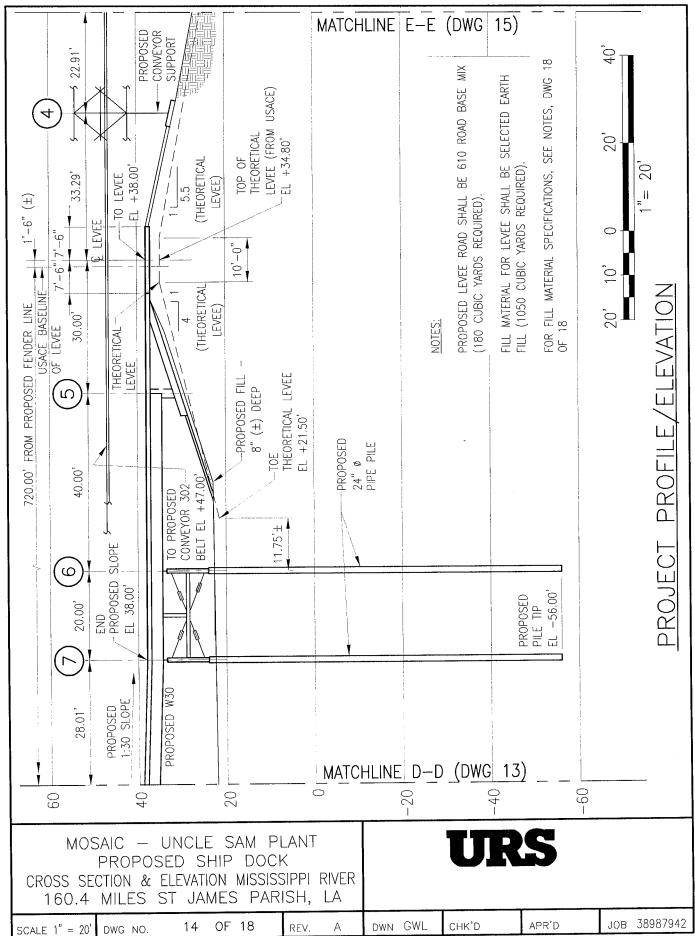


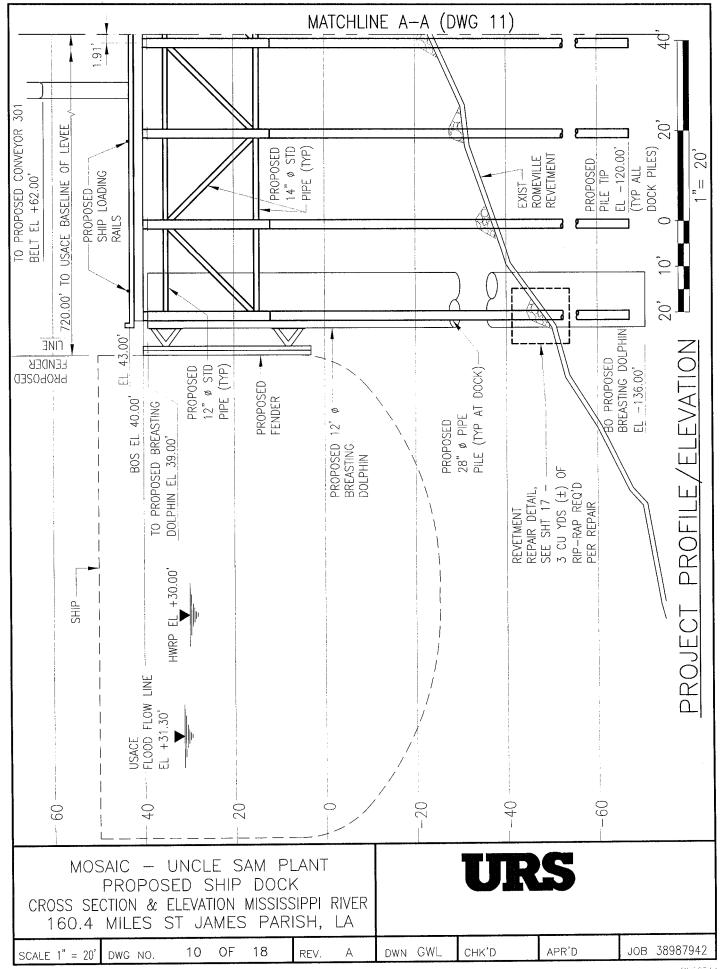

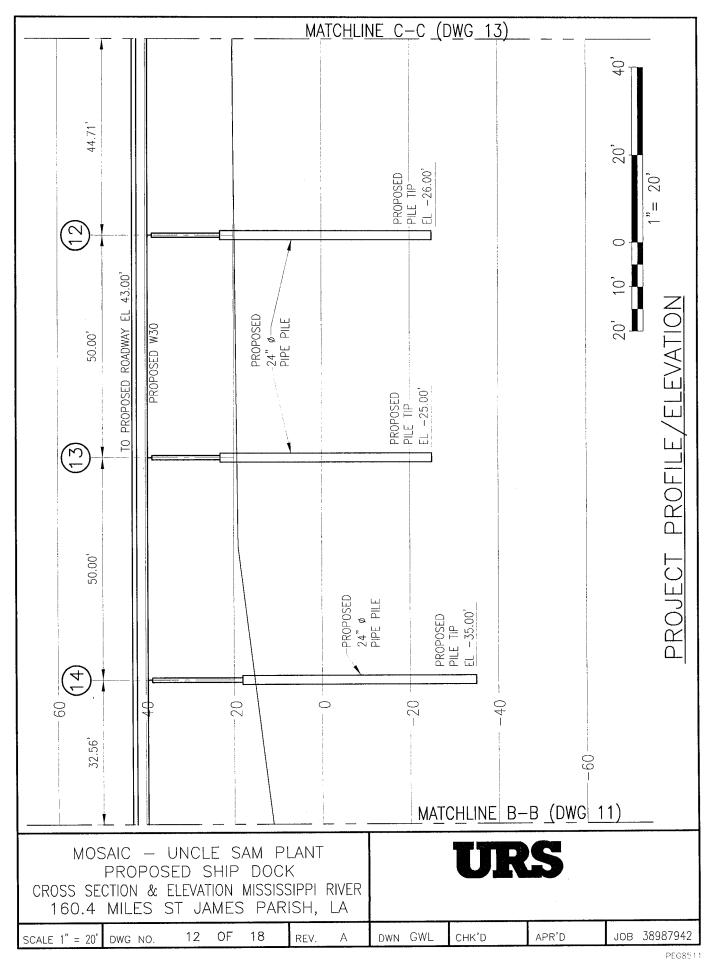

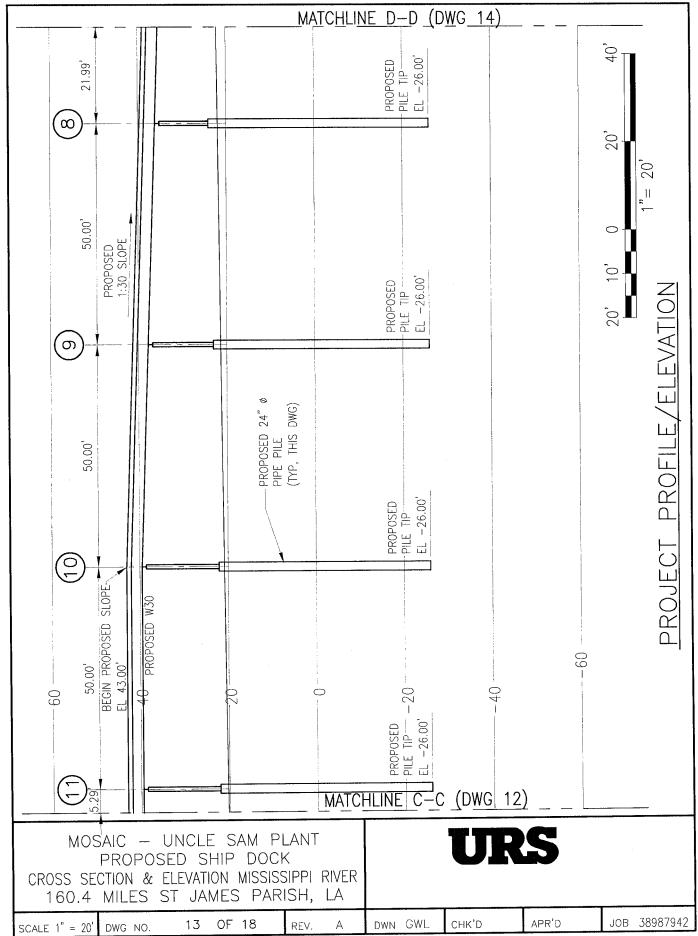
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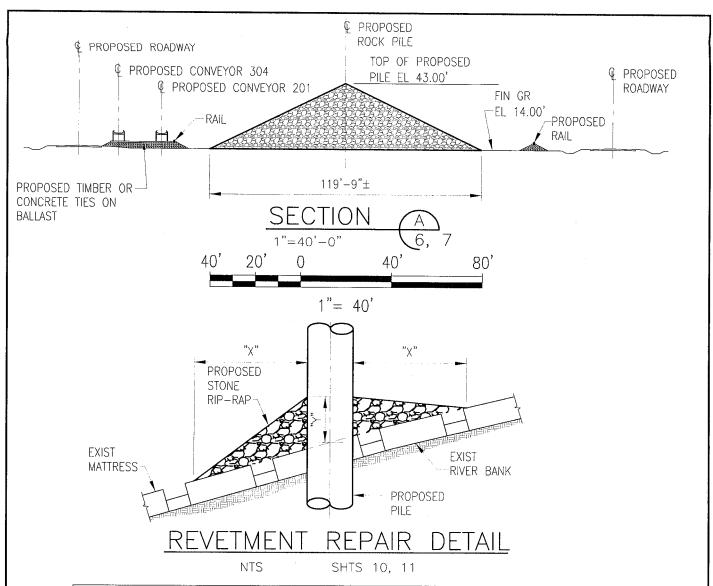
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GERAPD_LANGLOT GNVPM_VRNWGRPAPD_LANGLOTSND04+1366/20E PFGFLEDWS PGJTEG 12/16/2011-07/29



REVETMENT REPAIR SCHEDULE								
DEPTH OF WATER IN	DIMENSION IN FEET		APPROX TONS OF STONE REQUIRED					
FEET AT POINT OF PILE PENETRATION	"χ"	"\"	12" TO 14" PILE	18" TO 24" PILE	28" TO 36" PILE	42" AND ABOVE		
0 TO 10	3	1 1/2	2	2.5	3	4		
11 TO 40	5	2	7	7	9	10		
41 TO 60	8	3	22	23	26	30		
61 TO 100	12	4	57	63	69	76		

REVETMENT REPAIR NOTES:

- 1. SIZE OF RIP-RAP TO VARY BETWEEN 6 LBS AND 125 LBS WITH 40% TO 60% OF THE STONE WITHIN THE RANGE OF 25 LBS TO 75 LBS
- 2. RIP-RAP 10 INCHES THICK SHALL BE PLACED AROUND THE DISTURBED AREA OF ANY PILING DRIVEN THROUGH THE UPPER BANK PAVING
- 3. A TOTAL OF 582 CU YDS (±) OF RIP-RAP SHALL BE REQUIRED RE: REVETMENT REPAIR FOR THIS PROJECT

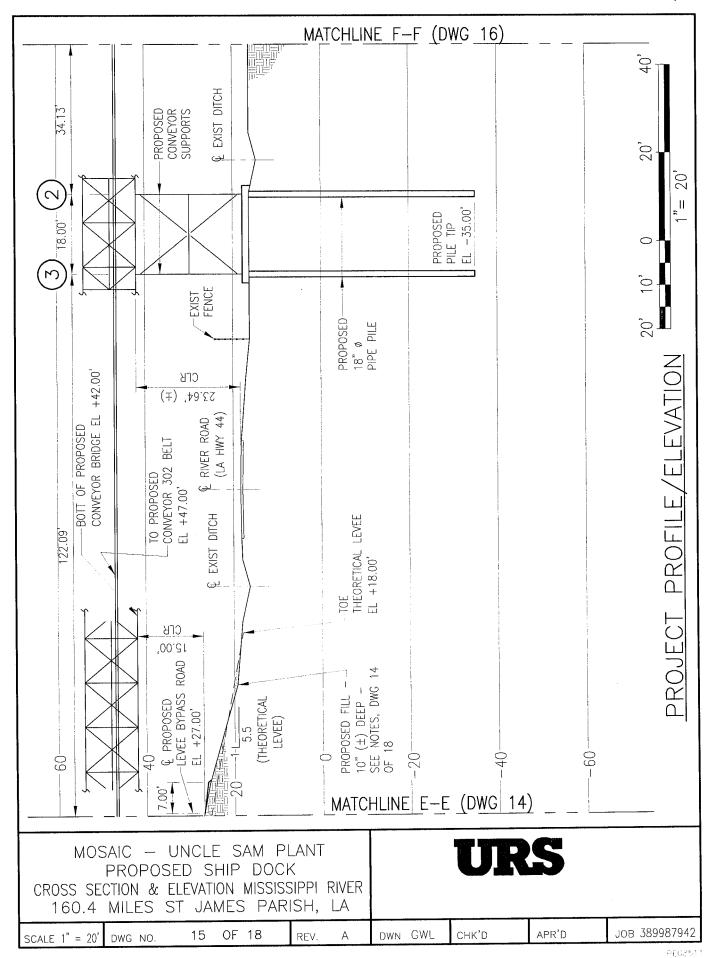MOSAIC — UNCLE SAM PLANT PROPOSED SHIP DOCK CROSS SECTION & ELEVATION MISSISSIPPI RIVER 160.4 MILES ST JAMES PARISH, LA							URS					
S	CALE NOTED	DWG NO.	17	OF 18	REV.	Α	DWN	GWL	CHK'D	APR'D	ЈОВ 38987942	

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NOTES

- AS-BUILT DRAWINGS AND/OR PLATS SHALL HAVE WRITTEN ON THEM THE DATE OF COMPLETION
 OF SAID ACTIVITIES AND SHALL BE SUBMITTED TO THE LOUISIANA DEPARTMENT OF NATURAL
 RESOURCES, OFFICE OF COASTAL MANAGEMENT, P.O. BOX 44487, BATON ROUGE, LOUISIANA,
 70804-4487 WITHIN 30 DAYS OF PROJECT COMPLETION.
- 2. ALL STRUCTURES, FACILITIES, WELL AND PIPELINES/FLOWLINES OCCURRING IN OPEN WATER AREAS OR IN OILFIELD CANALS OR SLIPS SHALL BE REMOVED WITHIN 120 DAYS OF ABANDONMENT OR THE FACILITIES FOR THE HEREIN PERMITTED USE UNLESS PRIOR WRITTEN APPROVAL TO LEAVE SUCH STRUCTURES IN PLACE IS RECEIVED FROM THE COASTAL MANAGEMENT DIVISION. THIS CONDITION DOES NOT PRECLUDE THE NECESSITY FOR REVISING THE CURRENT PERMIT OR OBTAINING A SEPARATE COASTAL USE PERMIT SHOULD ONE BE REQUIRED.
- 3. STRUCTURES SHALL BE MARKED/LIGHTED IN ACCORDANCE WITH U.S. COAST GUARD REGULATIONS.
- 4. IN ORDER TO ENSURE THE SAFETY OF ALL PARTIES, THE PERMITTEE SHALL CONTACT THE LOUISIANA ONE CALL SYSTEM (1-800-272-3020) A MINIMUM OF 48 HOURS PRIOR TO THE COMMENCEMENT OF ANY EXCAVATION (DIGGING, DREDGING, JETTING, ETC.) OR DEMOLITION ACTIVITY.
- 5. LEVEE ROAD SHALL BE 610 ROAD BASE MIX (180 CUBIC YARDS REQUIRED).
- 6. FILL MATERIAL FOR LEVEE SHALL BE SELECTED EARTH FILL (1050 CUBIC YARDS REQUIRED).
- 7. FILL MATERIAL COHESIVE SOILS
 - A. EMBANKMENTS WILL BE CONSTRUCTED OF EARTH MATERIALS NATURALLY OCCURRING OR CONTRACTOR BLENDED. MATERIALS CLASSIFIED IN ACCORDANCE WITH ASTM D 2487 AS CL OR CH WITH LESS THAN 35% SAND CONTENT ARE SUITABLE FOR USE AS EMBANKMENT FILL. MATERIALS CLASSED AS ML ARE SUITABLE IF BLENDED TO PRODUCE A MATERIAL THAT CLASSIFIES AS CH OR CL ACCORDING TO ASTM D 2487.
 - B. ALL FILL MATERIALS WILL BE FREE FROM MASSES OF ORGANIC MATTER, STICKS, BRANCHES, ROOTS, AND OTHER DEBRIS, INCLUDING HAZARDOUS AND REGULATED SOLID WASTES. AS EARTH FROM THE DESIGNATED EXCAVATION AREAS MAY NOT BE CONSIDERED OBJECTIONABLE IN THE EMBANKMENT PROVIDED THEIR LENGTH DOES NOT EXCEED 1 FOOT, THEIR CROSS—SECTIONAL AREA IS LESS THAN 4 SQUARE INCHES, AND THEY ARE DISTRIBUTED THROUGHOUT THE FILL. NOT MORE THAN 1% (BY VOLUME) OF OBJECTIONABLE MATERIAL SHALL BE CONTAINED IN THE EARTH MATERIAL PLACED IN EACH CUBIC YARD OF THE LEVEE SECTION. POCKETS AND/OR ZONES OF WOOD SHALL NOT BE PLACED IN THE EMBANKMENT.
 - C. MATERIALS PLACED IN THE SECTION WILL BE AT OR ABOVE THE PLASTICITY INDEX OF 10.
 AS A PRECAUTION, CONTRACTORS SHALL NOTIFY THE INSPECTOR WHENEVER THE IN-PLACE PLASTICITY INDEX OF THE MATERIAL IS 15 OR LESS.
 - D. MATERIALS PLACED IN THE SECTION WILL BE AT OR BELOW AN ORGANIC CONTENT OF 9% BY WEIGHT, AS DETERMINED BY ASTM D 2974, METHOD C.

MOSAIC — UNCLE SAM PLANT PROPOSED SHIP DOCK NOTES 160.4 MILES ST JAMES PARISH, LA **URS**

SCALE NONE DWG NO. 18 OF 18 REV. A DWN GWL CHK'D APPD JOB 38987942