

CEDAR CREEK
SECTIONS 7 7 8, T-7-S, R-10-E,
ST. TAMMANY PARISH, LA.


VICINITY MAP

SCALE:	N.T.S.	DATE:	06-29-11
DRAWN:		JOB NO.:	
REVISED:			

NOTE:
ALL ELEVATIONS ARE REFERENCED TO MSL (NAVD 88)


— = DIRECTION OF SURFACE FLOW
— = EXISTING NATURAL DRAINAGE
PATTERN TO REMAIN

■ = INDICATES WETLANDS
(16.95 ACRES)
■ = IMPACTED WETLANDS
(0.57 ACRES)
OTHER WATERS IMPACTED 0.04 AC.

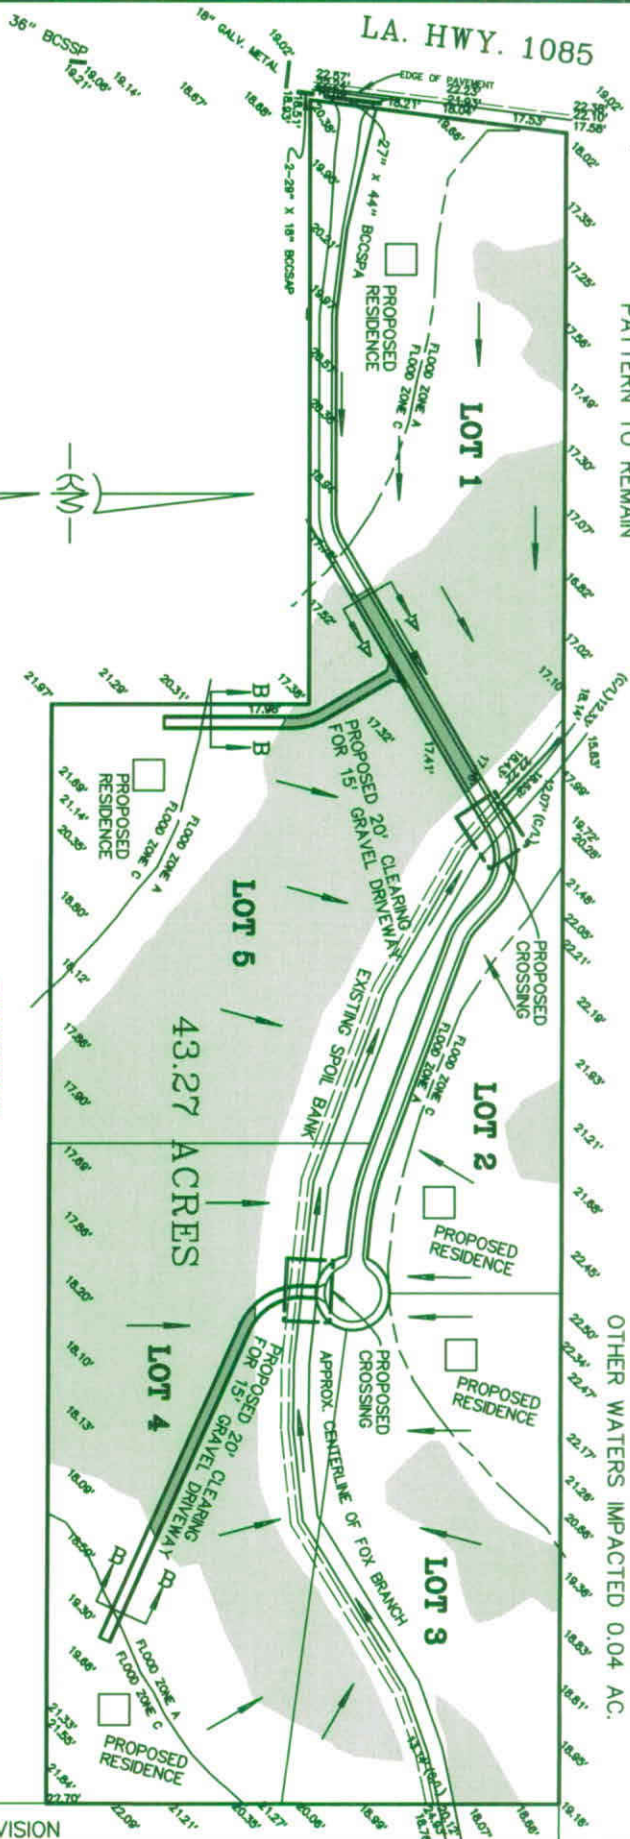

QUANTITIES

FILL FOR STREET WETLANDS IMPACT	351 cu. yd. 193 cu. yd.	BASE AGGREGATE 159 cu. yd. 87 cu. yd.
FILL FOR DRIVEWAYS WETLANDS IMPACT	1034 cu. yd. 682 cu. yd.	470 cu. yd. 66 cu. yd.
FILL FOR CROSSINGS	240 cu. yd.	15 cu. yd.
EXISTING SPOIL BANK (FILL FOR DRIVEWAYS AND ROADWAY TO BE TAKEN FROM SPOIL BANK)	= 2150 +/- cu. yd.	

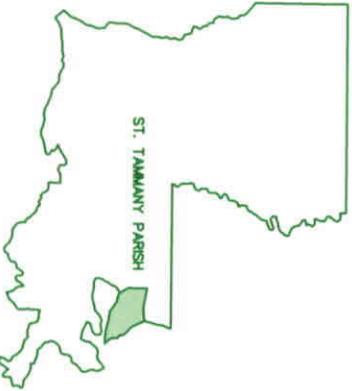


SITE PLAN AND DRAINAGE PLAN

CEDAR CREEK BEING
43.27 ACRES IN SECTIONS 7 & 8,
TOWNSHIP-7-SOUTH, RANGE-10-EAST,
ST. TAMMANY PARISH, LOUISIANA.


ALLEN TINGLE

SCALE 1" = 300'	DATE 04-26-11
DRAWN DRJ	JOB NO. 10-268
REVISIONS 06-29-11	

WINDERMERE SUBDIVISION

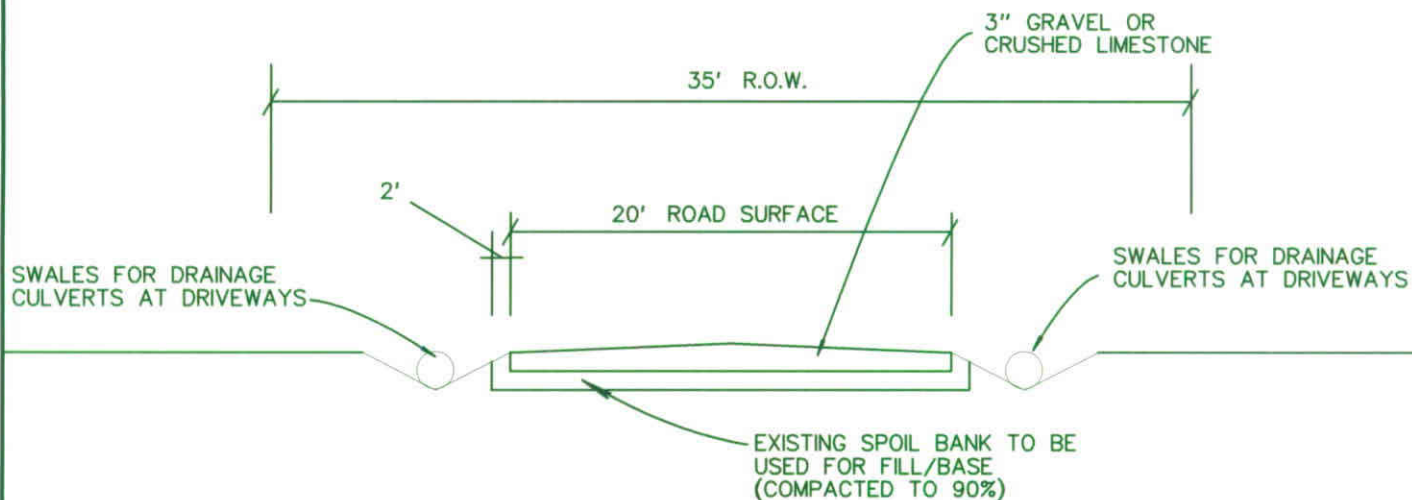

TYPICAL AGGREGATE ROADWAY
(SECTION A-A)

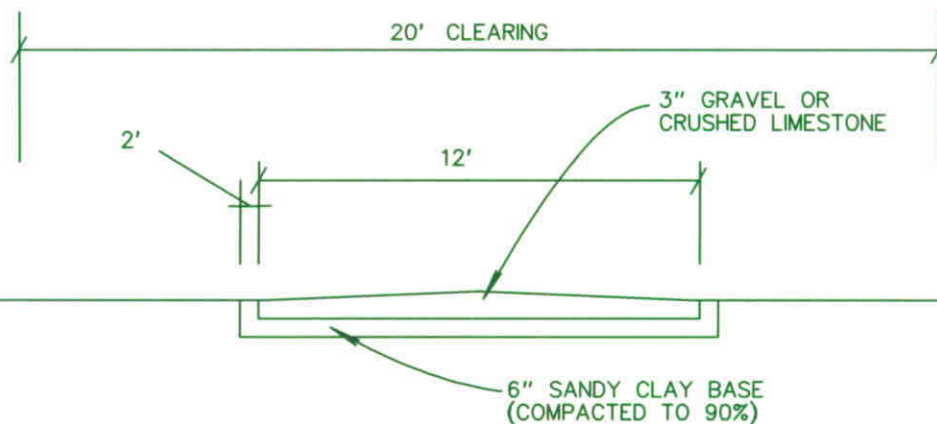


TYPICAL AGGREGATE DRIVEWAY
(SECTION B-B)

CEDAR CREEK


ROADWAY/DRIVEWAY SECTION

SCALE:	N.T.S.	DATE:	04-26-11
DRAWN:	DRJ	JOB NO.:	10-268
REVISED:	06-29-11		

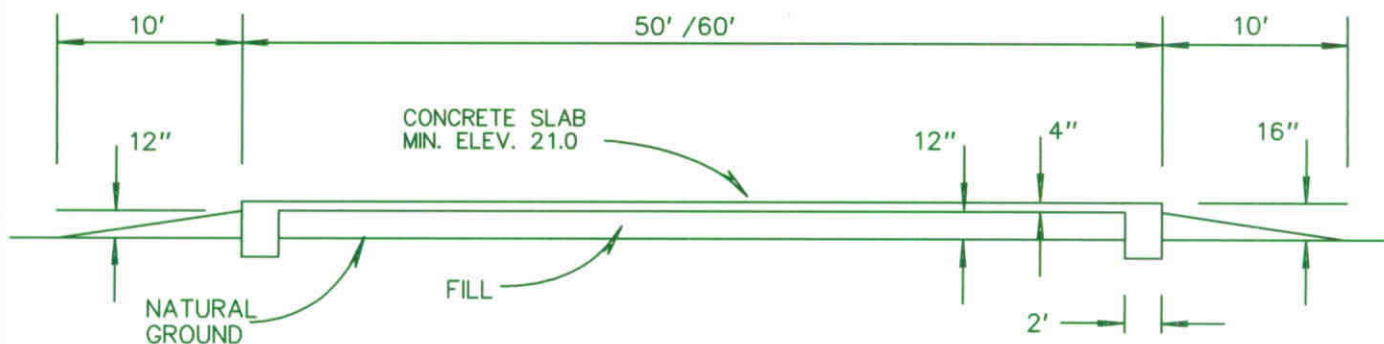

SECTION A-A (OPTION 1)

FILL FOR SLAB FOUNDATION
 FILL CONCRETE
 151 cu. yd. 60 cu. yd.
 ALL IN NON WET AREAS

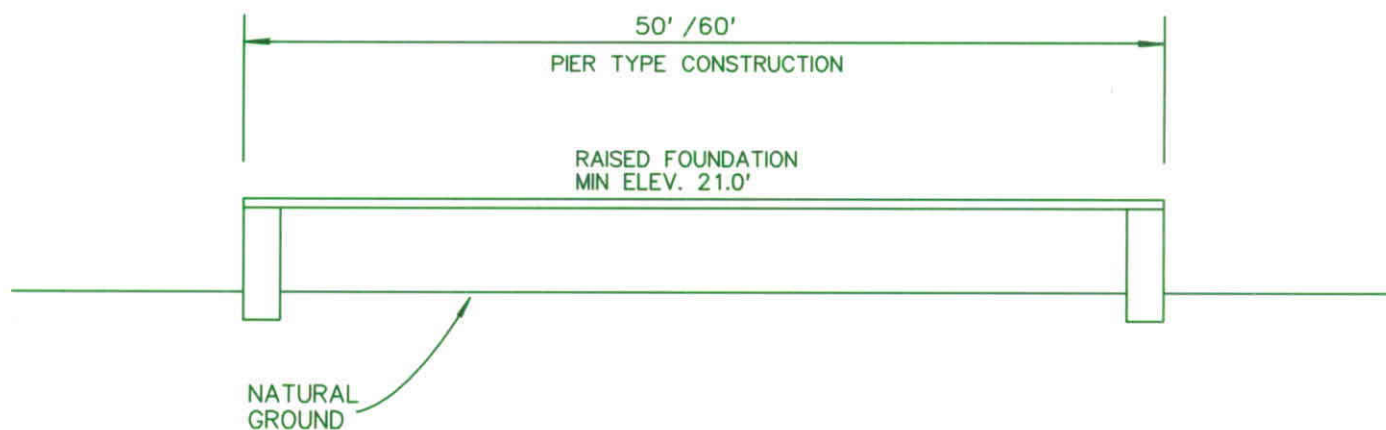

SECTION A-A (OPTION 2)



CEDAR CREEK

FOUNDATION SECTION VIEW

SCALE:	N.T.S.	DATE:	04-26-11
DRAWN:	DRJ	JOB NO.:	10-268
REVISED:			

EXISTING SPOIL BANK
TO BE USED FOR FILL



PROPOSED CONCRETE HEADWALLS

2- 8.5' DIAMETER
STEEL CULVERTS
(RAILROAD TANK CARS)

FILL = 120 cu. yd./CROSSING x 2 = 240 cu. yd.

NOTE:
CULVERTS TO BE CONSTRUCTED FROM
USED RAILROAD TANK CARS
WITH THE ENDS CUT OFF



PROPOSED CROSSING AT FOX BRANCH
ST. TAMMANY PARISH LOUISIANA

CEDAR CREEK

SCALE 1" = 10'

DATE 04-08-11

DRAWN

DRJ

JOB NO. 10-268

REVISIONS