


HKUST ISD CAPSTONE PROJECT LABORATORY AT ROOM 4223

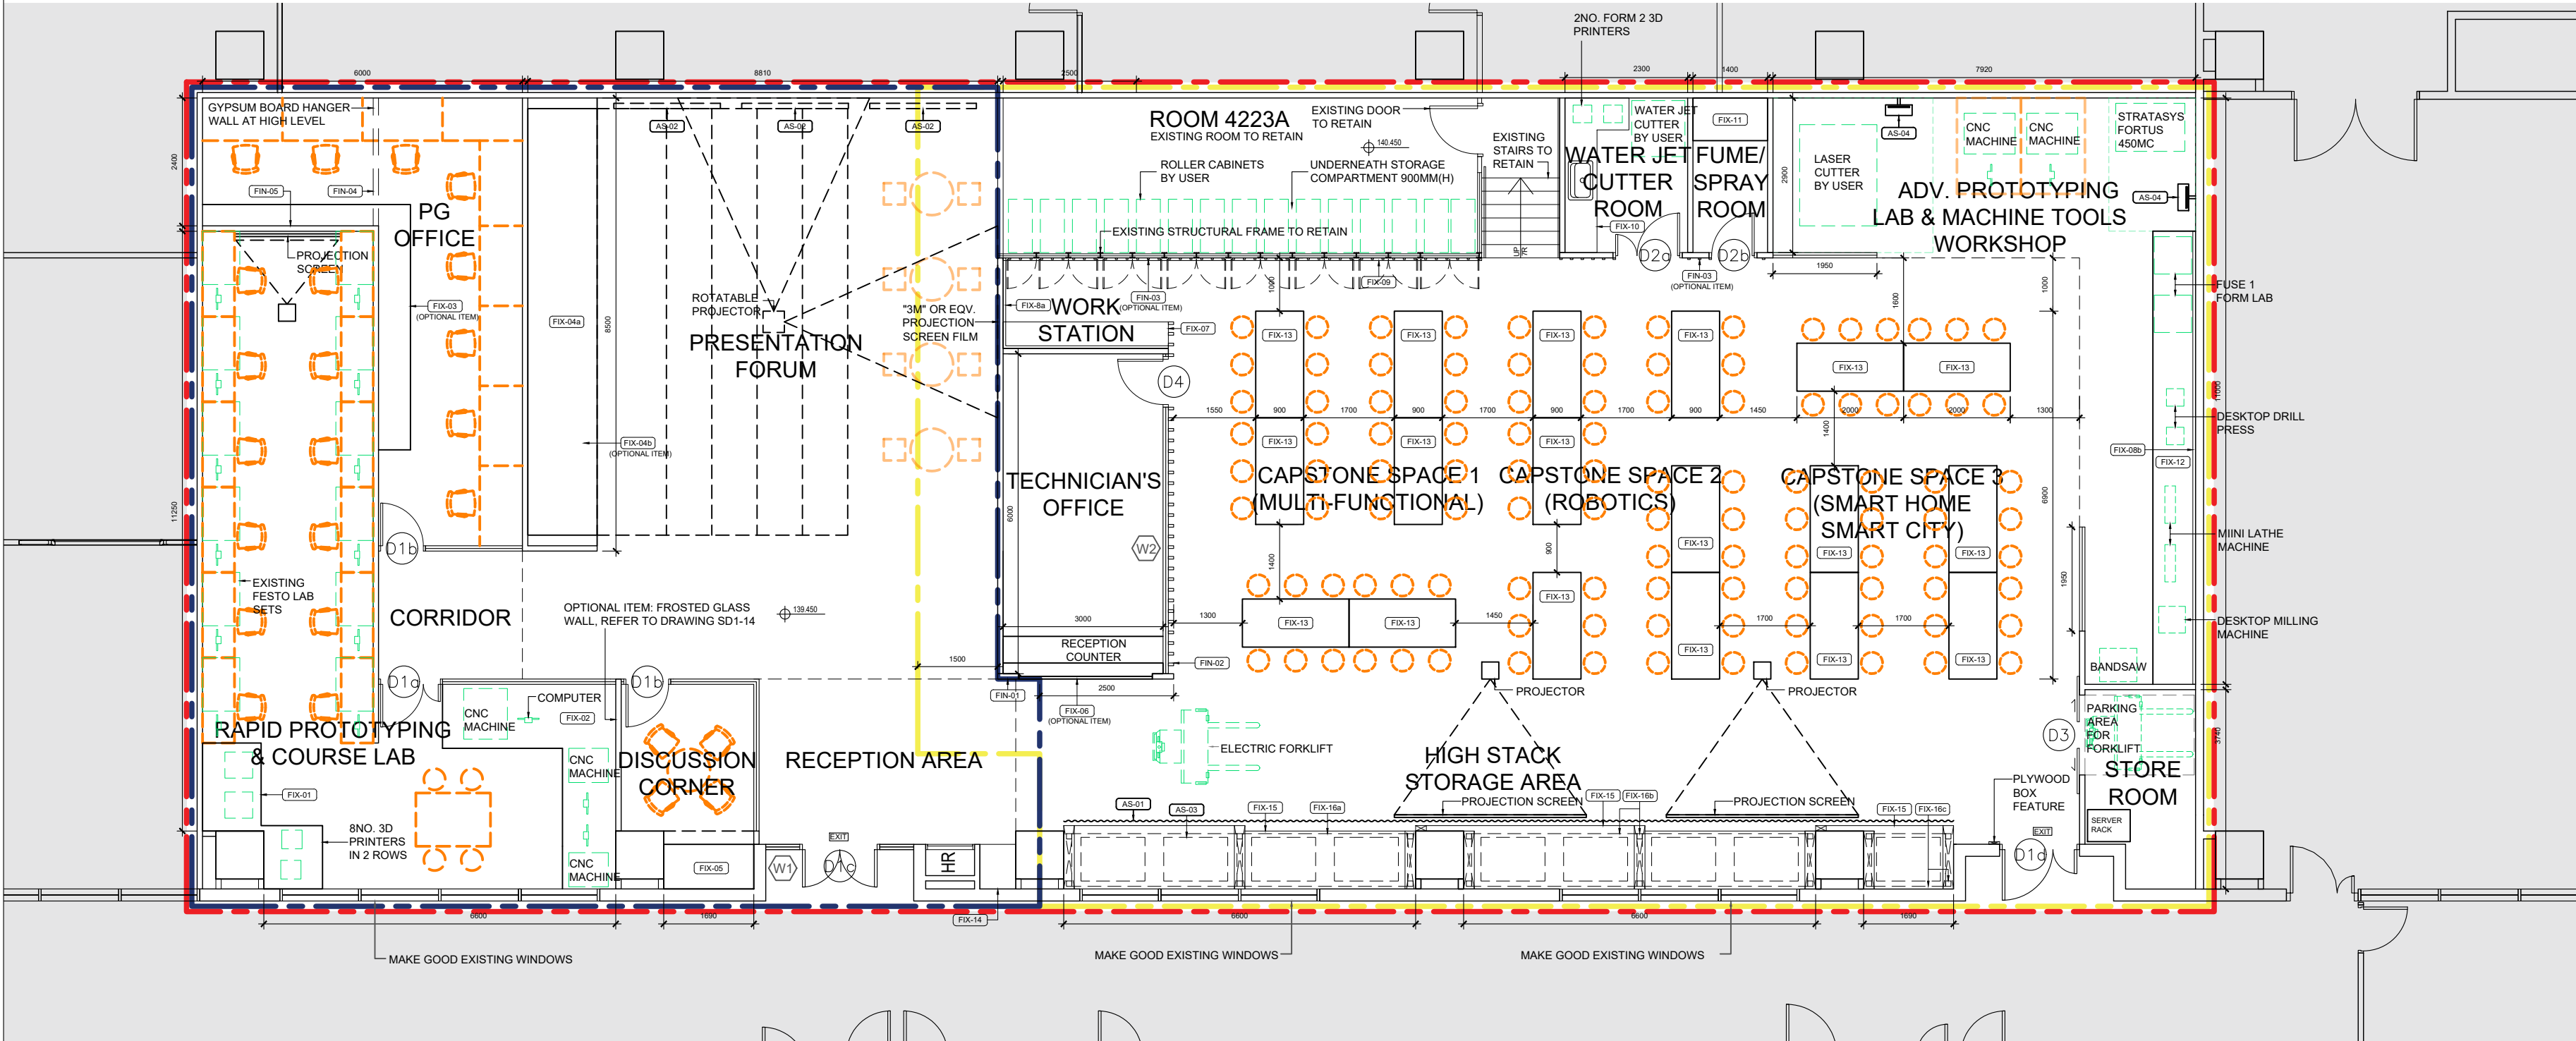

LEGEND:

- MACHINE/ EQUIPMENTS BY USER. M.C. TO PROVIDE ALL B.S. PROVISIONS NECESSARY, REFER TO B.S.TENDER DRAWINGS & SPECIFICATIONS.
- LOOSE FURNITURE LAYOUT FOR REFERENCE ONLY.
- SITE BOUNDARY
- PHASE 1 CONSTRUCTION AREA
- PHASE 2 CONSTRUCTION AREA

NOTES:

- M.C. TO MAKE GOOD ALL AFFECTED AREAS.
- ALL DIMENSIONS TO BE VERIFIED ON SITE.

LAYOUT PLAN

A.S.D. REF.:  
B.D. REF.:  
F.S.D. REF.:

TENDER DRAWING

REVISION:

NOTES:

- USE WRITTEN DIMENSIONS OR GRID LINES. MEASUREMENTS TO EXISTING WORK TO BE CHECKED ON SITE.
- THIS DRAWING IS TO BE READ IN CONJUNCTION WITH THE SPECIFICATION & CONDITIONS OF CONTRACT.
- THIS DRAWING & DESIGN ARE COPYRIGHT AND NO PORTION MAY BE REPRODUCED WITHOUT THE WRITTEN PERMISSION OF URBANAGE INTERNATIONAL LTD.

STRUCTURAL CONSULTANT:



E & M CONSULTANT:



QUANTITY SURVEYOR:



ARCHITECT:



TEL: (852)2865-6036 FAX: (852)2520-2218

DRAWN BY:

CHECKED BY:

DATE: APR 2019

SCALE: 1 : 100 IN A2

SHEET TITLE:

LAYOUT PLAN

PROJECT NO: SK-18202 SHEET NO: LA-01

HKUST ISD CAPSTONE PROJECT LABORATORY AT ROOM 4223



DEMOLITION PLAN

A.S.D. REF.:  
B.D. REF.:  
F.S.D. REF.:

TENDER DRAWING

REVISION:

NOTES:

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STRUCTURAL CONSULTANT:



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QUANTITY SURVEYOR:



ARCHITECT:



城市拓展國際有限公司

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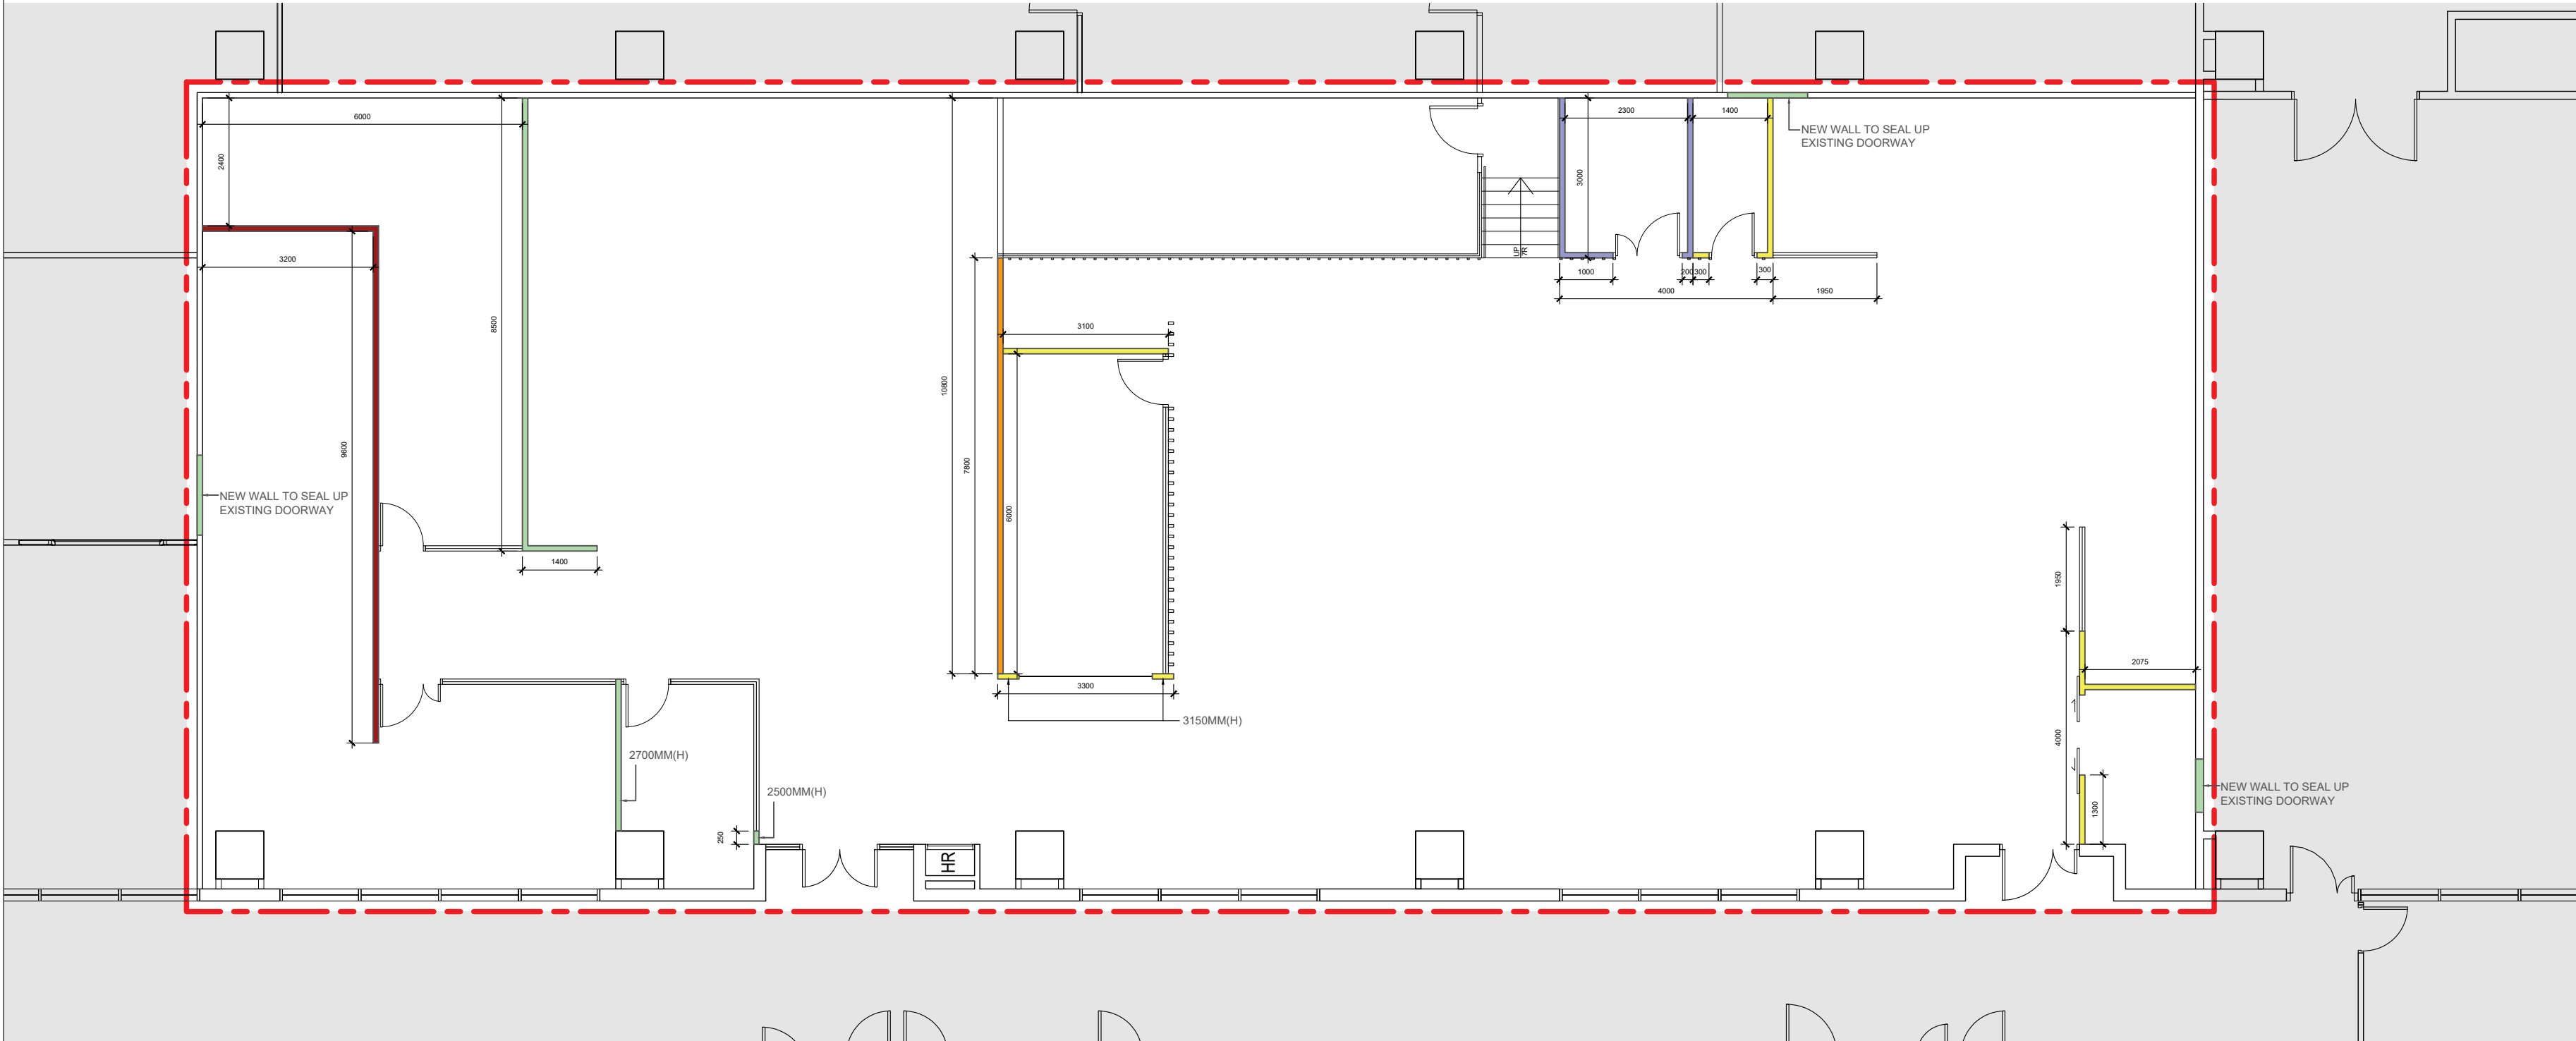
DATE: APR 2019

SCALE: 1 : 100 IN A2

SHEET TITLE:

DEMOLITION PLAN

PROJECT NO: SK-18202 SHEET NO: LA-02



LEGEND:

- FULL HEIGHT "Y-TONG" OR EQUIVALENT LIGHTWEIGHT CONCRETE BLOCK WALL (THICKNESS TO COMPLY W/ THE CURRENT EDITION OF FIRE SAFETY CODE & HK REGULATION) W. STRUCTURAL FRAME. STRUCTURAL FRAME DESIGN REFER TO STRUCTURE TENDER DRAWINGS & SPECIFICATIONS.
- 3000MM(H) "Y-TONG" OR EQUIVALENT LIGHTWEIGHT CONCRETE BLOCK WALL (THICKNESS TO COMPLY W/ THE CURRENT EDITION OF FIRE SAFETY CODE & HK REGULATION).
- 2350MM(H) "Y-TONG" OR EQUIVALENT LIGHTWEIGHT CONCRETE BLOCK WALL (THICKNESS TO COMPLY W/ THE CURRENT EDITION OF FIRE SAFETY CODE & HK REGULATION).
- 3600MM(H) X 100MM THK. "Y-TONG" OR EQUIVALENT LIGHTWEIGHT CONCRETE BLOCK WALL (THICKNESS TO COMPLY W/ THE CURRENT EDITION OF FIRE SAFETY CODE & HK REGULATION) W. STRUCTURAL FRAME. STRUCTURAL FRAME DESIGN REFER TO STRUCTURE TENDER DRAWINGS & SPECIFICATIONS.
- 3000MM(H) X 100MM THK. "K.WAH" OR EQUIVALENT CONCRETE BLOCK (THICKNESS TO COMPLY WITH THE CURRENT EDITION OF FIRE SAFETY CODE & HK REGULATION).

NOTES:

- M.C. TO MAKE GOOD ALL AFFECTED AREAS.
- ALL DIMENSIONS TO BE VERIFIED ON SITE.

BLOCK WALL PLAN

HKUST ISD CAPSTONE PROJECT LABORATORY AT ROOM 4223

A.S.D. REF.:  
B.D. REF.:  
F.S.D. REF.:

TENDER DRAWING

REVISION:

NOTES:

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STRUCTURAL CONSULTANT:



E & M CONSULTANT:



QUANTITY SURVEYOR:



ARCHITECT:



城市拓展國際有限公司

TEL: (852)2865-6036 FAX: (852)2520-2218

DRAWN BY:

CHECKED BY:

DATE: APR 2019

SCALE: 1 : 100 IN A2

SHEET TITLE:

BLOCK WALL PLAN

PROJECT NO: SK-18202 SHEET NO: LA-03

HKUST ISD CAPSTONE PROJECT LABORATORY AT ROOM 4223

A.S.D. REF.:  
B.D. REF.:  
F.S.D. REF.:

TENDER DRAWING

REVISION:

NOTES:

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STRUCTURAL CONSULTANT:



E & M CONSULTANT:



QUANTITY SURVEYOR:



ARCHITECT:



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DRAWN BY:

CHECKED BY:


DATE: APR 2019

SCALE: 1 : 100 IN A2

SHEET TITLE:

REFLECTED  
CEILING PLAN

PROJECT NO: SK-18202 SHEET NO: LA-04

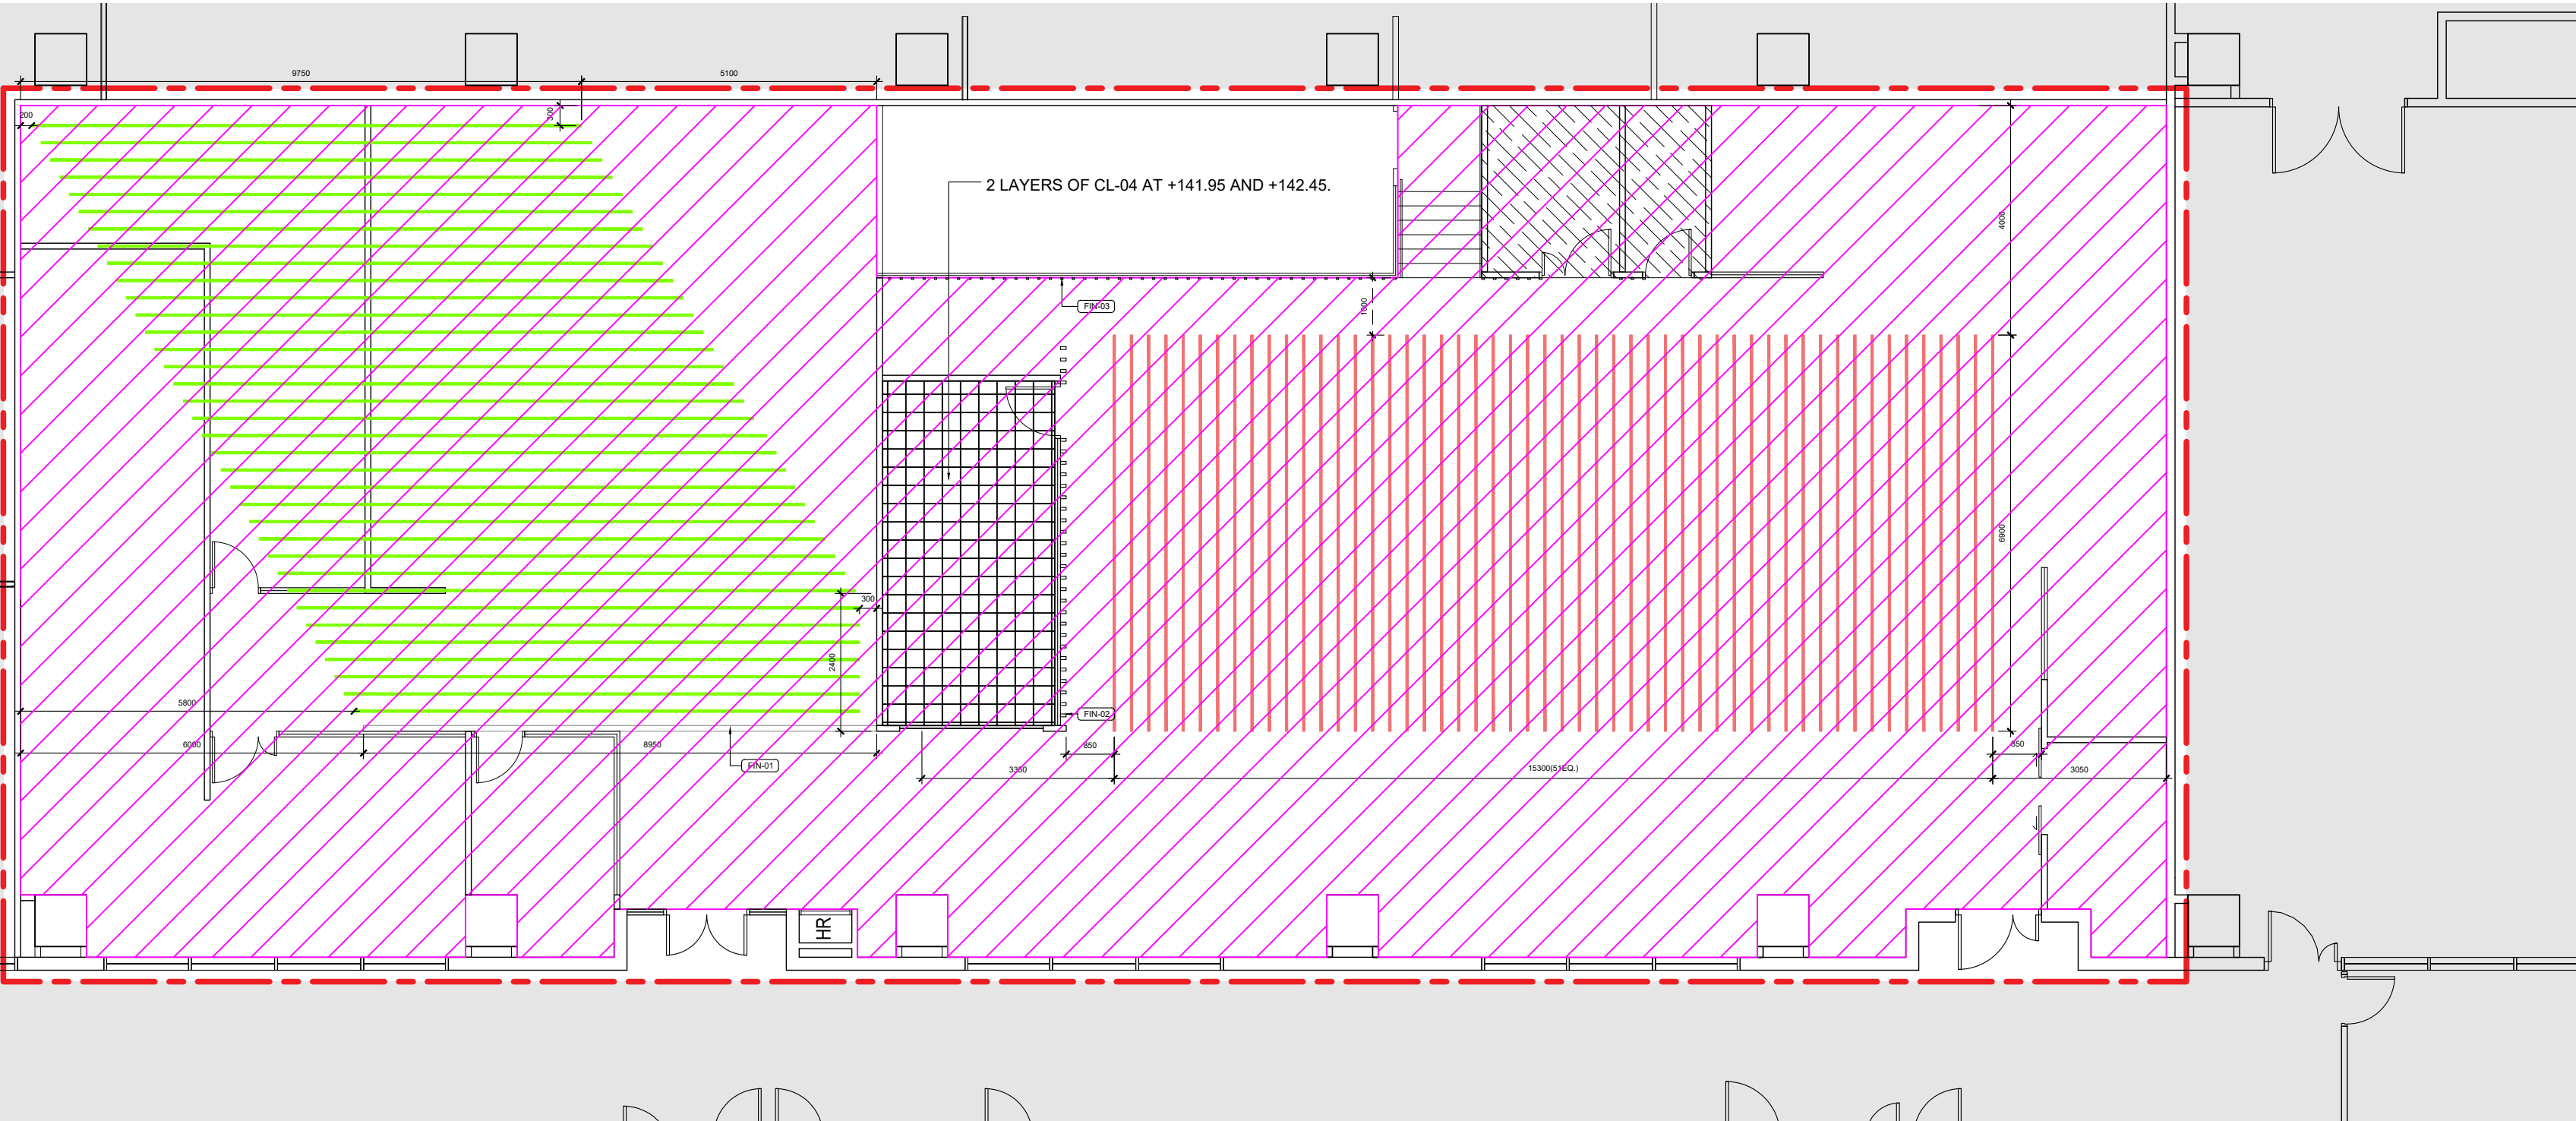

LEGEND:



CL-01

"ICI" OR EQUIVALENT ANTI-MOULD ACRYLIC BASE EMULSION PAINT




CL-02a

200MM(H) X 40MM(THK.) ALUMINUM BAFFLE FALSE CEILING SYSTEM W/ CL-01 ABOVE AT TRUE CEILING




CL-02b

200MM(H) X 40MM(THK.) ALUMINUM BAFFLE FALSE CEILING SYSTEM W/ CL-01 ABOVE AT TRUE CEILING. (OPTIONAL ITEM)

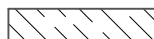

CL-03

"KNUAF-AQUAPANEL CEMENT BOARD INDOOR" OR EQUIVALENT ANTI-MOULD WATER RESISTANT CEMENT BOARD FALSE CEILING

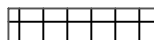

CL-04

ALUMINUM CONCEALED GRID PROFILE FALSE CEILING SYSTEM WITH MINERAL CEILING TILES.


NOTES:

1. M.C. TO MAKE GOOD ALL AFFECTED AREAS.  
2. ALL DIMENSIONS TO BE VERIFIED ON SITE.  
3. ALL CEILING LEVELS TO BE VERIFIED ON SITE.


REFLECTED CEILING PLAN




HKUST ISD CAPSTONE PROJECT LABORATORY AT ROOM 4223

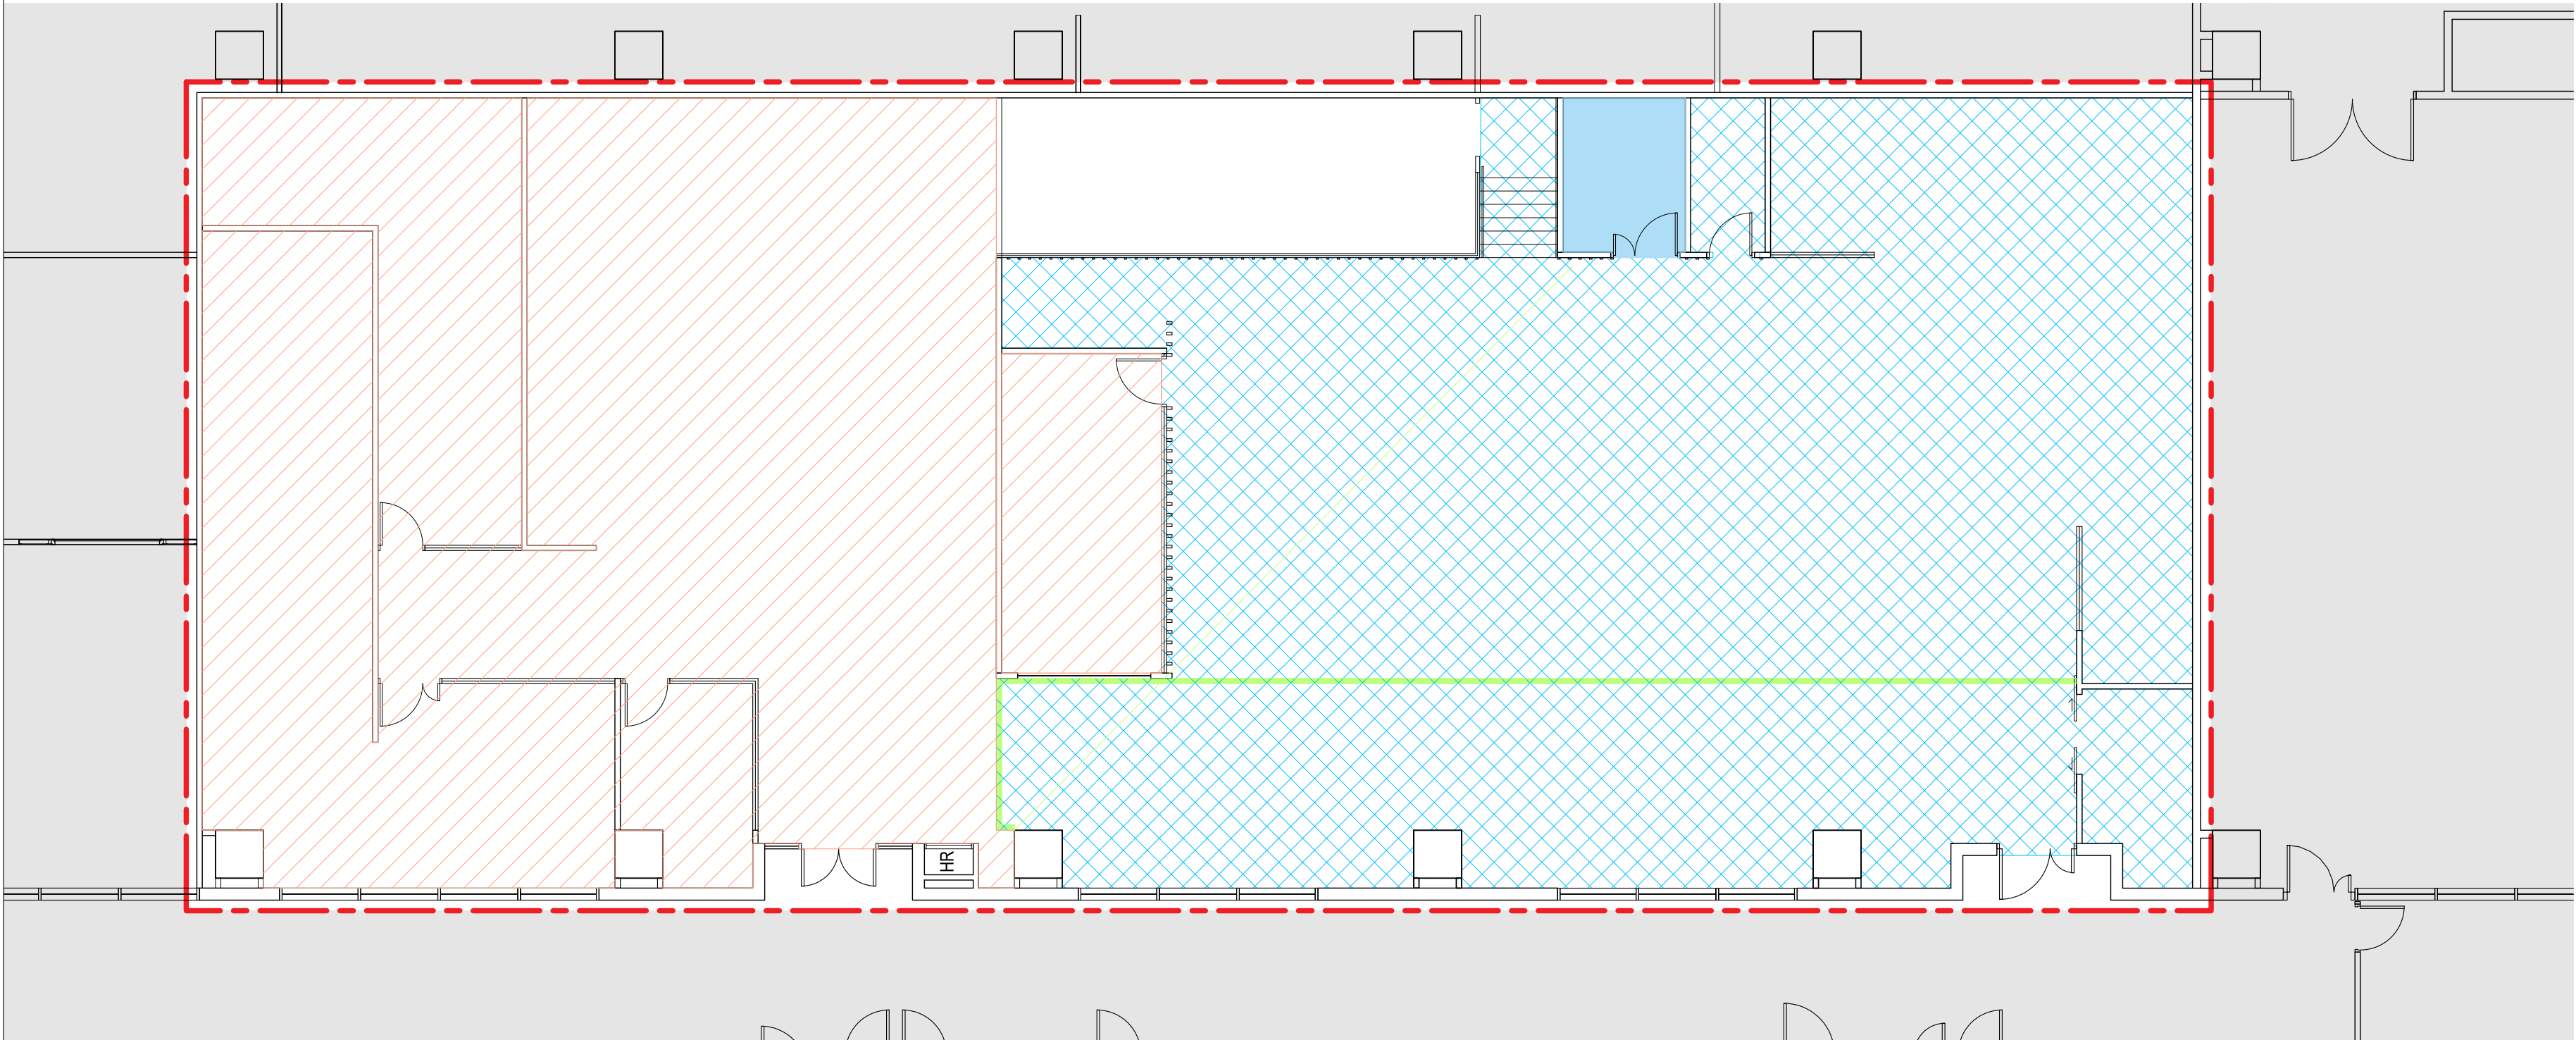


LEGEND:

- 


FL-01

VINYL FLOORING
- 

FL-02a

EPOXY FLOORING
- 

FL-02b

EPOXY FLOORING W. WATERPROOF MEMBRANE
- 

100MM(W) SAFETY LINE (COLOURS AND SAMPLES TO BE SUBMITTED FOR ARCHITECT'S APPROVAL)

NOTES:

1. M.C. TO MAKE GOOD ALL AFFECTED AREAS.
2. ALL DIMENSIONS TO BE VERIFIED ON SITE.

FLOOR FINISHES PLAN

A.S.D. REF.:  
B.D. REF.:  
F.S.D. REF.:

TENDER DRAWING

REVISION:

NOTES:

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QUANTITY SURVEYOR:



ARCHITECT:



TEL: (852)2865-6036 FAX: (852)2520-2218

DRAWN BY:

CHECKED BY:

DATE: APR 2019

SCALE: 1 : 100 IN A2

SHEET TITLE:

FLOOR FINISHES PLAN

PROJECT NO: SK-18202 SHEET NO: LA-05